




FILL IN AND SIGN WITH INK

APPLICATION FOR PERMIT HEATING OR POWER EQUIPMENT

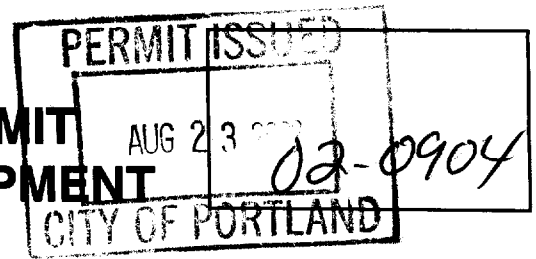

To the INSPECTOR OF BUILDINGS, PORTLAND, ME.

111-C-005

The undersigned hereby applies for a permit to install the following heating, cooking or power equipment in accordance with the Laws of Maine, the Building Code of the City of Portland, and the following specifications:

Location 405 Forest Ave Use of Building office Date 8-12-02

Name and address of owner of appliance _____

Installer's name and address B & B Mechanical Inc P.O. Box 22 Hollis, ME
Telephone (207) 415-5928

Location of appliance:

- Basement
- Floor
- Attic
- Roof

Type of Fuel:

- Gas
- Oil
- Solid

Appliance Name: American Standard

U.L. Approved Yes No

Will appliance be installed in accordance with the manufacture's installation instructions? Yes No

IF NO Explain: _____

The Type of License of Installer:

- Master Plumber # _____
- Solid Fuel # _____
- Oil # _____
- Gas # _____
- Other _____

Type of Chimney:

- Masonry Lined
Factory built NA
- Metal
Factory Built U.L. Listing # NA
- Direct Vent
Type _____ UL# _____

Type of Fuel Tank

- Oil
- Gas

Size of Tank NA

Number of Tanks NA

Distance from Tank to Center of Flame NA feet.

\$ 30.⁰⁰

Approved

Approved with Conditions


Fire: GHM

Ele.: _____


Bldg.: 8/12/02

See attached letter or requirement

Signature of Installer [Signature]

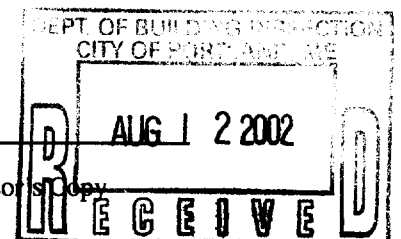


White - Inspection Yellow - File Pink - Applicant's Gold - Assessor's Copy

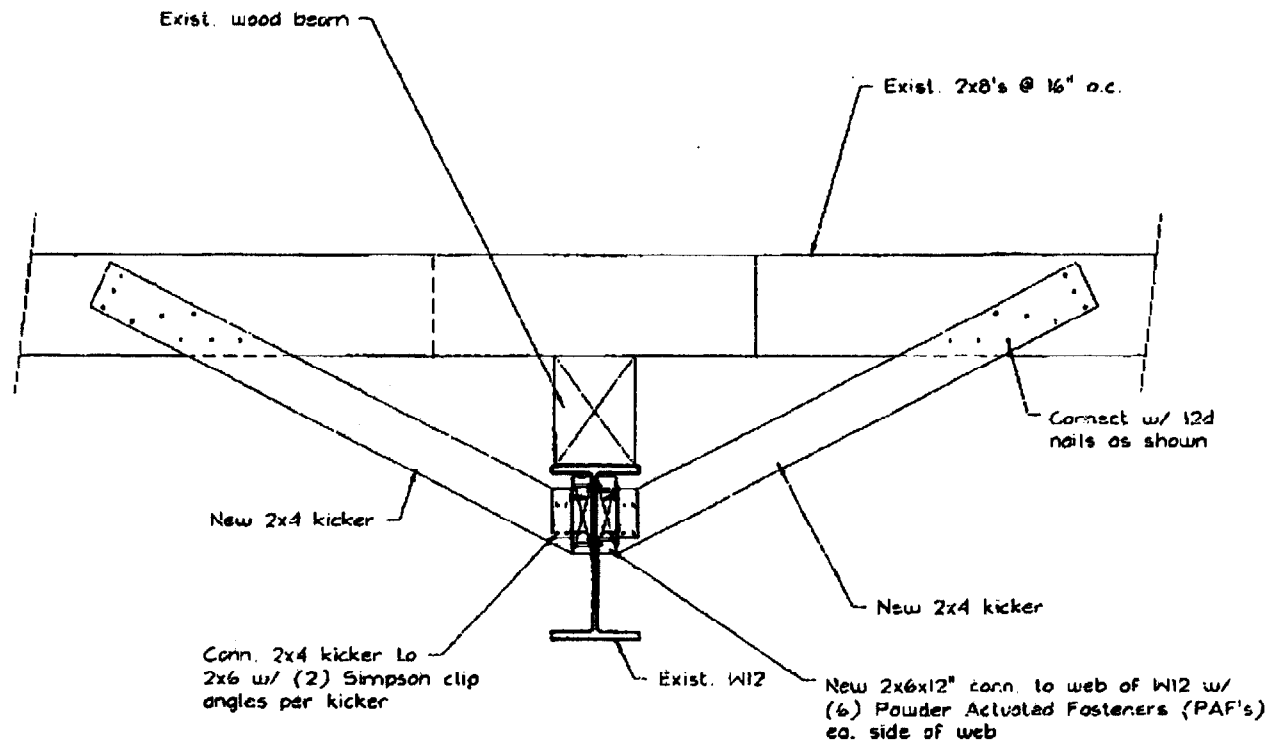

DETAIL
SCALE: 1" = 1'-0"

A
Sk1

SEI	SHELLEY ENGINEERING, INC.			415 FOREST AVE.		
	STRUCTURAL CONSULTANTS 90 BRIDGE STREET WESTBROOK, MAINE 04092 PHONE: (207) 854-5465 FAX: (207) 854-8706 WWW.SHELLEYENGINEERING.COM			RTU REINFORCEMENT		
	Drawn By:	PDJ	Date:	08/19/02	Sheet:	SK2
	Checked By:	PDJ	Scale:	AS NOTED	Job No.:	2002-586

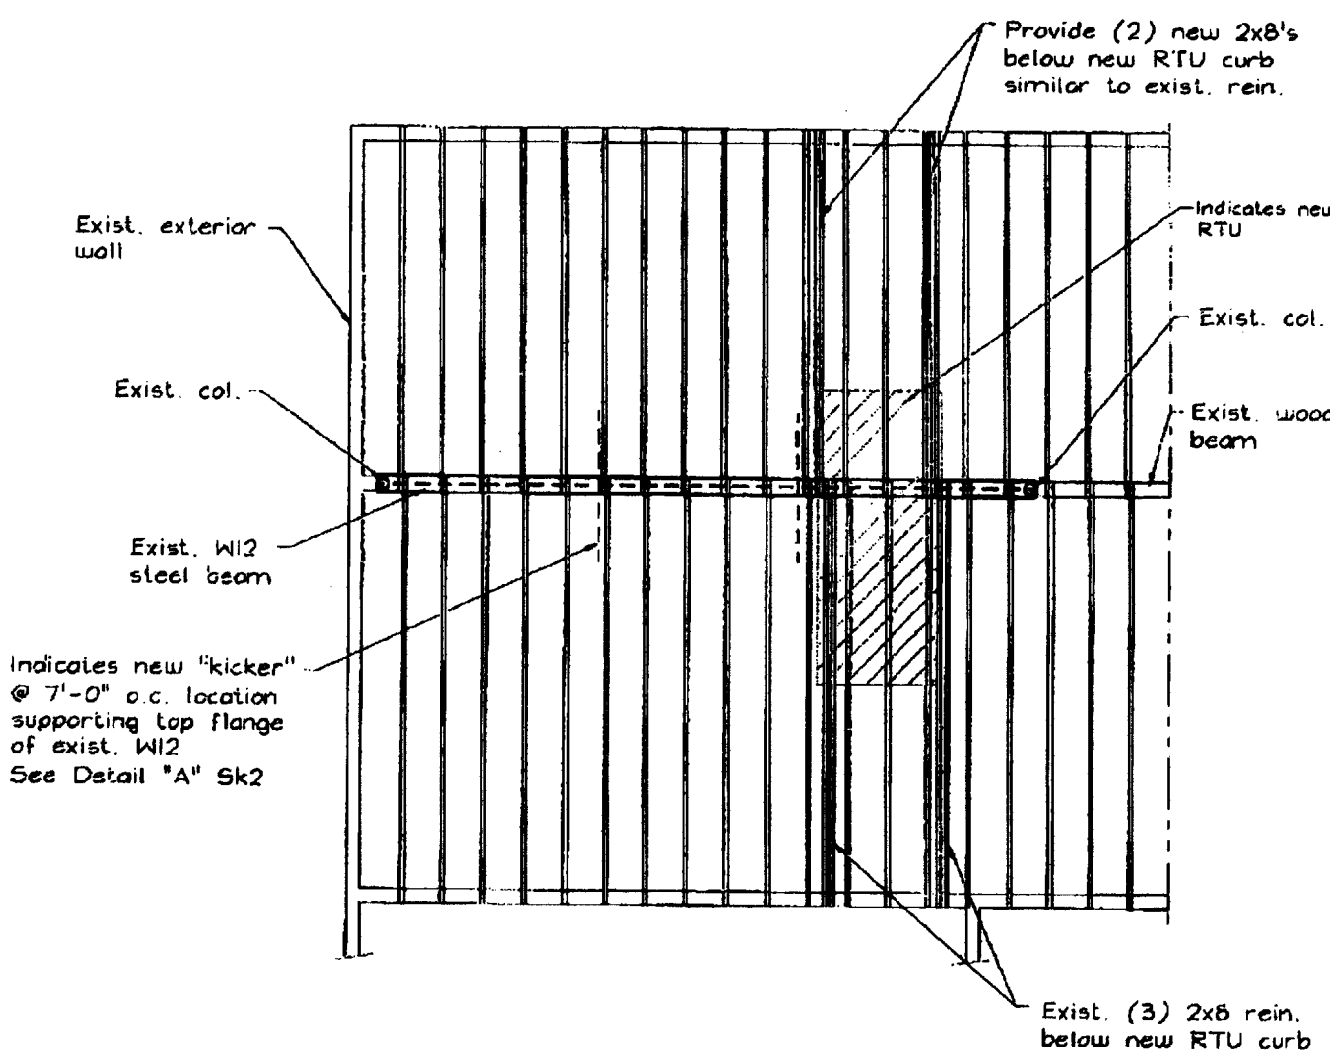


PART ROOF FRAMING PLAN
 SCALE: 3/16" = 1'-0"

SEI SHELLEY ENGINEERING, INC. STRUCTURAL CONSULTANTS 90 BRIDGE STREET WESTBROOK, MAINE 04092 PHONE (207) 854-5465 FAX (207) 854-8706 WWW.SHELLEYENGINEERING.COM		415 FOREST AVE. RTU REINFORCEMENT	
		Designer: PDUJ Checked By: PDUJ	Date: 08/19/02 Scale: AS NOTED

25'

Additional
Buildout

American Standard
YCO/YCH.O60C1L
Wgt. 531 lbs

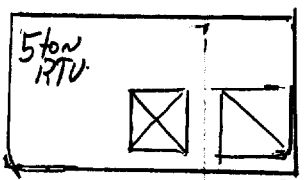

⊙ Roof Drain

51'

Parking

Primary Mortgage
415 Forest Ave

~ steel wrapped w/ wood Beams
& Front to Back

Forest Ave