# 300 CENTRAL AVENUE


PEAKS ISLAND, MAINE

## OWNER

PHIL AND JUDY RICHARDSON 300 Central Avenue Peaks Island, Maine 04108

## CONSULTANT

CASCO BAY ENGINEERING 424 Fore Street Portland, ME 04101

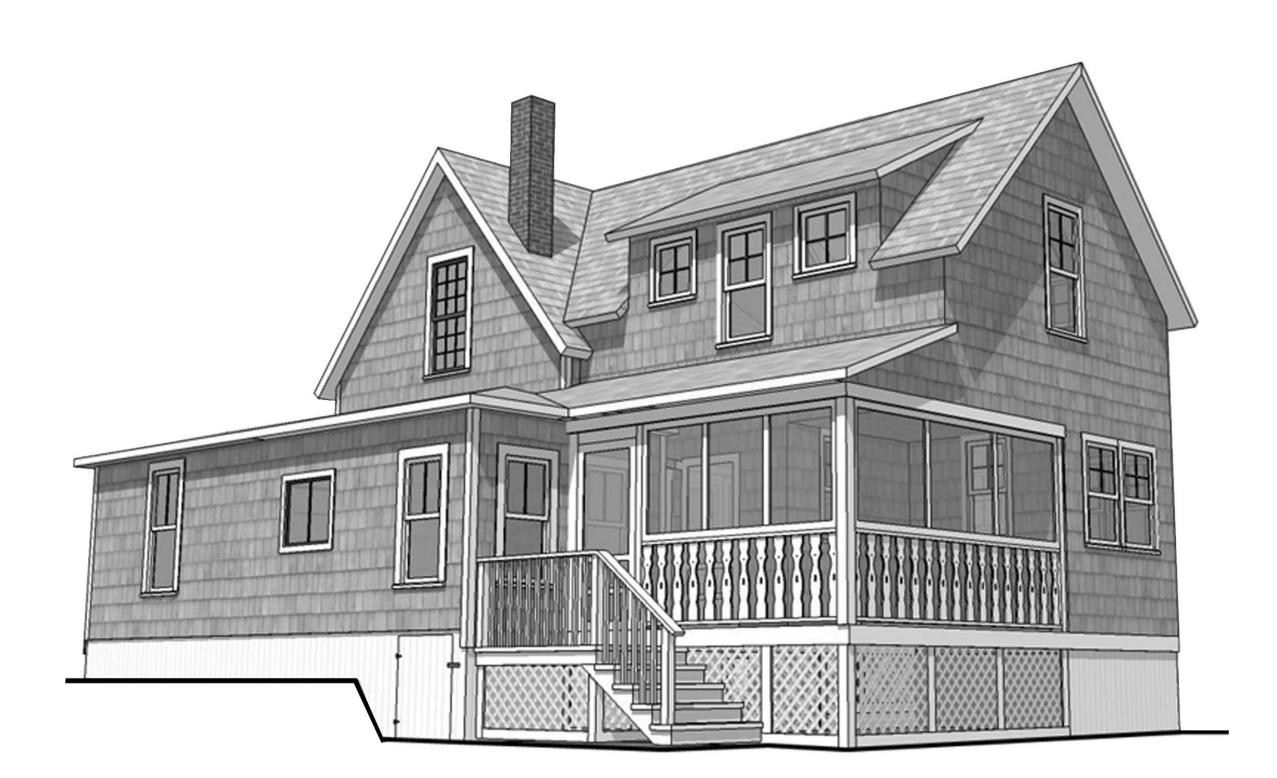

## **ABBREVIATIONS**

ABOVE FINISHED FLOOR **AFF BLDG** BUILDING **BOTTOM OF** B.O. **CHIMNEY** CHM CLG **CEILING CLST CLOSET** CR WOOD COAT ROD CORR. CORRIDOR COL COLUMN **DOOR DRAWING** FFE FINISHED FLOOR ELEVATION **FLOOR** FL **FND FOUNDATION FACE OF** F.O. GENERAL CONTRACTOR

GWB GYPSUM WALL BOARD
HGT HEIGHT
INSUL INSULATION
MFGR MANUFACTURER
MAX MAXIMUM

MIN MINIMUM

MISC MISCELLANEOUS

NIS NOT IN SCOPE

OC ON CENTER

PLYWD PLYWOOD

PNT PAINTED

PT PRESSURE TREATED

REQ REQUIRED RM ROOM

R.OW. ROUGH OPENING

SIM SIMILAR
STRL STRUCTURAL

T&G TONGUE AND GROOVE

T.O. TOP OF TYPICAL

UNO UNLESS NOTED OTHERWISE

U.D. UNIT DIMENSIONVIF VERIFY IN FIELD

WD WOOD

## DRAWINGS

### **BOUNDARY SURVEY**

### ARCHITECTURAL DRAWINGS

A1 CRAWL SPACE AND FIRST
FLOOR PLANS, NOTES, LEGEND
A2 SECOND FLOOR AND ROOF

PLANS, DOOR SCHEDULE, ALLOWANCES, NOTES
A3 REFLECTED CEILING PLANS/POWER PLANS

A4 EXTERIOR ELEVATIONS, WINDOW TYPES,

NOTES, DETAILS

A5 EXTERIOR ELEVATIONS, SECTIONS, DETAILS

### STRUCTURAL DRAWINGS

S000 STRUCTURAL NOTES

S100 FOUNDATION AND FIRST FLOOR FRAMING PLAN
S101 SECOND FLOOR AND ROOF FRAMING PLAN

S200 FRAMING DETAILS

## **CODE REVIEW**

ZONE - ISLAND RESIDENTIAL ZONE 1 (IR-1)

APPLICABLE CODE - MAINE UNIFORM BUILDING AND ENERGY CODE

**IMPORTANT INTERPRETATIONS:** 

THE ADDITION IS NOT INSULATED TO THE FULL VALUE

REQUIRED BY THE IECC AS IT WILL BE AN

UNCONDITIONED SPACE.

### ADDITIONAL GOVERNING RULES/ORDINANCES

RESIDENTIAL FIRE SPRINKLER ORDINANCE AND THE CITY OF PORTLAND FIRE DEPARTMENT RULES AND

REGULATIONS.

CHAPTER 7 OF THE PFD RULES AND REGULATIONS

7.2.2.2

TOTAL AREA OF ALL REHABILITATION WORK AREAS

AND ADDITIONS = 630 SQ.FT.


AREA OF THE FINISHED DWELLING UNIT = 1,659 SQ.FT.

ADDITION + REHAB AREAS (630 SF)

----- = 38% (<50%)

FINISHED DWELLING AREA = 1659 SF

RESIDENTIAL SPRINKLERS NOT REQUIRED

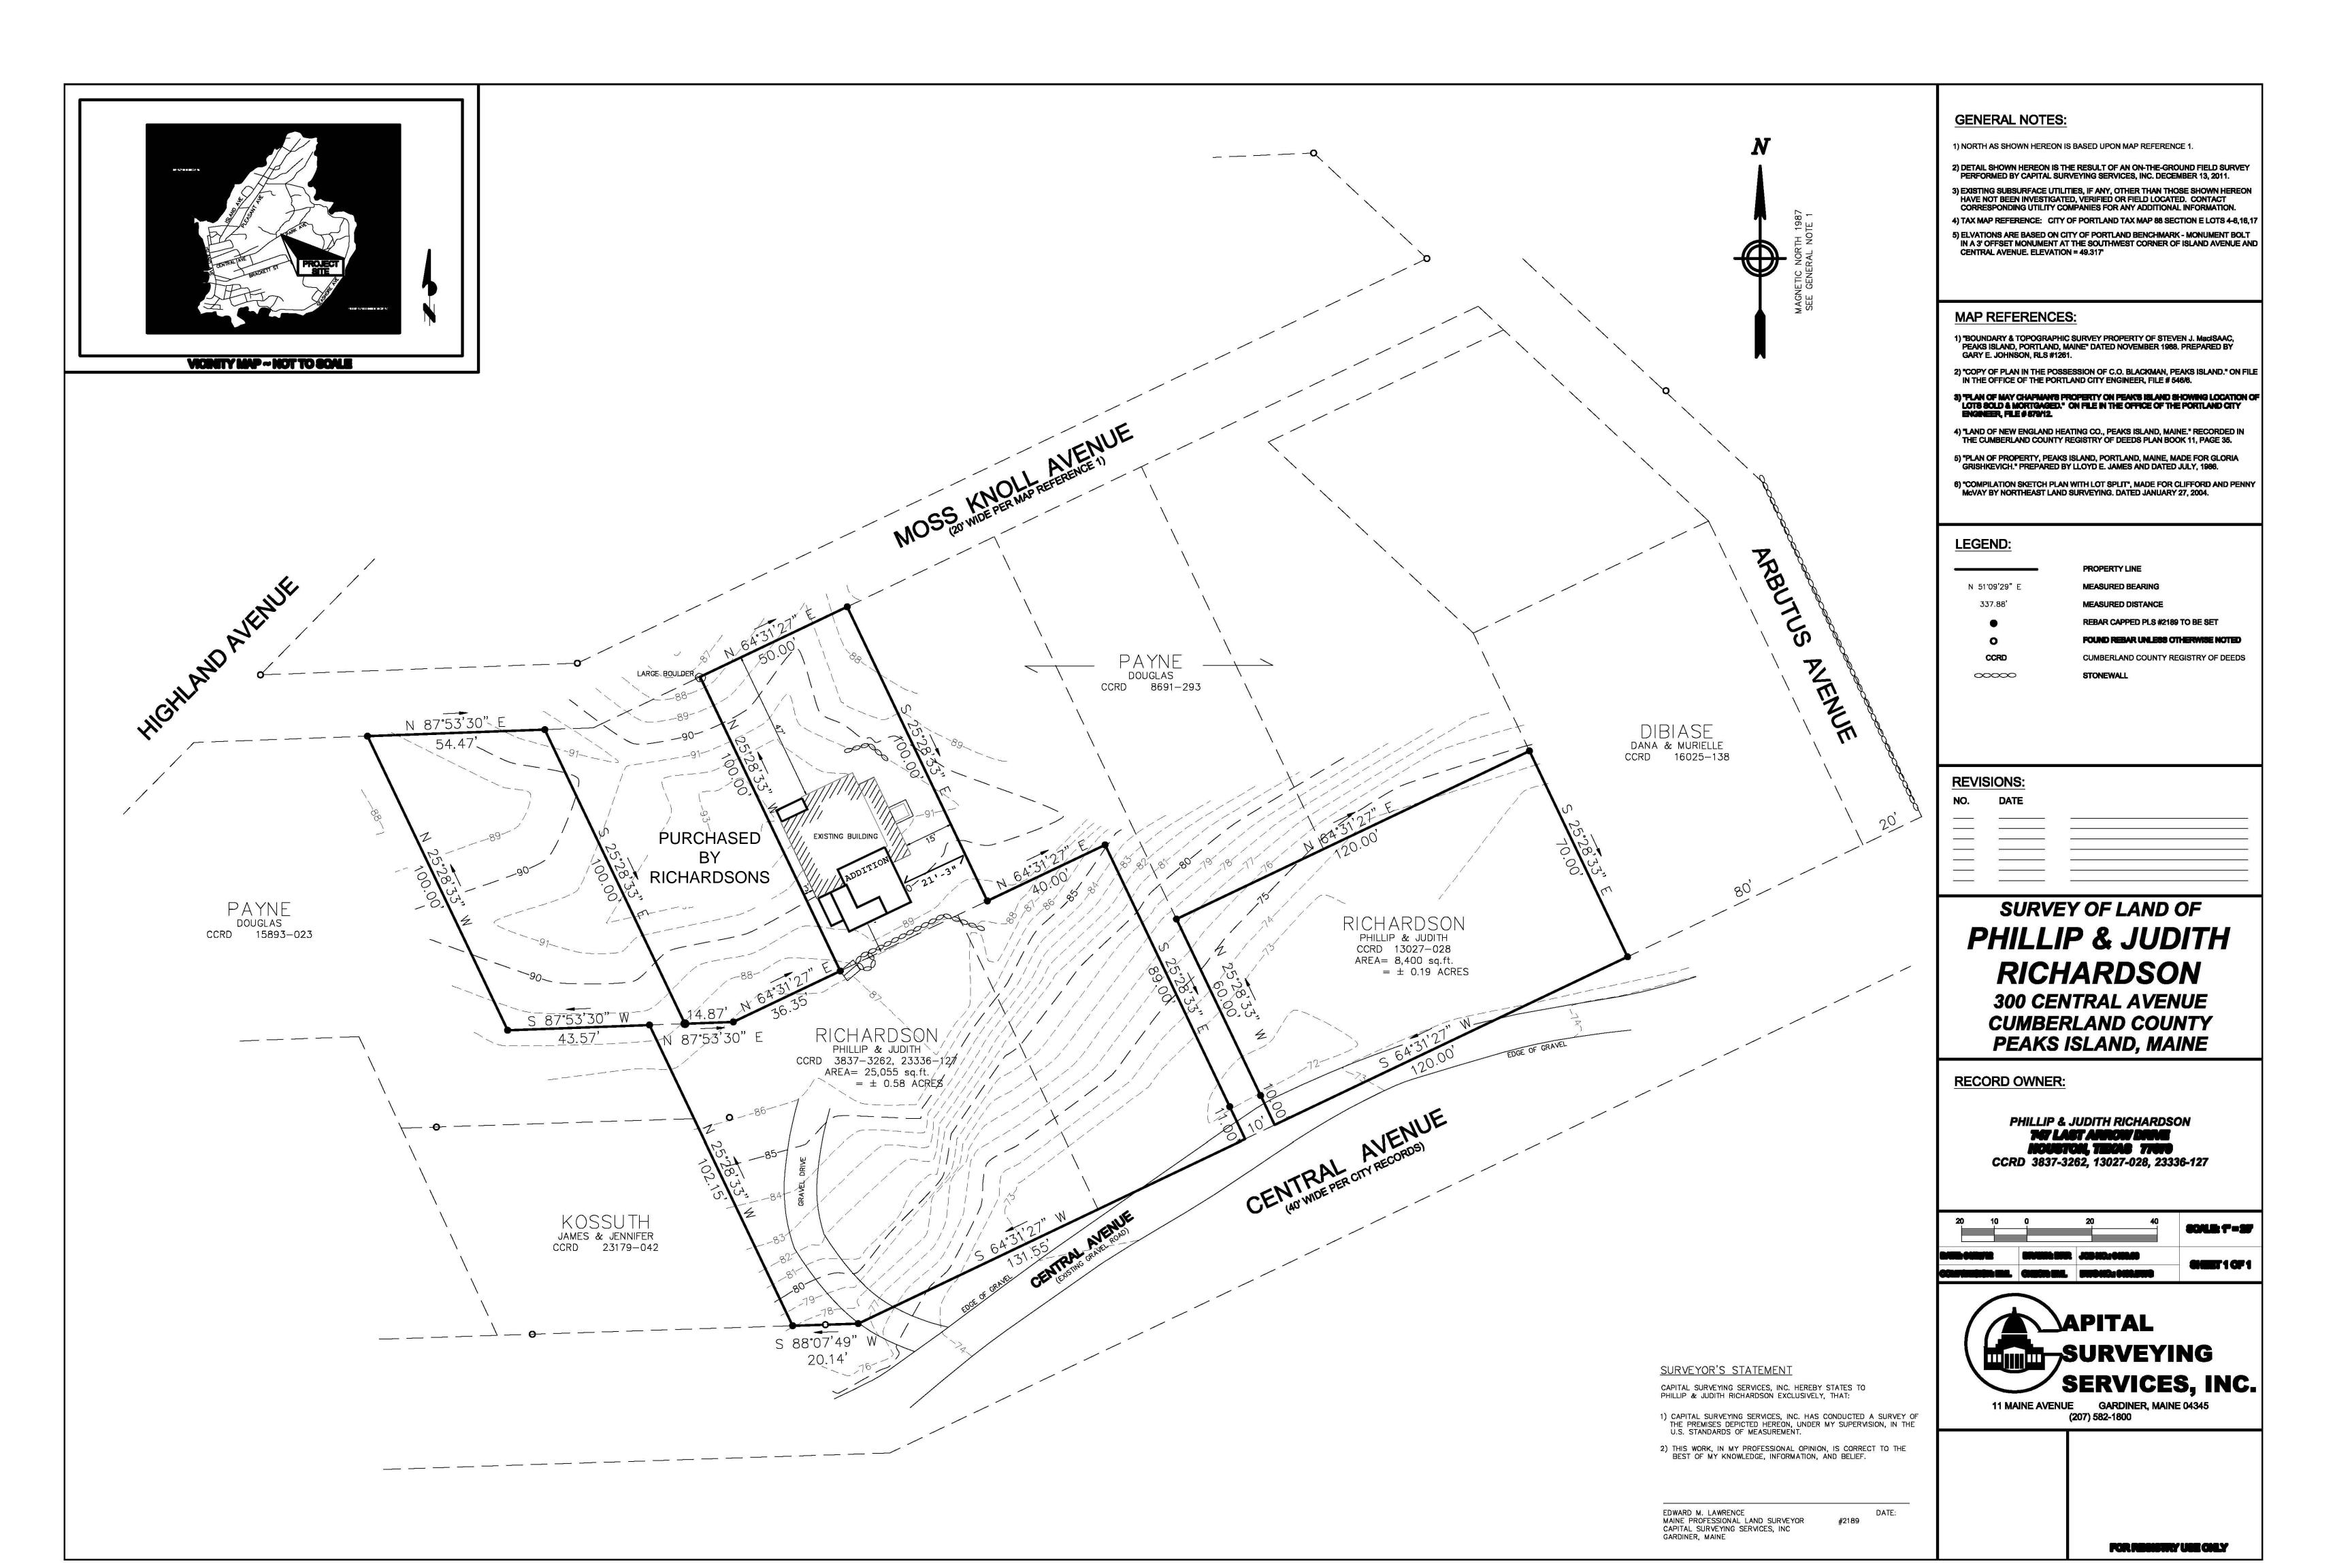



#### DOOR SCHEDULE NUMBER WIDTH HEIGHT HARDWARE NOTE REINSTALL EXISTING OWNER TO SELECT 3'-0" 6'-8" CL 2'-8" **OWNER TO SELECT** 6'-8" PDPS 1'-0" OWNER TO SELECT 6'-8" PS 2'-8" 6'-8" PL OWNER TO SELECT

6		6'-8"	PS	OWNER TO SELECT
7	2'-8"	6'-8"	PL	OWNER TO SELECT
8	ELIMINATED			
9	2'-0"	SLOPED	PS	9 AND 10 TO BE SITE BUILT FROM BEAD BOARD, SEE ELEVATIONS
10	2'-0"	SLOPED	PS	
11	2'-0"	6'-8"	PS	OWNER TO SELECT

OWNER TO SELECT

HADDWADE KEV

5'-0"

HARDWARE KEY

CL CYLINDER LOCKSET DOOR TYPES ARE EITHER SINGLE LEAF,
PL PRIVACY LOCKSET BIFOLD, OR POCKET AS INDICATED ON THE
PS PASSAGE SET PLAN. OWNER TO SELECT STYLE.

PDPS POCKET DOOR PASSAGE SET

PS

### **MATERIALS**

6'-8"

FLOORING - PREFINISHED WOOD FLOORING TO BE SELECTED BY OWNER.

BASE - 4" FLAT STOCK CLEAR PINE IN MULTI-PURPOSE ROOM, BEDROOM, SECOND FLOOR CORRIDOR, BATHROOM - NOT PRE-PRIMED.

WALLS - DRYWALL (LEVEL 3 FINISH). USE MOISTURE RESISTANT DRYWALL IN BATHROOM, LAUNDRY ROOM.

BEADBOARD IS TO BE CLEAR 1X4 T&G SOUTHERN YELLOW PINE

DECK BOARDS AND EXTERIOR STAIRS - PLASTIC COMPOSITE (COLOR BY OWNER) - PROVIDE 1/4 " GAP BETWEEN BOARDS FOR VENTILATION.

PORCH SKIRTING - PVC

EXTERIOR TRIM BOARDS - PRE-PRIMED, NON FINGER JOINTED PINE.

SEE ELEVATIONS AND SECTIONS FOR OTHER NOTES PERTAINING TO MATERIALS.

USE PT COMPATIBLE FASTENERS AND HANGERS WITH ALL CONSTRUCTION USING PRESSURE TREATED LUMBER.

USE STAINLESS STEEL FASTENERS FOR ALL EXTERIOR TRIM.

### INTERIOR FINISHES KEY NOTES

EXISTING SHINGLES, DOORS, WINDOWS TO REMAIN ON THIS WALL, UNLESS INDICATED OTHERWISE ON DEMOLITION PLANS

1X4 PINE BEADBOARD WITH CHAIR RAIL CAP ON WALL (TOP OF CHAIR RAIL TO MATCH TOP OF BENCH IN NOOK - 3'-3") - FULL HEIGHT GWB TO EXTEND DOWN TO FLOOR BEHIND BEADBOARD

FULL HEIGHT 1X4 PINE BEADBOARD, ADD BLOCKING AS REQ. FOR ATTACHMENT

1X4 PINE BEADBOARD WITH CHAIR RAIL TO MATCH HEIGHT OF EXISTING BEADBOARD IN UPSTAIRS, APPROX. 3'-7" - FULL HEIGHT GWB TO EXTEND DOWN TO FLOOR BEHIND BEADBOARD NOTE: UNLESS TAGGED DIFFERENTLY, ASSUME FULL HEIGHT

### DEMOLITION KEY NOTES

GWB FOR INTERIOR WALL FINISH

(D1) - REMOVE AND KEEP DOOR FOR REUSE

(D2) - DEMOLISH WINDOW

D3) - DEMOLISH WALL

D4) - DEMOLISH ENTIRE ENTRY PORCH, RAILING, AND STAIR

D5) - DEMOLISH THIS AREA OF PORCH ROOF

06) - DEMOLISH PORCH RAILING, SCREENING, ROOF AND STRUCTURE ABOVE

D7) - DEMOLISH PORCH FLOOR BOARDS IN AREA OF ADDITION

D8) - DEMOLISH PORCH STRUCTURE IN AREA OF ADDITION

D9) - DEMOLISH PORTION OF GABLE ROOF REQUIRED FOR NEW CORRIDOR, SEE STRUCTURAL

010- REMOVE ROOF EAVE AS REQUIRED TO ALLOW FOR INSTALLATION OF NEW WALL

D11)- REMOVE EXTERIOR FINISHES TO SIDING

AND ADD NEW GWB

NOTE: GC TO PROVIDE TEMPORARY SHORING

AS REQUIRED FOR ALL DEMOLITION

### ALLOWANCES

OPERATIONS

ALLOWANCES INCLUDE COST OF MATERIAL ONLY, NOT DELIVERY OR INSTALLATION - THE FOLLOWING ALLOWANCES ARE TO BE INCLUDED IN THE


BATHROOM - \$800.00 TOTAL FOR A 4"-0" VANITY, 3'-0" X 3'-0" SHOWER UNIT, TOILET, AND ACCESSORIES.


DOORS (PREHUNG) - \$2,200 FOR DOORS 2-8, 11-12. ALLOWANCE INCLUDES HARDWARE BUT NOT THRESHOLDS AND TRANSITIONS. INTERIOR DOORS TO BE WOOD, EXTERIOR DOOR TO BE STEEL. ALLOWANCE DOES NOT COVER THE COST TO REINSTALL DOOR 1 AND TO SITE BUILD DOORS 9,10, AND THE DOOR FOR OUTDOOR STORAGE (GC TO CARRY COST FOR THESE THREE DOORS SEPARATELY IN ESTIMATE).


LIGHTING FIXTURES - \$1,000 TOTAL FOR INTERIOR AND EXTERIOR FIXTURES - SEE POWER PLANS.

NEW ELECTRICAL ENTRANCE/MAST - \$2000. IT IS NOT CURRENTLY KNOWN IF EXISTING PANEL, METER, AND MAST WILL NEED TO BE REPLACED. CARRY THIS NUMBER IN ESTIMATE AS A PLACE HOLDER TO ACCOUNT FOR THIS WORK IN THE EVENT IT IS REQUIRED.

FLOORS - CARRY A UNIT PRICE OF \$5.00 PER SQUARE FOOT FOR PRE-FINISHED WOOD FLOORS THROUGHOUT ADDITION.

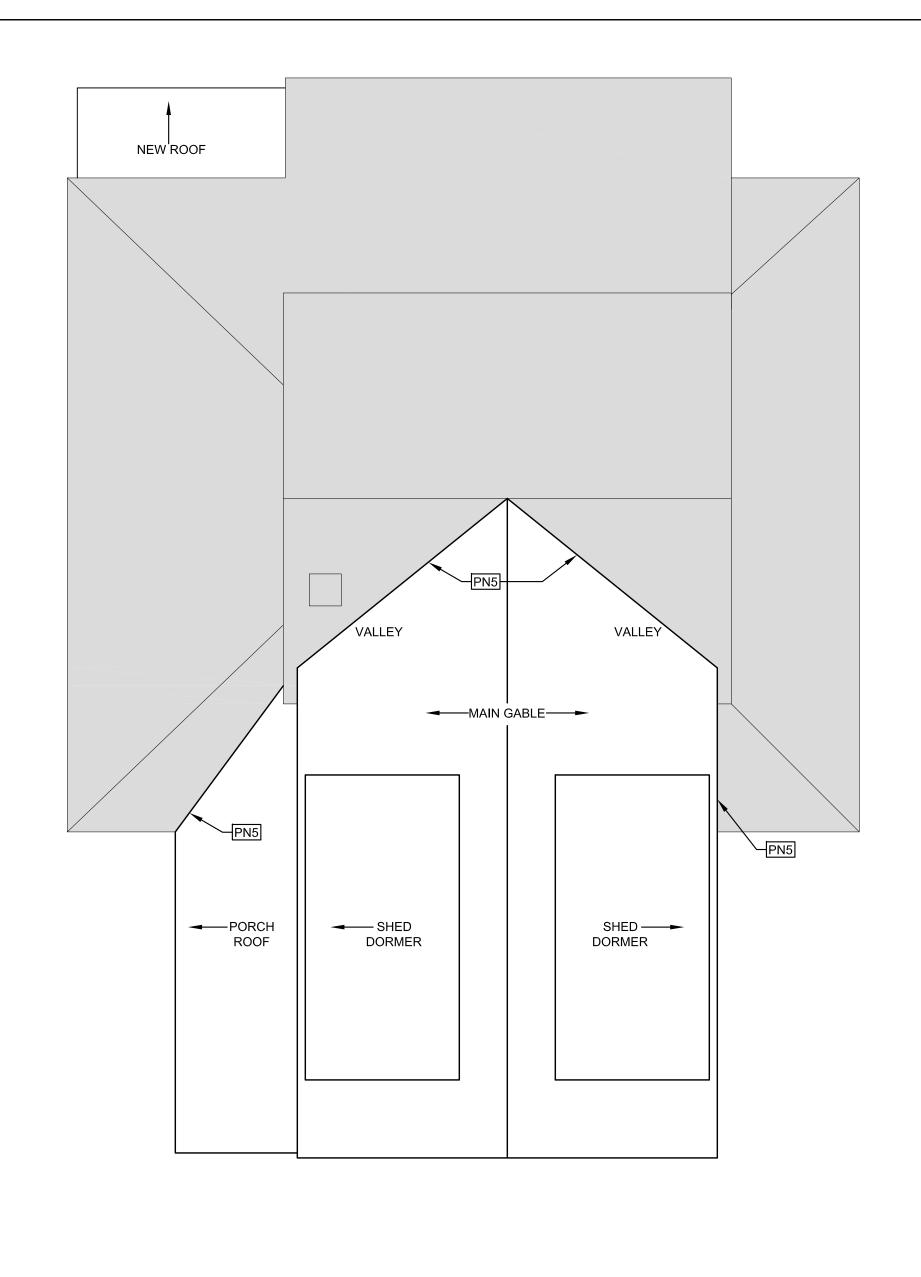


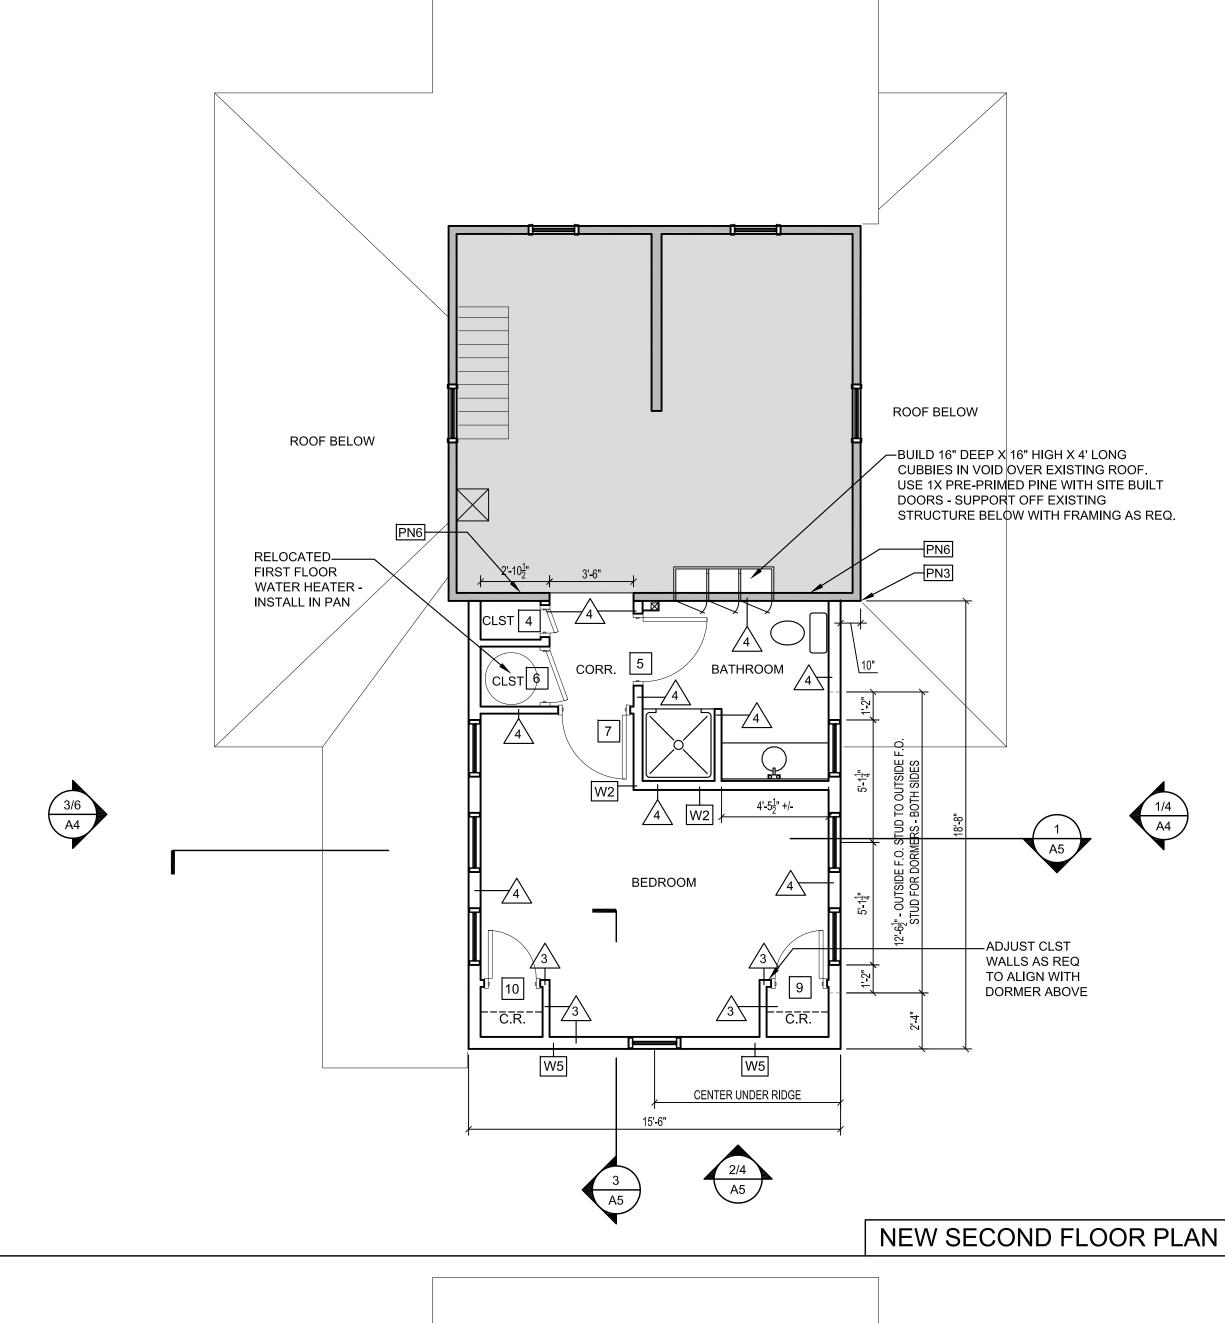

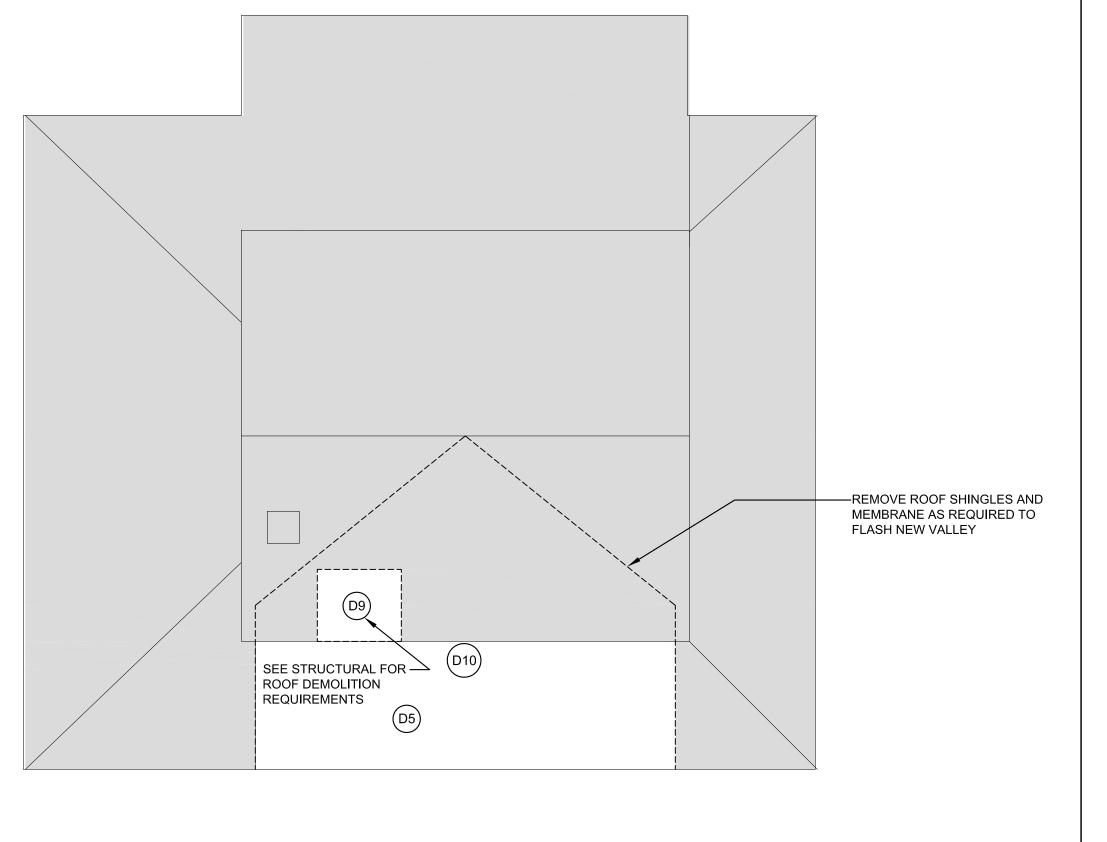

NEW ROOF PLAN

EXISTING ROOF/DEMOLITION PLAN

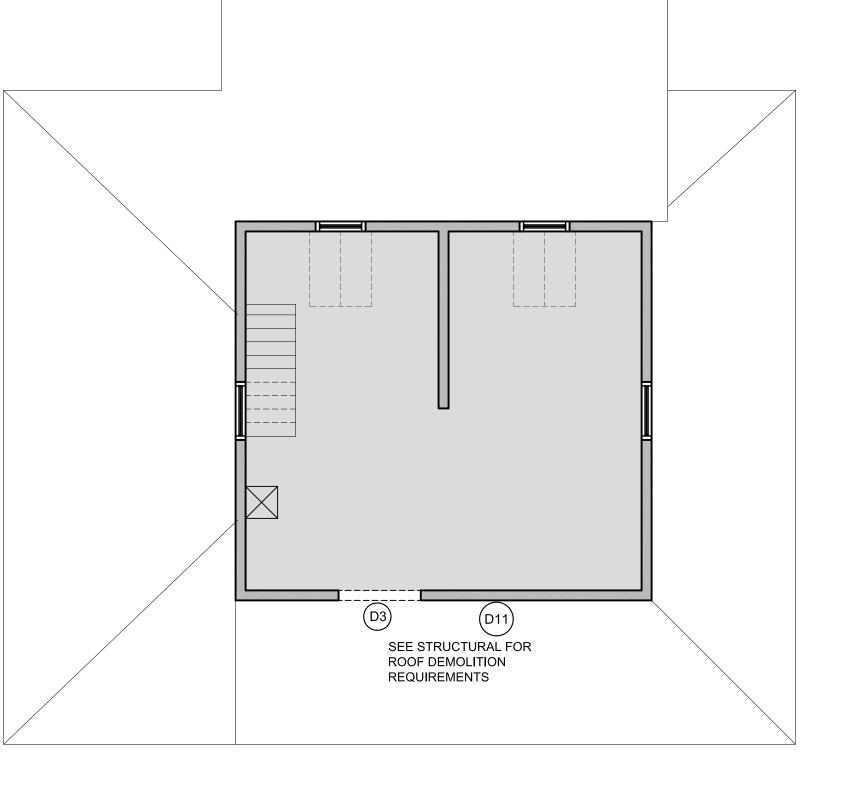

PLAN NORTH

PERMIT DRAWINGS


SEPTEMBER 21, 2012


SCALE: \frac{1}{4}" = 1'-0"

SECOND FLOOR AND ROOF PLANS, DOOR SCHEDULE, ALLOWANCES, NOTES

**A2** 

EXISTING SECOND FLOOR/DEMOLITION PLAN

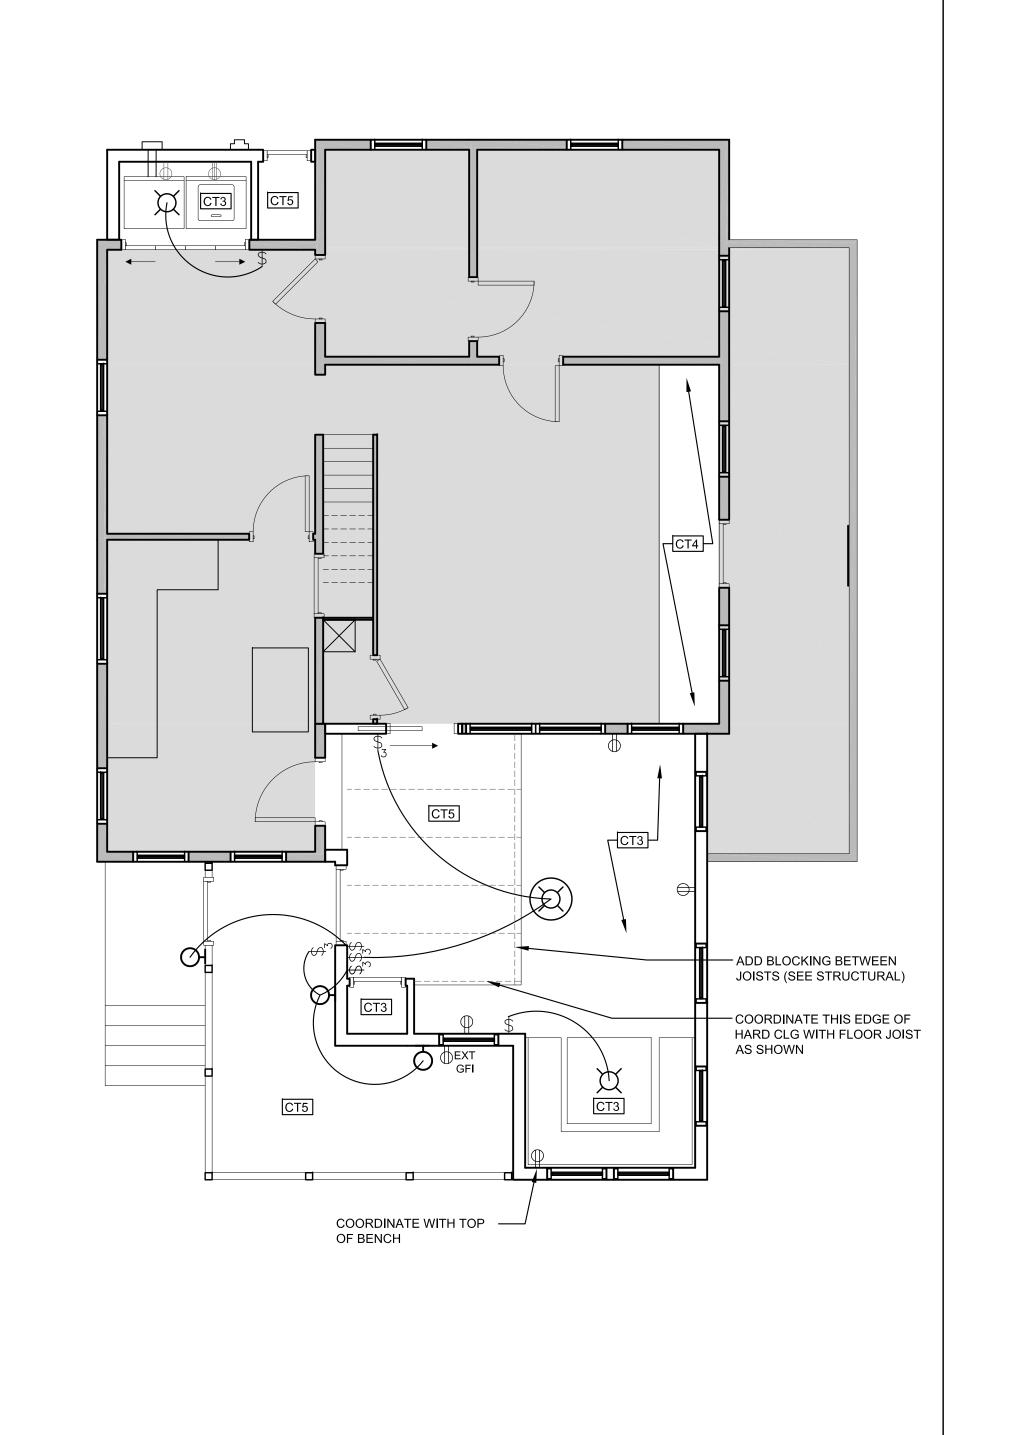

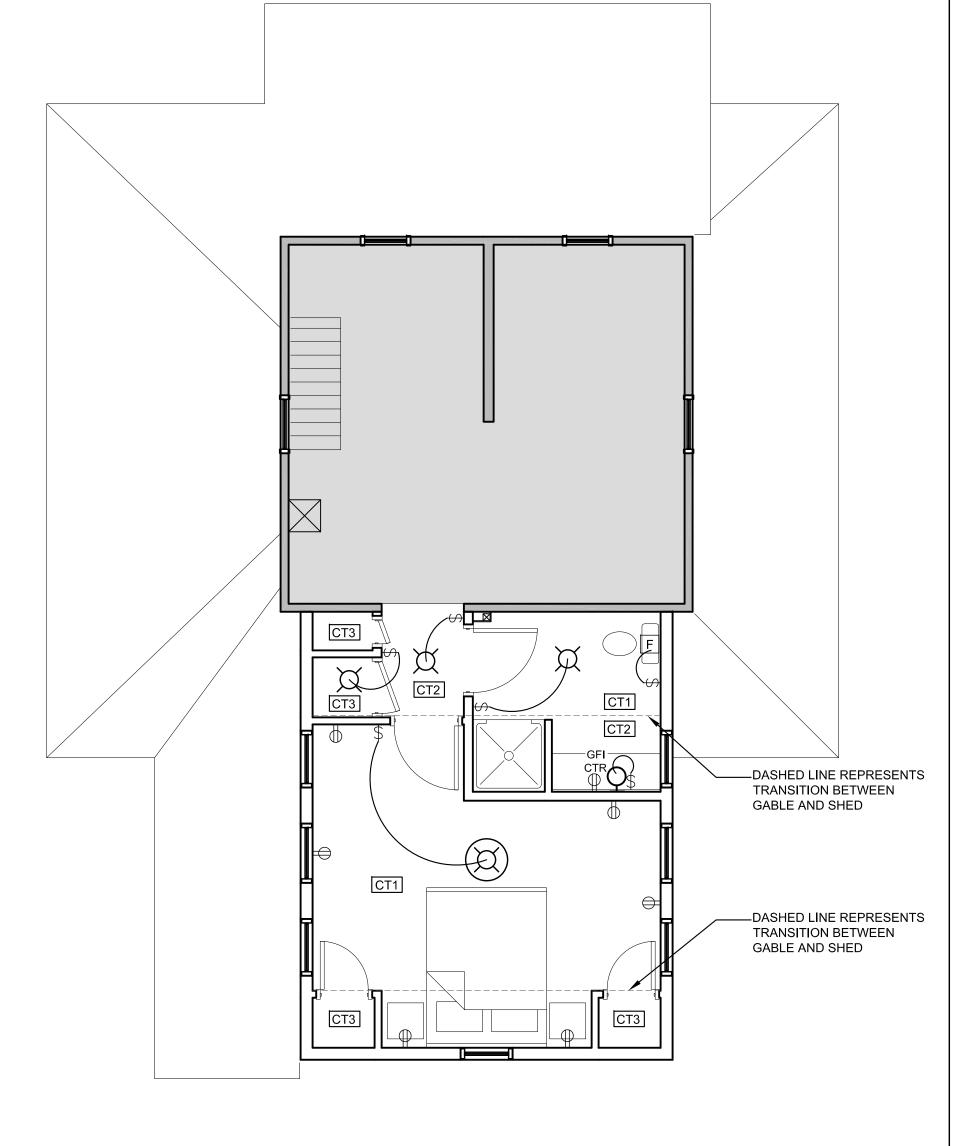

300 Central Avenu Peaks Island, Maine

PLAN NORTH

FIRST FLOOR REFLECTED CEILING AND POWER PLAN

## SECOND FLOOR REFLECTED CEILING AND POWER PLAN SEPTEMBER 21, 2012

### POWER PLAN NOTES

ALL WORK TO CONFORM TO N.E.C. AND OTHER GOVERNING CODES.

MOUNT SWITCHES AT 4'-0" TO TOP OF PLATE.

MULTIPLE SWITCHES SHOWN IN SAME LOCATION SHALL BE GANGED UNDER COMMON PLATE.

SWITCHES SHOWN ADJACENT TO DOORS ARE TO BE LOCATED CLOSE TO FRAME ON LOCK

FIXTURES SHOWN ON THE DRAWING ARE TO BE SELECTED BY THE OWNER. SEE ALLOWANCES.

### **CEILING TYPES**

CT1 - VAULTED GWB CEILING TO FOLLOW SLOPE OF ROOF/STRUCTURE. TURN HORIZONTAL AT BOTTOM OF MAIN SUPPORT/RIDGE BEAM.

CT2 - FLAT GWB CEILING AT 8'-0" UNLESS NOTED OTHERWISE ON DRAWING.

CT3 - GWB CLG HELD TIGHT TO STRUCTURE

CT4 - BEADBOARD PLUMBING SOFFIT - HELD TIGHT TO PLUMBING - AS TIGHT TO STRUCTURE AS POSSIBLE - LIMIT TO 1 JOIST BAY - TURN UP JOIST AND EXTEND TO EXPOSED FLOOR BOARDS (ENCAPSULATE EXISTING JOIST)

CT5 - EXPOSED FRAMING

### LEGEND

\$ SINGLE WALL SWITCH

3-WAY WALL SWITCH
220 VOLT OUTLET

220 VOLT OUTLET

DUPLEX WALL OUTLET

GFI GFI DUPLEX OUTLET - COUNTER HEIGHT

WALL SCONCE

PENDANT LIGHT

PENDANT LIGHT WITH FAN

F FAN


REFLECTED CEILING AND POWER PLANS


SCALE:

 $\frac{1}{4}$ " = 1'-0"

PERMIT DRAWINGS

**A3** 

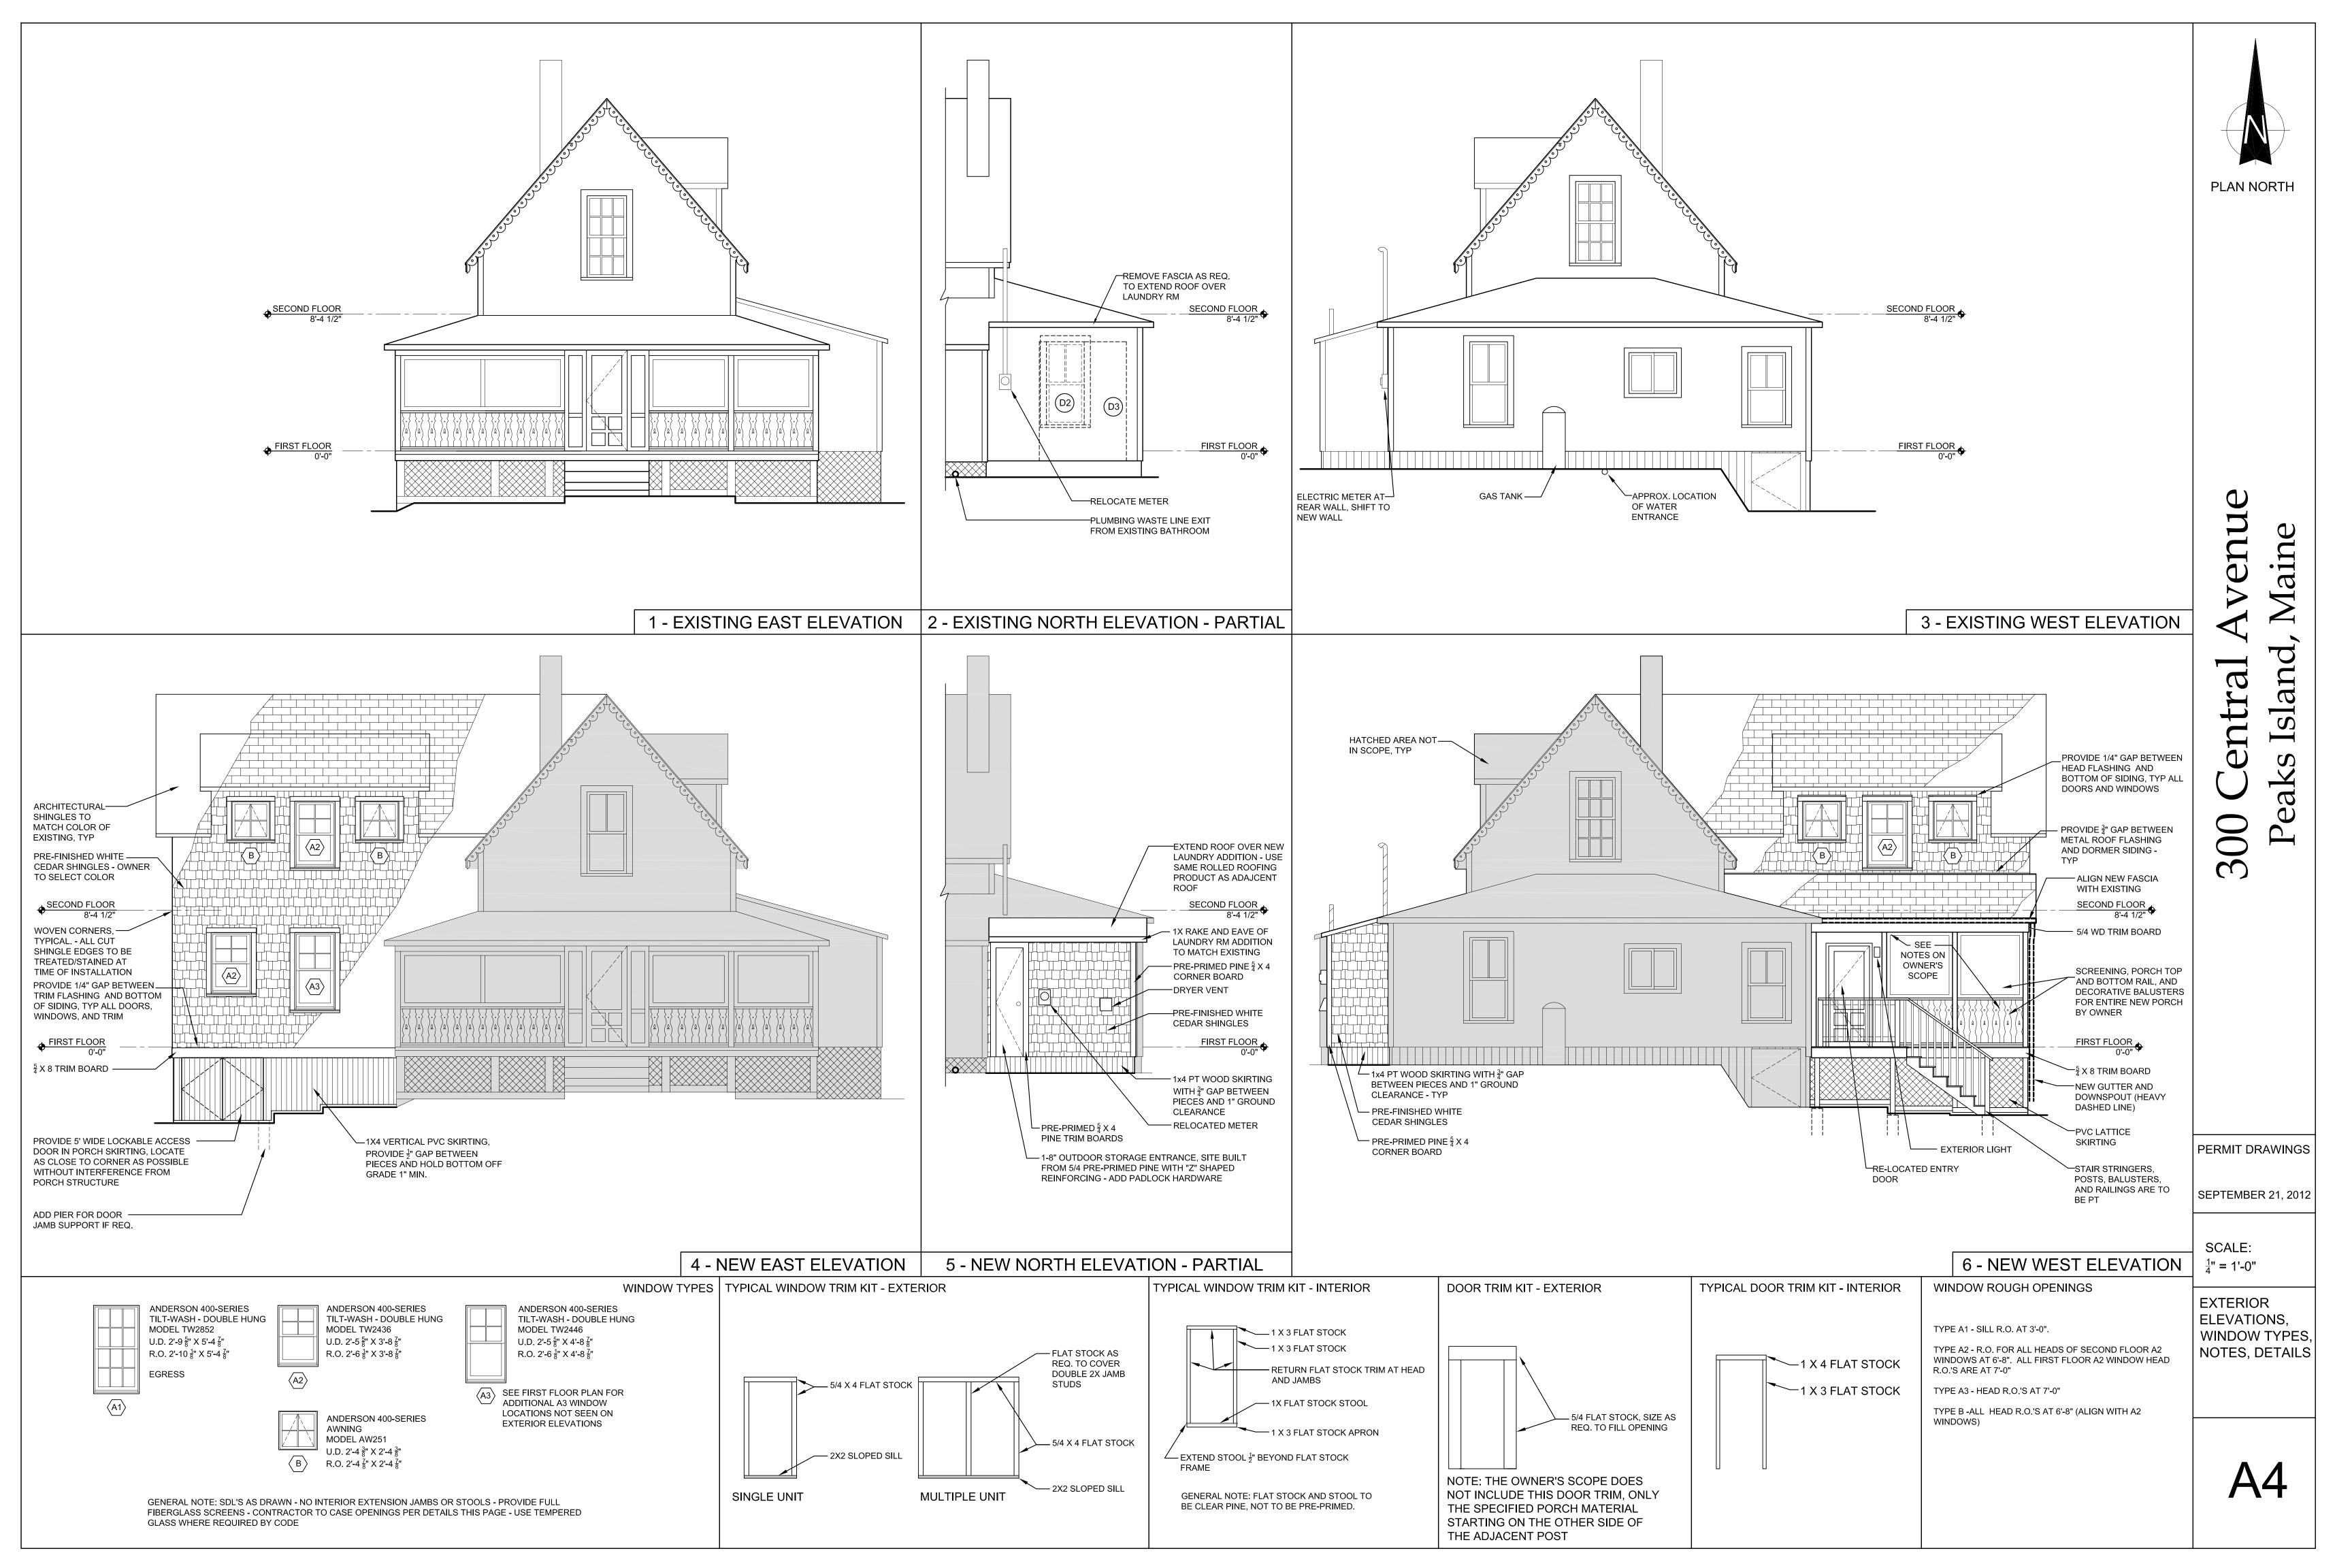

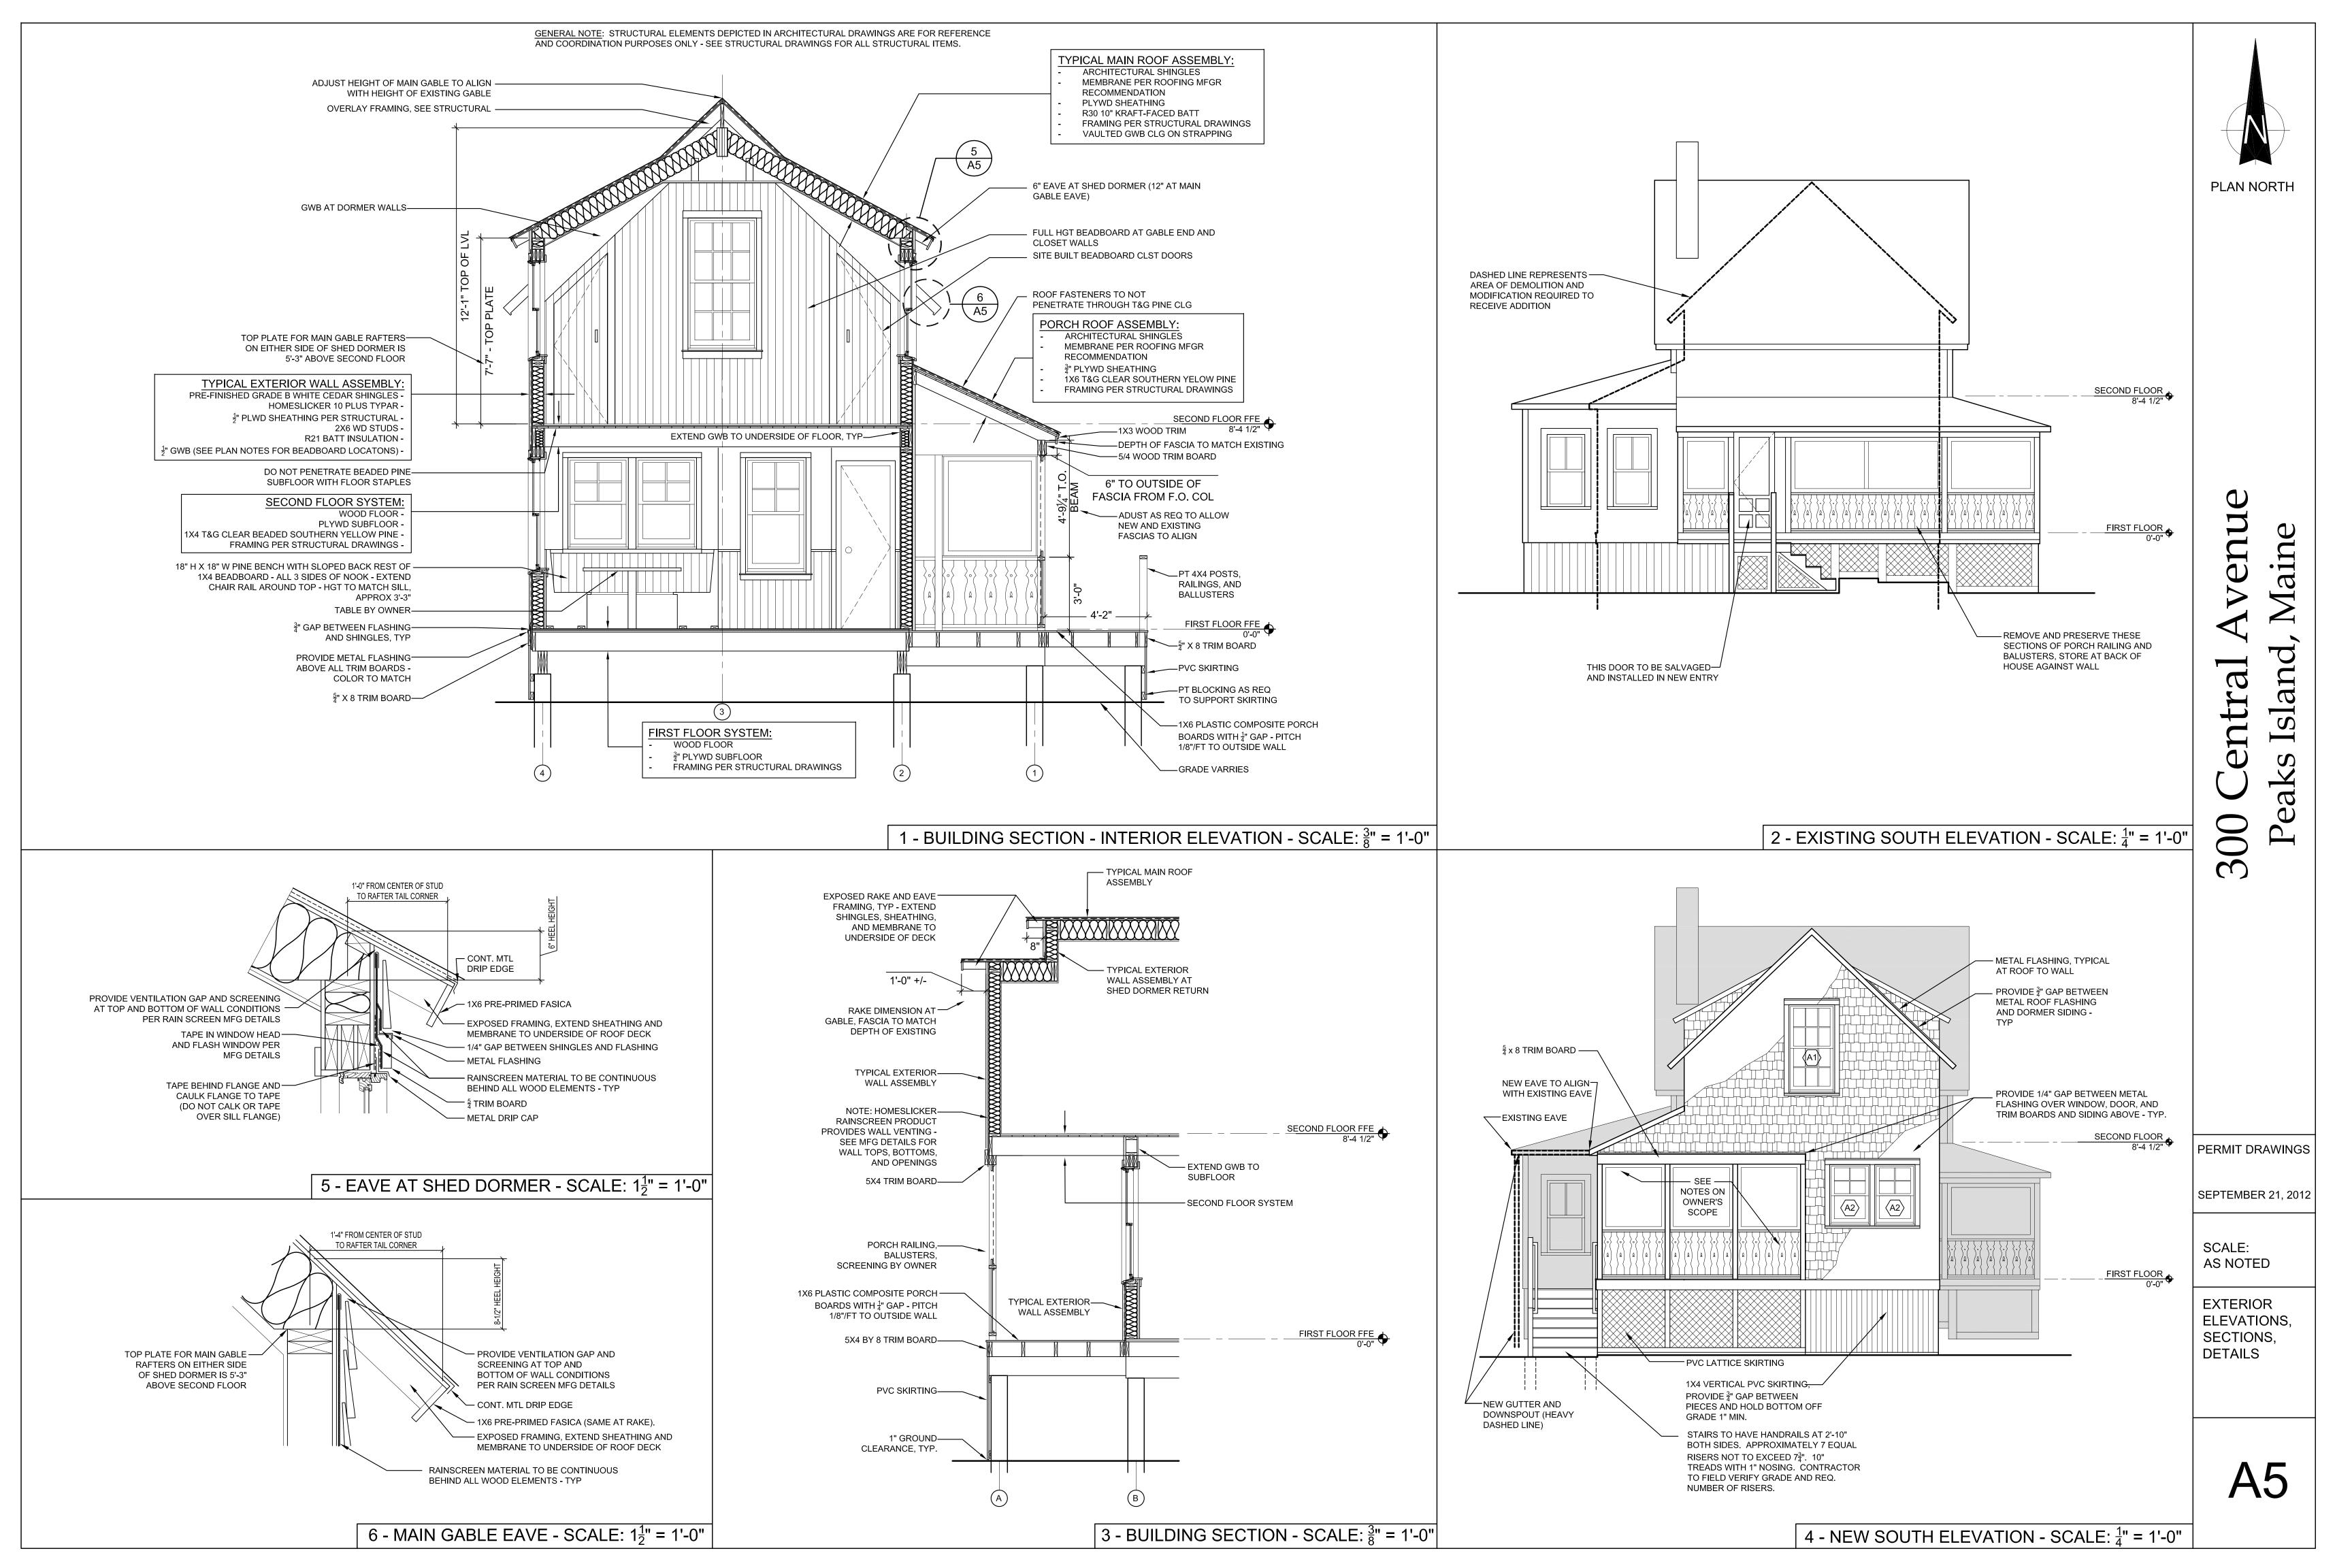


**WOOD NOTES** 

SCALE: NTS


SCALE: NTS

**CONCRETE NOTES** 

ANCHOR BOLT DOUBLE ANGLE ADDL ADDITIONAL ARCH ARCHITECT POUND LINEAR FOOT LONG LEG HORIZONTAL LONG LEG VERTICAL LLV BOTTOM OF FOOTING BLDG BUILDING MAX MAXIMUM RFAM MECH MECHANICAL BOTTOM MFR MANUFACTURER BEARING MINIMUM BTWN BETWEEN MISC **MISCELLANEOUS** STRUCTURAL STEEL CHANNEL NEAR FACE CANT CANTILEVER NUMBER CAST-IN-PLACE CONCRETE CIP NEAR SIDE CONTROL JOINT NOT TO SCALE CENTERLINE CLR OC ON CENTER CONCRETE MASONRY UNIT CMU OUTSIDE FACE CONSTRUCTION JOINT CNJ OPNG OPENING COL COLUMN OPP OPPOSITE CONC CONCRETE CONN CONNECTION CONT PIER DESIGNATION CONTINUOUS CONTR CONTRACTOR PARTIAL PENETRATION WELD COMPLETE PENETRATION WELD CP PREFABRICATED CY CUBIC YARD POUNDS PER SQUARE FOOT DIA PSI POUNDS PER SQUARE INCH DIAMETER DIMENSION REINF REINFORCING STEEL DISCONT DISCONTINUOUS REQ, REQD REQUIRED DWG DRAWING ROOF DRAIN EXISTING (E), EX, EXIST SLIP CRITICAL SECT SECTION EACH FACE SHEATH SHEATHING EL, ELEV ELEVATION SIM SIMII AR FOUAL SOG SLAB-ON-GRADE EQUIP **EQUIPMENT** SPAC SPACING EACH SIDE SPECS **SPECIFICATIONS** EACH WAY STAINLESS STEEL EXP EXPANSION STD STANDARD EXTERIOR STIFF STIFFENER STEEL FOOTING DESIGNATION STR STRAIGHT FDN FOUNDATION STRUCT STRUCTURAL FINISH FLOOR FLG FLANGE FLR FLOOR T&B TOP AND BOTTOM FOOT TOC, T/CONC TOP OF CONCRETE FTG FOOTING T/FTG, TOF TOP OF FOOTING FIELD VERIFY TEMPERATURE T/SHELF GAGE TOP OF SHELF GALV GALVANIZED T/SLAB TOP OF SLAB TOP OF STEEL HOR, HORIZ HORIZONTAL T/WALL TOP OF WALL HSS HOLLOW STRUCTURAL SHAPE STRUCTURAL TUBING HEIGHT TYP TYPICAL INSIDE FACE UNO UNLESS NOTED OTHERWISE INFO INFORMATION VER, VERT VERTICAL VERIFY IN FIELD JOINT STRUCTURAL STEEL WIDE FLANGE KIP (1 KIP = 1,000 LBS)KIPS PER SQUARE INCH WITHOUT WORK POINT WEIGHT WELDED WIRE FABRIC

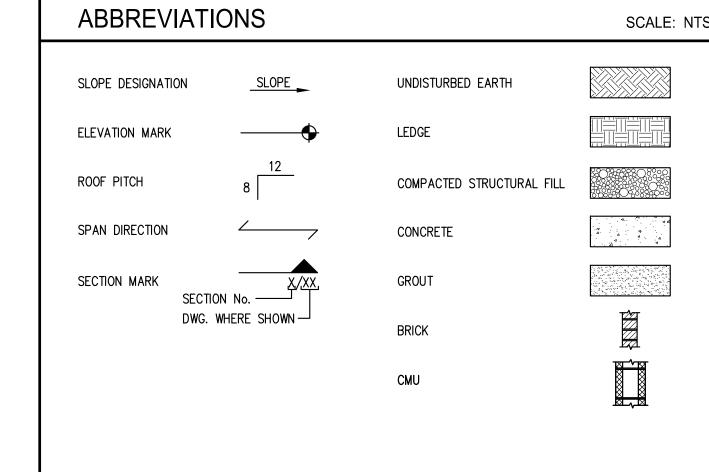


LEGEND

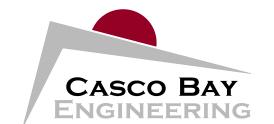

424 Fore Street
Portland, ME 04101
Phone 207.842.2800
Fax 207.842.2828
www.cascobayengineering.com

CLIENT:

PHIL RICHARDSON
300 CENTRAL AVENUE
PEAKS ISLAND, ME 04108

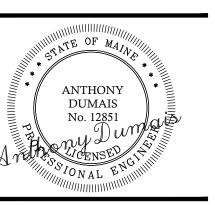

CE PEAKS ISLAND, MA

RICHARDSON RESIDE

No. DESCRIPTION BY BY DATE

O PERMIT DRAWINGS

TD TD 9-21-12

SHEET TITLE:

SCALE: NTS-

STRUCTURAL NOTES


DESIGNED: TD

DRAWN: TD

DATE: 9-14-12

PROJECT NUMBER: 12-078

S000

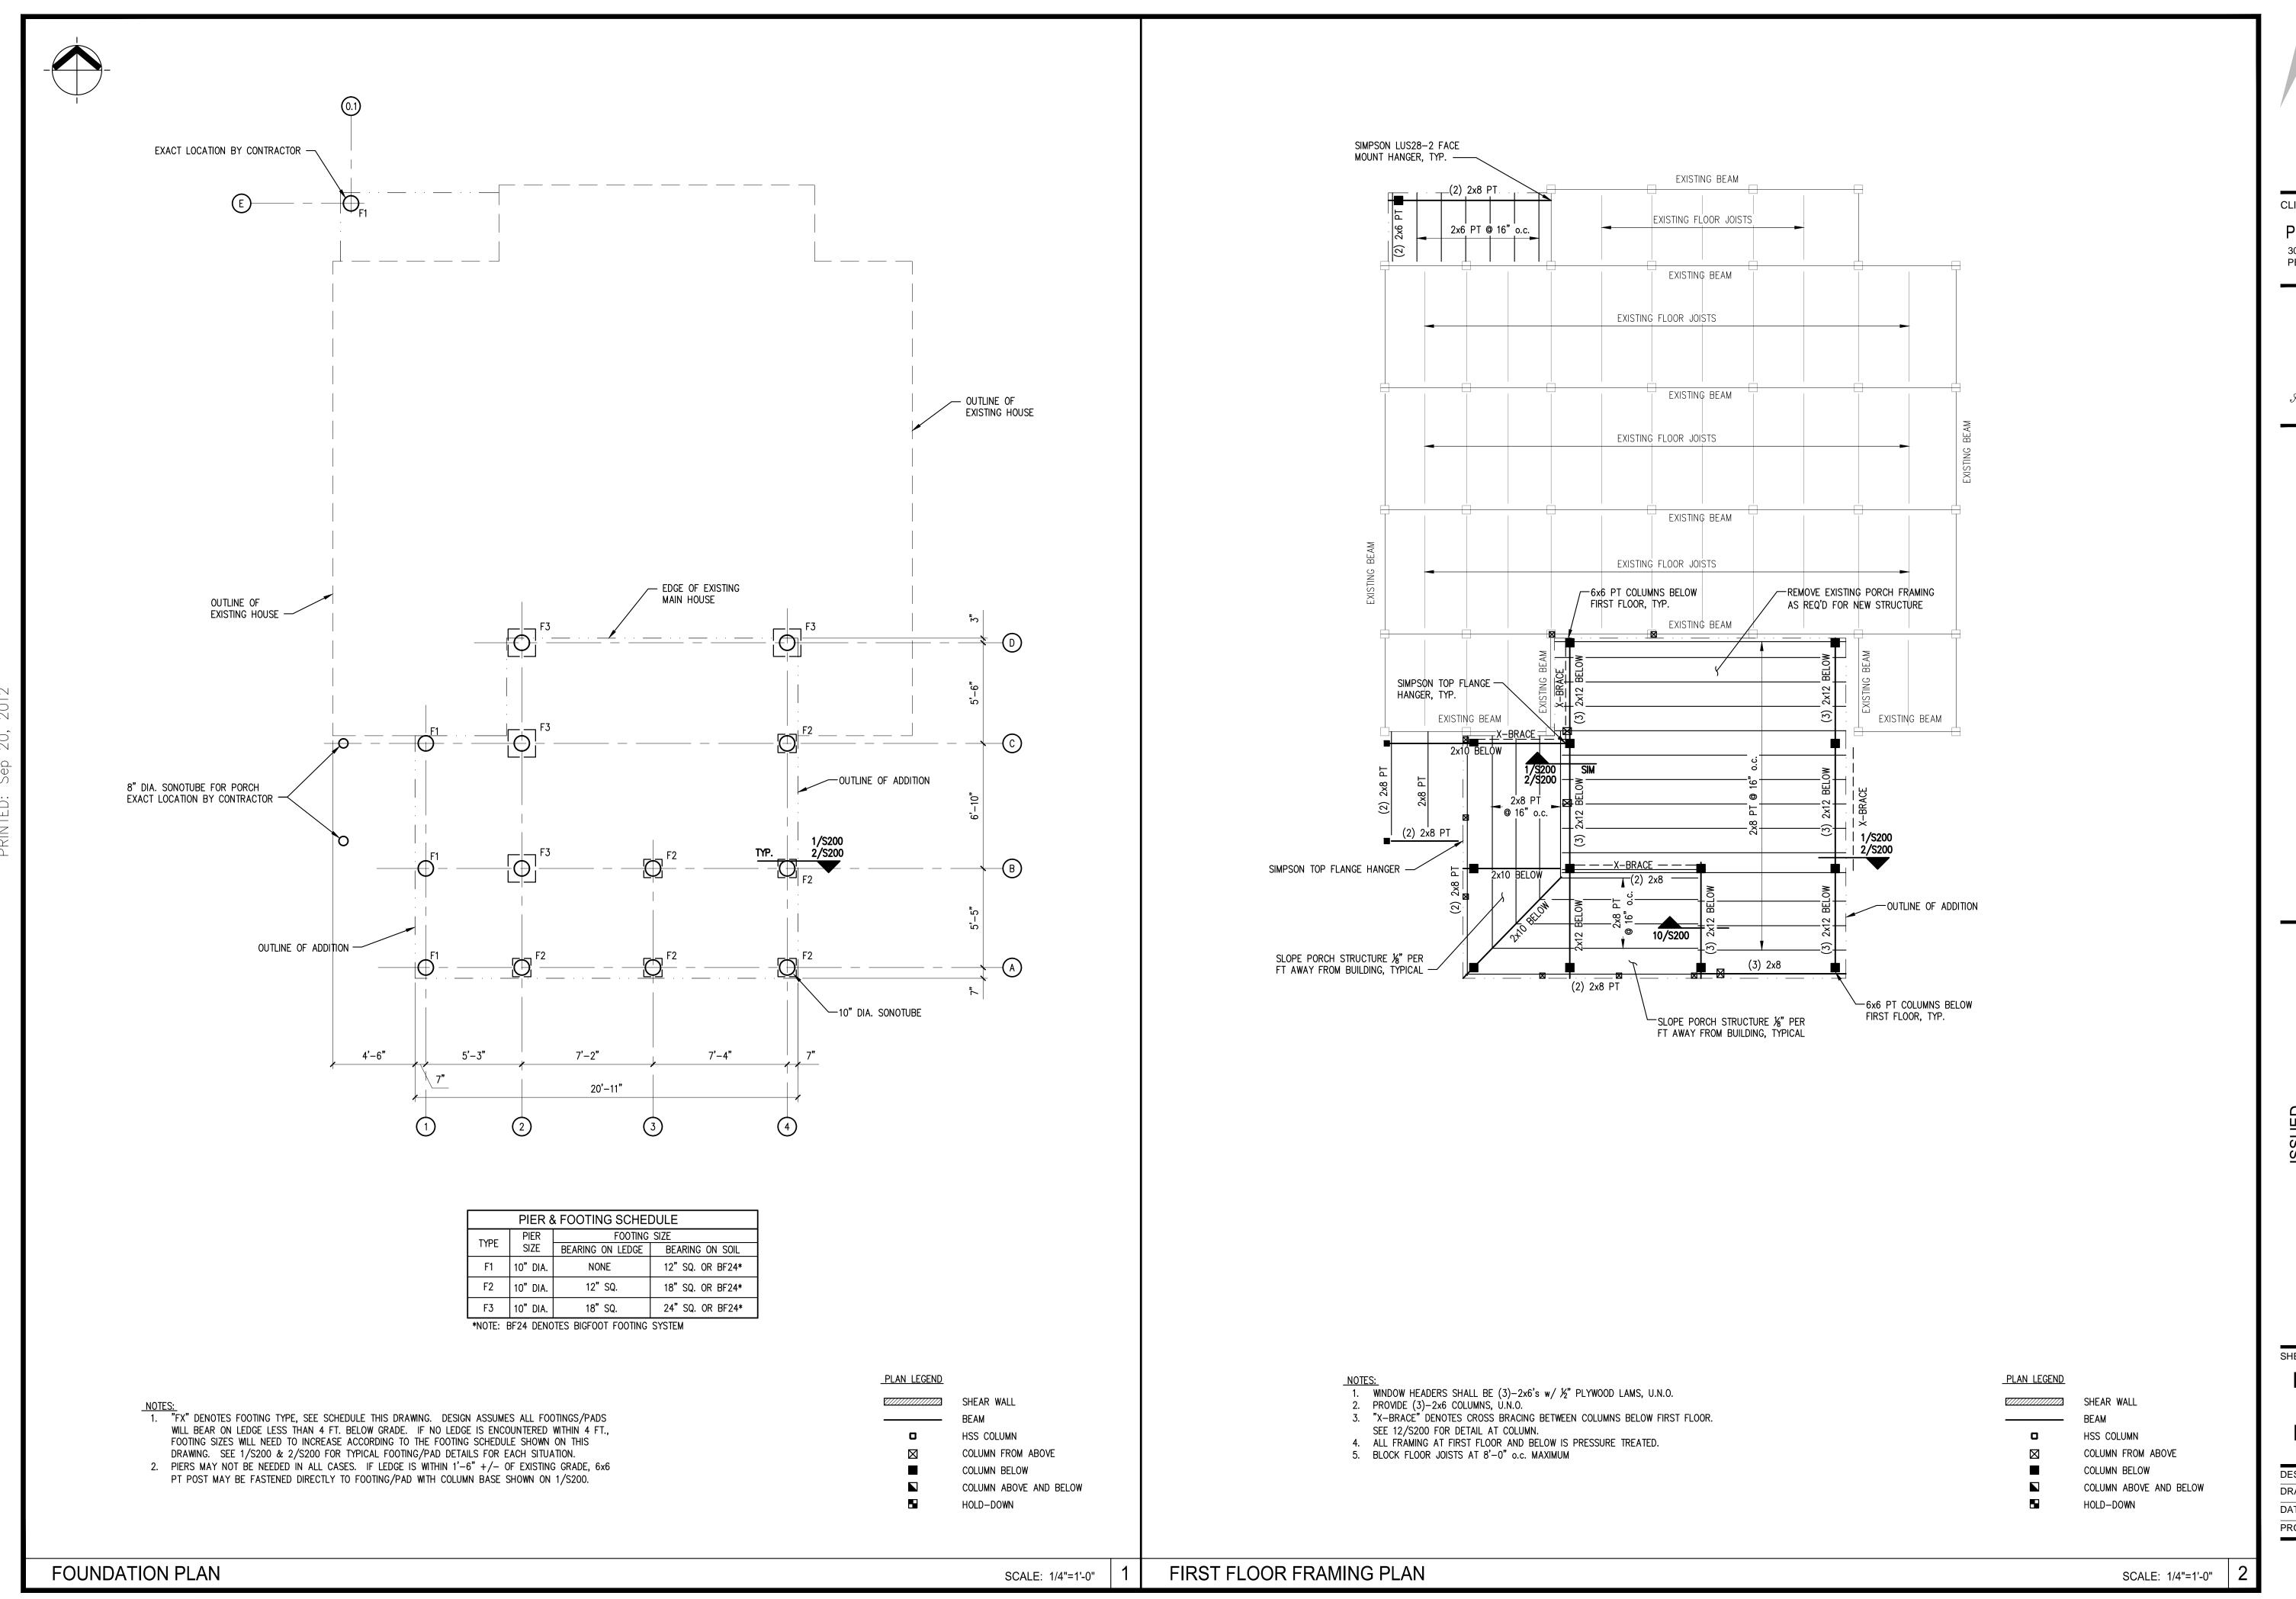


CASCO BAY ENGINEERING

424 Fore Street
Portland, ME 04101
Phone 207.842.2800
Fax 207.842.2828
www.cascobayengineering.com

CLIENT

PHIL RICHARDSON
300 CENTRAL AVENUE
PEAKS ISLAND, ME 04108

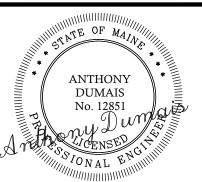

KS ISLAND, MAINE

RESIDENCE

RICHARDSON RESIL 300 CENTRAL AVENUE

No. DESCRIPTION BY BY DATE

0 PERMIT DRAWINGS TD TD 9-21-12

FOUNDATION & FIRST FLOOR

FRAMING PLAN

DESIGNED: TD

DRAWN: TD


DESIGNED: TD

DRAWN: TD

DATE: 9-14-12

PROJECT NUMBER: 12-078

S100

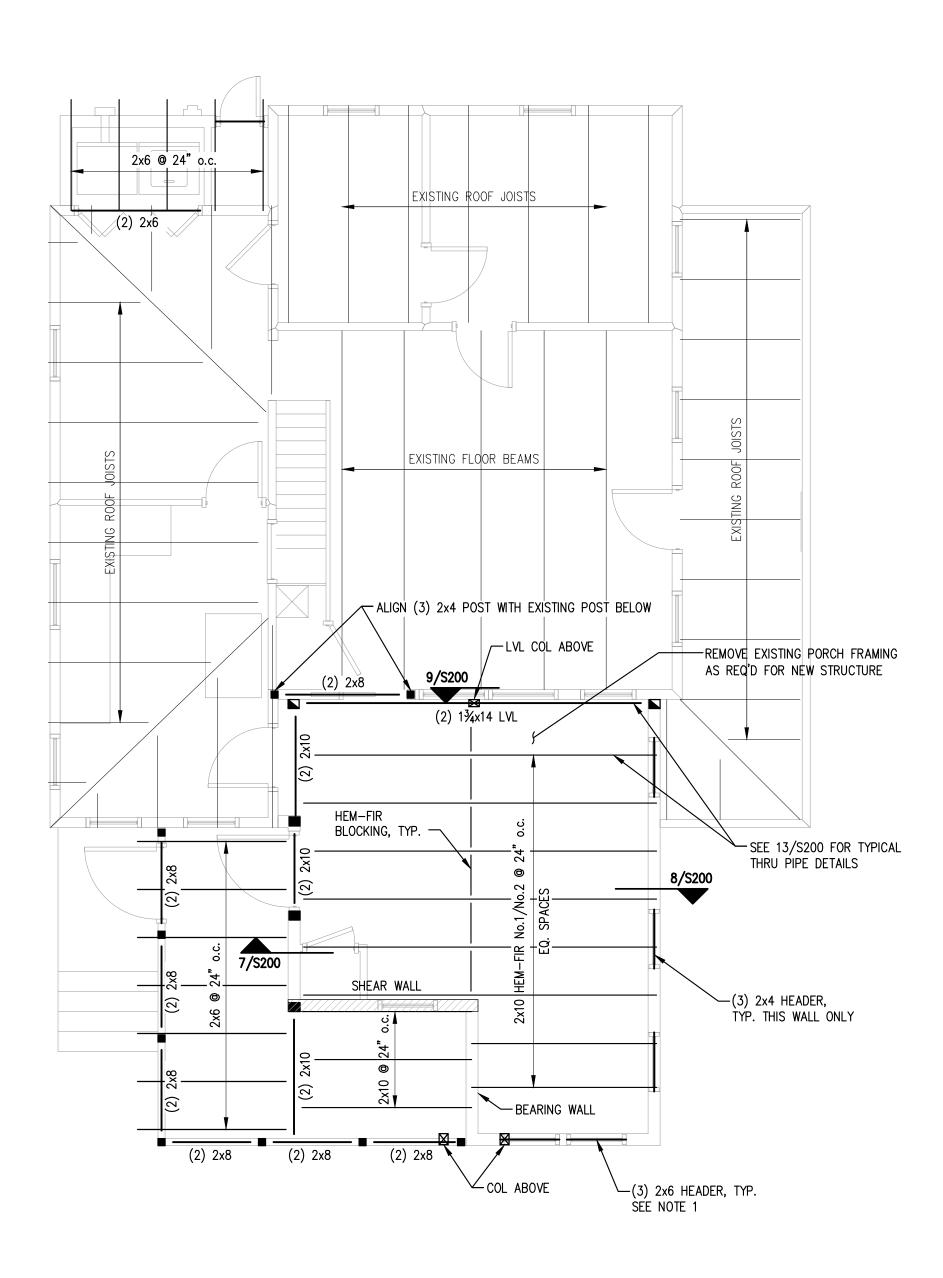

EXISTING ROOF TRUSSES - REMOVE TAIL OF THIS TRUSS ONLY BELOW TIE FOR NEW DOOR OPENING. SEE 6/S200 SIMPSON LSSU210-2 ADJUSTABLE HANGER+31/2×51/4 LVL COL -(3) 2x6 COLUMN, SHEAR WALL

 WINDOW HEADERS SHALL BE (3)-2x6's w/½" PLYWOOD LAMS, U.N.O.
 PROVIDE (3)-2x6's AT ALL COLUMNS, CORNERS AND ENDS OF SHEAR WALLS, U.N.O. 3. ALL SHEAR WALLS SHOWN ON PLAN ARE TO BE SHEATHED ON ONE SIDE WITH ½" APA RATED SHEATHING. NAIL EXTERIOR SHEATHING PANEL EDGES @ 3" o.c. BLOCK AND STAGGER ALL PANEL EDGES. SPACE NAILS AT 12" o.c. AT INTERMEDIATE PANEL EDGES. ALL OTHER EXTERIOR WALLS SHALL HAVE EXTERIOR PANEL EDGES NAILED AT 6" o.c. & 12" o.c. AT INTERMEDIATE PANEL EDGES. 4. SEE 13/S200 FOR TYPICAL DETAILS OF ALLOWABLE HOLES IN FRAMING MEMBERS AND REINFORCEMENT.

5. PROVIDE SIMPSON HANGERS AT ALL JOIST ENDS, TYP.

SECOND FLOOR FRAMING PLAN

HSS COLUMN COLUMN FROM ABOVE COLUMN BELOW COLUMN ABOVE AND BELOW HOLD-DOWN

SCALE: 1/4"=1'-0"

1. WINDOW HEADERS SHALL BE (3)-2x6's w/  $\frac{1}{2}$ " PLYWOOD LAMS, U.N.O.

2. PROVIDE (3)-2x6 COLUMNS, Ù.Ń.O. 3. ALL SHEAR WALLS SHOWN ON PLAN ARE TO BE SHEATHED ON ONE SIDE WITH  $\frac{1}{2}$ " APA RATED SHEATHING. NAIL EXTERIOR SHEATHING PANEL EDGES @ 3" o.c. BLOCK AND STAGGER ALL PANEL EDGES. SPACE NAILS AT 12" o.c. AT INTERMEDIATE PANEL EDGES. ALL OTHER EXTERIOR WALLS SHALL HAVE EXTERIOR PANEL EDGES NAILED AT 6" o.c. & 12"

4. PROVIDE SIMPSON HANGERS AT ALL RAFTER ENDS.

ROOF FRAMING PLAN

DESIGNED: DRAWN: TD 9-14-12 PROJECT NUMBER: 12-078

SECOND FLOOR

& ROOF

FRAMING PLAN

SHEET TITLE:

SCALE: 1/4"=1'-0"

CASCO BAY ENGINEERING

424 Fore Street Portland, ME 04101 Phone 207.842.2800 Fax 207.842.2828 www.cascobayengineering.com

PHIL RICHARDSON 300 CENTRAL AVENUE PEAKS ISLAND, ME 04108

**DUMAIS** 

ARDSON RESIDENCE

RICHA 300 CENTR

**S101** 

PLAN LEGEND SHEAR WALL

PLAN LEGEND SHEAR WALL BEAM HSS COLUMN COLUMN FROM ABOVE COLUMN BELOW o.c. AT INTERMEDIATE PANEL EDGES. COLUMN ABOVE AND BELOW HOLD-DOWN

