
	STRUCTURAL DRAWING LIST
SHEET	TITLE
S1	STRUCTURAL NOTES DECK FOUNDATION PLAN
S2	DECK FLOOR PLAN
S3	DECK ROOF PLAN


## STRUCTURAL NOTES

- 1. STRUCTURE HAS BEEN DESIGNED TO COMPLY WITH THE 2009 INTERNATIONAL CODE COMMITTEE FAMILY OF CODES INCLUDING BY REFERENCE: ASCE 7-10; NATION DESIGN SPECIFICATION FOR WOOD CONSTRUCTION, 2012 EDITION; ACI BUILDING CODE REQUIREMENTS FOR STRUCTURAL CONCRETE 318-08.
- 2. DECK FRAMING HAS BEEN DESIGNED FOR THE FOLLOWING LOADS:

DEAD LOAD 10 PSF 40 PSF LIVE LOAD

- FOUNDATION DESIGN IS BASED ON A PRESUMPTIVE BEARING PRESSURE OF 1500 PSF (IBC TABLE 1804.2).
- 4. CONCRETE USED SHALL HAVE A MINIMUM COMPRESSIVE STRENGTH OF 3,000 PSI AT 28 DAYS. REINFORCING STEEL BARS SHALL CONFORM TO ASTM A615, GRADE 60.
- 5. WOOD FRAMING INDICATED IN THE DRAWING BY NOMINAL SIZES (2X4, 2X6, ETC) SHALL BE KILN DRIED SPRUCE-PINE-FIR, #2 OR BETTER.
- 6. CONNECTIONS AND FASTENERS NOTED IN THE DRAWINGS SHALL BE CONSIDERED TYPICAL AT ALL SIMILAR CONNECTIONS UNLESS NOTED OTHERWISE.
- CONNECTORS NOTED BY PART NUMBER ARE BY SIMPSON STRONG-TIE OR APPROVED EQUAL.
- 8. CONTRACTOR IS RESPONSIBLE FOR SHORING, TEMPORARY STABILITY, AND MEANS & METHODS OF CONSTRUCTION. IMMEDATELY NOTIFY THE ENGINEER IF THE WORK RESULTS IN EXCESSIVE DEFLECTION OR CRACKING.
- 9. JOIST SPACING IS EQUAL WITHIN BAYS UNLESS OTHERWISE NOTED. JOISTS MAY BE MOVED +/-3" RELATIVE TO THE POSITION SHOWN ON THE DRAWINGS TO ENABLE FIELD COORDINATION IF NECESSARY.
- 10. STRUCTURAL DESIGN IS ONLY PROVIDED FOR THOSE ELEMENTS SPECIFICALLY NOTED ON THESE DRAWINGS. ALL OTHER STRUCTURAL DESIGN FOR FOUNDATIONS, WALLS, LATERAL SYSTEMS, ROOFS, ARCHITECTURAL OR ORNAMENTAL FEATURES, STAIRS, MECHANICAL, PLUMBING AND ELECTRICAL SYSTEMS AND ATTACHMENTS IS BY OTHERS. DO NOT SCALE FROM THESE DRAWINGS.

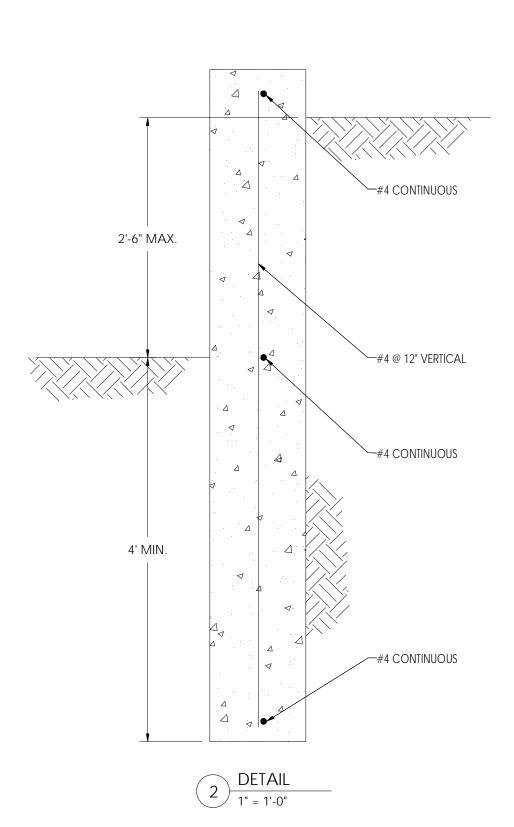

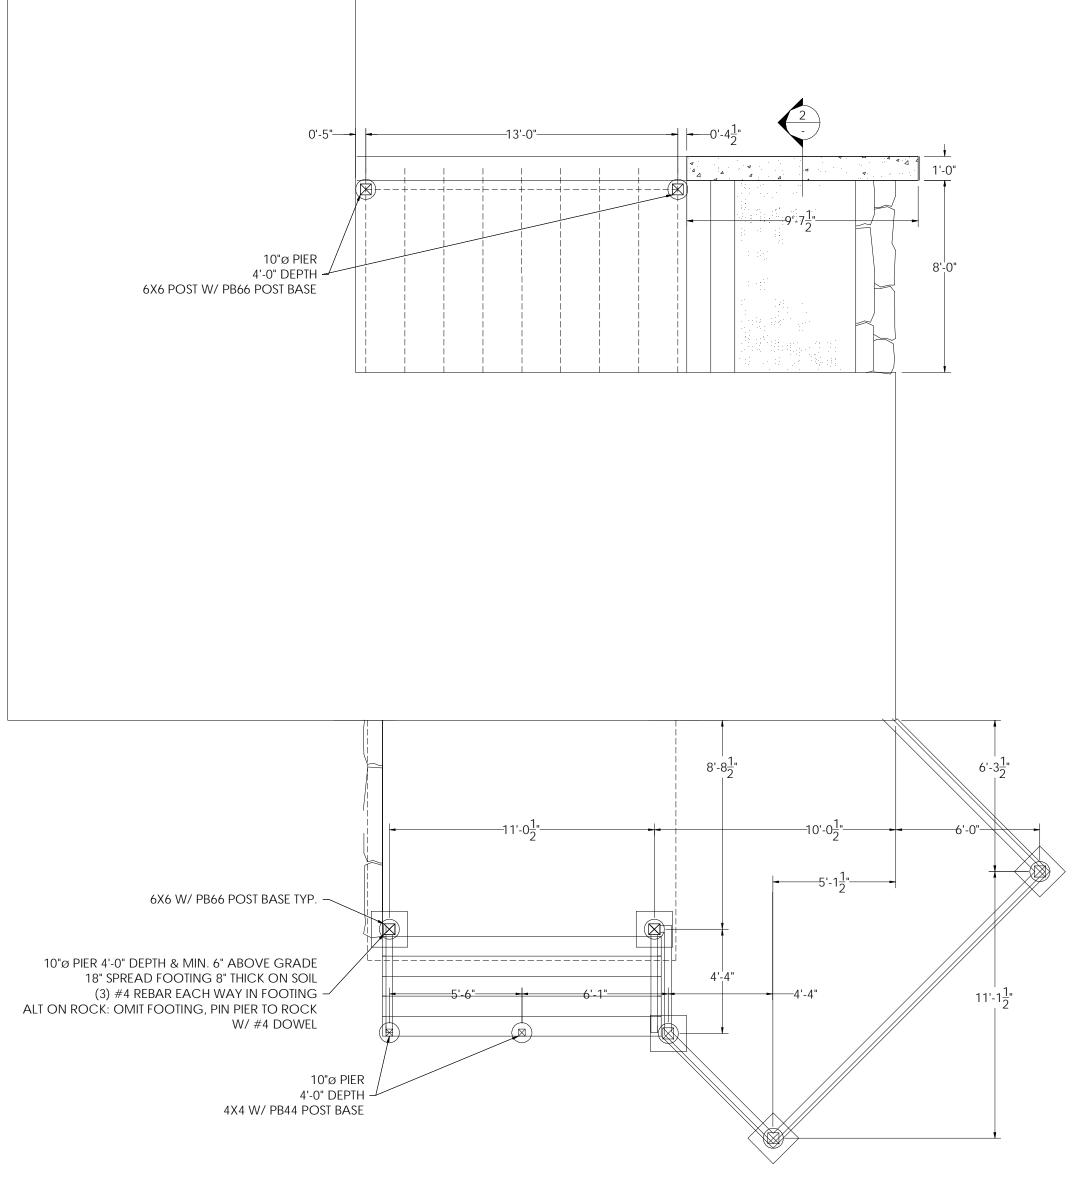

**Rachel Conly** 

Architectural Design

Peaks Island, Maine 04108 207.766.5625

STRUCTURAL

**NOTES** 

DECK **FOUNDATION PLAN** 

PROJECT

Gulliver Family Residence


Island Avenue Peaks Island, Me. 04108

DATE	REVISED
4.5.13	
SCALE	DRAWN BY
1/4"=1'-0"	AJ
NOTES	

1. SEE ARCHITECTURAL DRAWINGS FOR INFO NOT SHOWN. 2. DESIGN IS FOR DECK & PORCH STRUCTURES ONLY.

PORCH & DECK FOUNDATION PLAN

1/4" = 1'-0"

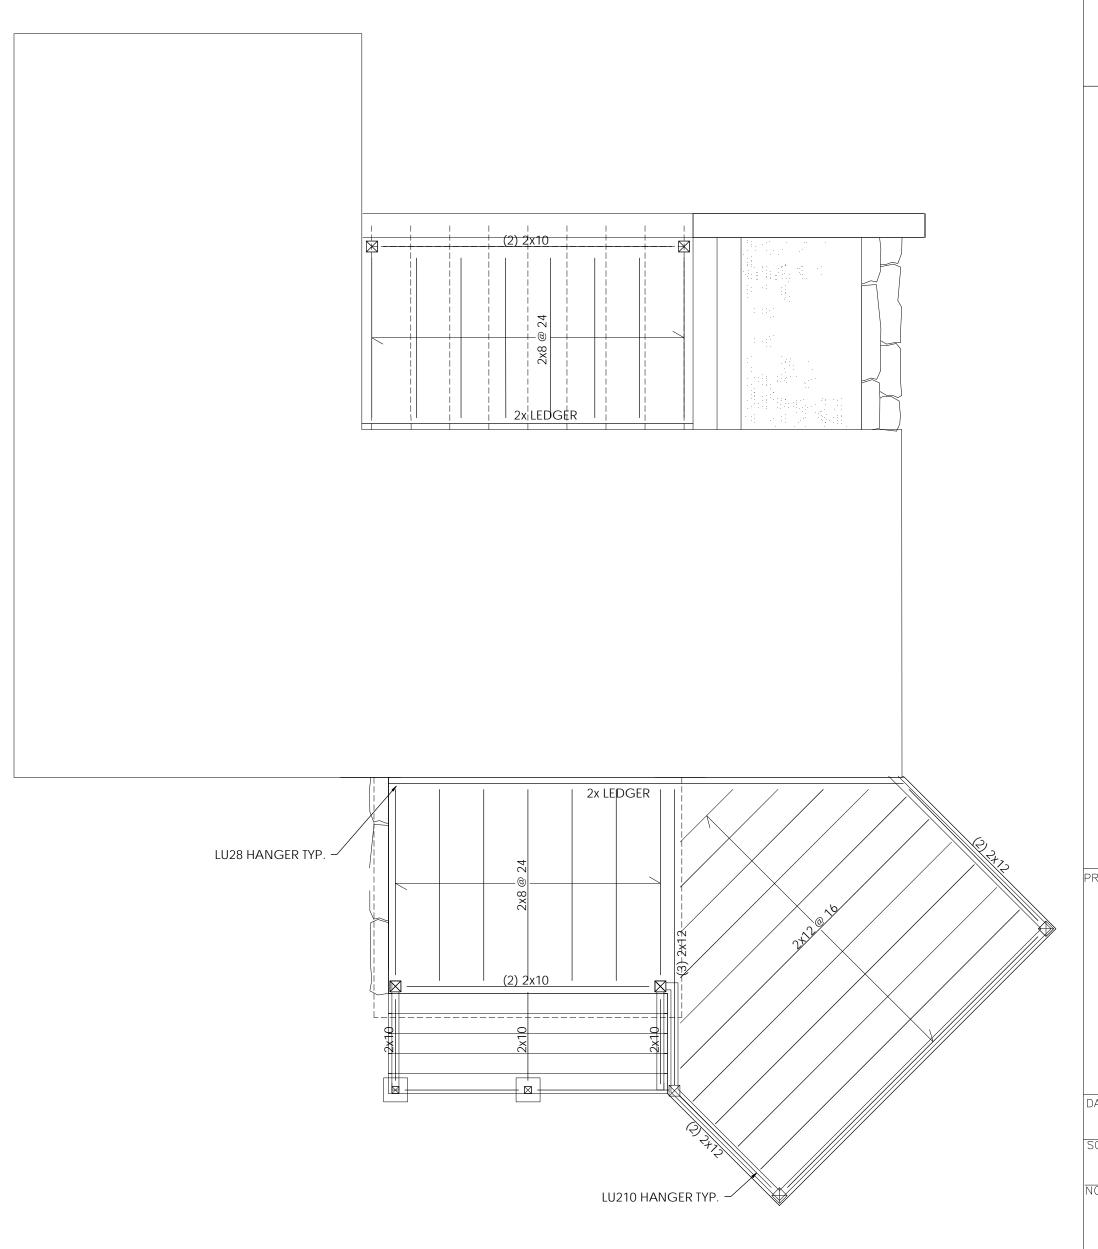

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STRUCTURAL

DECK FRAMING

PROJECT

Gulliver Family Residence

Island Avenue Peaks Island, Me. 04108

DATE
4.5.13

SCALE
1/4"=1'-0"

REVISED


AJ

NOTES

PORCH & DECK FRAMING PLAN

1/4" = 1'-0"

<u>S2</u>

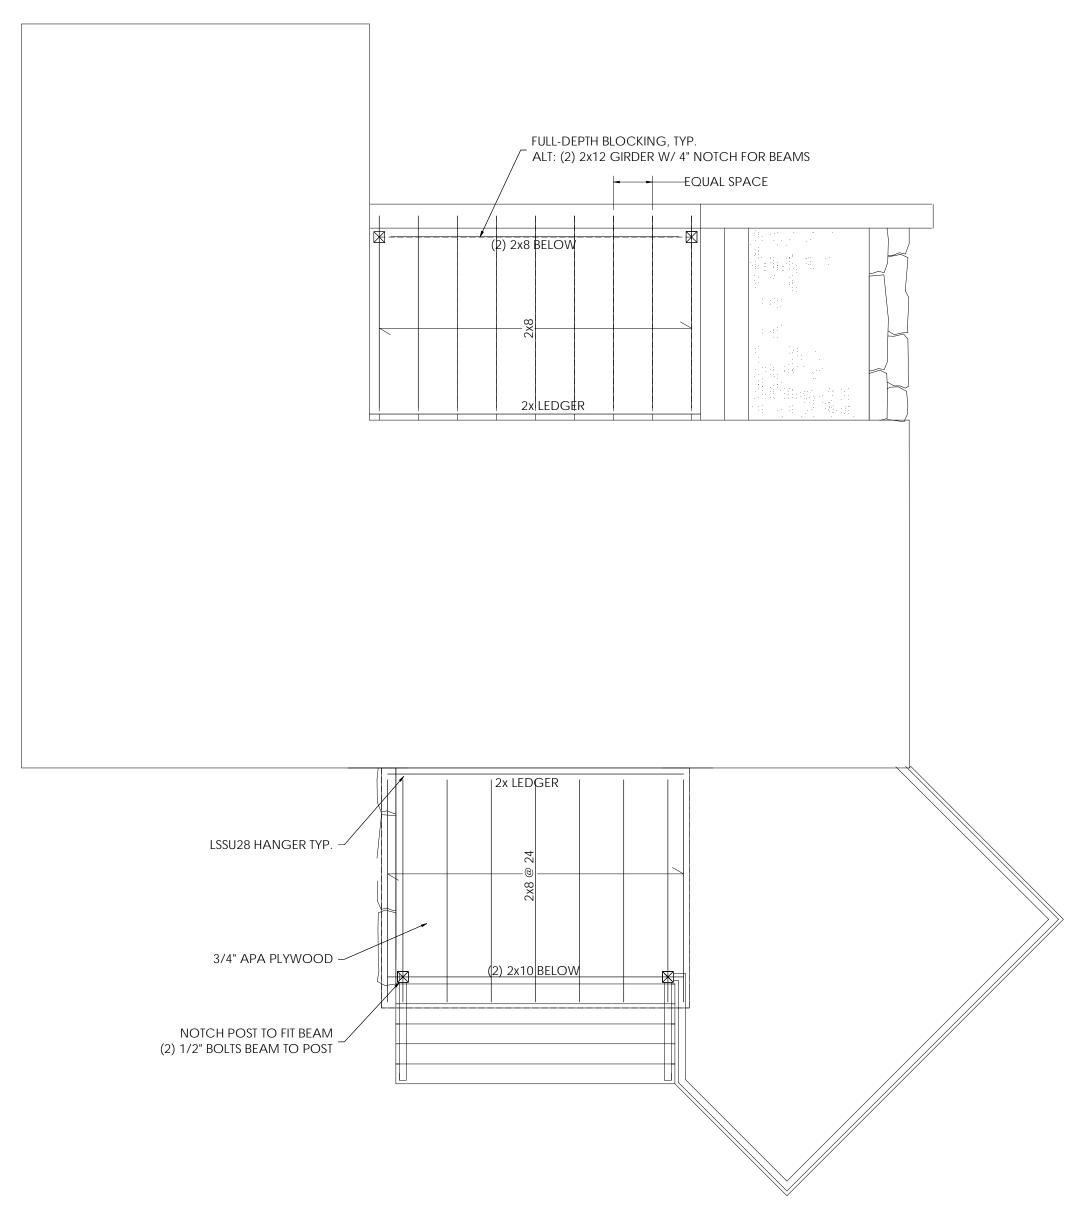

## **Rachel Conly**

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STRUCTURAL

DECK ROOF

PROJECT

Gulliver Family Residence

Island Avenue Peaks Island, Me. 04108

DATE 4.5.13 REVISED 4.5.13 SCALE 1/4"=1'-0" AJ

NOTES

PORCH & DECK ROOF PLAN

1/4" = 1'-0"

53