City of Portland, N	/Iaine - Bui	lding or Use	Permi	t Application	1 ``		Issue Date	:	CBL:	
389 Congress Street,	04101 Tel: ((207) 874-8703	3, Fax: ((207) 874-871	6	04-1120			085 G(006001
Location of Construction:		Owner Name:			Own	er Address:			Phone:	
20 Spruce Ave			20 3	Spruce Ave						
		Contractor Name			l .	ractor Address:			Phone	
		Thompson & .	Johnson	Woodworkers		Island Ave Po	eaks Island		2077665	219
Lessee/Buyer's Name Phone:				l	nit Type:				Zone:	
				ļ	Ad	lditions - Dwe	llings			IR-2
Past Use:		Proposed Use:			Pern	nit Fee:	Cost of Wor		CEO District:	
single family		single family -		' x 16'		\$201.00	\$20,00		2	
		addition w/8' p	orch		FIR	E DEPT:	Approved	INSPEC	TION: 2	1
) /=	Denied	Use Gro	TION: up: R-3 BOCA	Type: 7
									2011	1999
D						$\lambda I I$			1000	T'
Proposed Project Description - build 8' x 16' addition					n:	$\int \bigcup \int \int $		a:		
- build 8 x 10 addition	w/o poich					ayure: / ESTRIAN ACTI	VITIES DIST	Signatur		
					Actio	on: Approv	ed App	proved w/C	Conditions 📄	Denied
					Sign	ature:			Date:	\sim
Permit Taken By:	Date A	pplied For:			Zoning Approval					
tmm	08/0	5/2004					rr			
1.	-		Spe	cial Zone or Revie	ws	Zonii	ng Appeal		Historic Fre	servation
			Sh	oreland		☐ Variance	:		Not in Distri	ct or Landma
									-	
2.			□ W	etland j		☐ Miscella	neous		Does Not Re	equire Review
				a 1/		1 _				
3.				ood Zone		Condition	onal Use	[Requires Re	view
			l	(.)/					٦	
				bdiv i sio∕n		Interpret	ation		Approved	
			Sit	to Dian		Approve	a		Approved w	(Conditions
				le Fian		Approve	u	'	Approved w	Conditions
			 Maj	Minor MM		Denied		1 -	Denied	,
								'		
			late:	8/5/04		late:		Dat	te: 8/5/6	64
			1	7 / -					-//-	<u>, </u>
				•						
			C	CERTIFICATION	ON					
I hereby certify that I an	n the owner of	record of the na	med pro	operty, or that th	e pro	posed work is	authorized	by the o	wner of reco	rd and that
I have been authorized b										
jurisdiction. In addition										
shall have the authority such permit.	io enter all are	eas covered by su	ucn pern	int at any reason	aoie	nour to enforc	e the provi	sion of t	ne code(s) ap	opiicable to
oach permit.										
SIGNATURE OF APPLICAL	NT			ADDRESS			DATE		PHO	ONE

BUILDING PERMIT INSPECTION PROCEDURES Please call 874-8703 or 874-8693 to schedule your inspections as agreed upon

Permits expire in 6 months, if the project is not started or ceases for 6 months.

The Owner or their designee is required to notify the inspections office for the following inspections and provide adequate notice. Notice must be called in 48-72 hours in advance in order to schedule an inspection:

By initializing at each inspection time, you are agreeing that you understand the inspection procedure and additional fees from a "Stop Work Order" and "Stop Work Order Release" will be incurred if the procedure is not followed as stated below.

A Pre-construction Meeting will take place upor	receipt of your building permit.
Footing/Building Location Inspection:	Prior to pouring concrete Sefbacks Toka Dyft
Re-Bar Schedule Inspection:	Prior to pouring concrete
Foundation Inspection:	Prior to placing ANY backfill
Framing/Rough Plumbing/Electrical:	Prior to any insulating or drywalling Close /
use. N	o any occupancy of the structure or IOTE: There is a \$75.00 fee per tion at this point.
Certificate of Occupancy is not required for certain you if your project requires a Certificate of Occupa inspection If any of the inspections do not occur, the phase, REGARDLESS OF THE NOTICE OR C	e project cannot go on to the next
CERIFICATE OF OCCUPANICES MU BEFORE THE SPACE MAY BE OCCUPIED	ST BE ISSUED AND PAID FOR,
× Paul Is dell	8.5.04
Signature of Applicant/Designee	Date 5 04
Signature of Inspections Official	Date
CBL: Building Permit #: a	-1120_

Form # P 04

DISPLAY THIS CARD ON PRINCIPAL FRONTAGE OF WORK

CITY OF PORTLAND

Please Read Application And

CTION

Notes, If Any, Attached		PERMIT	Permit Number: 041 120
This is to certify the	at Bramn Scott M & /Thomp	Johnso Jorkers	
has permission to	- build 8' x 16' addition w/	/8' p	
AT 20 Spruce Ave	}		, 085 G006001
of the provis	It the person or person sions of the Statutes o stion, maintenance and nent.	f it ine and of the	epting this permit shall comply with all nees of the City of Portland regulating stures, and of the application on file in
	c Works for street line ature of work requires on.	N fication inspect in must go and with a permission procubing the this body of the ding or the thereof lands or the permission of the perm	A certificate of occupancy must be
_	EQUIRED APPROVALS		
Fire Dept			3/5/01
Appeal Board		<u></u>	(A
Other	Department Name		Director Building & Inspection Services
	To the second se	IALTY FOR REMOVING THIS	/\

All Purpose Building Permit Application

If you or the property owner owes real estate or personal property taxes or user charges on any property within

y cantify that I am the Owner of record of the named property, or that the owner of record authorizes the proposed work and the outhorized by the Owner to make this application as his/her authorized agent. I agree to conform to all applicable laws of ion authorized by the Code Official's authorized representation. In addition, if a permet for work described in this application is issued. I certify that the Code Official's authorized representative the authority to enter all areas the provisions of the codes applicated.	hereby nave be halich
REQUIRED INFORMATION IS NOT INCLUDED IN THE SUBMISSIONS THE PERMIT WILL BE AUTOMATICALLY DAT THE DISCRETION OF THE BUILDING/PLAUNING DEPARTMENT, WE MAY REQUIRE ADDITIONAL MATION IN ORDER TO APROVE THIS PERMIT.	DENIE
should we contact when the permit is ready: Moop works order will be issued as \$100.00 fee if any work starts before the permit is picked up. PHONE: a \$100.00 fee if any work starts before the permit is picked up. PHONE:	Mail We v
itractor's name, address & telephone:	Con
oced use: KITCHEN MO LORCH ADDITION PATHOON 200 FORCH—ect description: Renovation: Renovation.	Prop
e location is currently vacant, what was prior use:	
Tent use: St PESIDENCE TENDS CONTROLLED TO THE STATE OF T	n)
see/Buyer's Name (If Applicable) Applicant name, address & Cost Of Work: \$ 20,0000 See:	sөŋ
CASSESSON'S Chart, Block & Lot Sushune Parula Telephone: Sushune Parula Telephone: Sushune Parula Telephone:	(D)
tal Square Footage of Proposed Structure Square Footage of Lot	toT
cation/Address of Construction: 191 MBW 194MD AVE, 20 SPRUCE STRE	ଠା

This is NOT a permit, you may not compence ANY work until the permit is issued. If you are in a Historic District you may be subject to additional permitting and fees with the Planning Department on the 4^{th} floor of City Hall

Date: 8.4.04

Signature of applicant:

5/8DEF.



Triple 13/4" x 16" VERSA-LAM® 3100 SP

PARROTT Job Name:

Address:

City, State, Zip: PEAKS ISLE, ME Customer:

THOMSON & JOHNSON Code reports: ICBO 5512, NER 629


File Name: BC CALC Project: FB01

Description:

Specifier. RACHEL

Designer: **BRIAN BIRKINBINE**

Company: WOOD STRUCTURES INC Misc.

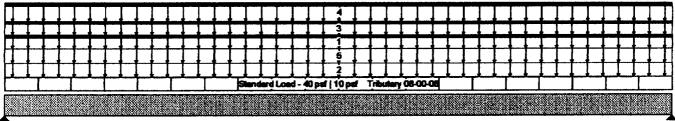

80 9889 lbs LL 5012 lbs DL

Duration:

Disclosure

100

The completeness and accuracy of the input must be verified by anyone who would rely on the output as evidence of suitability for a particular application. The output above is based upon building

code-accepted design properties

products must be in accordance

with the current installation Guide

and the applicable building codes.

To obtain an Installation Guide or if you have any questions, please call (800)232-0788 before beginning

BC CALCO, BC FRAMERO, BCIO,

BC RIM BOARD™, BC OSB RIM

of BOISE engineered wood

product installation.

and analysis methods. Installation

Bí 9889 lbs LL 5012 lbs DL

	Total Horizontal Length - 14-03-00										
General Data		TLO	ad Summary								
Version:	US Imperial	D	Description	Load Type	Ref.	Start	End	Type	Value	Trib.	Dur.
		s	Standard Load	Unf. Area	Len	00-00-00	14-03-00	Live	40 psf	06-00-06	100%
Member Type:	Floor Beam							Dead	10 paf	08-00-08	90%
Number of Spans:	1	1	1ST WALL	Unf. Lin.	Len	00-00-00	14-03-00	Live	0 pW	n/a	90%
Left Cantilever:	No							Dead	80 p lf	n/a	90%
Right Cantilever:	No	2	2ND FLOOR	Unf. Area	Lea	00-00-00	14-03-00	Live	30 psf	08-00-08	
_								Dead	10 psf	08-00-08	
Stope:	0/12	3	2ND WALL	Unf. Lin.	Leu	00-00-00	14-03-00	Live	0 plf	n/a	115%
Tributary:	08-00-08							Dead	80 plf	n/a	90%
		4	KNEE WIFLOO	OlUnf. Lin.	Left	00-00-00	14-03-00	Live	745 plf	n/a	100%
								Dead	319 plf	n /a	90%
		5	ROOF	Unf. Area	Len	00-00-00	14-03-00	Live	40 psf	02-00-00	
Live Load:	40 psf							Dead	20 psf	02-00-00	90%
Dead Load:	10 psf										
Partition Load:	C pef	Co	ntrois Summs	ıry							

Controls Sum	mary				
Control Type	Value	% Allowable	Duration	Load Case	Span Location
Vioment	51054 ft-lbs	91.1%	100%	2	1 - Internal
Veg. Moment	Oft-bs	n/a	100%		
End Shear	11649 lbs	71.7%	100%	2	1 - Left
Total Load Defi.	L/316 (0.541")	76.0%		3	1
.ive Load Defi.	L/476 (0.359°)	75.6%		3	1
Wax Defl.	0.541	54.1%		3	1

Vates

Design meets Code minimum (L/240) Total load deflection criteria. Design meets Code minimum (L/360) Live load deflection criteria.

Design meets arbitrary (1") Maximum load deflection criteria.

Viinimum bearing length for 80 is 3-3/8". Viinimum bearing length for B1 is 3-3/8".

Entered/Displayed Horizontal Span Length(s) = Clear Span + 1/2 min. end bearing + 1/2 intermediate bearing

Connection Diagram

valling schedule applies to both sides of the member. Member has no side loads.

Connectors are: 16d Sinker Nails

1= 2" 1= 3"				+	— d —	_
;= 6" != 12"	•	-	ه ٦	1	0	Ţ
!= 3"		o		۰ ،	•	o
		1	0	•	•	•
	4,	,				



BOARD™, BOISE GLULAM™, VERSA-LAM®, VERSA-RIM®, VERSA-RIM PLUS®, VERSA-STRAND™ VERSA-STUD®, ALLJOIST® and AJS™ are trademarks of Boise Cascade Corporation.

This page contains a detailed description of the Parcel ID you selected. Press the New Search button at the bottom of the screen to submit a new query.

Current Owner Information

Card Number 1 of 1 085 GDGLGG1 Parcel ID Location 20 SPRUCE AVE Land Use SINGLE FAMILY

Owner Address BRAMN SCOTT M 8 SUZANNE PARROTT JTS

20 SPRUCE AVE PEAKS ISLAND ME 04108

21342/170 Book / Page

85-G-L-7-8-32-33 SPRUCE AVE Legal

ISLAND AVE

PEAKS ISLAND 18629 SF

Valuation Information

Land Building Total **\$46.620** \$55₁020 **\$101**,640

Story Weight

Property Information

1900	Old Style	2	2304	0.428	
Bedrooms 3	Full Baths	Half Baths	Total Rooms L	Attic Full Finsh	Basement Full

Sc. Ft

Total Acres

Outbuildings

Туре	Quantity	Year Built	Size	Grade	Condition
SHED-FRAME	1	1900	7PX50	С	P
SHED-FRAME	1	1900	250	D	P

Sales Information

Price Book/Page Date Type 15244-048 12/23/1999 LAND + BLDING


Picture and Sketch


Sketch <u>Picture</u>


<u>Click here</u> to view Tax Roll Information.


Any information concerning tax payments should be directed to the Treasury office at 874-8490 or emailed.




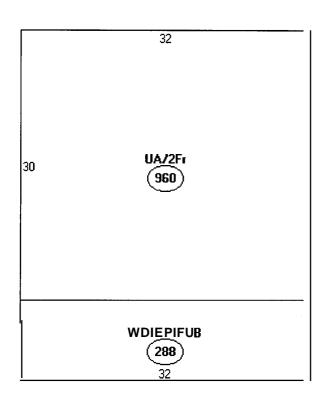

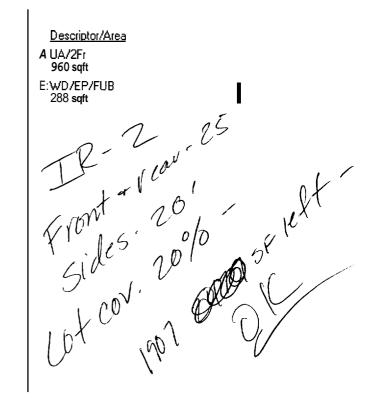

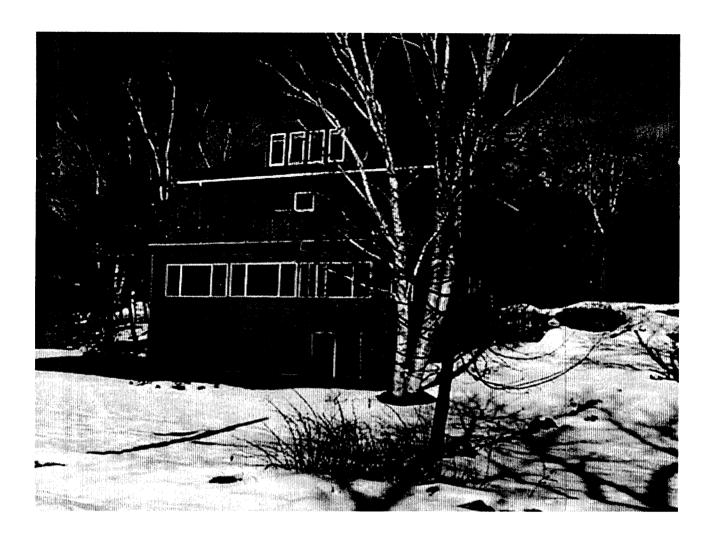

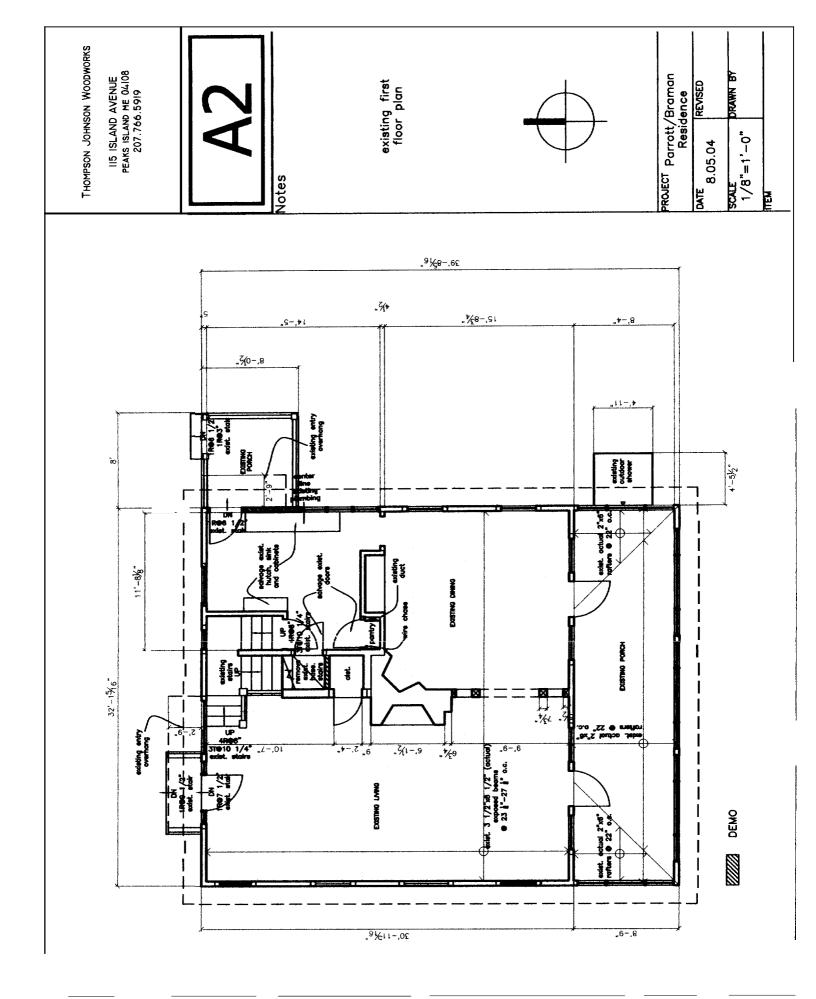

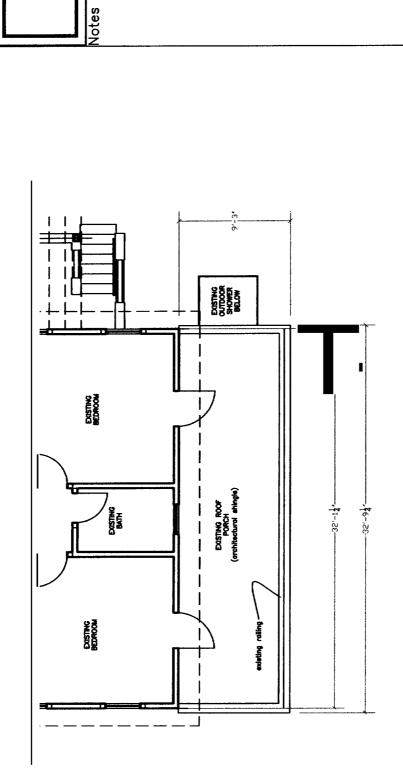

IIS ISLAND AVENUE PEAKS ISLAND ME 04108 207.766.5919



Existing Second Floor Plan





PROJECT Parrott/Braman
Residence
DATE
REVISED

	DRAW	
a.05.04	SCALE 1/8"=1"-0"	

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115 ISLAND AVENUE PEAKS ISLAND ME 04108 207.766.5919

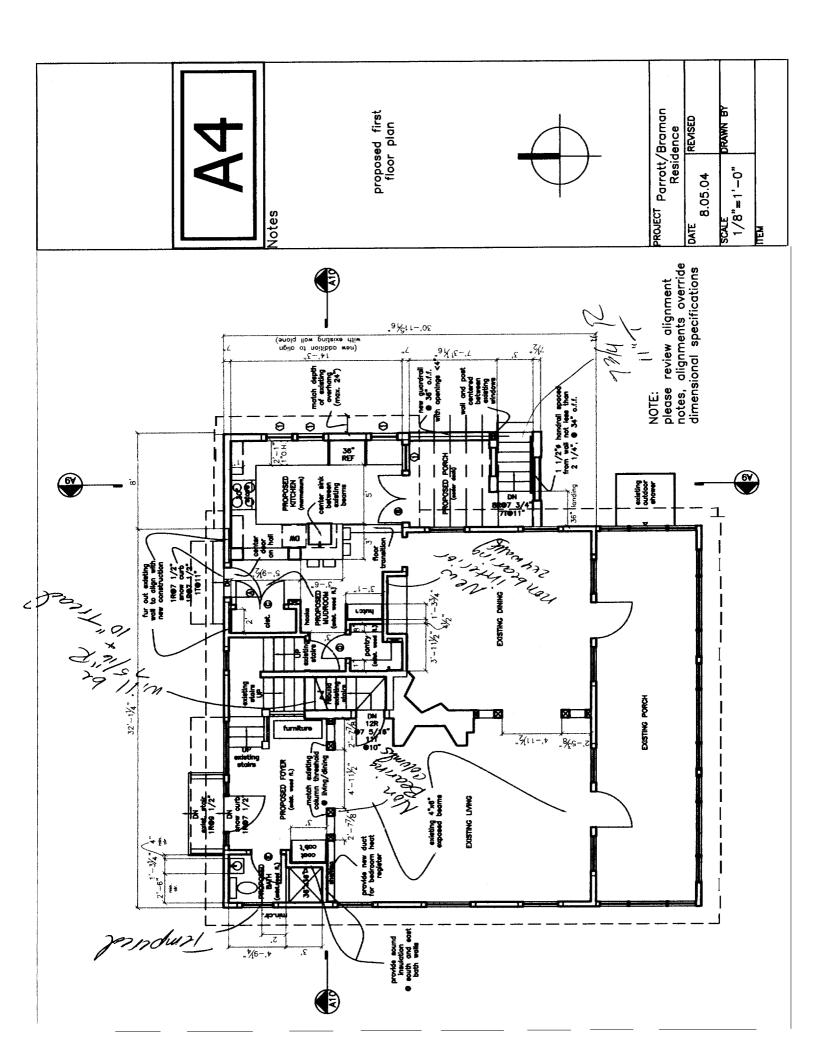



Notes

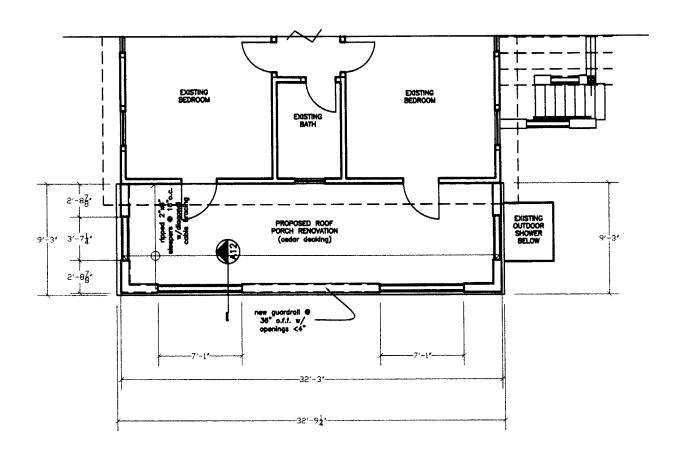
Second Floor Roof Porch **Proposal**




PROJECT Parrott/Braman Residence				
8.05.04	REVISED			
1/8"=1'-0"	DRAWN BY			
ITEM				

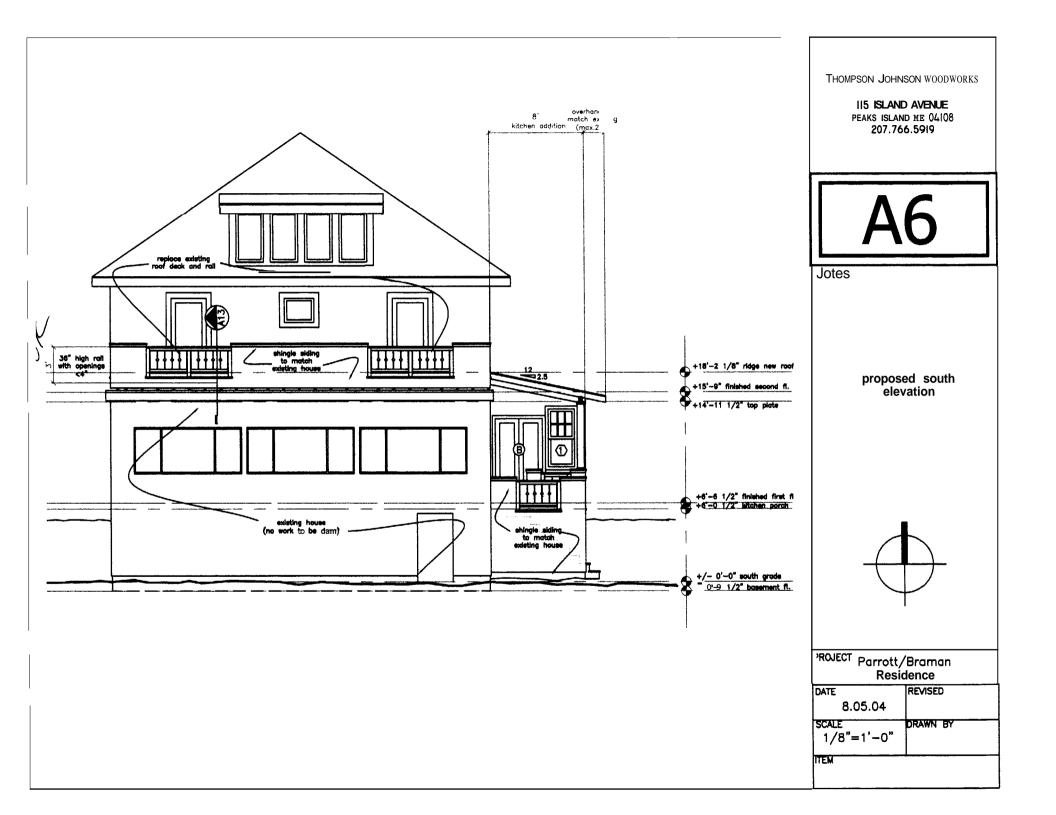

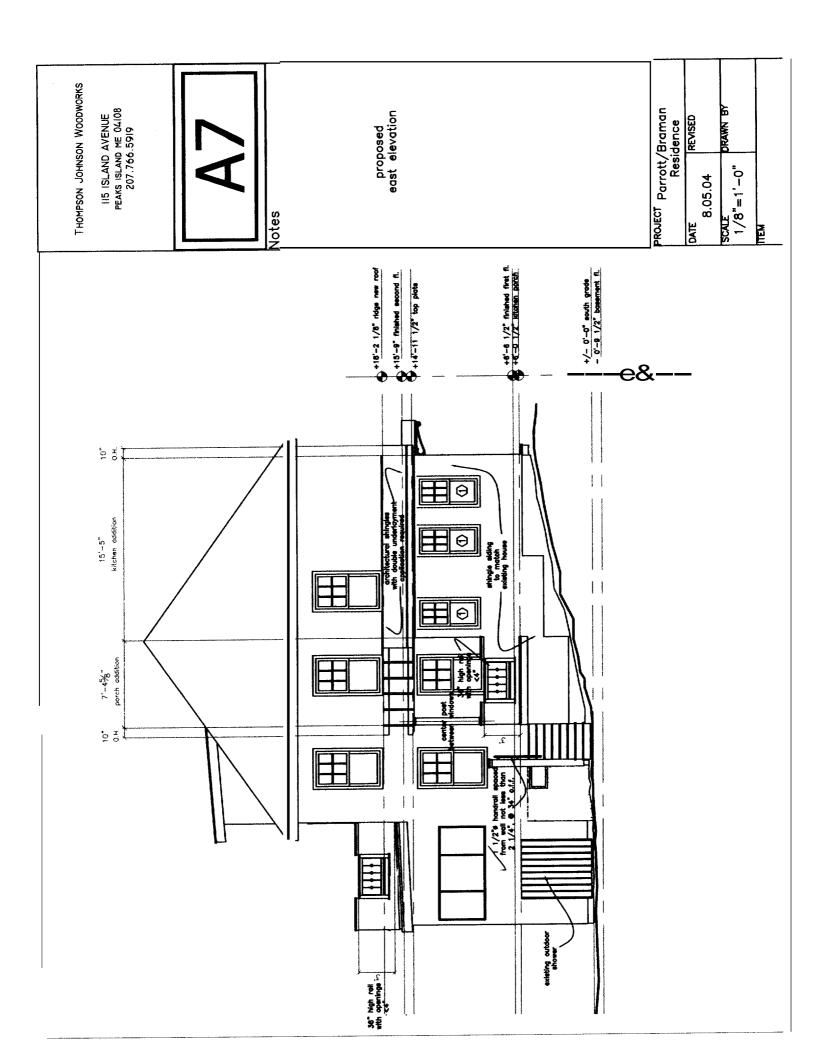

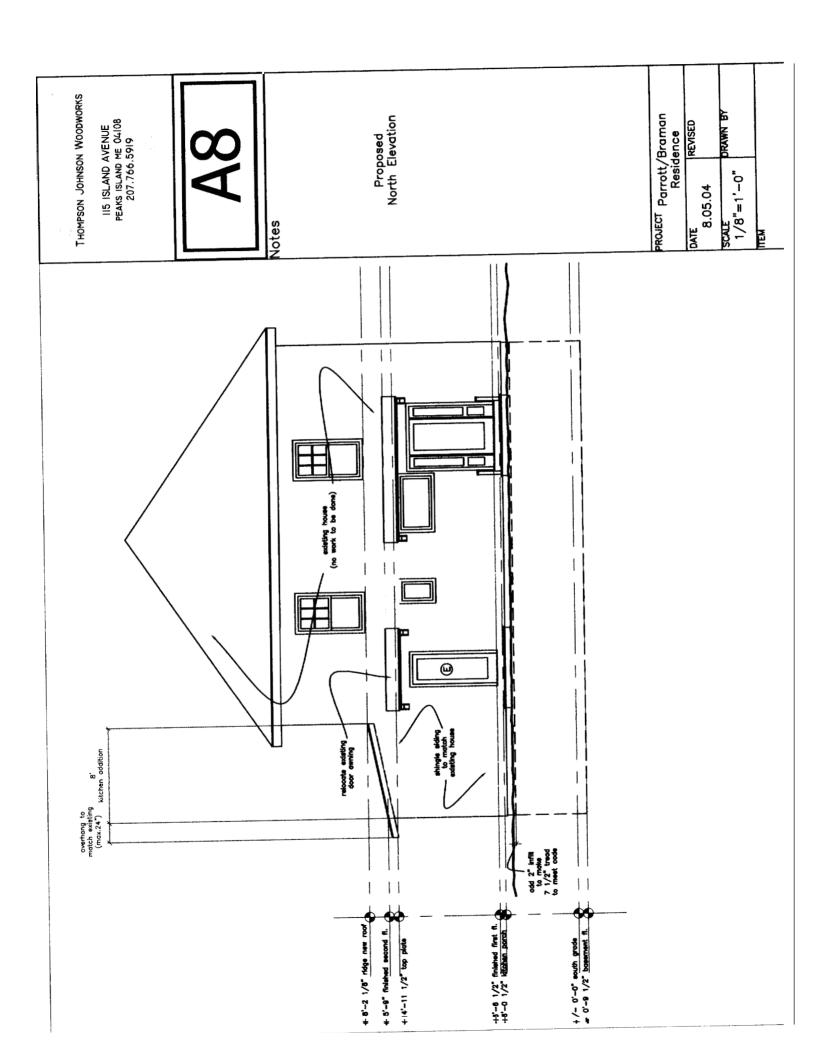


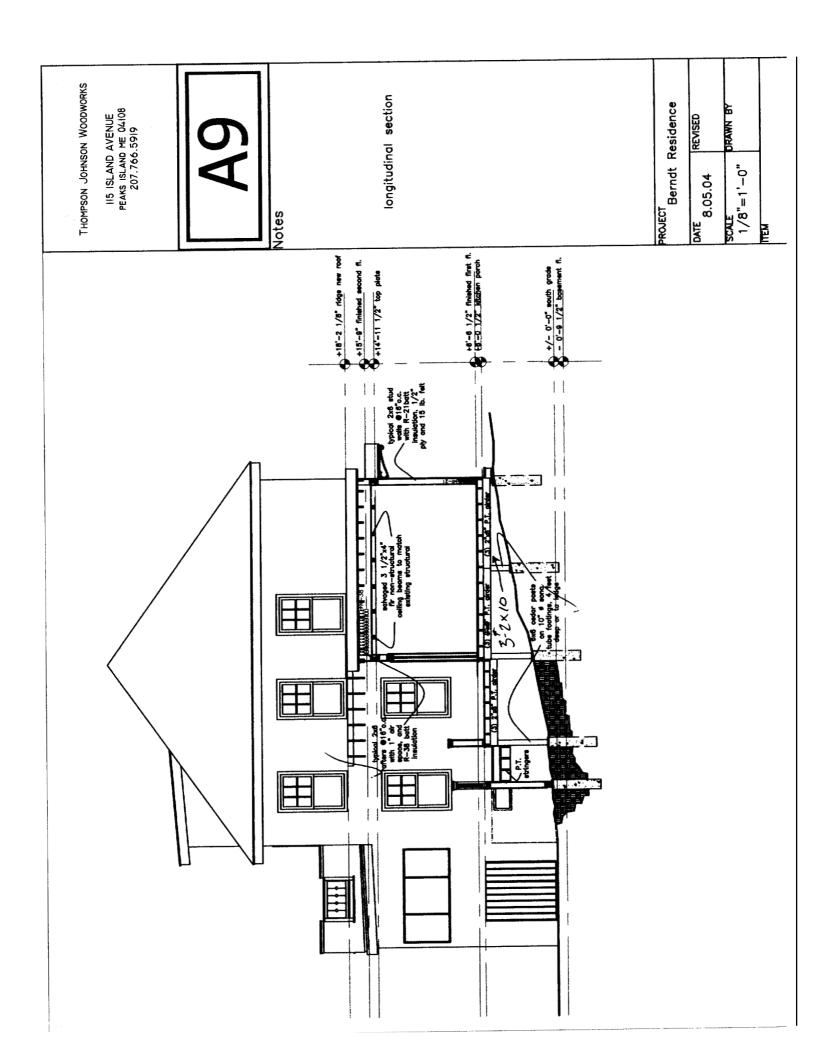


PROJECT Parrott/Braman Residence cross section REVISED 1/8"=1'-0" 8.05.04 Notes 1 +18'-2 1/8" ridge new roof +15'-9" finished second fi. +14'-11 1/2" top picte typical 2nd stud wells @16°o.c. with R-21bott insulation, 1/2° ply and 15 tb. felt A4Z 7'-1115/6" overhang to kitchen addition (max.24") typical 2x6
roffers @16.0.c.
with 1" oir
space, and
R-36 batt
freulation ₹Ø existing 2"x10" joints (octual)— @18 1/2"o.c. existing house (no work to be done)

THOMPSON JOHNSON WOODWORKS

IIS ISLAND AVENUE PEAKS ISLAND ME 04108 207.766.5919

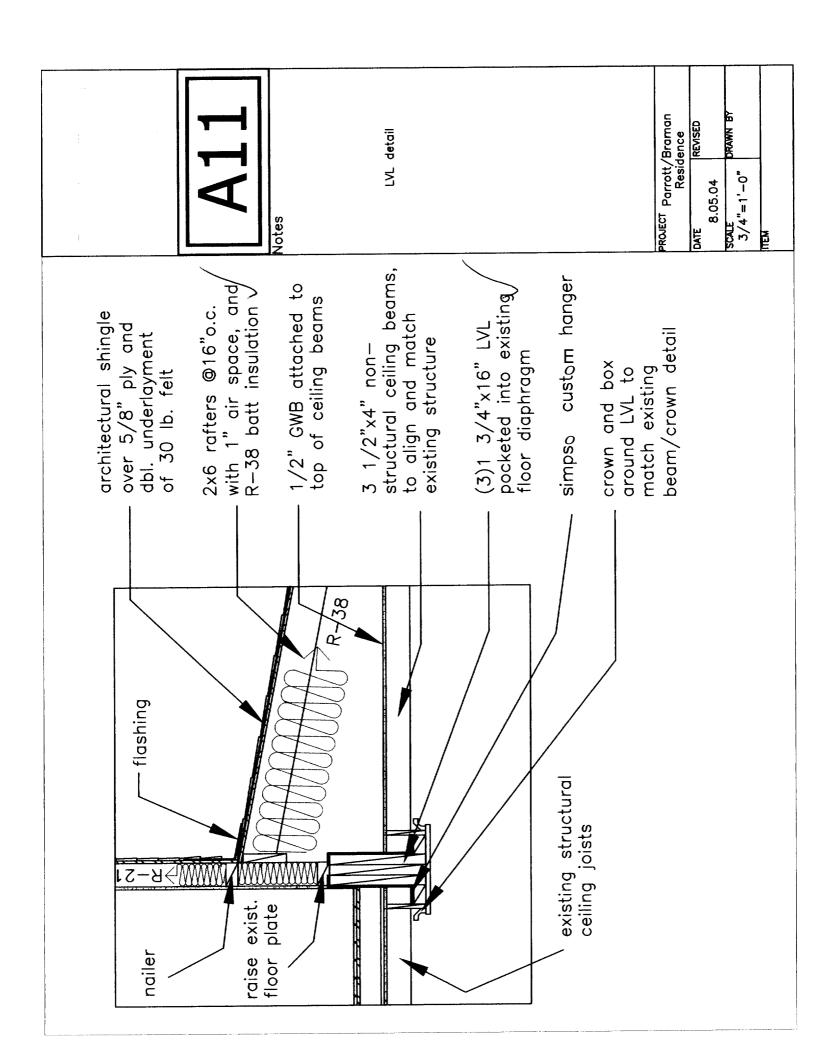

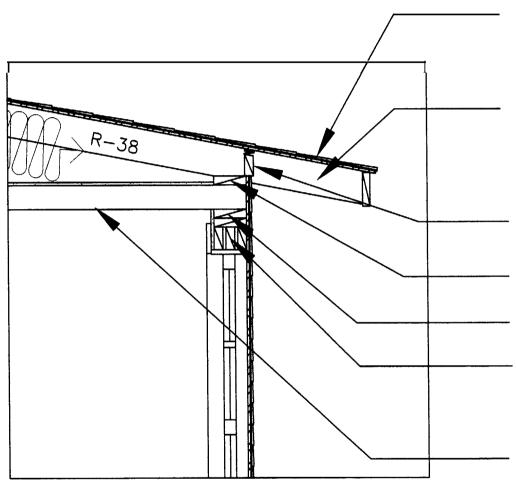

architectural shingle over 5/8" ply and dbl. underlayment of 30 lb. felt

2x6 rafters @16"o.c. with 1" air space, and R-38 batt nsulation

2x bird blocking w/
1" strip of folded cobra vent

2x rafter plate

dbl. top plate

(2)2"x4" header (w/spacers)

3 1/2"x4" nonstructural ceiling beams, to align and match existing structure THOMPSON JOHNSON WOODWORKS

115 ISLAND AVENUE PEAKS ISLAND ME 04108 207.766.5919

A12

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bird blocking and ceiling beams

Parrott/Braman Residence


8.05.04


REVISED

3/4"=1'-0"

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ledger detail

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DATE	REVISED
8.05.04	
SCALE	DRAWN BY
3"=1'-0"	
ITEM	

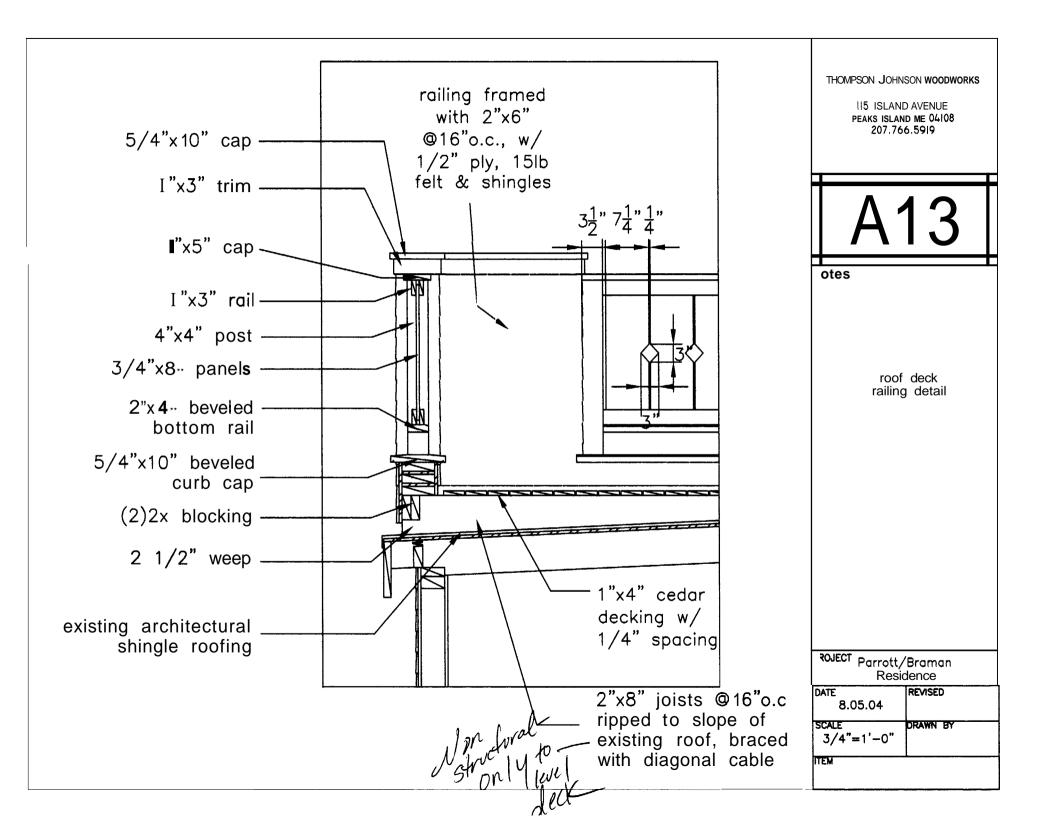H5 ISLAND AVENUE PEAKS ISLAND ME 04:08 207.766.5919

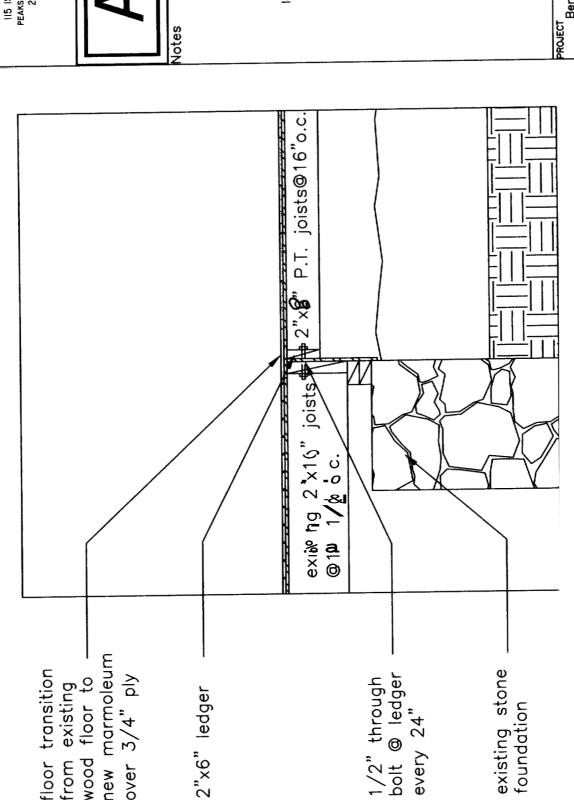A15

Parrott/Braman Residence

Door Schedule

						UNIT	UNIT					
QTY	DOOR	MANUFCT.	MATERIAL	GLASS	OPER	WIDTH	HEIGHT	JAMB	HINGEMORTISE	LOCKSETPREP	NOTES	HARDWARE
1	Α	bonneville	wood w/ single panel, glass	tempered	RH	30"	84"	v.i.f.				
1 PR	В	bonneville	wood w/ single panel. glass	tempered	LH, RH	48"	84"	v.i.f.				
1 PF	C	salvage	5 panel doors	NA	LH, RH	60"	v.i.f.	v.i.f.			reuse existing	
1	D	bonneville	5 panel doors	NA	LH	24"	v.i.f.	v.i.f.				
1	E	salvage	5 panel doors	NA	LH	30"	v.i.f.	v.i.f.			reuse existing	


Window Schedule


						UNIT	UNIT			
QTY	WIN.	MANUFCT.	MATERIAL	GLASS	OPER	WIDTH	HEIGHT	JAMB	NOTES	HARDWARE
1	1	honnoville	wood	NΔ	double hung	25 5/8"	56 7/8"	vif	<u> </u>	

lotes

window/door schedule

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8.05.04	
1/8"=1'-0"	DRAWN BY
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IIS ISLAND AVENUE PEAKS ISLAND ME 04108 207.766.5919

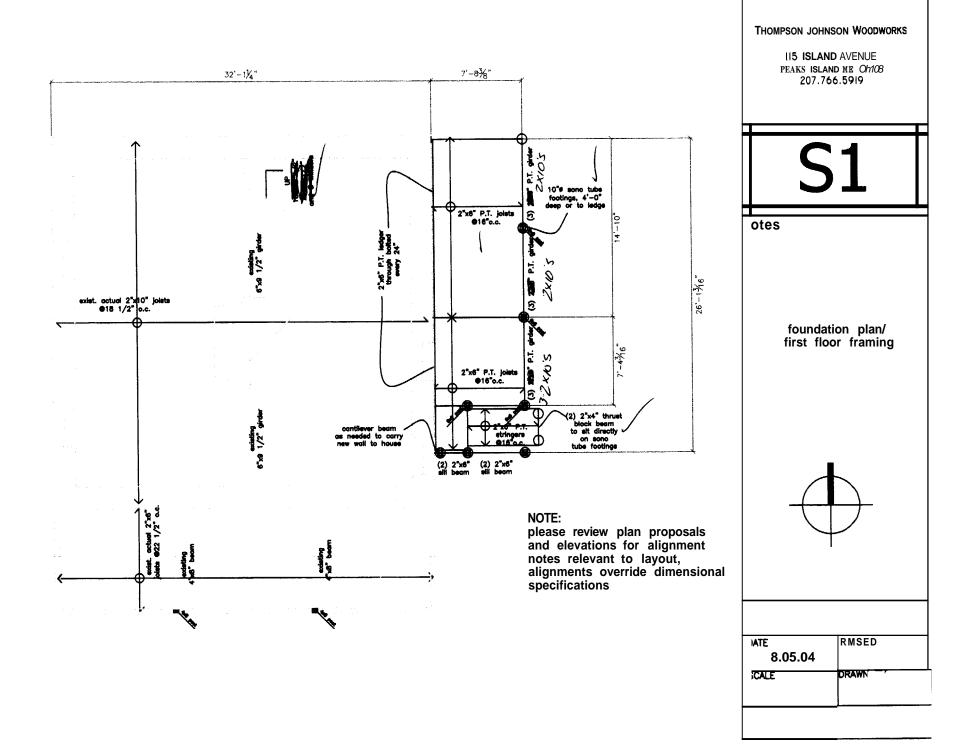second floor framing, exist. porch framing & first floor addition ceiling joists & roof rafters

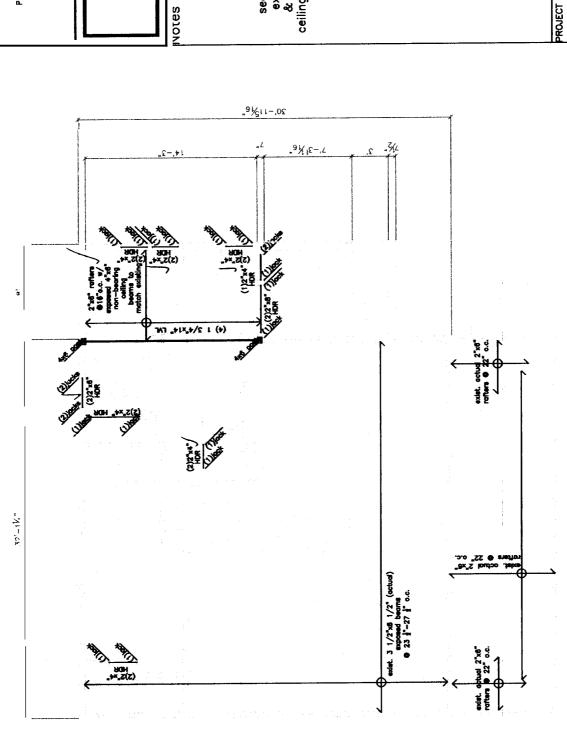
PROJECT Parrott/Braman Residence

REVISED 8.05.04 DATE

SCALE 1/8"=1'-0"

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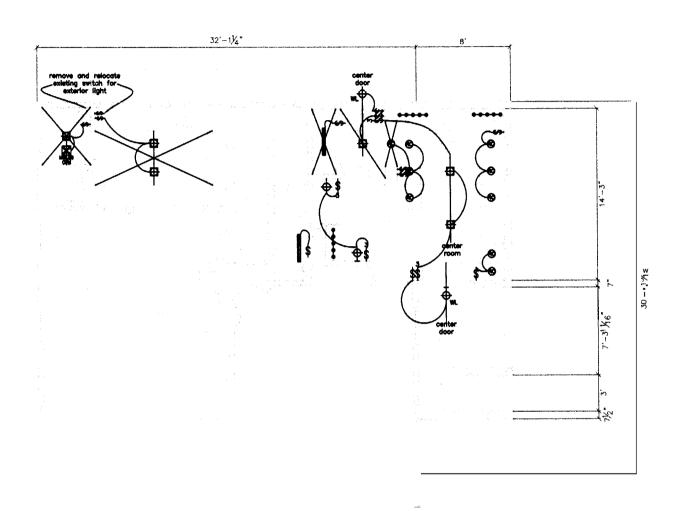
II5 ISLAND AVENUE PEAKS ISLAND ME 04108 207.766.5919

E1

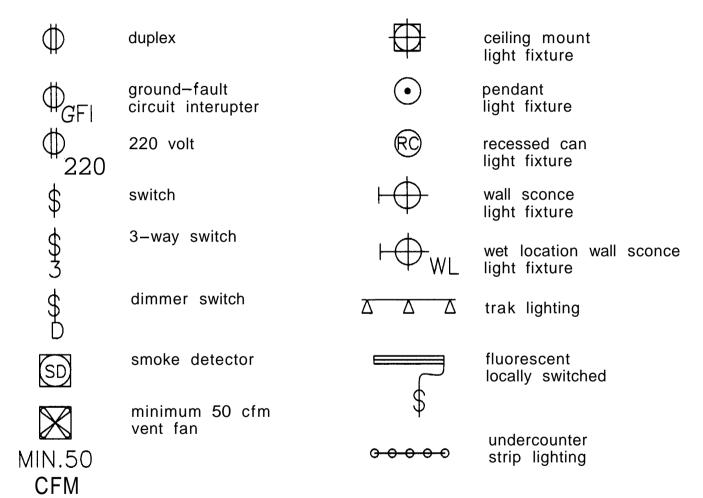lotes

electrical key

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II5 ISLAND AVENUE PEAKS ISLAND ME 0h108 207.766.5919

E2

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first floor lighting plan




ROJECT Parrott/Braman Residence

DATE 8.05.04

SCALE DRAWN BY 1/8"=1'-0"

REVISED

ITEM

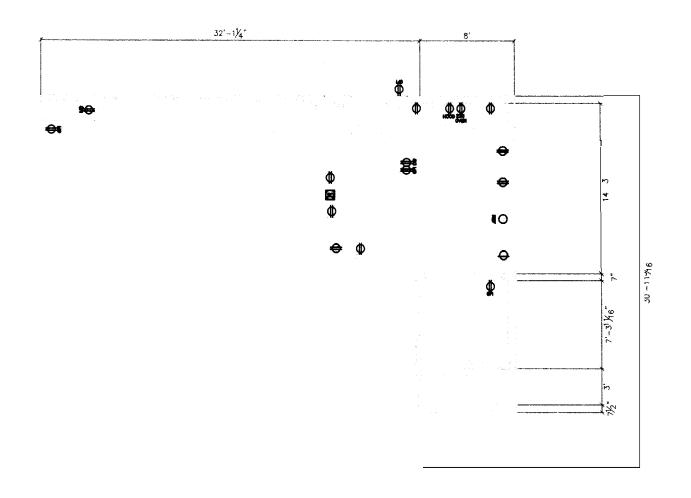

II5 ISLAND AVENUE PEAKS ISLAND ME 04108 207.766.5919

E3

totes

first floor power plan



Parrott/Braman Residence

DATE

REVISED

8.05.04

1/8"=1'-0"

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