


HIGHEST POINT OF STRUCTURE ABOVE ORIGINAL MEAN GRADE: 75'-1.50"

TO PLATE 69'-11"

TO SUB-FLR 59'-2.76"

TO SUB-FLR 49'-6.94"

2 NORTHWEST ELEVATION  
A2.1 1/4" = 1'-0"

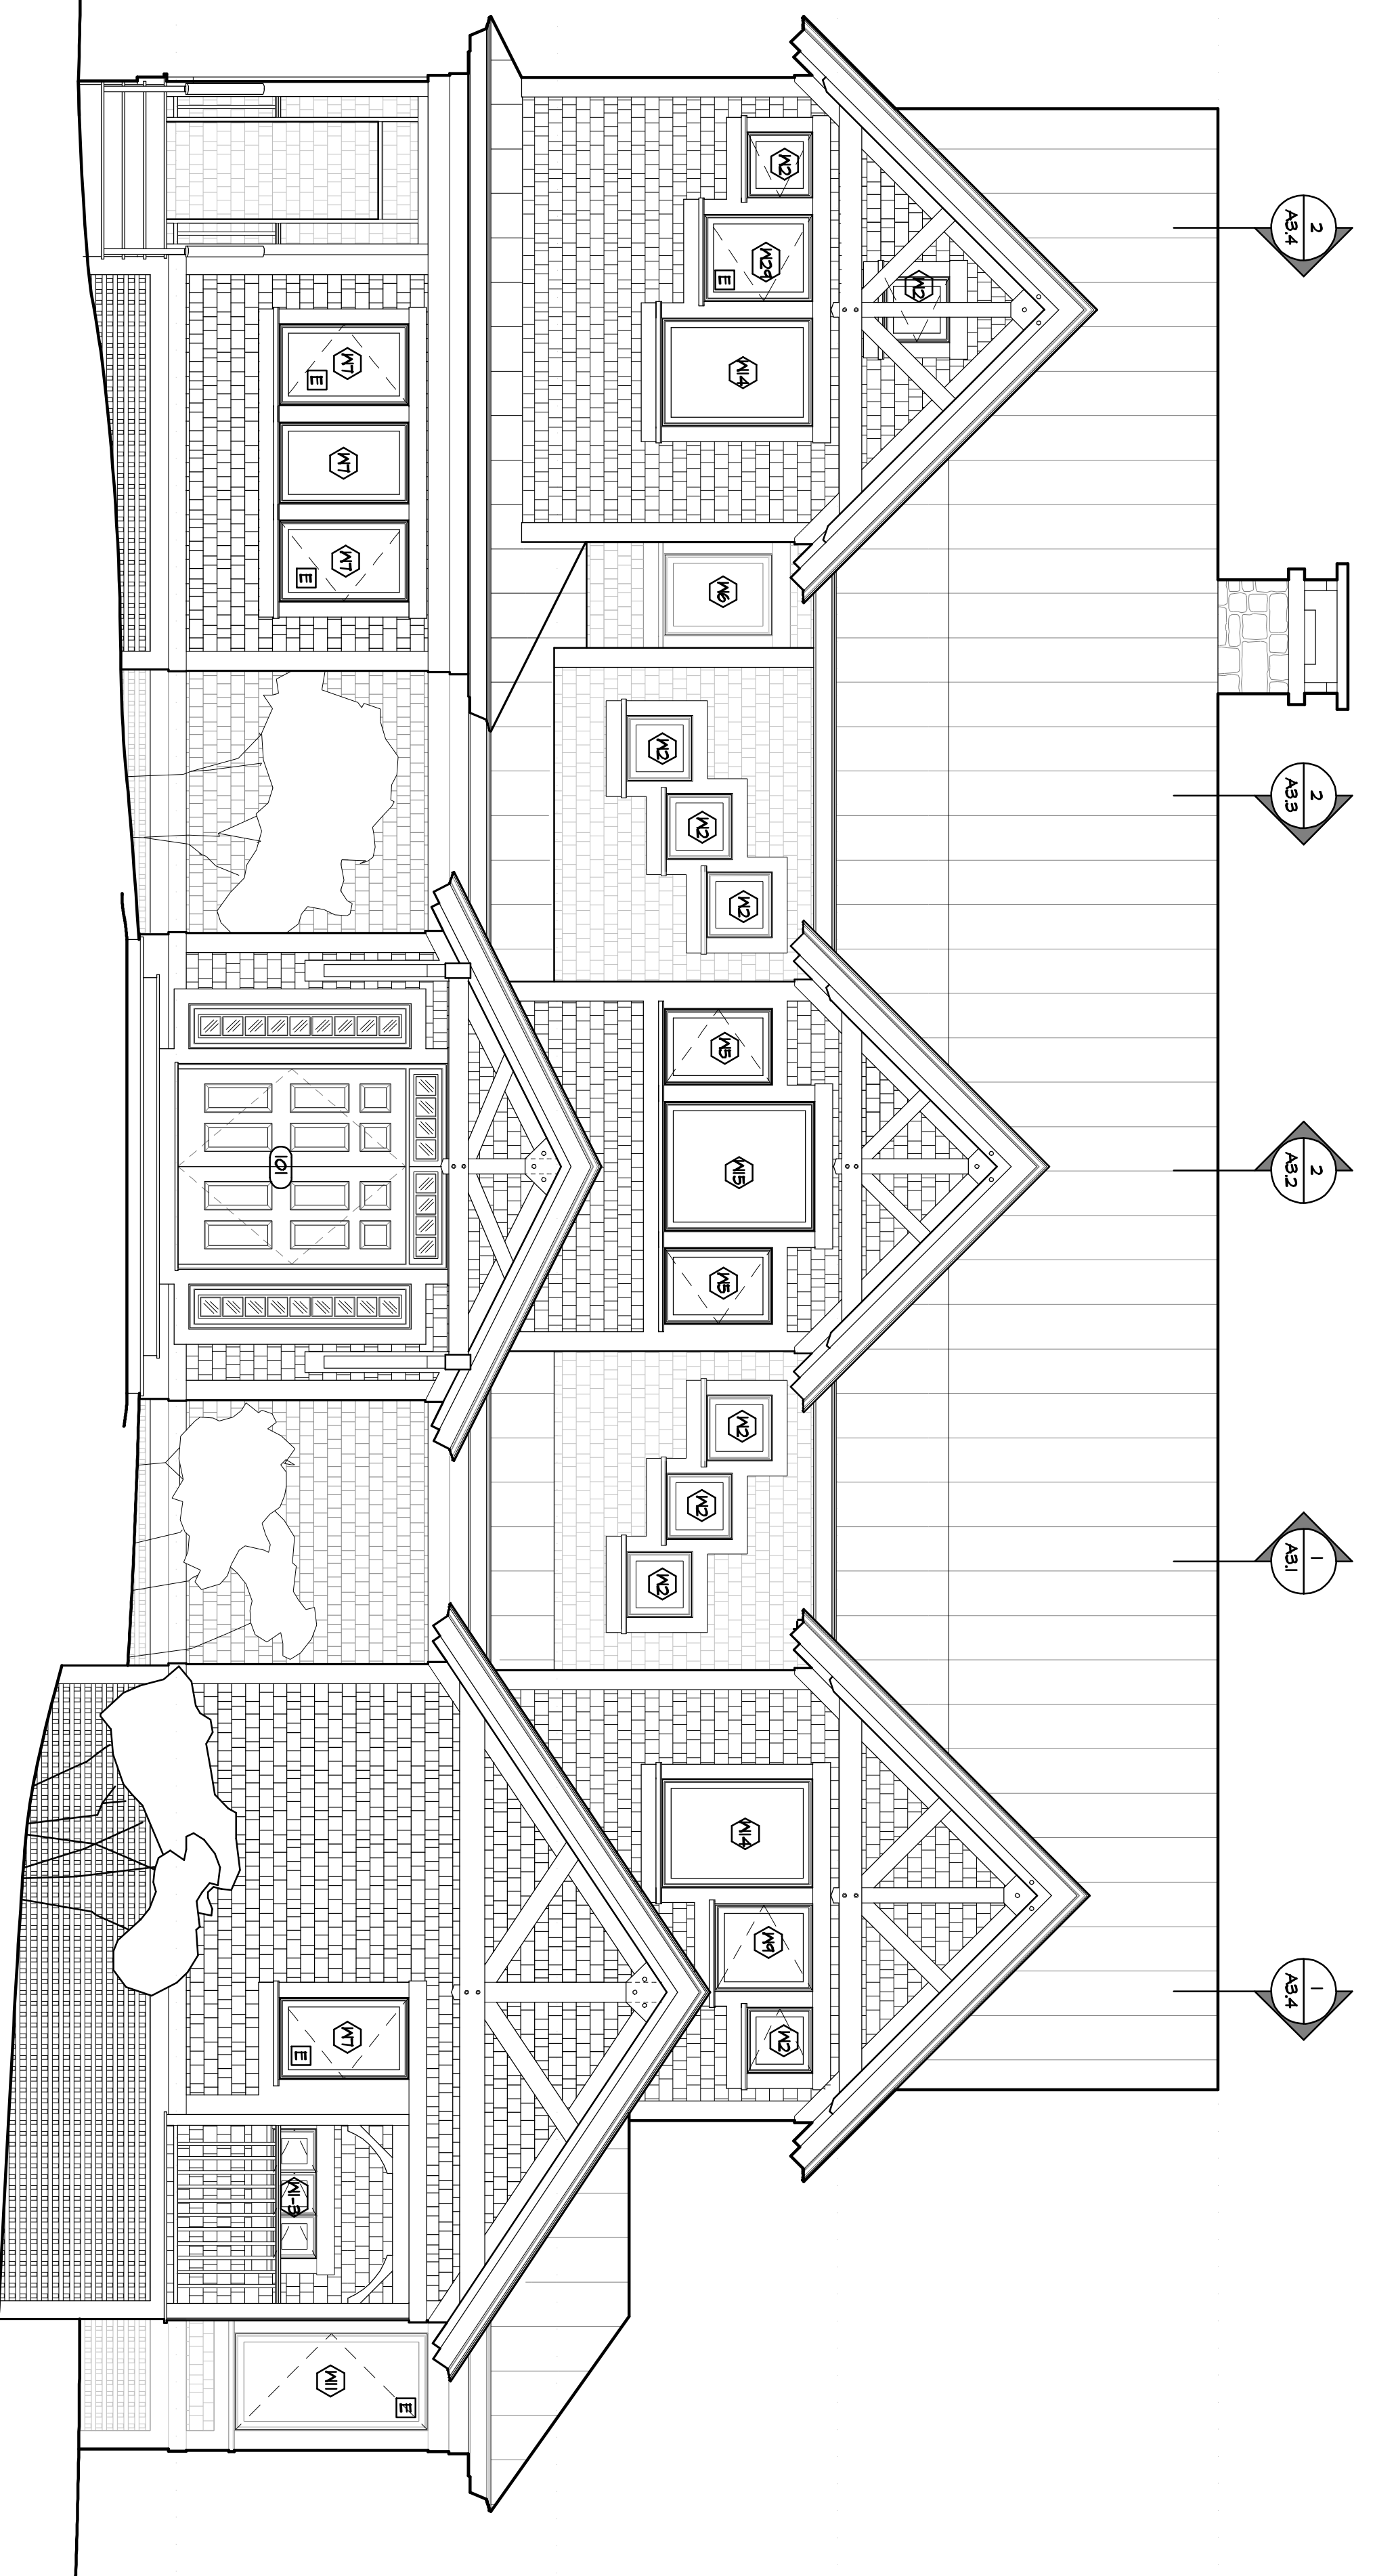


HIGHEST POINT OF STRUCTURE ABOVE ORIGINAL MEAN GRADE: 75'-1.50"

TO PLATE 69'-11"


TO SUB-FLR 59'-2.76"

TO SUB-FLR 49'-6.94"

1 SOUTHEAST ELEVATION  
A2.1 1/4" = 1'-0"

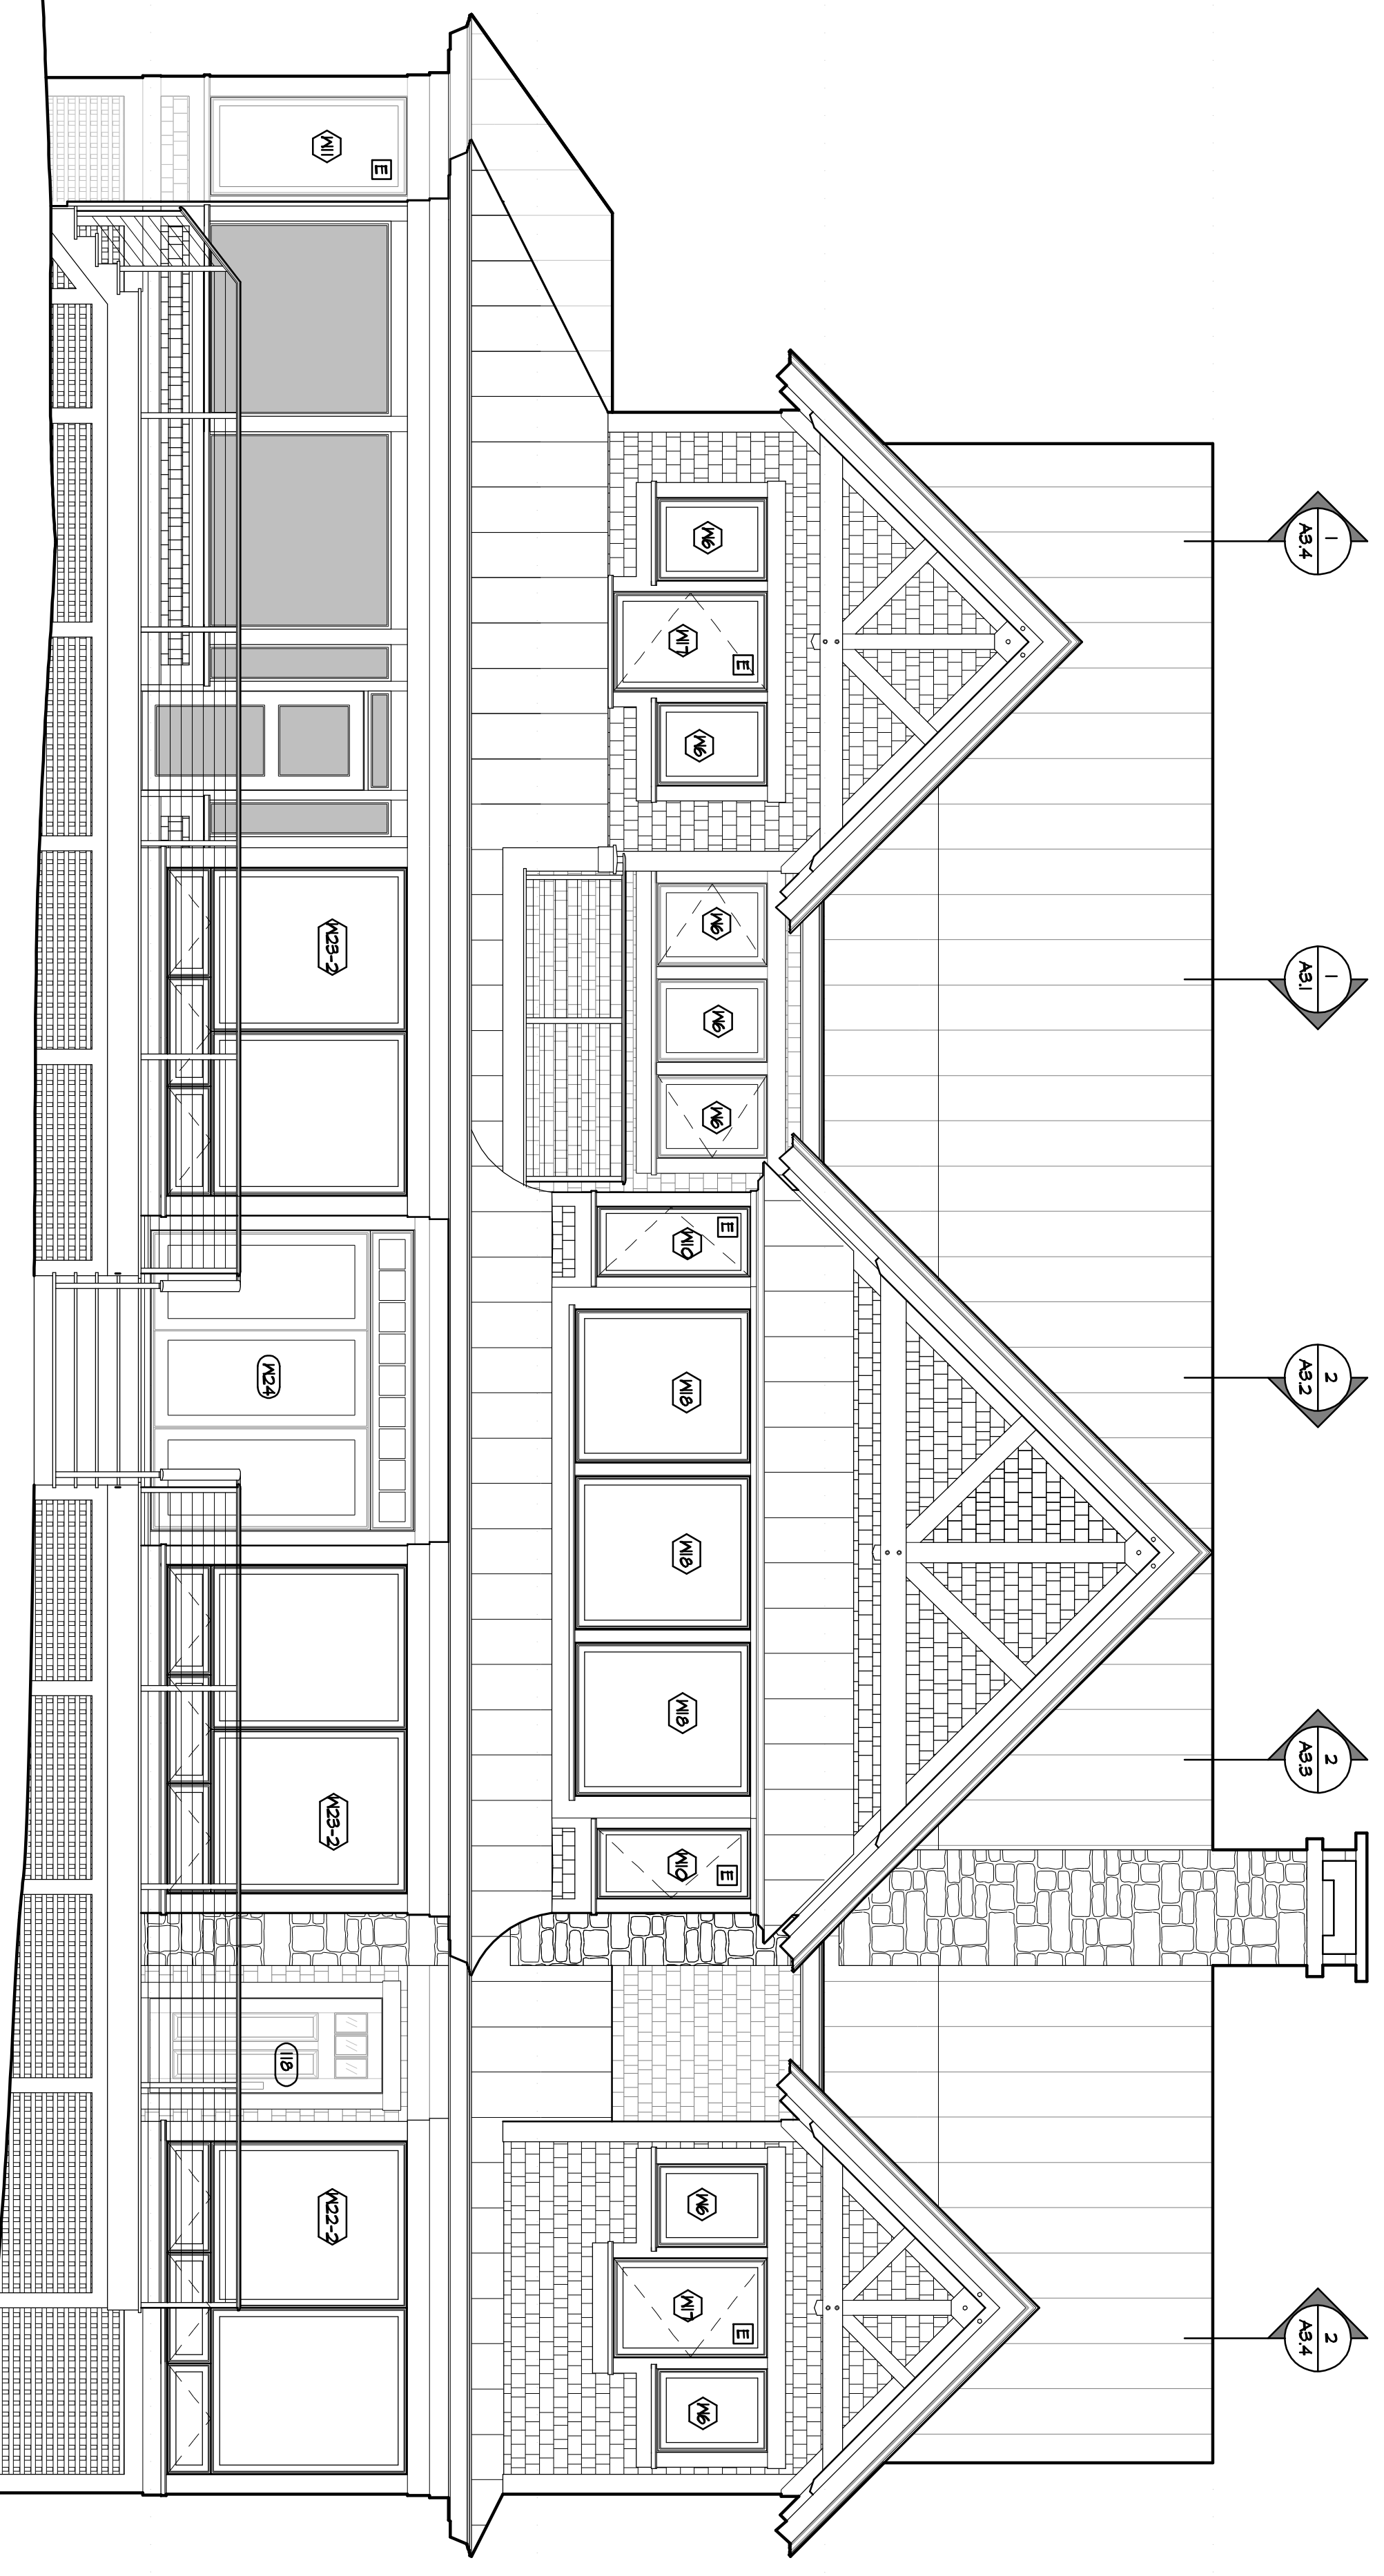

ISSUE FOR PERMIT  
PROGRESS PRINT  
NOT FOR CONSTRUCTION

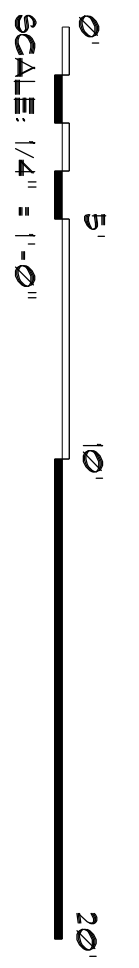

REVISIONS  
XXXX, XXX

SOSNIK COTTAGE  
GREAT DIAMOND ISLAND ■ PORTLAND ■ MAINE  
EXTERIOR ELEVATIONS  
SCALE: 1/4" = 1'-0"

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JOB NO.	FILE NAME
1506	1506-ELEVATION
DRAWN BY	DATE
JJA	24 MAY 2016
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A2.1