


67 WOODMONT STREET

Portland, Maine

February 17, 2005


SCHEMATIC DESIGN • Building Section 1/4" = 1'-0"

MarilynLeivian**Architect** 77RackdeffStræt Portland•Maire 04103 Phone 207•774•3668 mlarch@maine.rr.com

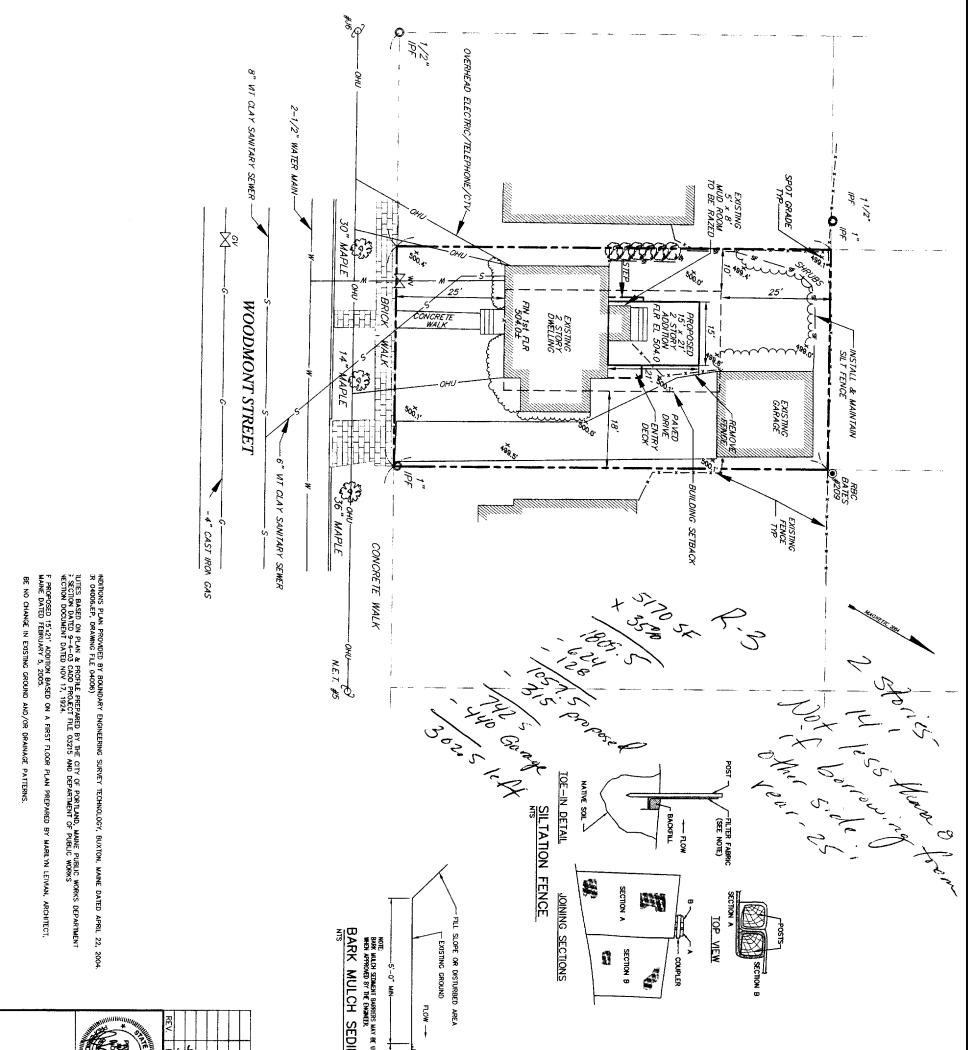

	JEC 2/10/05 JRK 5/3/04 BY DATE		
67 WOODMONT STREET PORTLAND, MAINE BUILDING ADDITION SITE PLAN Sevee & Maher Engineers, Inc. Consulting Biggivers Comberland Center, Maare	REVISED FOUNDATION SIZE, AND DECK CITY OF PORTLAND SITE PLAN REVIEW STATUS TODD O.	WOOD WASTE COMPOST/BARK	LOCATION PLAN
OR NE OR OESIGN BY: JRK DRAWN BY: PAF DATE: 4/27/04 CHECKED BY: ACC UMN: ADDITION	Σ		
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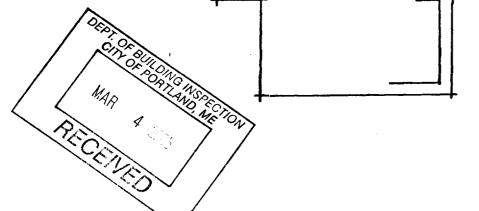
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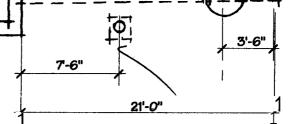


• schematic design • schematic d

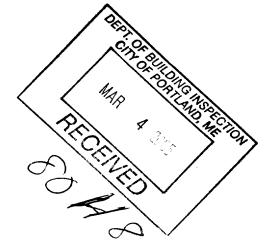67 WOODMONT STREET

IF REQUIRED, INSTALL RADON REMEDIATION MATERIALS ACCORDING TO STANDARD RADON REMEDIATION PRACTICES. WATERPROOF EXTERIOR = NDATI WALLS TO GRADE.	SUMP PUMP AND/OR FLOOR DRAIN TO BE FIELD LOCATED.	STRAPS AND/OR ANCHORS AT CORNERS 48" OC	FOUNDATION FOOTING DRAINS SHALL BE 4" DIA. PERFORATED DRAIN TILE TO SUMP OR SLOPED W/ POSITIVE UV	FOUNDATION FOOTINGS SHALL BE MIN. 48" BELOW FINAL FINISH GRADE OR TO FROST DEPTH AND UNDISTURBED SOIL.	FOUNDATION FOOTINGS SHALL HAVE A KEYWAY OR #4 REBAR 24" LONG PLACED VERT. @ 48" O.C.	CONCRETE FOOTINGS: 2500 PSI CONCRETE WALLS & SLAB: 3000 PSI	FOUNDATION NOTES:	ALL INTERIOR FINISHES AS SELECTED BY OWNER.	ALL MANUFACTURED STRUCTURAL LUMBER AND TRUSSES SHALL BE INSTALLED IN ACCORDANCE WITH MANUFACTURER INSTRUCTIONS. OPENINGS CUT IN MEMBERS SHALL MEET OR EXCEED RECOMMENDED GUIDELINES.	UNLESS OTHERWISE CERTIFIED ON THE PLANS, ALL STRUCTURAL MEMBERS SHALL BE VERIFIED BY A STRUCTURAL ENGINEER.	ALL SITE, MECHANICAL, ELECTRICAL AND UTILITY DESIGN SHALL BE BY OTHERS.	IT IS THE RESPONSIBILITY OF THE CONTRACTOR TO MEET ALL NATIONAL, STATE AND LOCAL BUILDING CODES AND REGULATIONS. IT IS THE RESPONSIBILITY OF THE CONTRACTOR TO OBTAIN ANY/OR ALL PERMITS REQUIRED TO PERFORM AND COMPLETE THE WORK	ALL EXISTING CONDITIONS AND DIMENSIONS SHALL BE VERIFIED BY THE CONTRACTOR. ANY POTENTIAL AND/OR REAL CONFLICTS WHICH MAY HAVE AN IMPACT ON THE PROPOSED ADDITION/RENOVATIONS SHALL BE BROUGHT TO THE ATTENTION OF THE OWNER AND/OR THEIR REPRESENTATIVE, PROMPTLY.	ALL DRAWINGS ARE SCHEMATIC IN NATURE. THEY IN NO WAY SHALL IMPLY ALL SPECIFIC MATERIALS, MEANS OR METHODS OF CONSTRUCTION; AND ARE FOR LAYOUT INFORMATION ONLY. ALL DRAWINGS ARE INTENDED TO REFLECT STANDARD BUILDING PRACTICES.	
						FDN. WALL		NO.4 X 12" REBAR DOWELS @ 24" O.C.		ZKO FKAMING, SLOPE FRAMING TO DRAIN, WATERPROOF W/RUBBER ROOFING, PRESSURE-TREATED DECKING AT DECK FLOOR	STEPPED ENTRY DECK		42" DIA. AREA WELL BASEMENT WINDOWS		
	FOUNDATION PLAN			• •	basement				drop wai	6" fdn. 19" basement	8 -2		8'-0" 15'-0"		





These drawings are schemmatic in nature and are for layout information. Al existing conditions shall be verified by the contractor. The drawings are the exclusive property of the Architect. Sheet No. **1 of 4**

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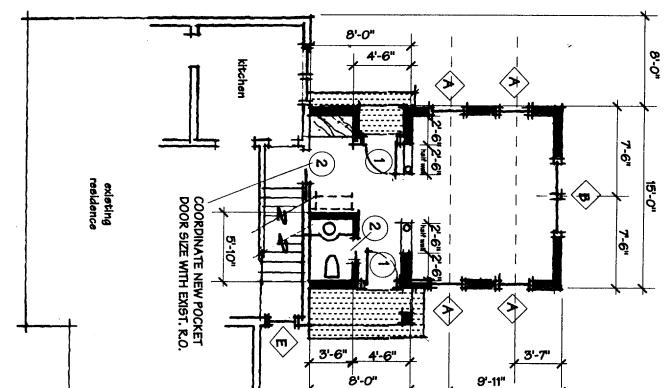
February 17,2005


SCHEMATIC DESIGN • Foundation Plan • Miscellaneous Notes 1/8" = 1'-0"









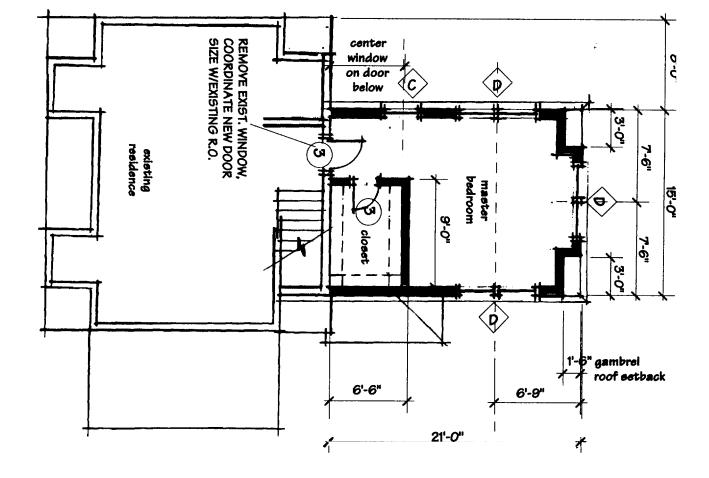





Sheet No. 2 of 4

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SCHEMATIC DESIGN • Floor Plans 1/8" = 1'-0"




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NORTH ELEVATION



> DOOR TYPE DESCRIPTION: Color and hardware as selected by Owner.

SIZE

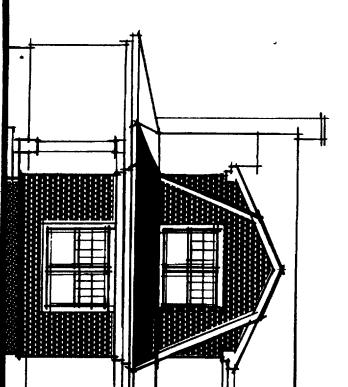- **EXTERIOR DOOR:** Similar to: THERMA-TRU, Smooth Star St Provide screen/storm combination door.
- INTERIOR POCKET DOOR: Similar to: MATCH EXISTING in profile and finish. SIZE MAY VARY, SEE PLANS.

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INTERIOR PASSAGE DOOR: Similar to: MATCH EXISTING in profile and finish. SIZE MAY VARY, SEE PLANS.

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WINDOW TYPE DE

- E DESCRIPTION: Color and hardware as selected by Owner.
- A **1st FLOOR:** Similar to: ANDERSON TW30410, double-hung tilt-wash window. Provide insect screen.
- **1st FLOOR:** Similar to: **ANDERSON TW30410-2**, double-hung tilt-wash window. Double-wide unit. Provide insect screens.
- **2nd FLOOR:** Similar to: **ANDERSON TW3046**, double-hung tilt-wash window. Provide insect screen. EGRESS WINDOW ... DO NOT MODIFY SIZE.

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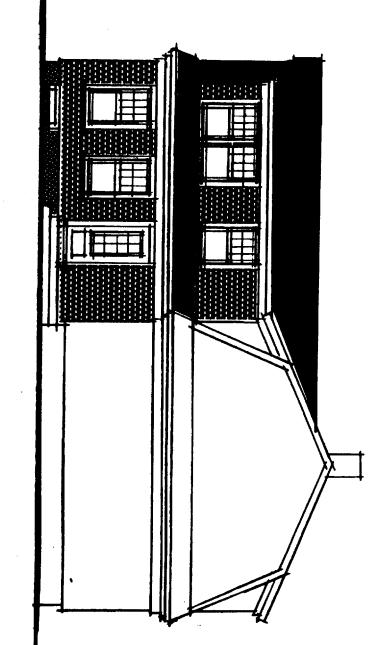
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D 2nd FLOOR: Similar to: ANDERSON TW3046-2, double-hung tift-wash window. Double-wide unit. Provide insect screens. EGRESS WINDOW ... DO NOT MODIFY SIZE.

SOUTH ELEVATION

- MAIN STAIR: Similar to: ANDERSON AW261 auming window
- E MAIN STAIR: Similar to: ANDERSON AW251 awning window. Provide insect screen.
- **BASEMENT:** Similar to: **ANDERSON 2017** interior swing awning Provide insect screen.

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	2-85/8"	2'-4 7/8" x	6'-3 15/16"	3'-2 1/8" ×	6'-3 15/16"	3'-2 1/8" x	R.O. SIZE		2-0" x 6' 2-4" x 6'	2'-8" x 6'
MAR A CRASS CONTRACTOR	x 1'-7 1/4"	(2'-4 7/8"	" x 4'-8 7/8"	4'-8 7/8"	" x 5'-0 7/8"	: 5'-0 7/8"		قِنْ قِنْ	Ģ ģ	-8"
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SCHEMATIC DESIGN • Elevations 1/8" = 1'-0"