
73-A-1 175 Fore River Parkway Mercy Hospital


> alreader on Spreadshoet add to file on G: Drive

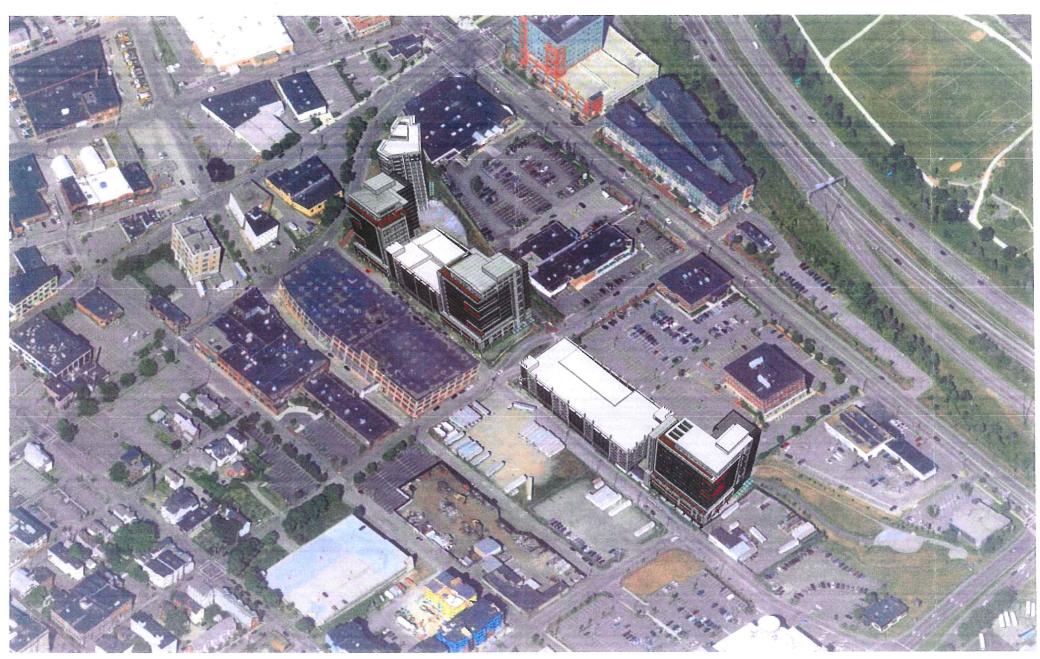



midtown
Portland, ME

aerial view 1



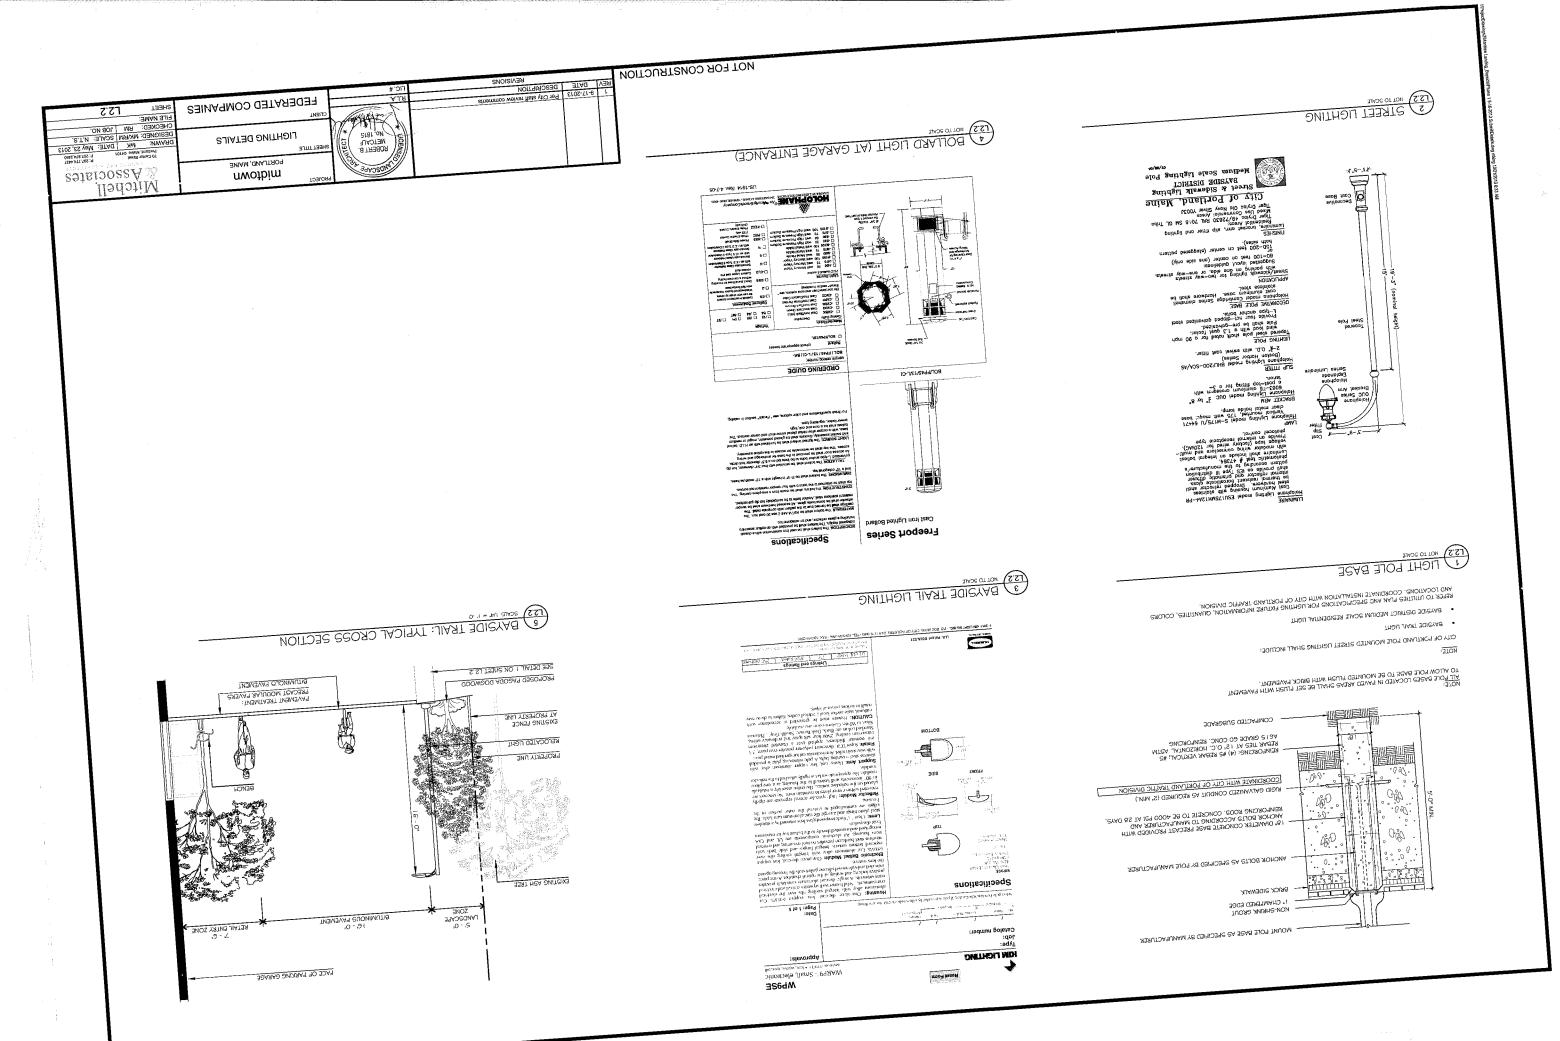

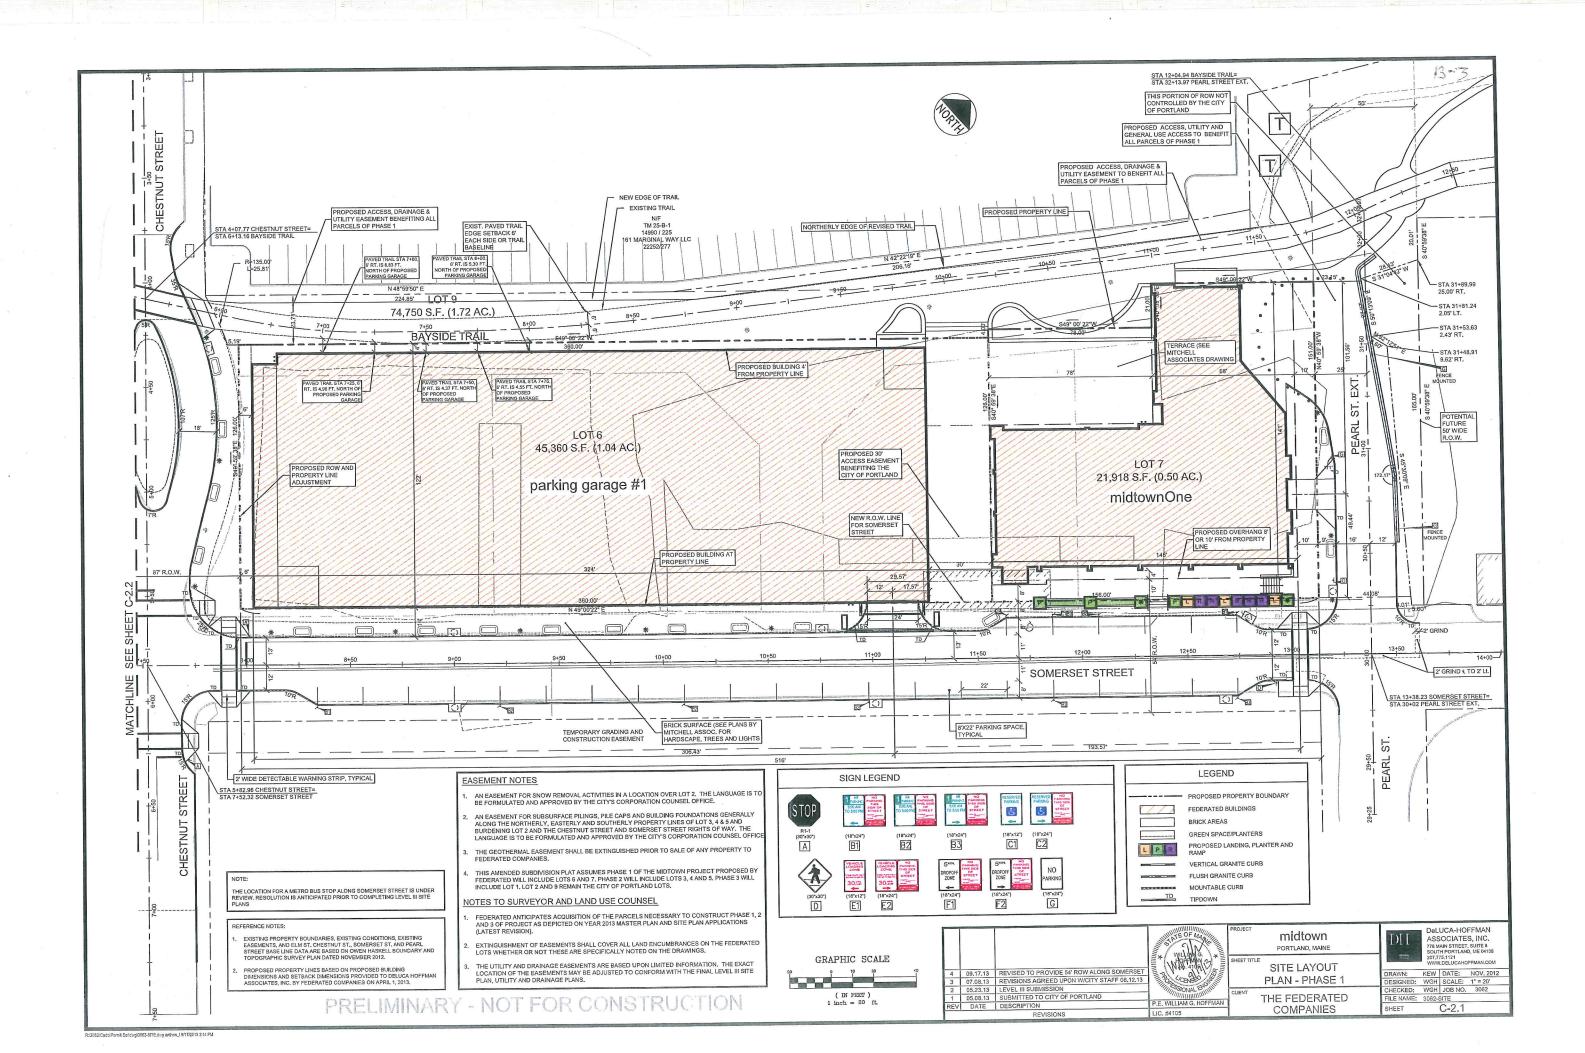

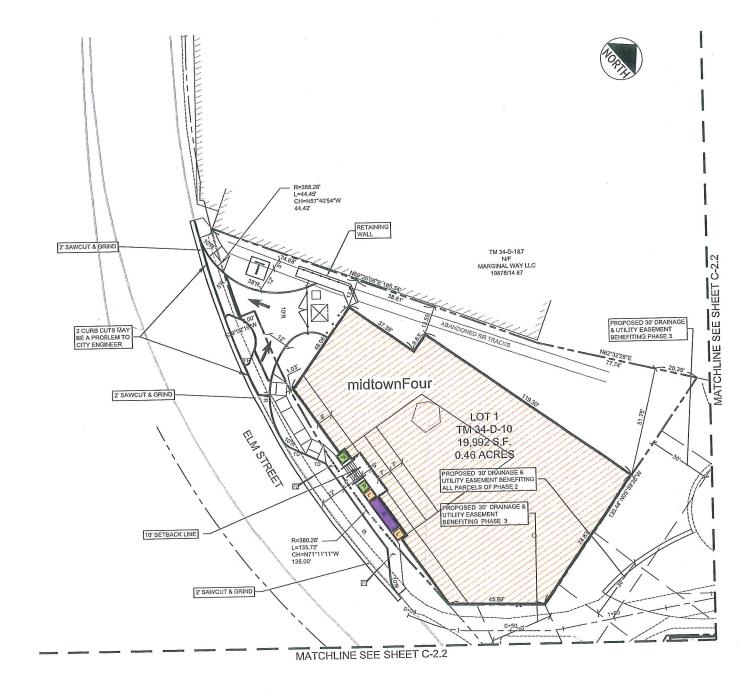

REFERENCE NOTE


- EXISTING PROPERTY BOUNDARIES, EXISTING CONDITIONS, EXISTING EASEMENTS, AND ELM ST. CHESTNUT ST., SOMERSET ST. AND PEARL STREET BASE LINE DATA ARE BASED ON OWEN HASKELL BOUNDARY AND THE BASE LINE OF THE BASE LINE OF THE BASED ON THE BASE AND THE BOUNDARY AND THE BASE AND THE BASE AND THE BOUNDARY AND THE BASE AND THE BASE AND THE BOUNDARY AND THE BASE AND
- PROPOSED PROPERTY LINES BASED ON PROPOSED BUILDING DIMENSIONS AND SETBACK DIMENSIONS PROVIDED TO DELUCA HOFFMAI ASSOCIATES, INC. BY FEDERATED COMPANIES ON APRIL 1, 2013.


EASEMENT NOTES


- AN EASEMENT FOR SNOW REMOVAL ACTIVITIES IN A LOCATION OVER LOT 2. THE LANGUAGE IS TO BE FORMULATED AND APPROVED BY THE CITY'S CORPORATION COUNSEL OFFICE.
- 2. AN EASEMENT FOR SUBSURFACE PILINGS, PILE CAPS AND BUILDING FOUNDATIONS GENERALLY ALONG THE NORTHERLY, EASTERLY AND SOUTHERLY PROPERTY LINES OF LOT 3, 4 & 5 AND BURDENING LOT 2 AND THE CHESTNUT STREET AND SOMERSET STREET RIGHTS OF WAY. THE LANGUAGE IS TO BE FORMULATED AND APPROVED BY THE CITY'S CORPORATION COUNSEL OFFICE.
- THE GEOTHERMAL EASEMENT SHALL BE EXTINGUISHED PRIOR TO SALE OF ANY PROPERTY TO FEDERATED COMPANIES.
- THIS AMENDED SUBDIVISION PLAT ASSUMES PHASE 1 OF THE MIDTOWN PROJECT PROPOSED BY FEDERATED WILL INCLUDE LOTS 6 AND 7. PHASE 2 WILL INCLUDE LOTS 3, 4 AND 5. PHASE 3 WILL INCLUDE LOT 1.

NOTES TO SURVEYOR AND LAND USE COUNSEL

- FEDERATED ANTICIPATES ACQUISITION OF THE PARCELS NECESSARY TO CONSTRUCT PHASE 1, 2 AND 3 OF PROJECT AS DEPICTED ON YEAR 2013 MASTER PLAN AND SITE PLAN APPLICATIONS.
- 2. EXTINGUISHMENT OF EASEMENTS SHALL COVER ALL LAND ENCUMBRANCES WHETHER OR NOT THESE ARE SPECIFICALLY NOTED ON THE DRAWINGS.
- THE UTILITY AND DRAINAGE EASEMENTS ARE BASED UPON LIMITED INFORMATION.
 THE EXACT LOCATION OF THE EASEMENTS MAY BE ADJUSTED TO CONFORM WITH THE FINAL LEVEL III SITE PLAN, UTILITY AND DRAINAGE PLANS.

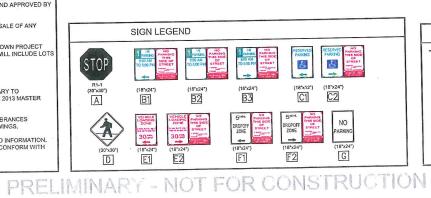

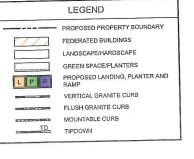

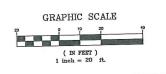

		,	THININI WHITE
4	09.17.13	REVISED TO PROVIDE 54' ROW ALONG SOMERSET	
3	07.08.13	REVISIONS AGREED UPON W/CITY STAFF 06.12.13	13
2	05,23,13	LEVEL III SUBMISSION	
1	05.08.13	SUBMITTED TO CITY OF PORTLAND	_
REV	DATE	DESCRIPTION	P.E
		REVISIONS	LIC

PROJECTION OF THE PROJECT OF THE PRO


PROJECT midtown
PORTLAND, MAINE
SHEET TITLE


SITE LAYOUT PLAN - PHASE 3


PLAN - PHASE 3
THE FEDERATED
COMPANIES

DeLUCA-HOFFMAN
ASSOCIATES, INC.
778 MAIN STREET, SUITE 8
SOUTH PORTLAND, ME 04106
207.775.1121
WWW.DELUCAHOFFMAN.COM

DRAWN: KEW JATE: NOV. 2012
DESIGNED: WGH SCALE: 1"= 20"
CHECKED: WGH JOB NO. 3062
FILE NAME: 3062-SITE
SHEET C-2.3

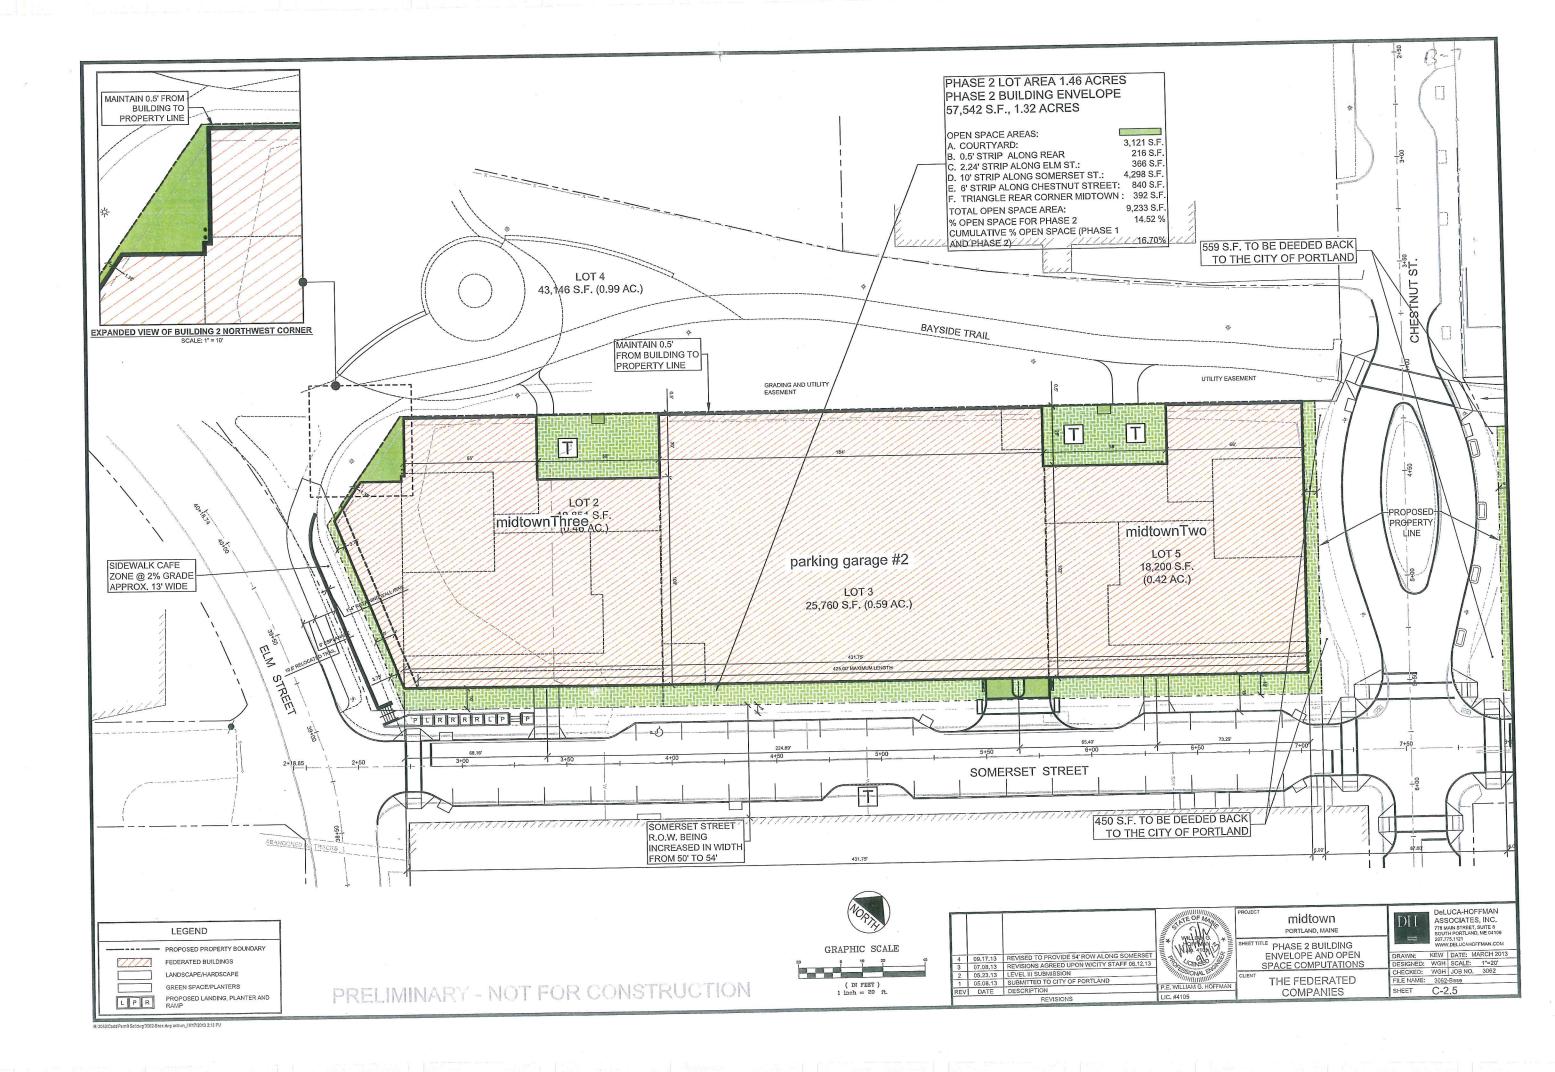


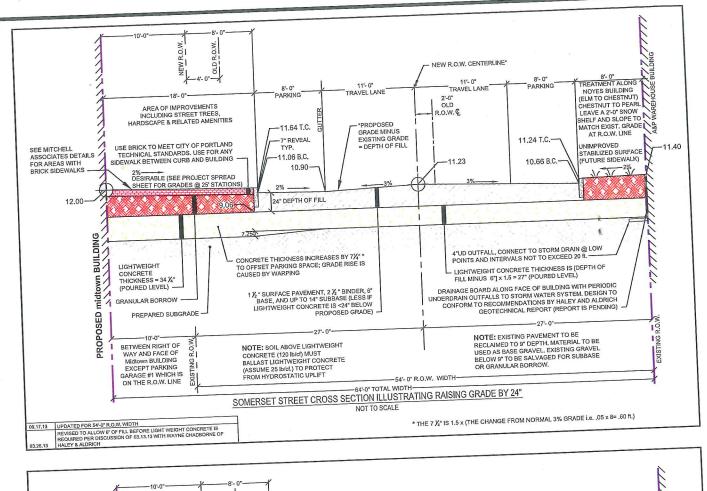


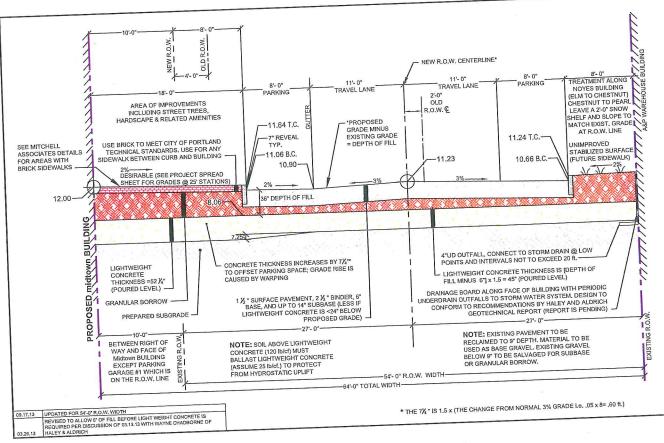

NOTE: SECTIONS ARE SUBJECT TO RECEIPT AND FINAL REVIEW OF THE GEOTECHNICAL REPORT FOR THE FEDERATED COMPANIES

PRELIMINARY - NOT FOR CONSTRUCTION

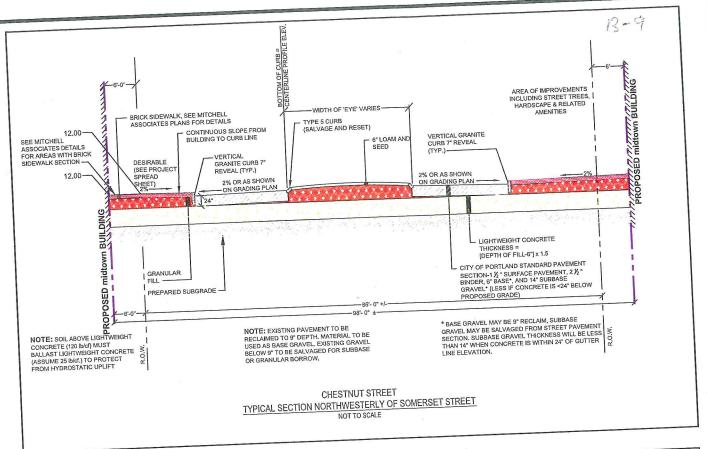

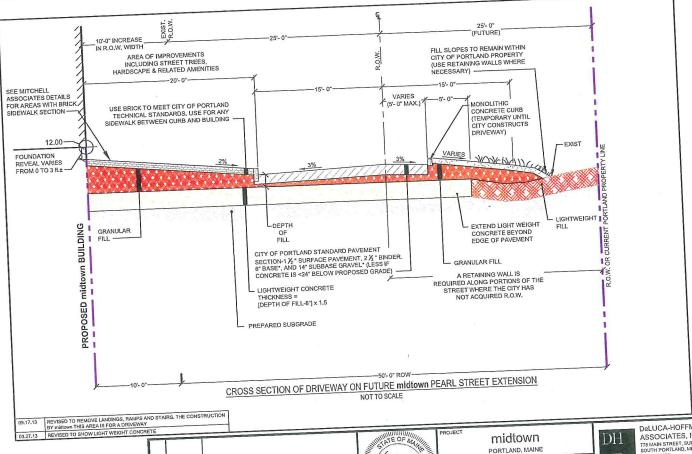


MAN G. 105 A 405 SONAL EN P.E. WILLIAM G. HOF


STREET AND DRIVEWAY CROSS SECTIONS


> THE FEDERATED COMPANIES


DeLUCA-HOFFMAN ASSOCIATES, INC. 778 MAIN STREET, SUITE 8 SOUTH PORTLAND, ME 04106 207.775.1121 WWW.DELUCAHOFFMAN.CON


RAWN: LA DATE: MAR 2013 ESIGNED: WGH SCALE: N.T.S. HECKED: WGH JOB NO. 3062 LE NAME: 3062-D

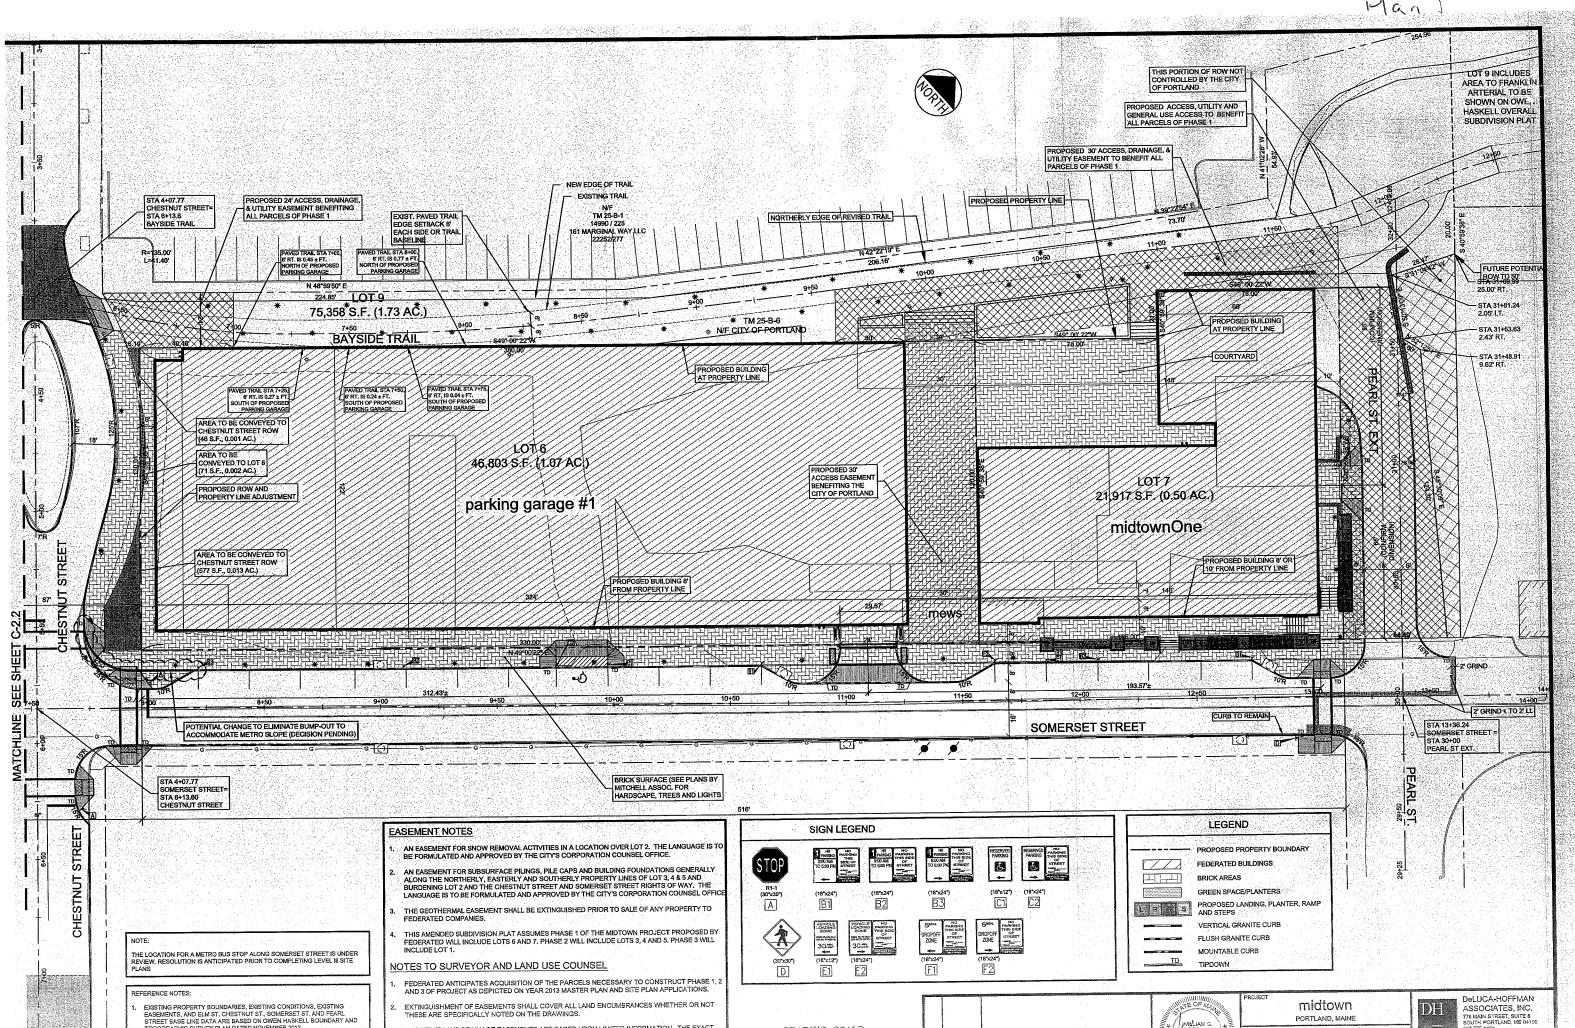


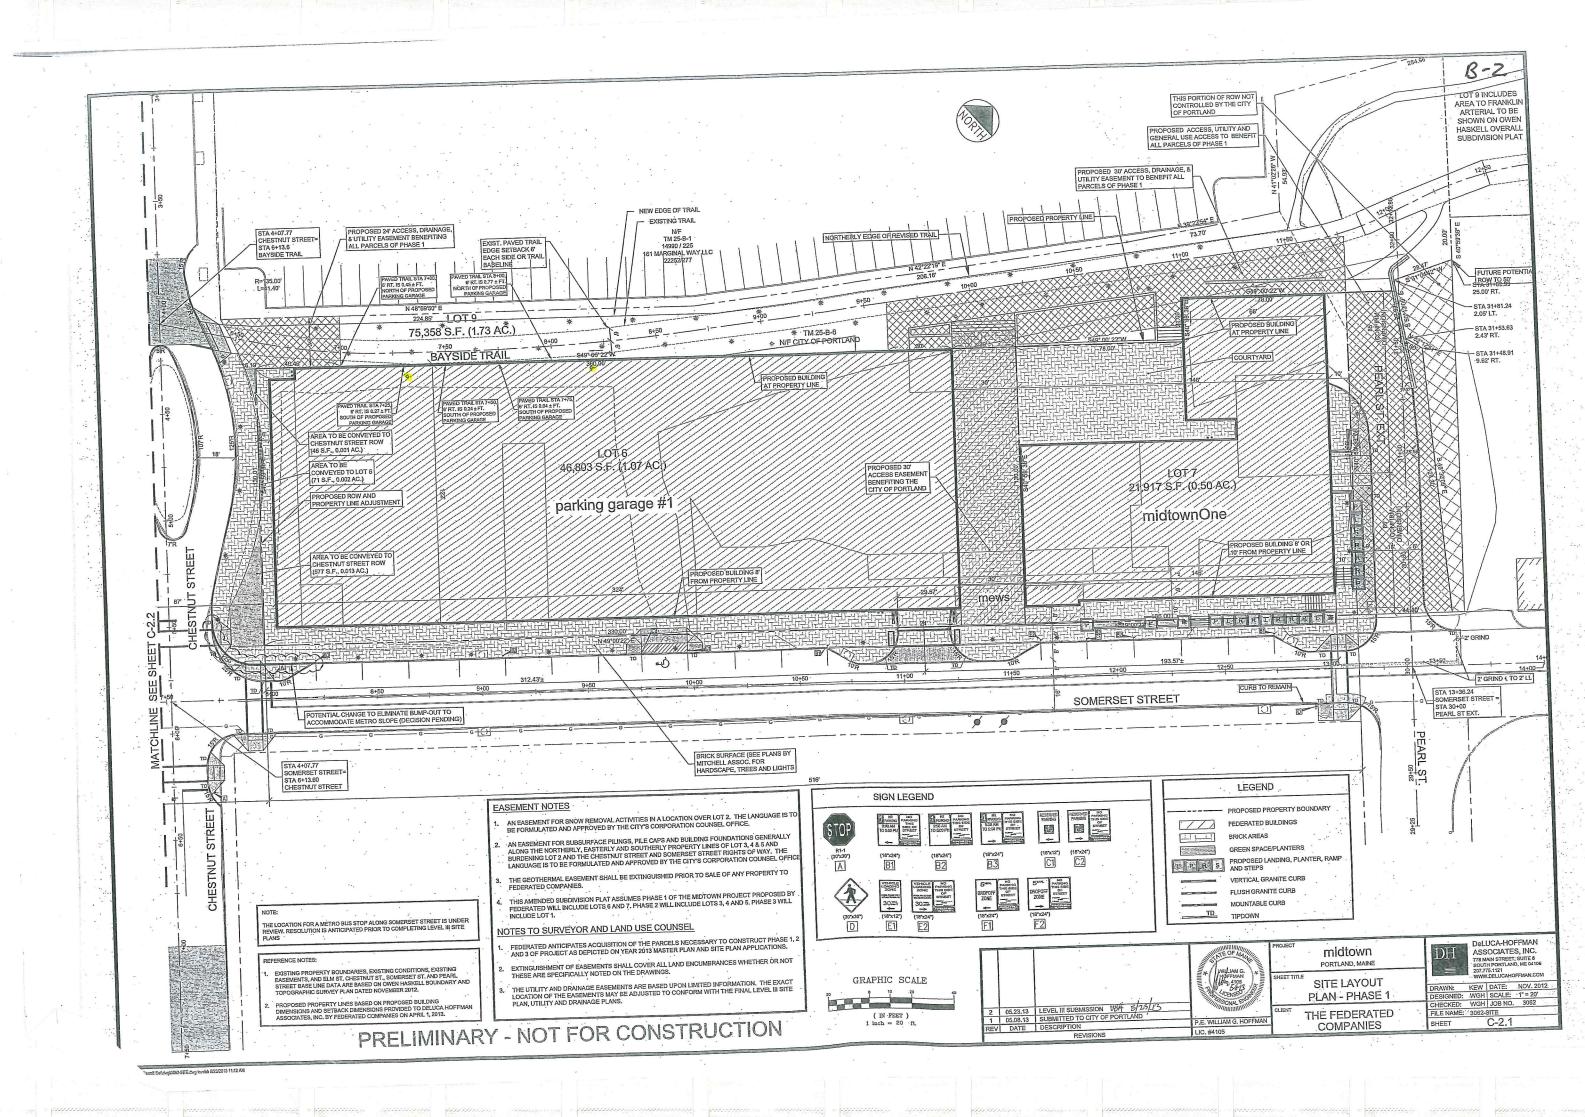


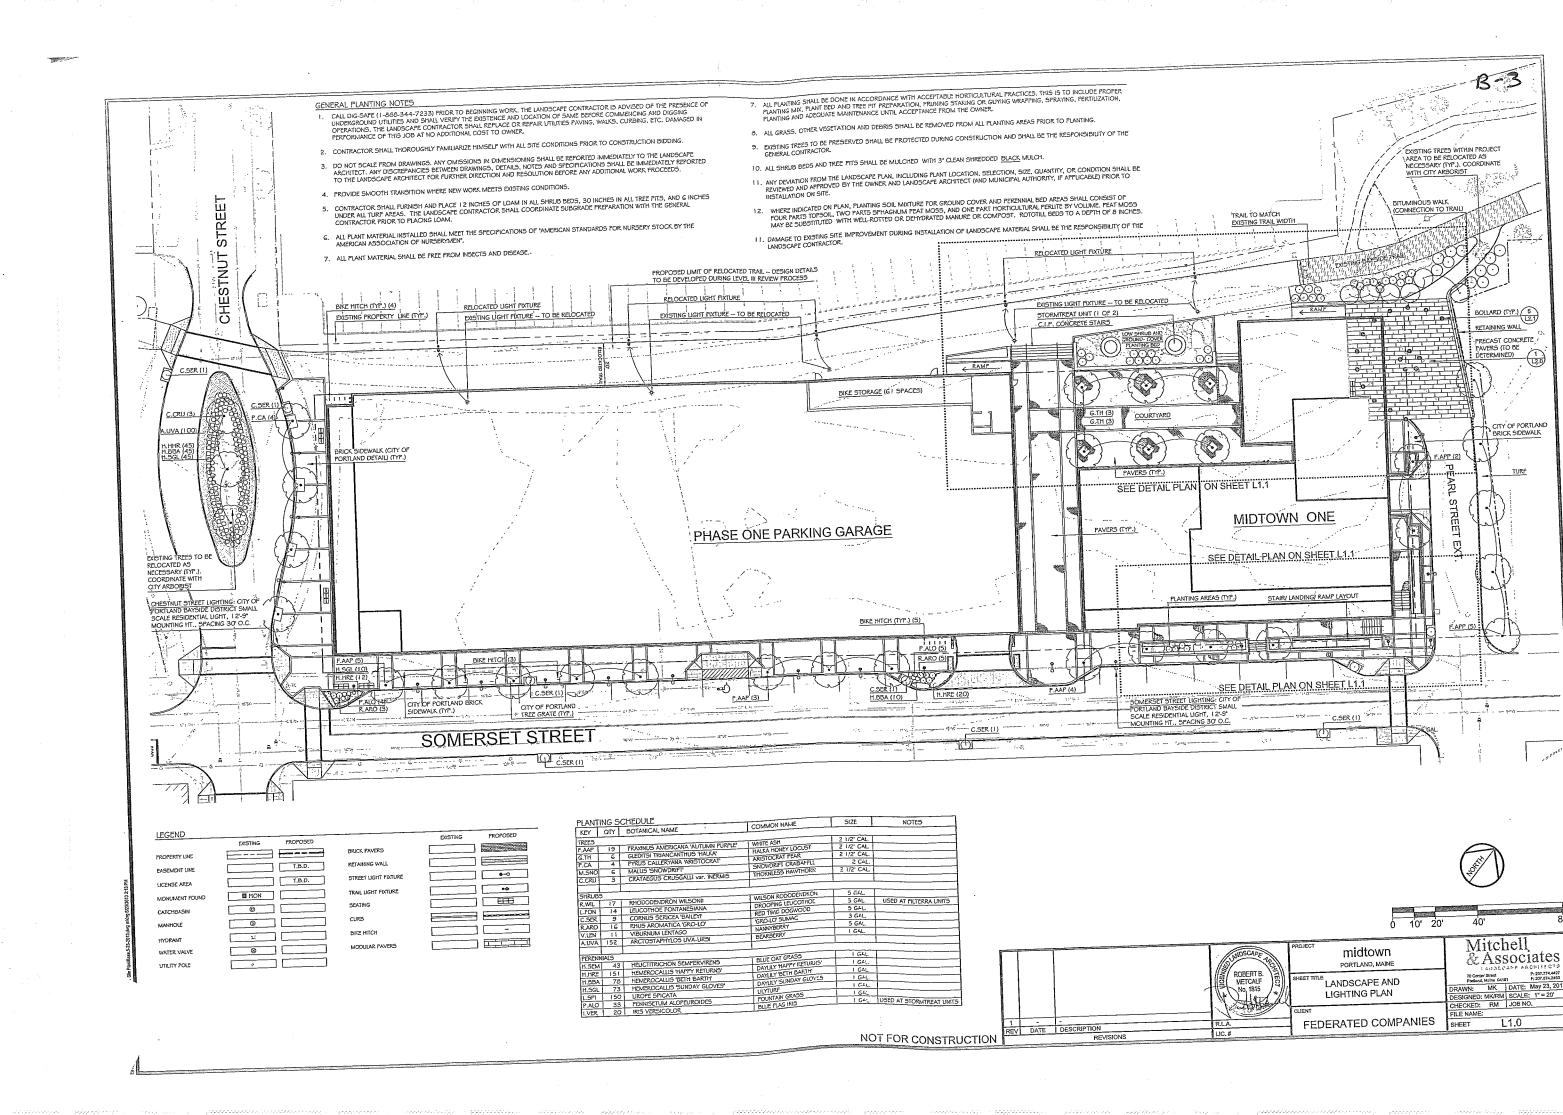


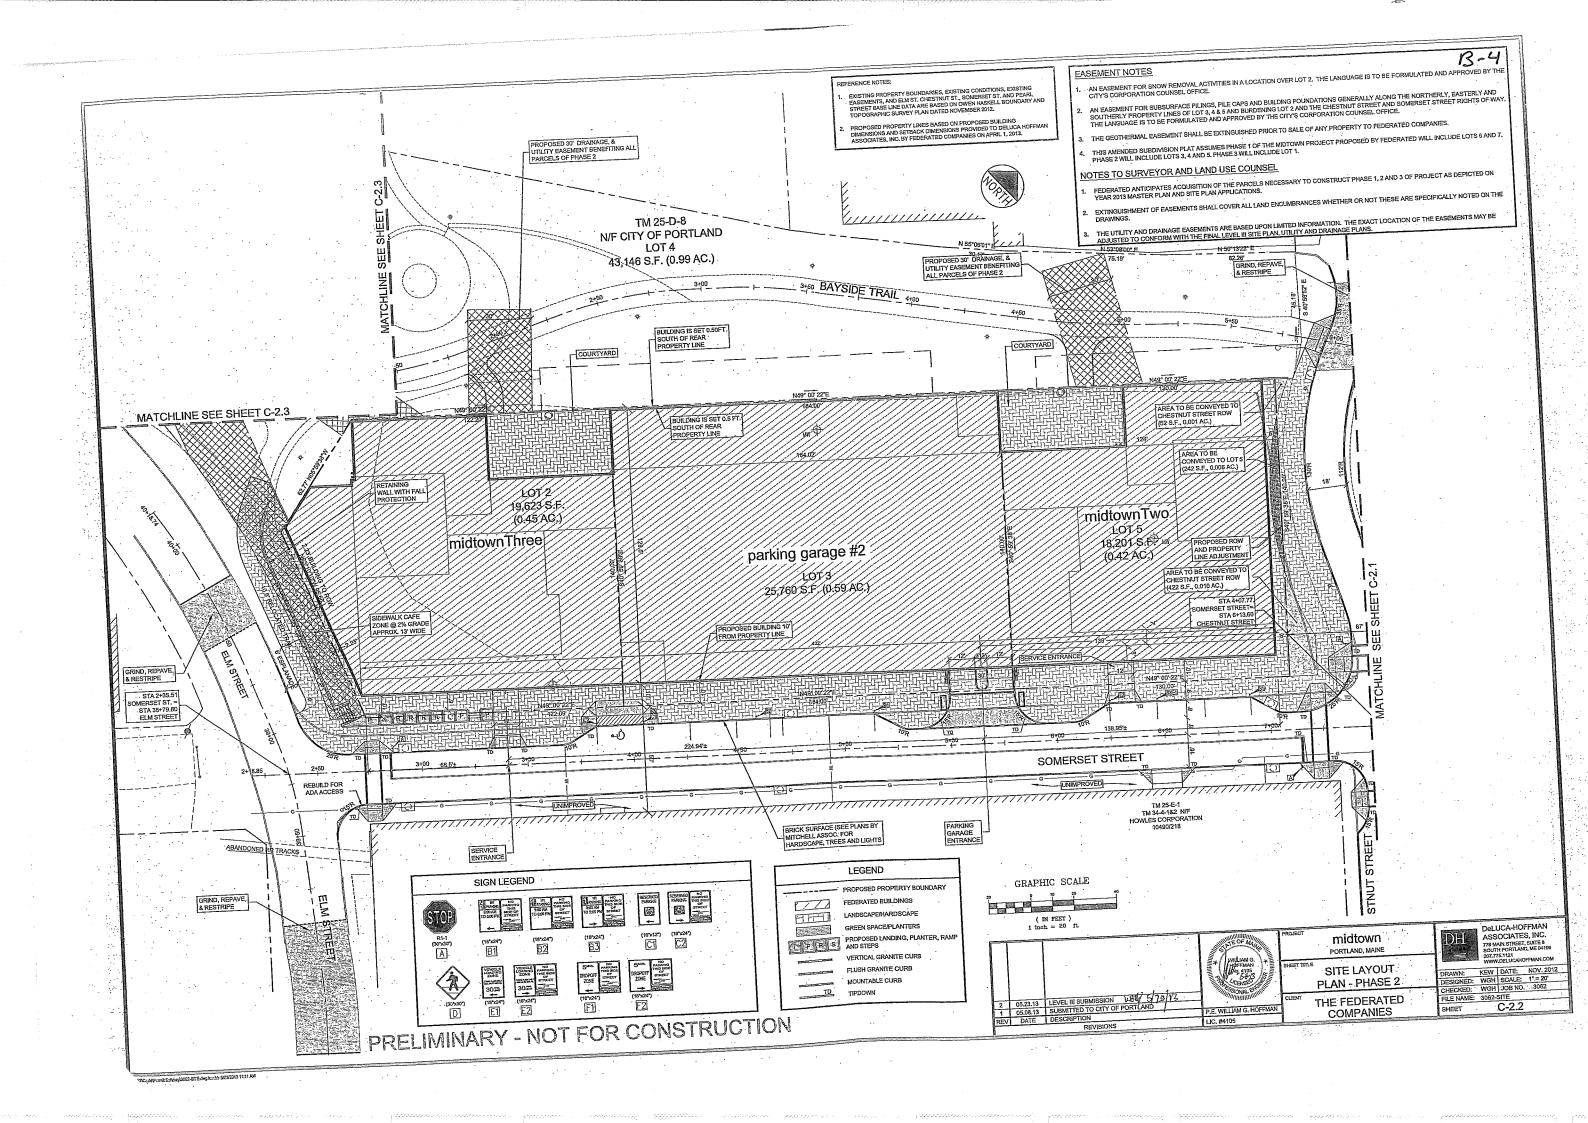


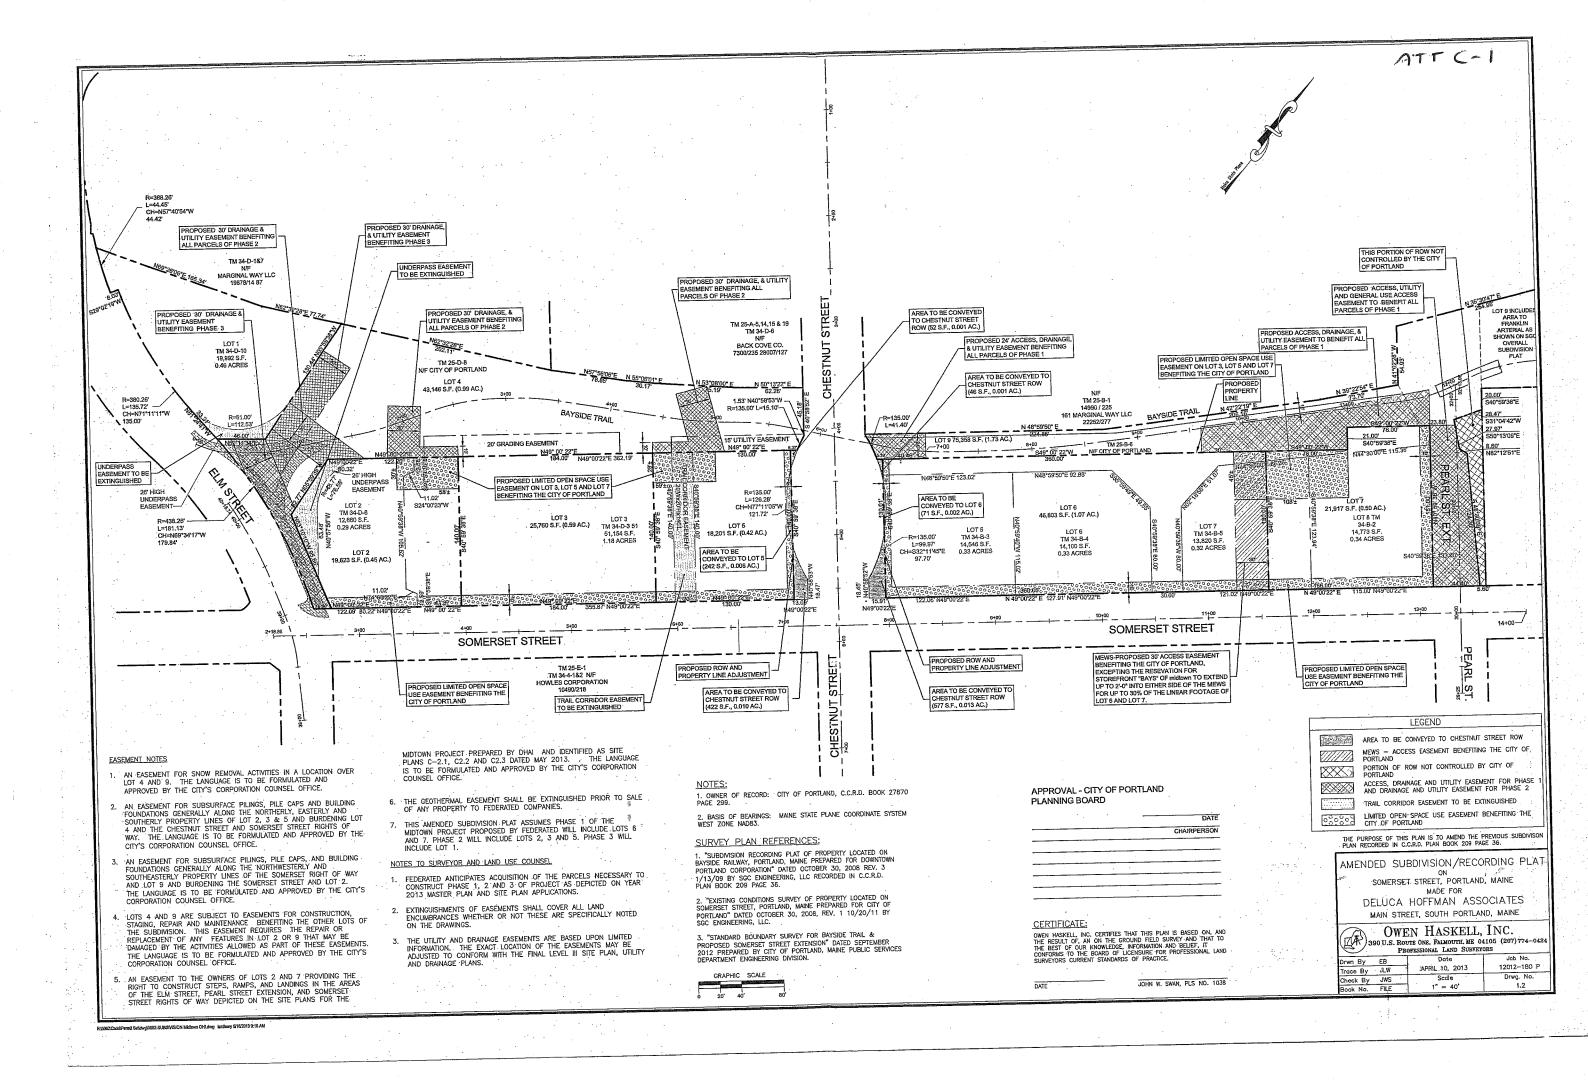

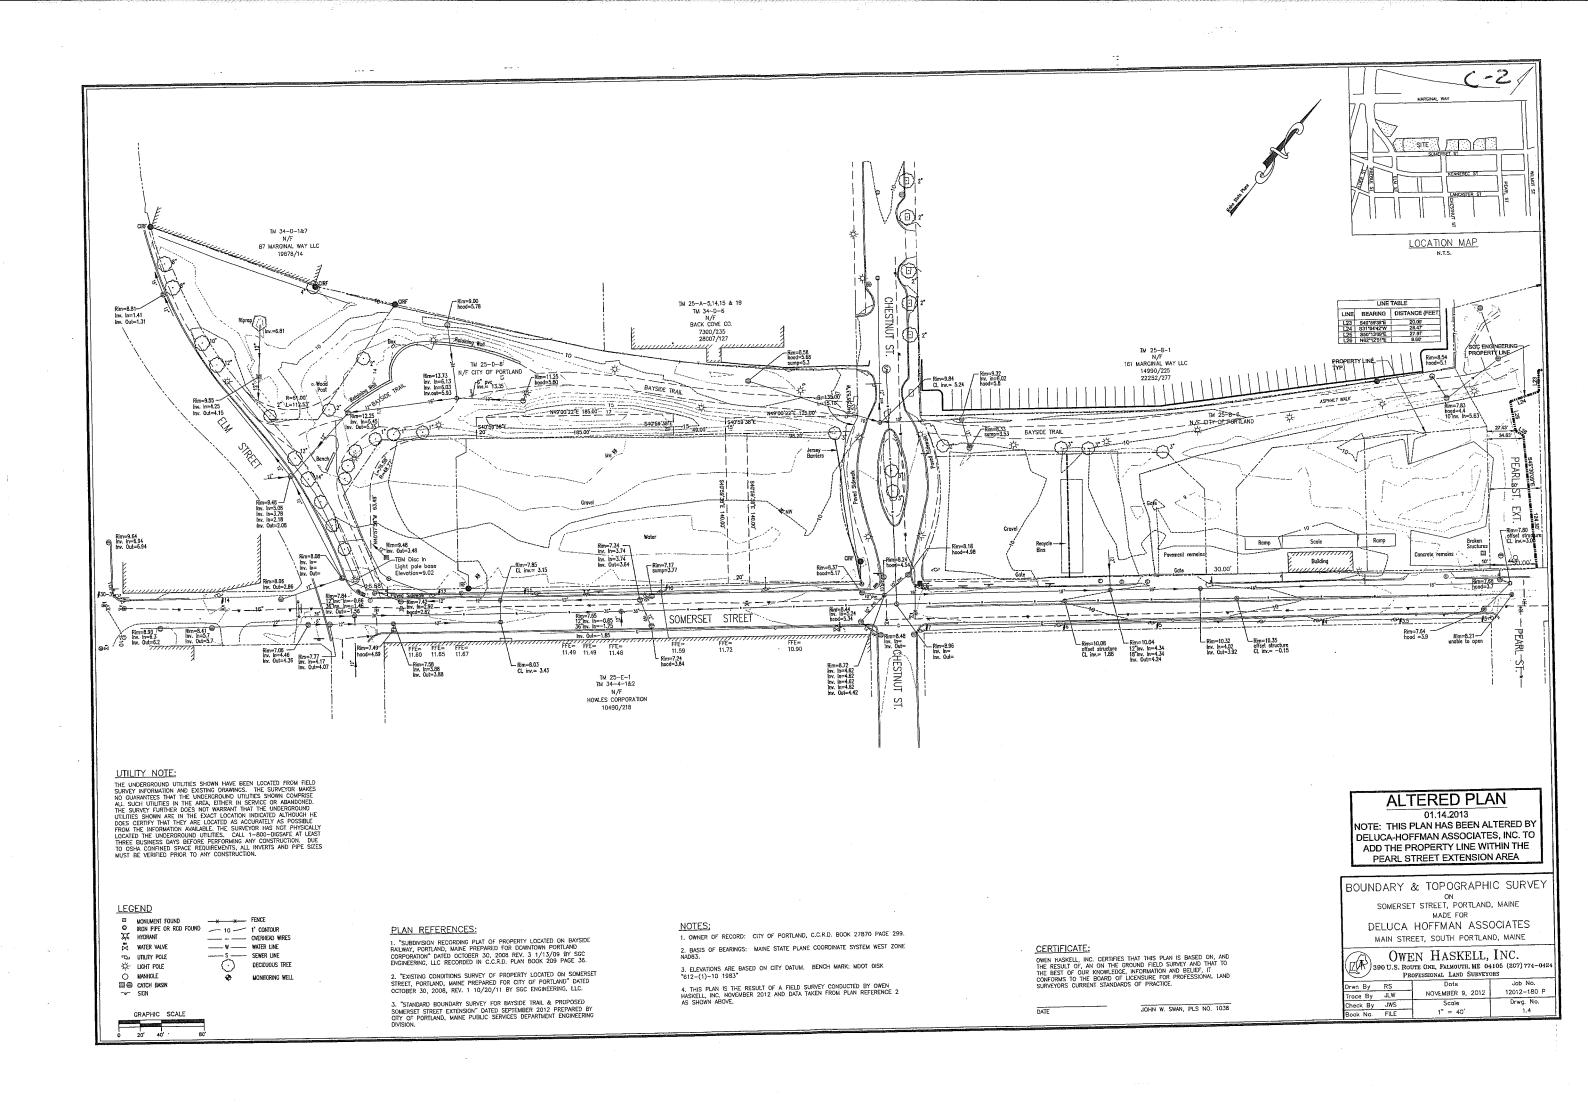

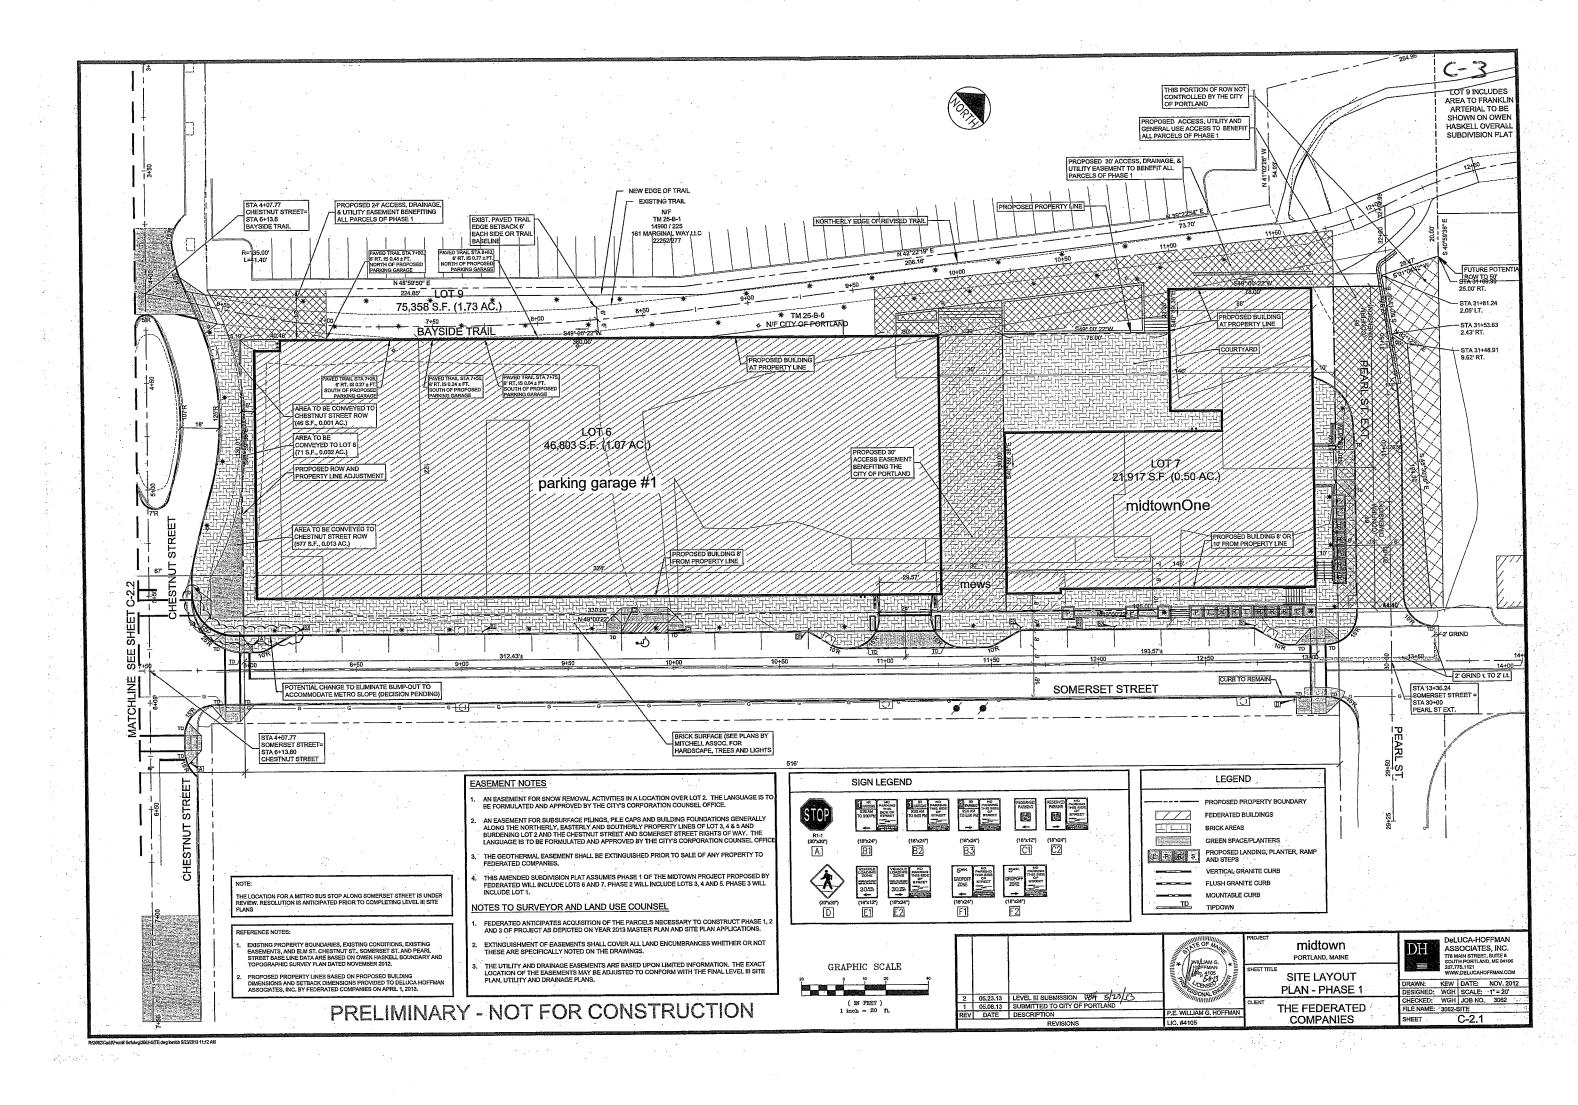

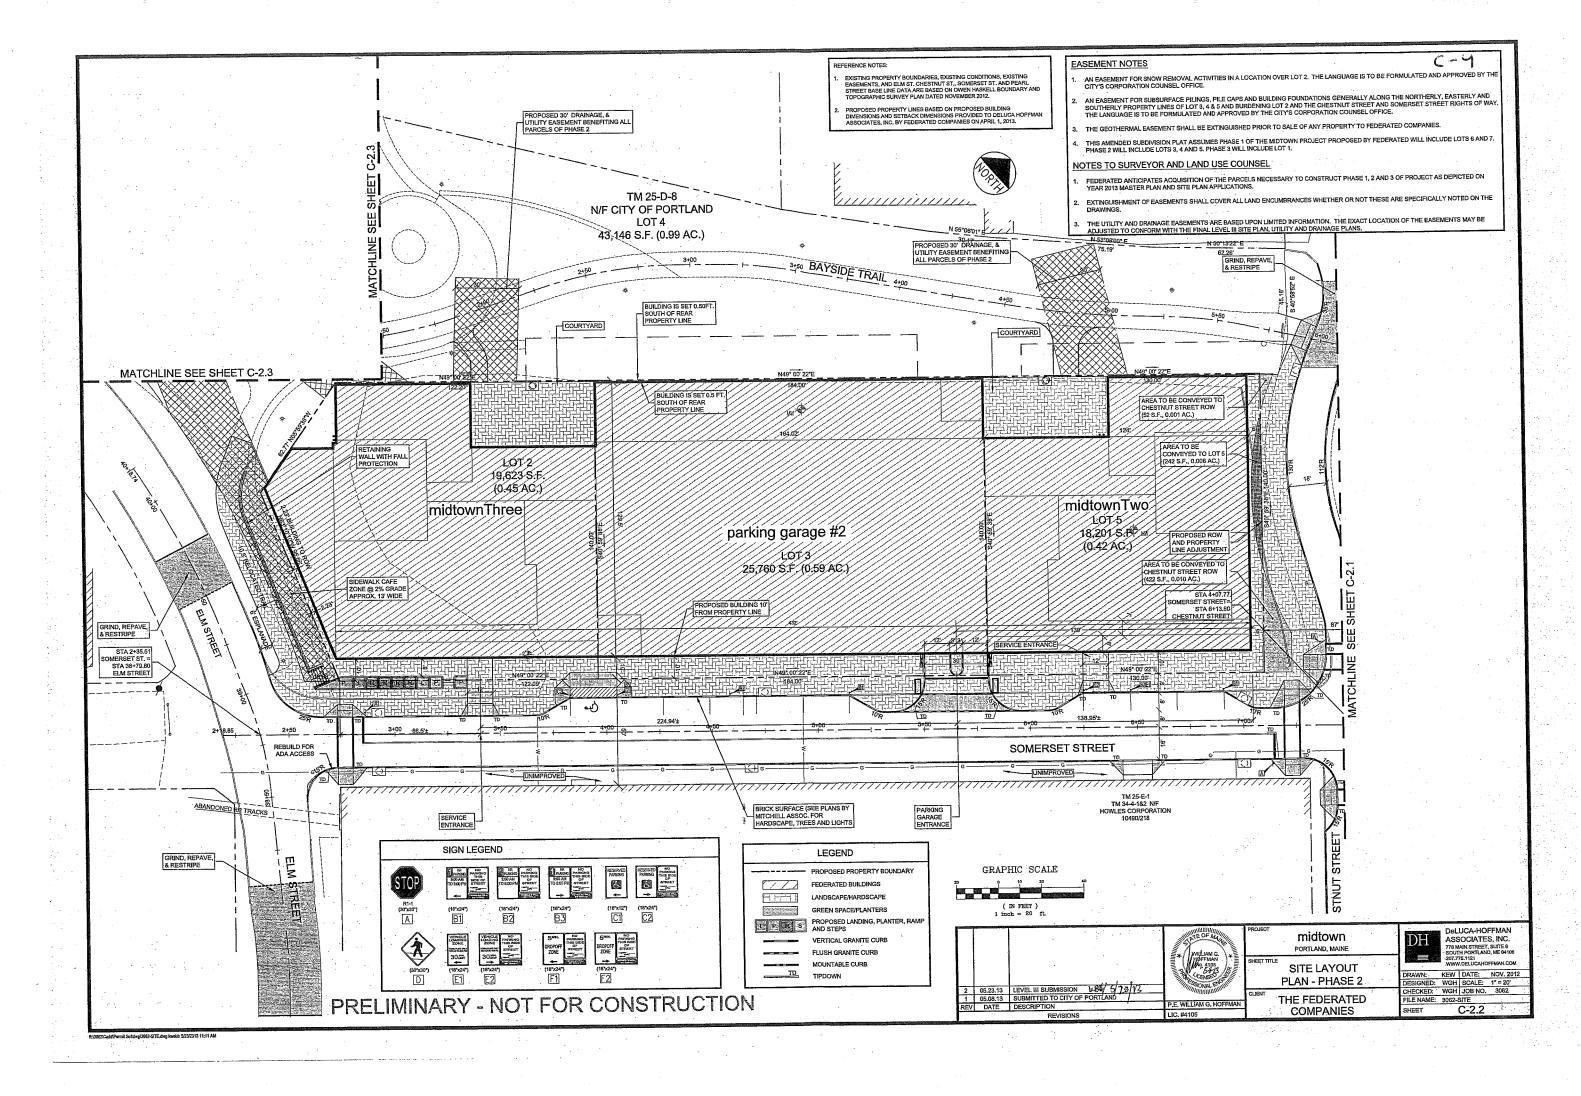

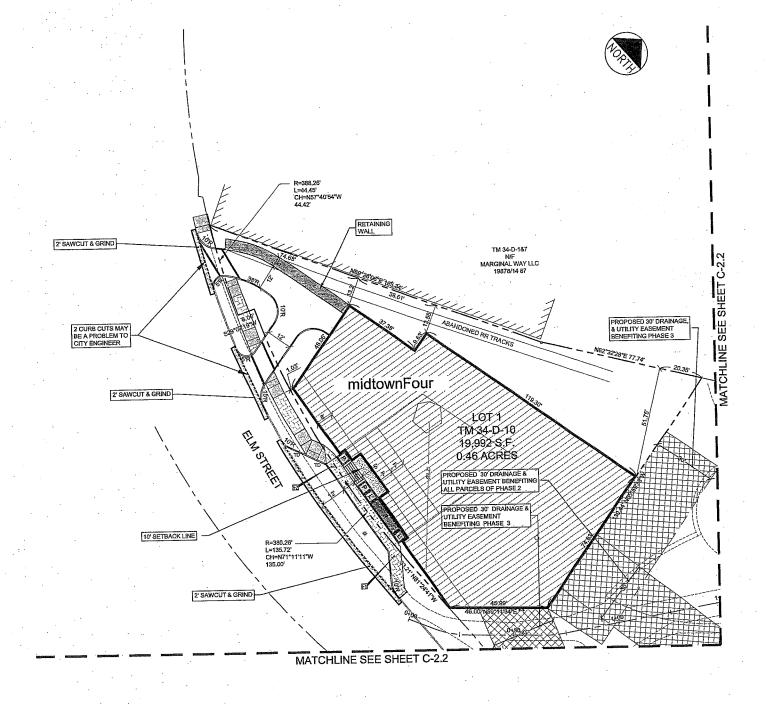


REFERENCE NOTES:


- EXISTING PROPERTY BOUNDARIES, EXISTING CONDITIONS, EXISTING EASEMENTS, AND ELM ST. CHESTMUT ST., SOMERSET ST. AND PEARL STREET BASE, LINE DATA ARE BASED ON OWNEN HASKELL BOUNDARY A TOPOGRAPHIC SURVEY PLAN DATED NOVEMBER 2012.

- AN EASEMENT FOR SNOW REMOVAL ACTIVITIES IN A LOCATION OVER LOT 2. THE LANGUAGE IS TO BE FORMULATED AND APPROVED BY THE CITY'S CORPORATION COUNSEL OFFICE.
- AN EASEMENT FOR SUBSURFACE PILINGS, PILE CAPS AND BUILDING FOUNDATIONS GENERALLY ALONG THE NORTHERLY, EASTERLY AND SOUTHERLY PROPERTY LINES OF LOT 3, 4 & 5 AND BURDENING LOT 2 AND THE CHESTNUT STREET AND SOMERSET STREET RIGHTS OF WAY. THE LANGUAGE IS TO BE FORMULATED AND APPROVED BY THE CITY'S CORPORATION COUNSEL OFFICE.
- THE GEOTHERMAL EASEMENT SHALL BE EXTINGUISHED PRIOR TO SALE OF ANY PROPERTY TO FEDERATED COMPANIES.
- THIS AMENDED SUBDIVISION PLAT ASSUMES PHASE 1 OF THE MIDTOWN PROJECT PROPOSED BY FEDERATED WILL INCLUDE LOTS 6 AND 7. PHASE 2 WILL INCLUDE LOTS 3, 4 AND 5, PHASE 3 WILL INCLUDE LOT 1.


NOTES TO SURVEYOR AND LAND USE COUNSEL

- FEDERATED ANTICIPATES ACQUISITION OF THE PARCELS NECESSARY TO CONSTRUCT PHASE 1, 2 AND 3 OF PROJECT AS DEPICTED ON YEAR 2013 MASTER PLAN AND SITE PLAN APPLICATIONS.
- EXTINGUISHMENT OF EASEMENTS SHALL COVER ALL LAND ENCUMBRANCES WHETHER OR NOT THESE ARE SPECIFICALLY NOTED ON THE DRAWINGS.
- THE UTILITY AND DRAINAGE EASEMENTS ARE BASED UPON LIMITED INFORMATION. THE EXACT LOCATION OF THE EASEMENTS MAY BE ADJUSTED TO CONFORM WITH THE FINAL LEVEL III SITE PLAN, UTILITY AND DRAINAGE PLANS.

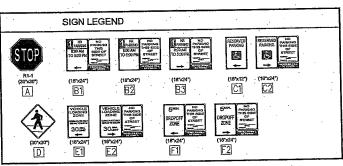

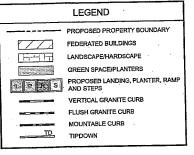

GRAPHIC SCALE (IN FEET) 1 inch = 20 ft.

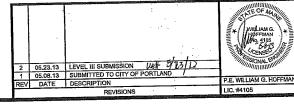

midtown PORTLAND, MAINE

SITE LAYOUT PLAN - PHASE 3

THE FEDERATED COMPANIES

ASSOCIATES, INC.
778 MAIN STREET, SUITE 8
SOUTH PORTLAND, ME 04106
207.775.1121
WWW.DELUCAHOFFMAN.COM

 DRAWN:
 KEW
 DATE:
 NOV. 2012


 DESIGNED:
 WGH
 SCALE:
 1*=20'


 CHECKED:
 WGH
 JOB NO.
 3062


 FILE NAME:
 3062-SITE
 C-2.3


PRELIMINARY - NOT FOR CONSTRUCTION


能特别。这次通行的方式

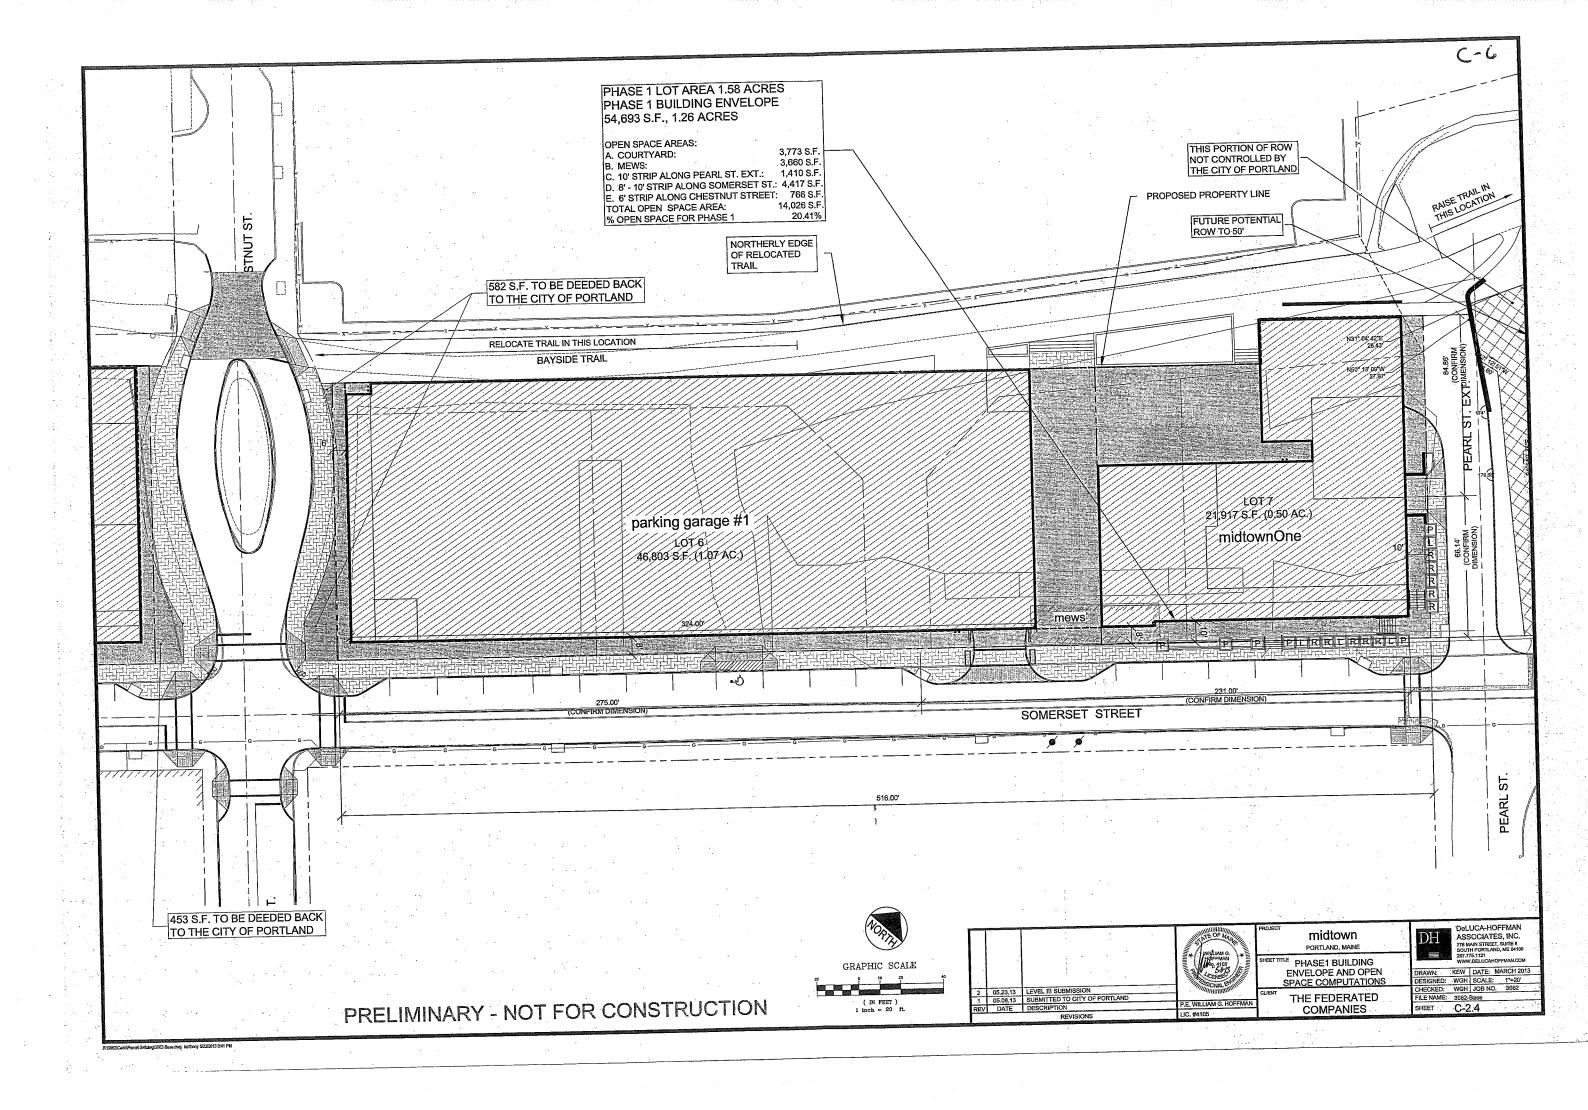


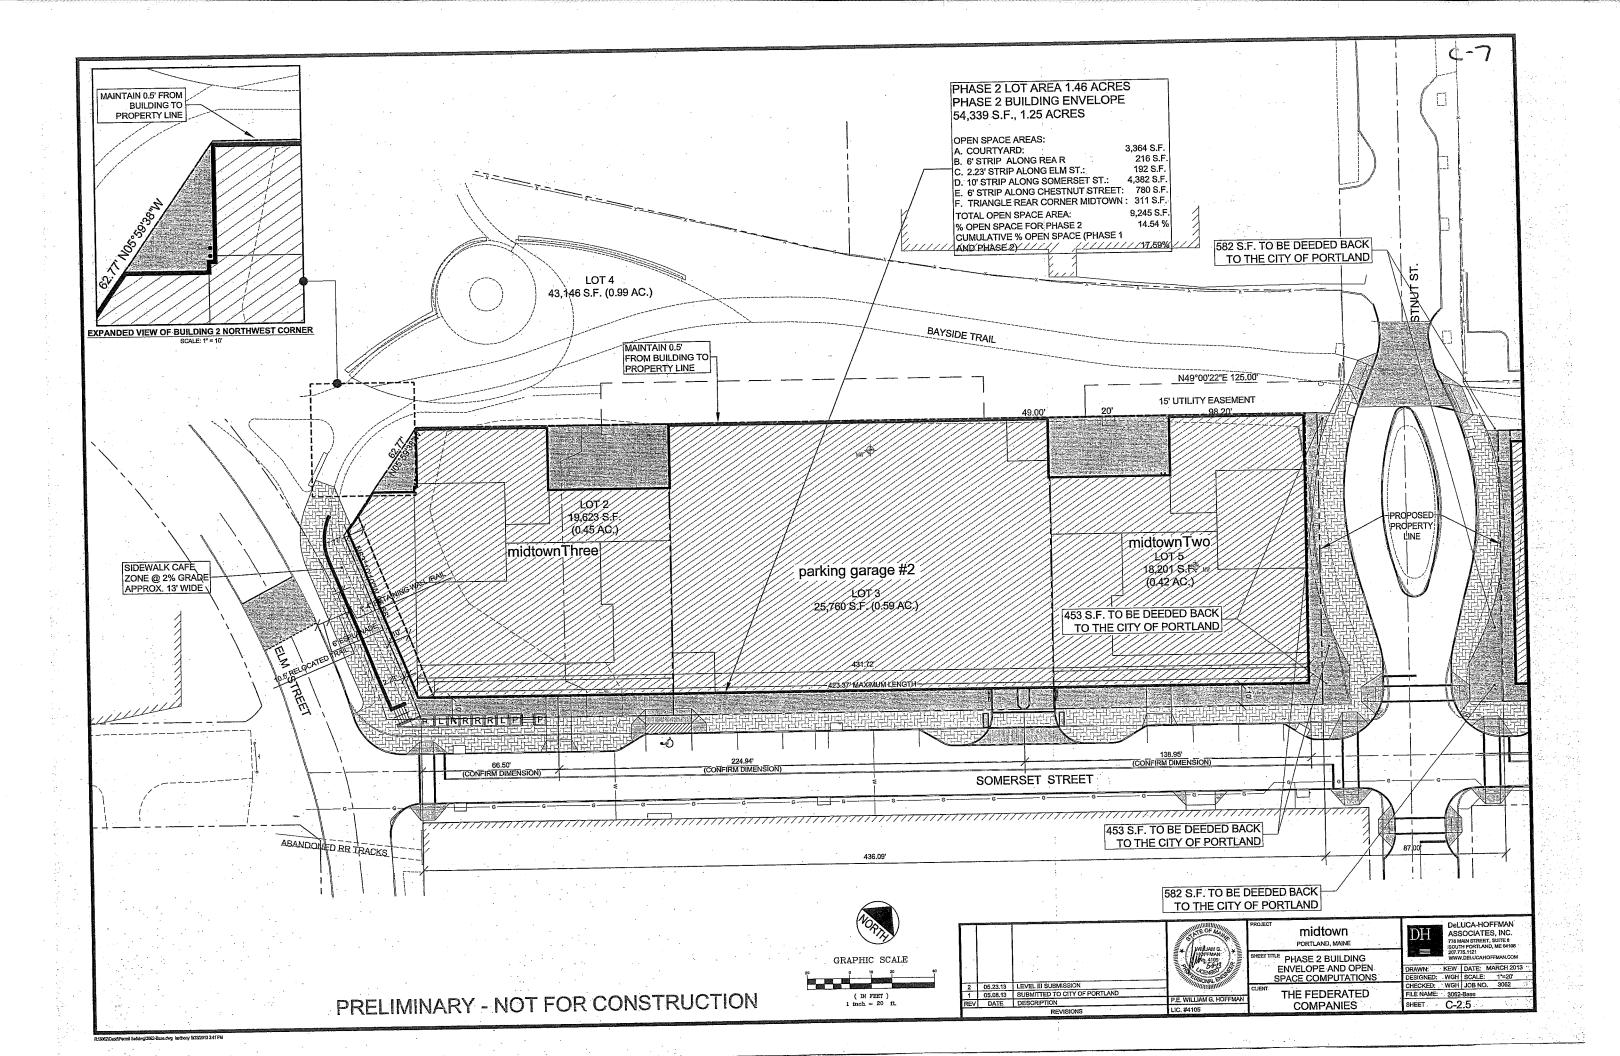


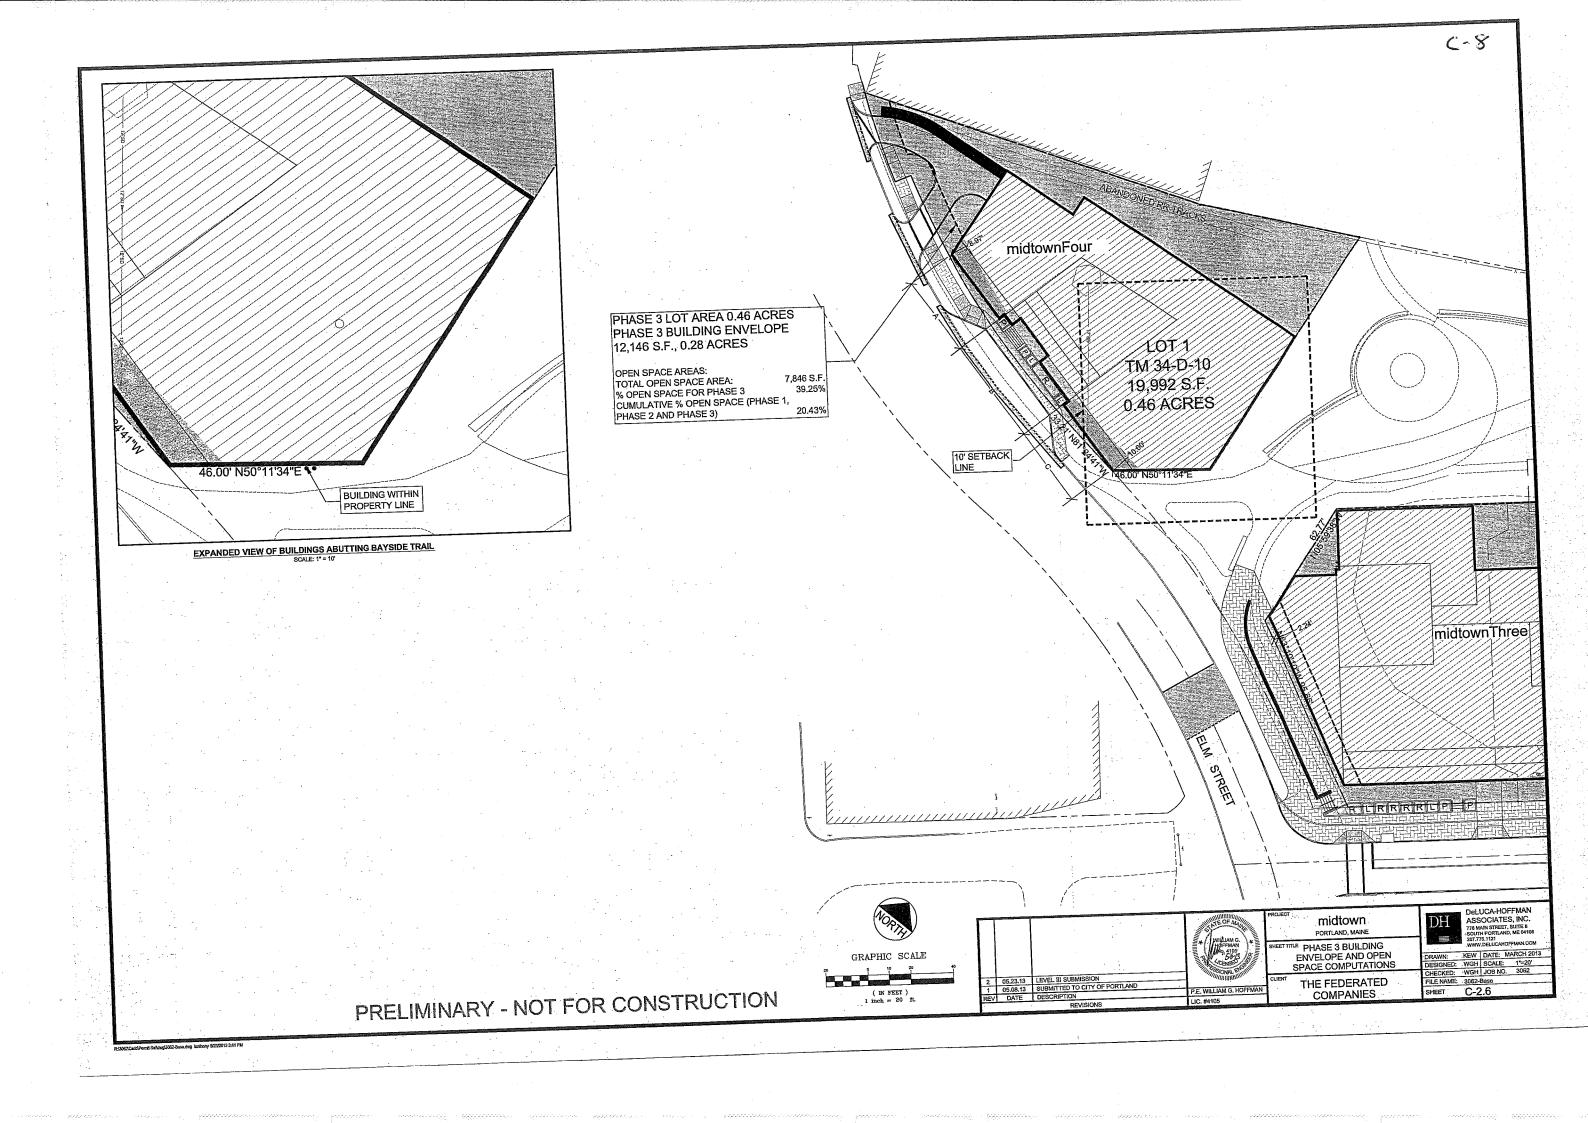


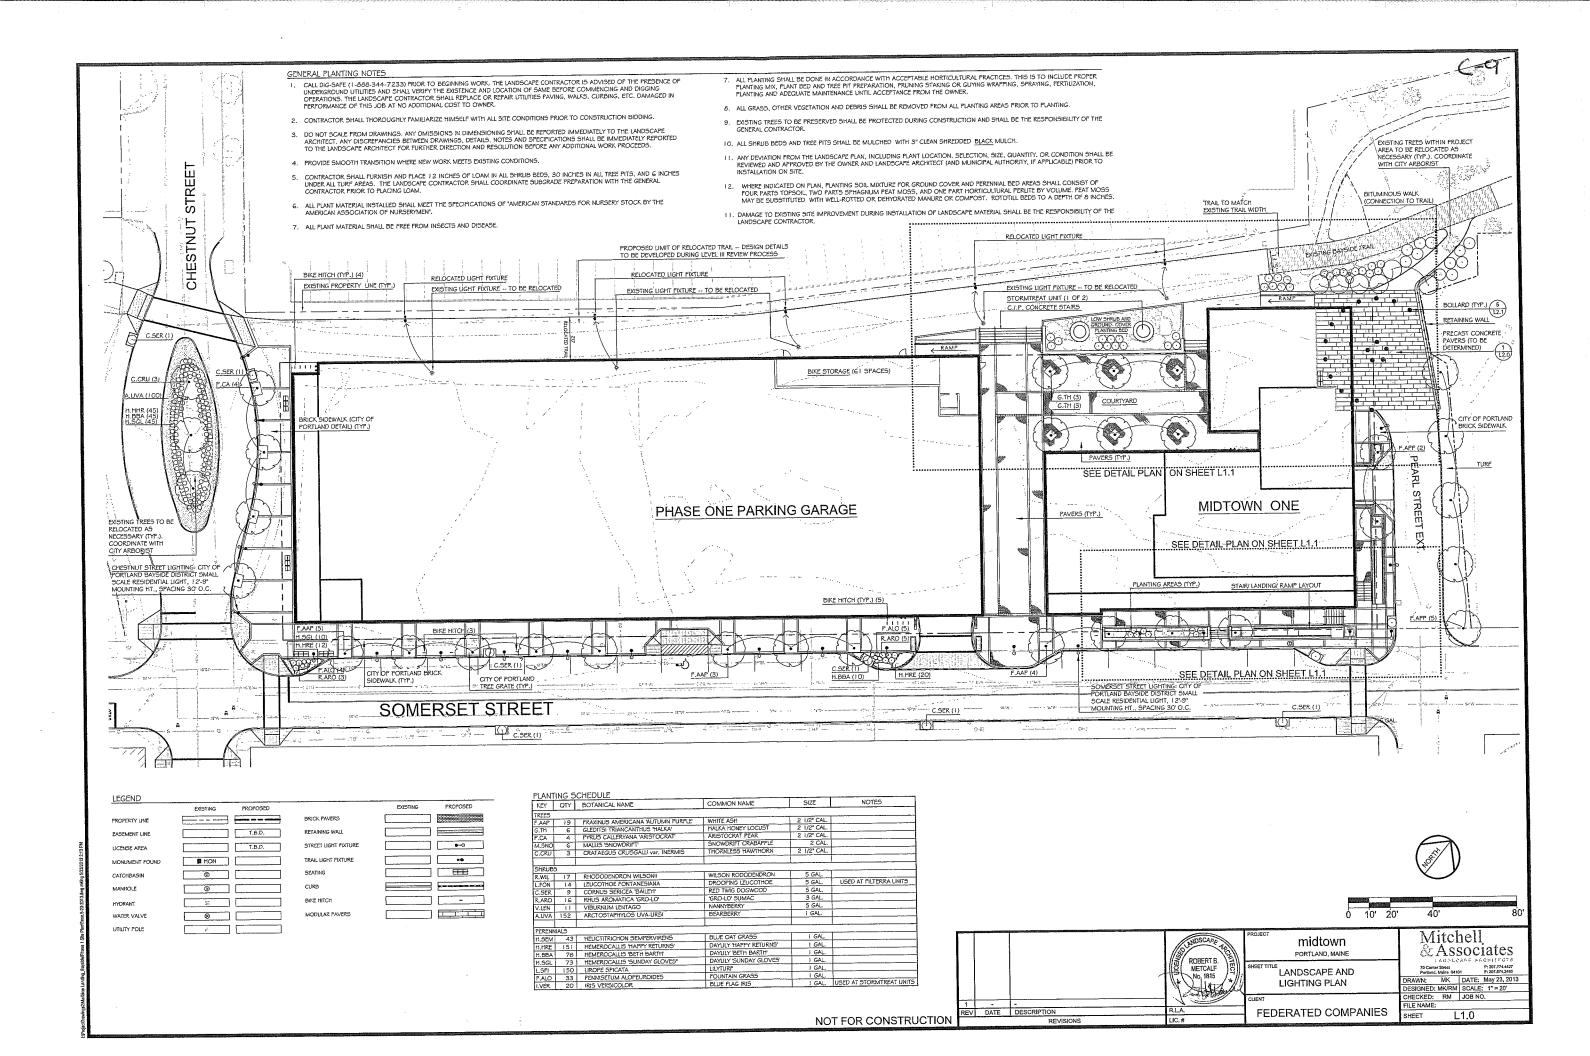


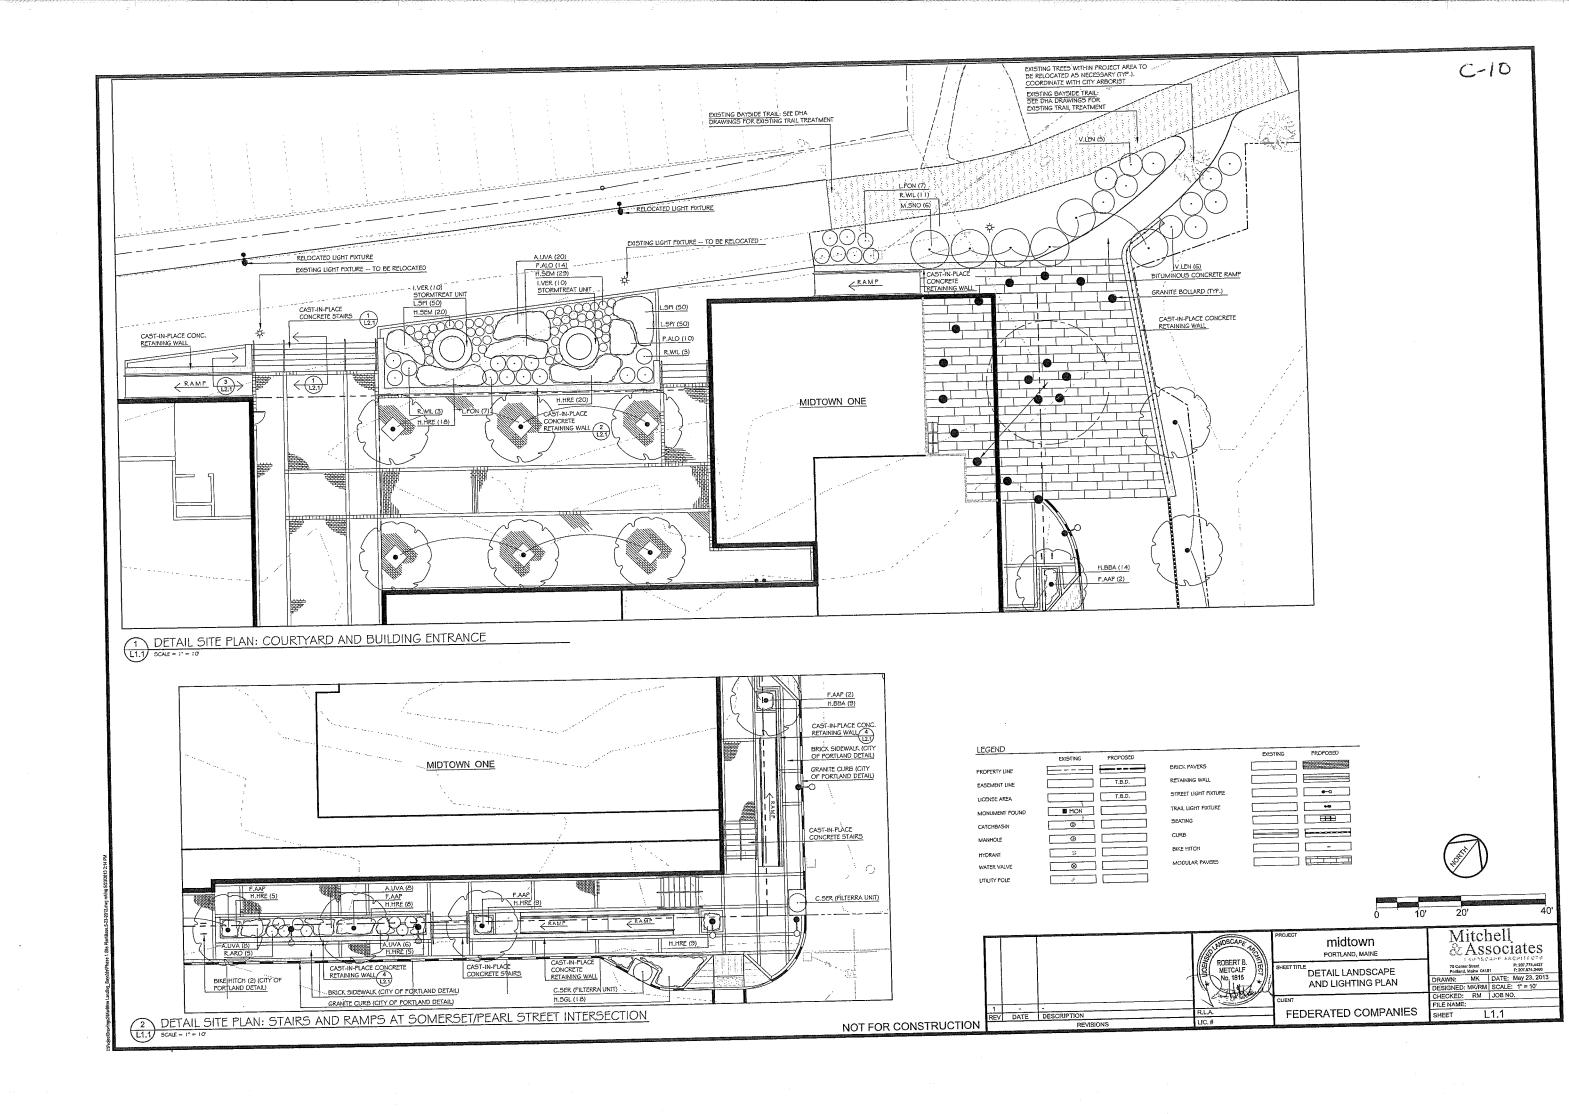

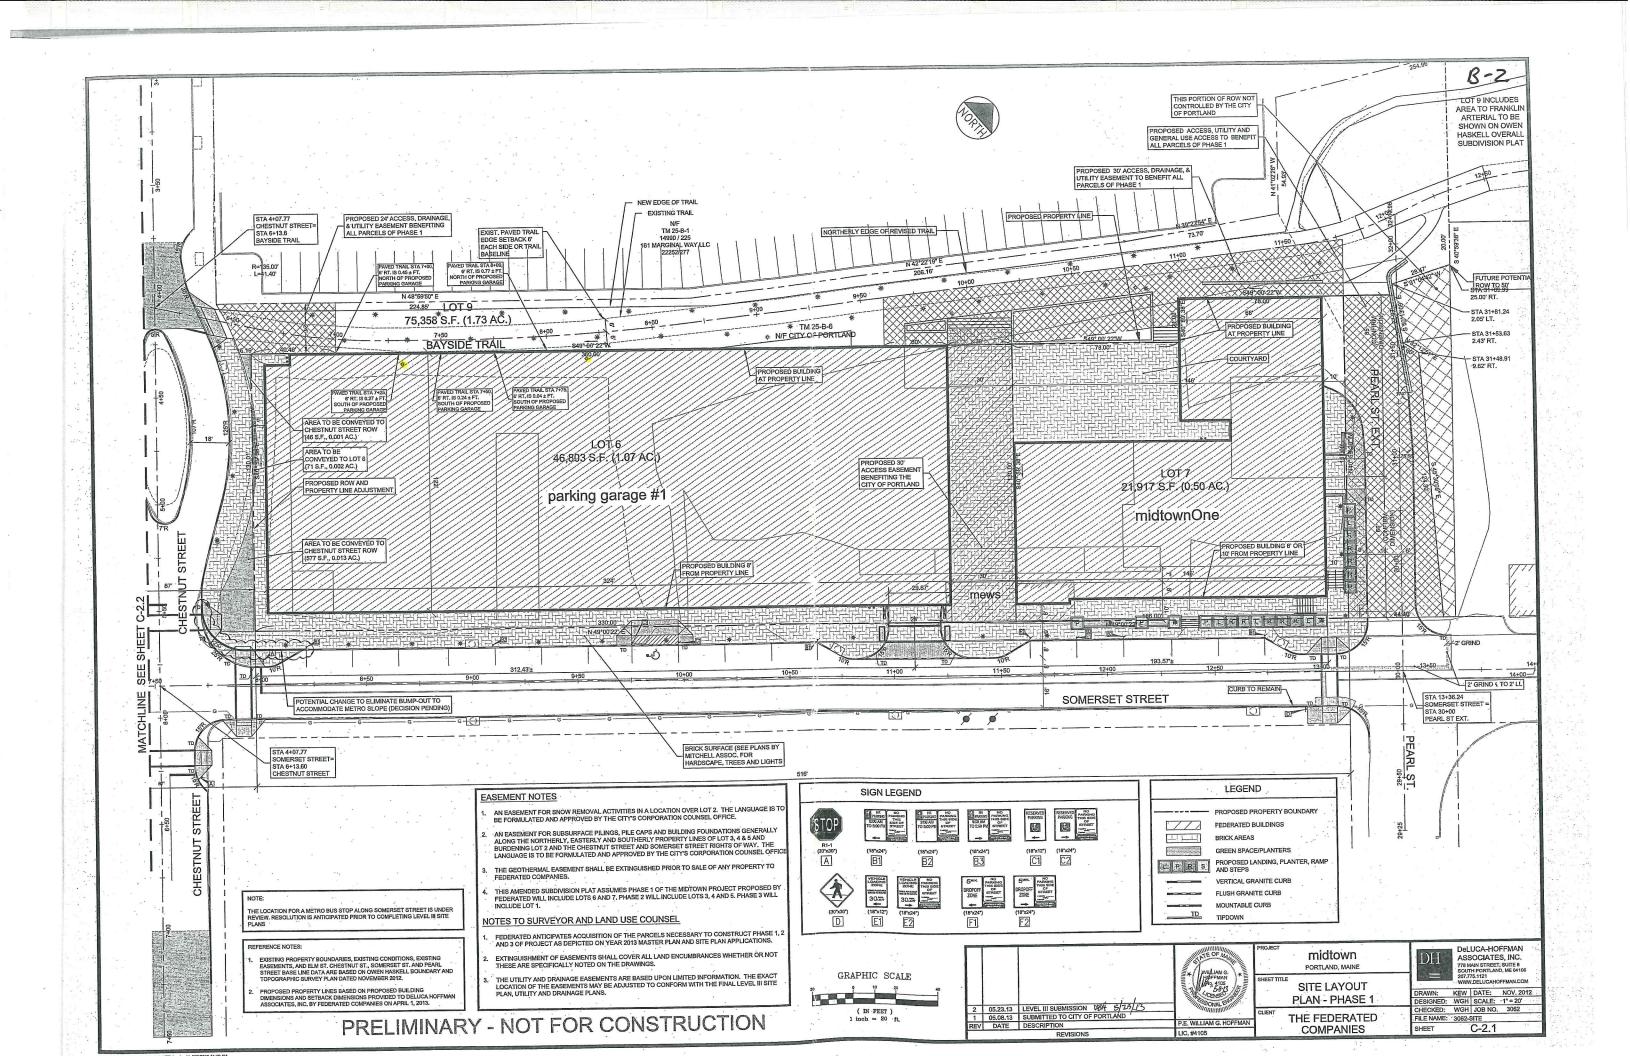

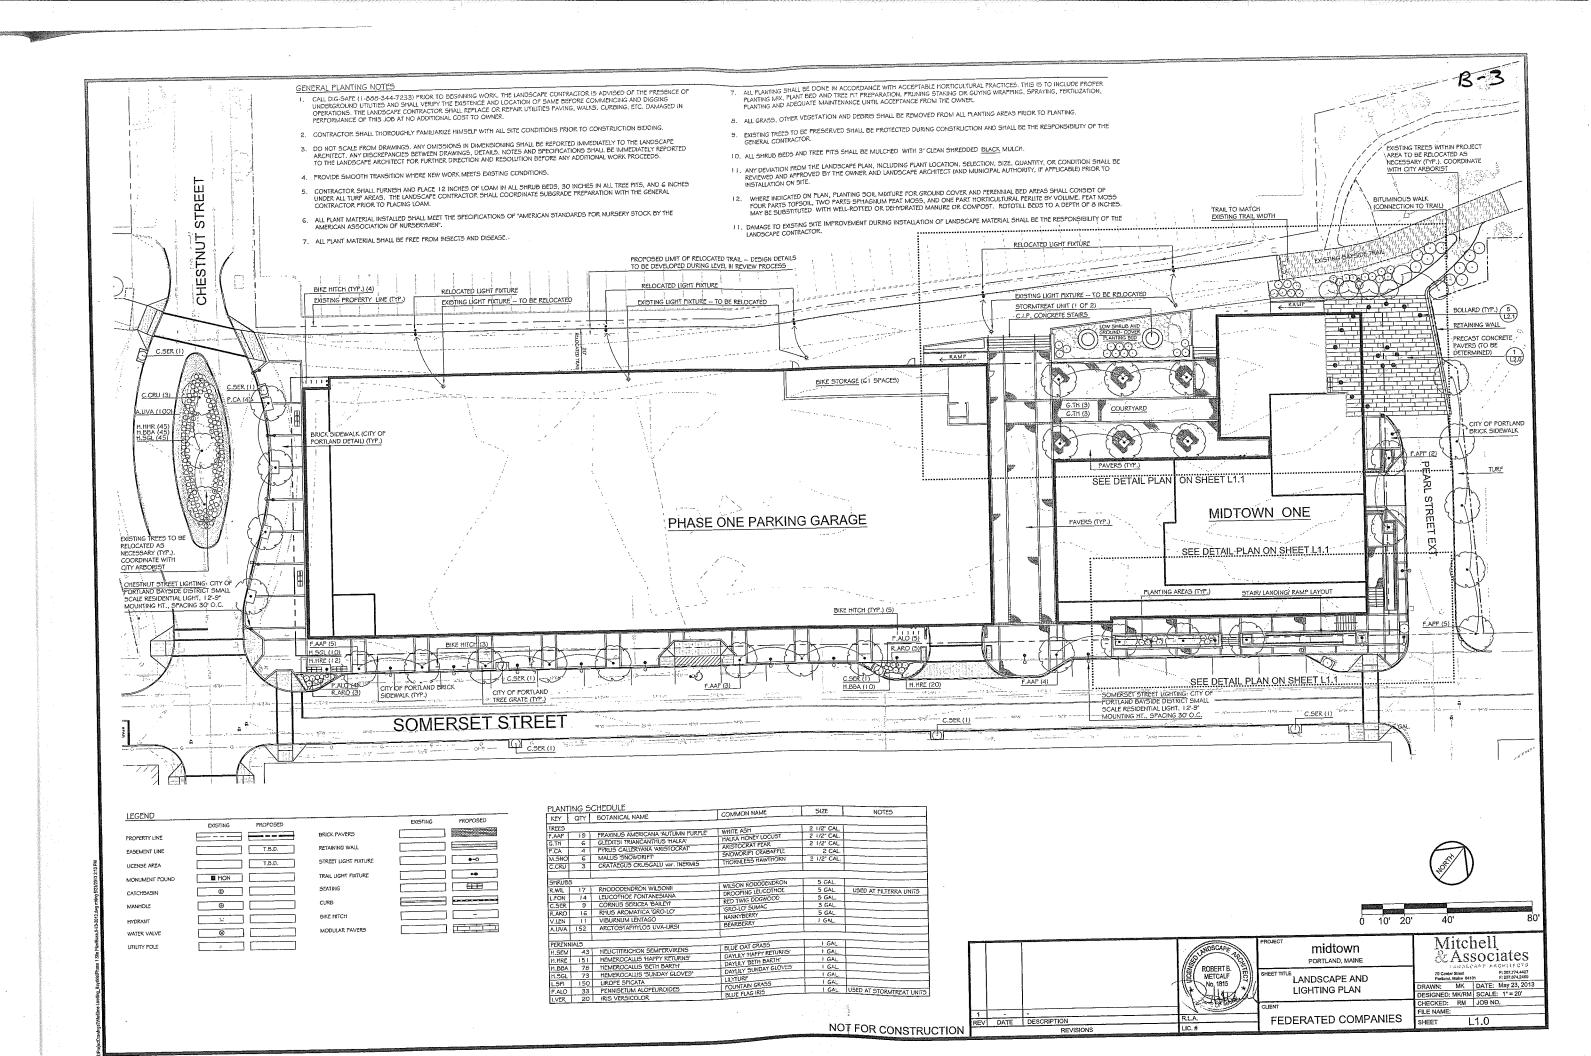

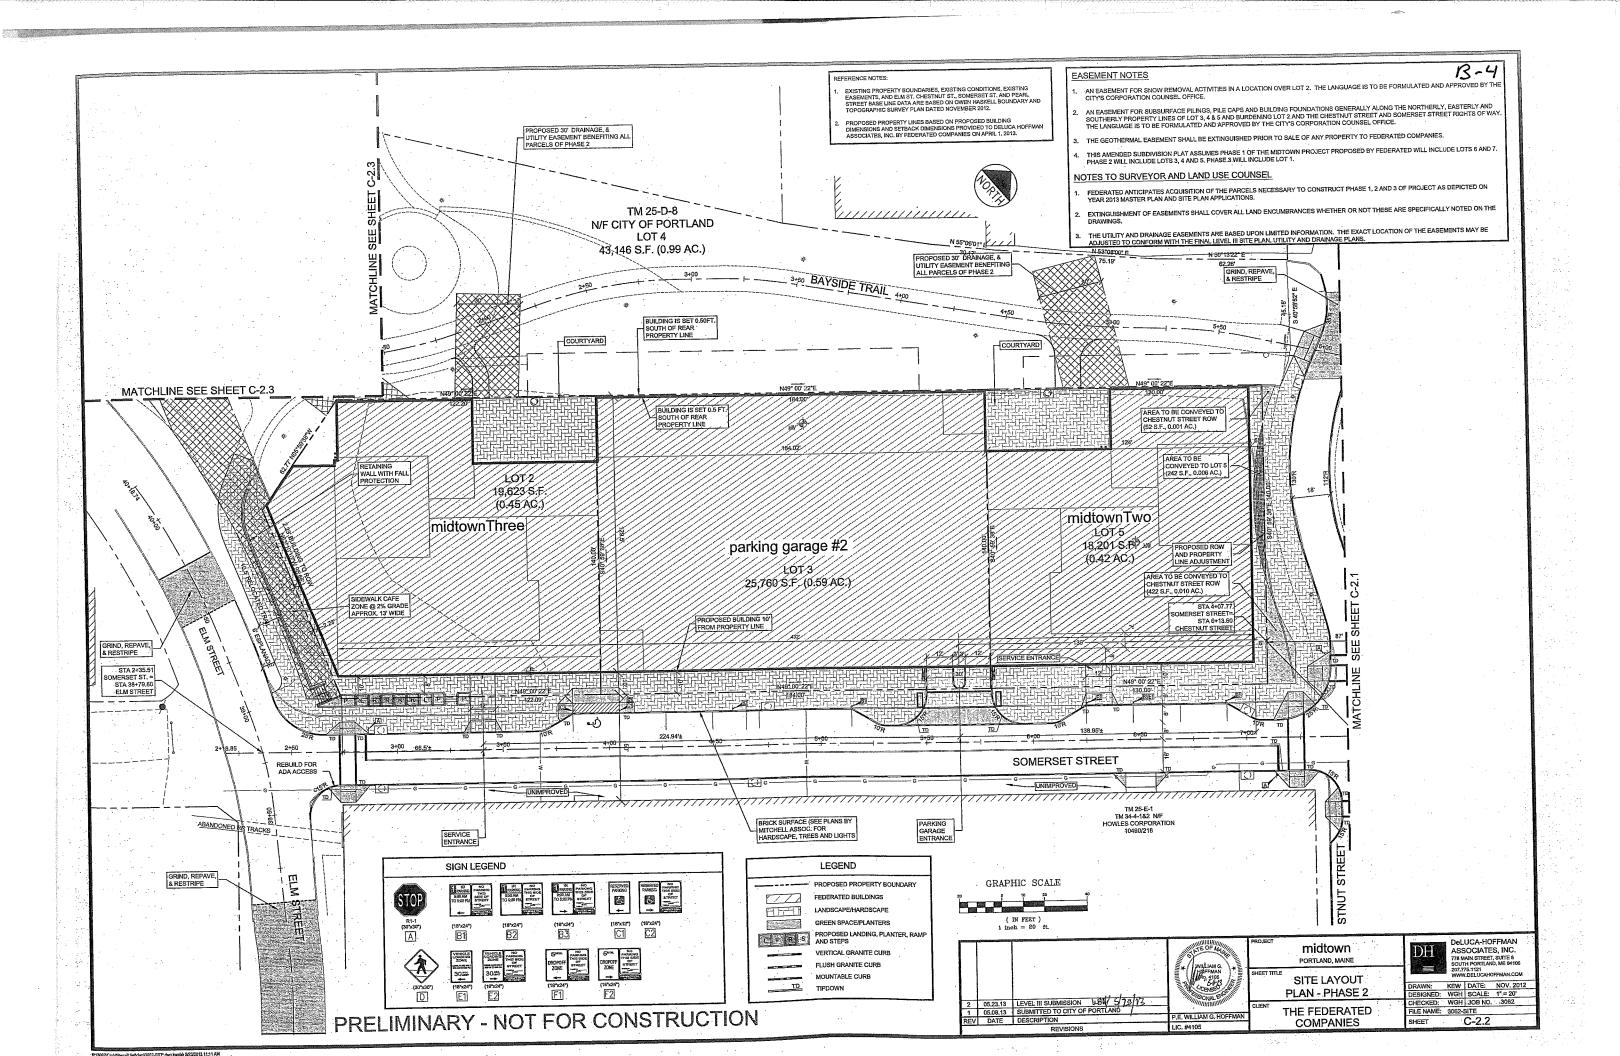

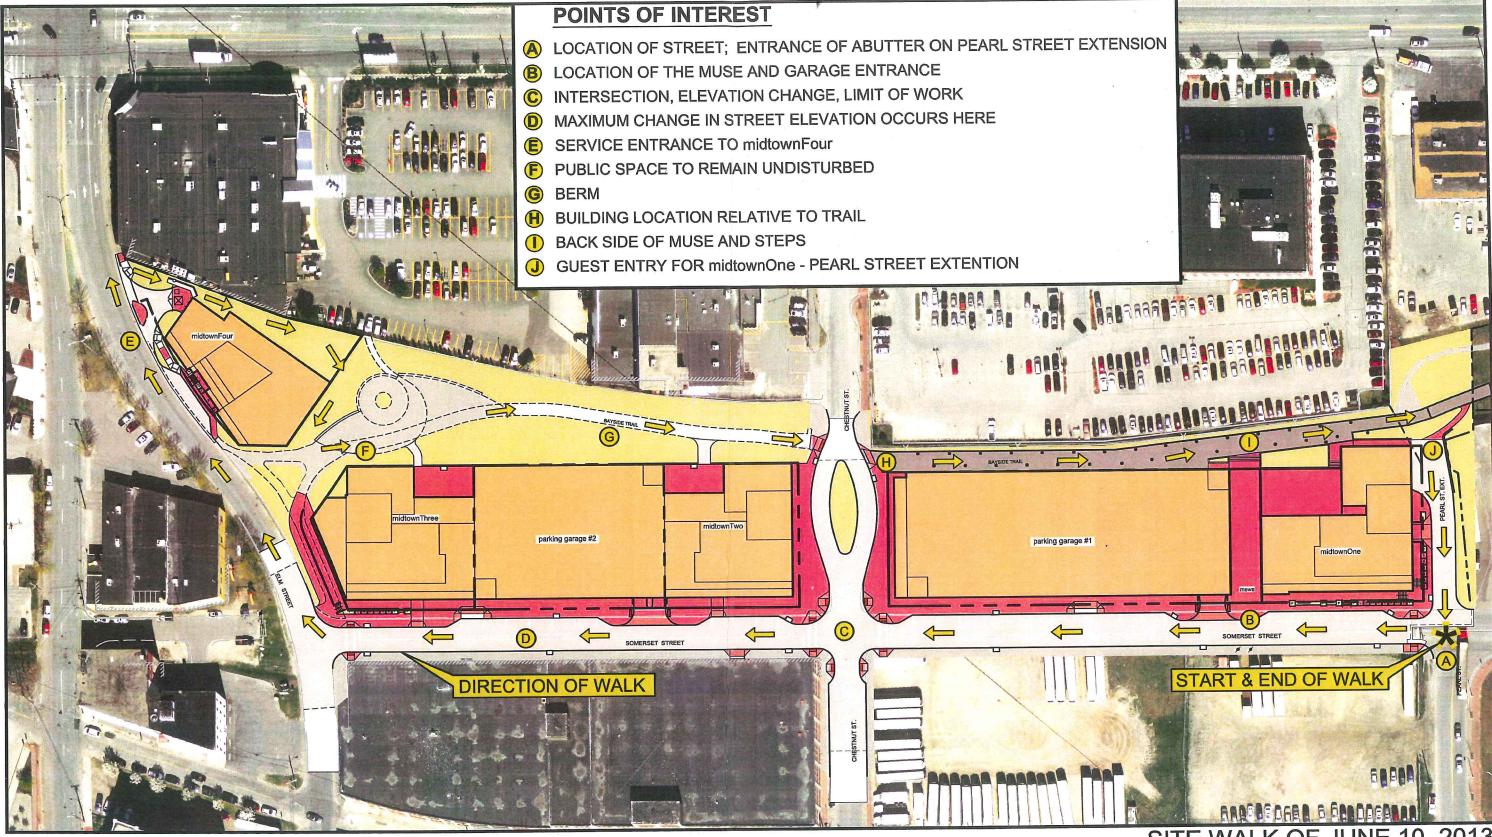


FST formerly DHAI



SITE WALK OF JUNE 10, 2013
APPLICANT: FEDERATED PROPERTIES

midtown

Portland, Maine

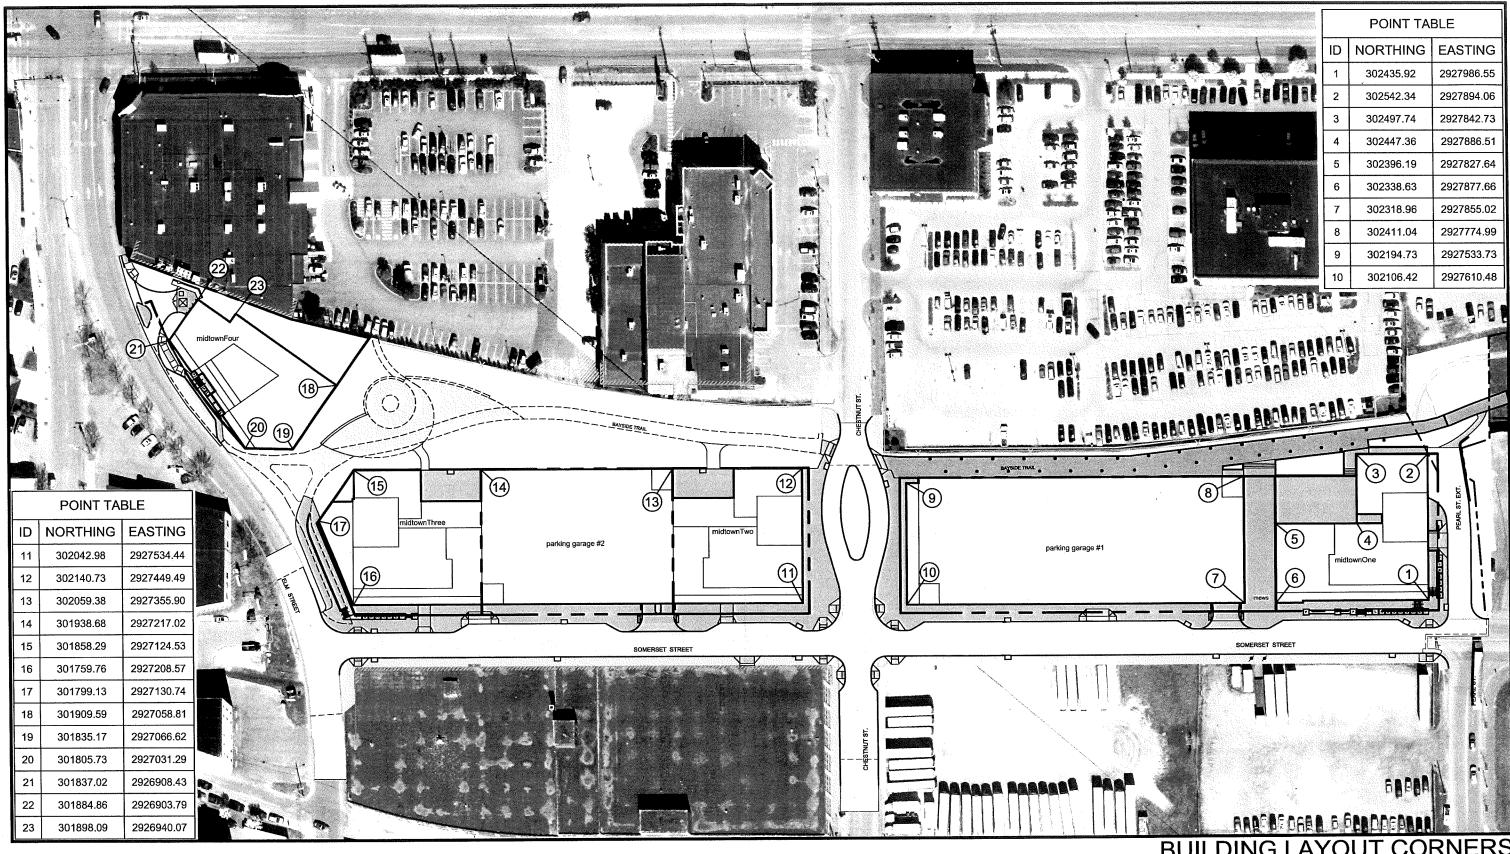

FST formerly DHAI

NOTE:


MANY BUILDING CORNERS ARE PROPERTY CORNERS. REFER TO STRUCTURAL DRAWINGS FOR EXACT LAYOUT OF **PILES** AND FOUNDATIONS



BUILDING LAYOUT CORNERS
APPLICANT: FEDERATED PROPERTIES
midtown

midtown
Portland, Maine

SITE UISIT 6-11-13

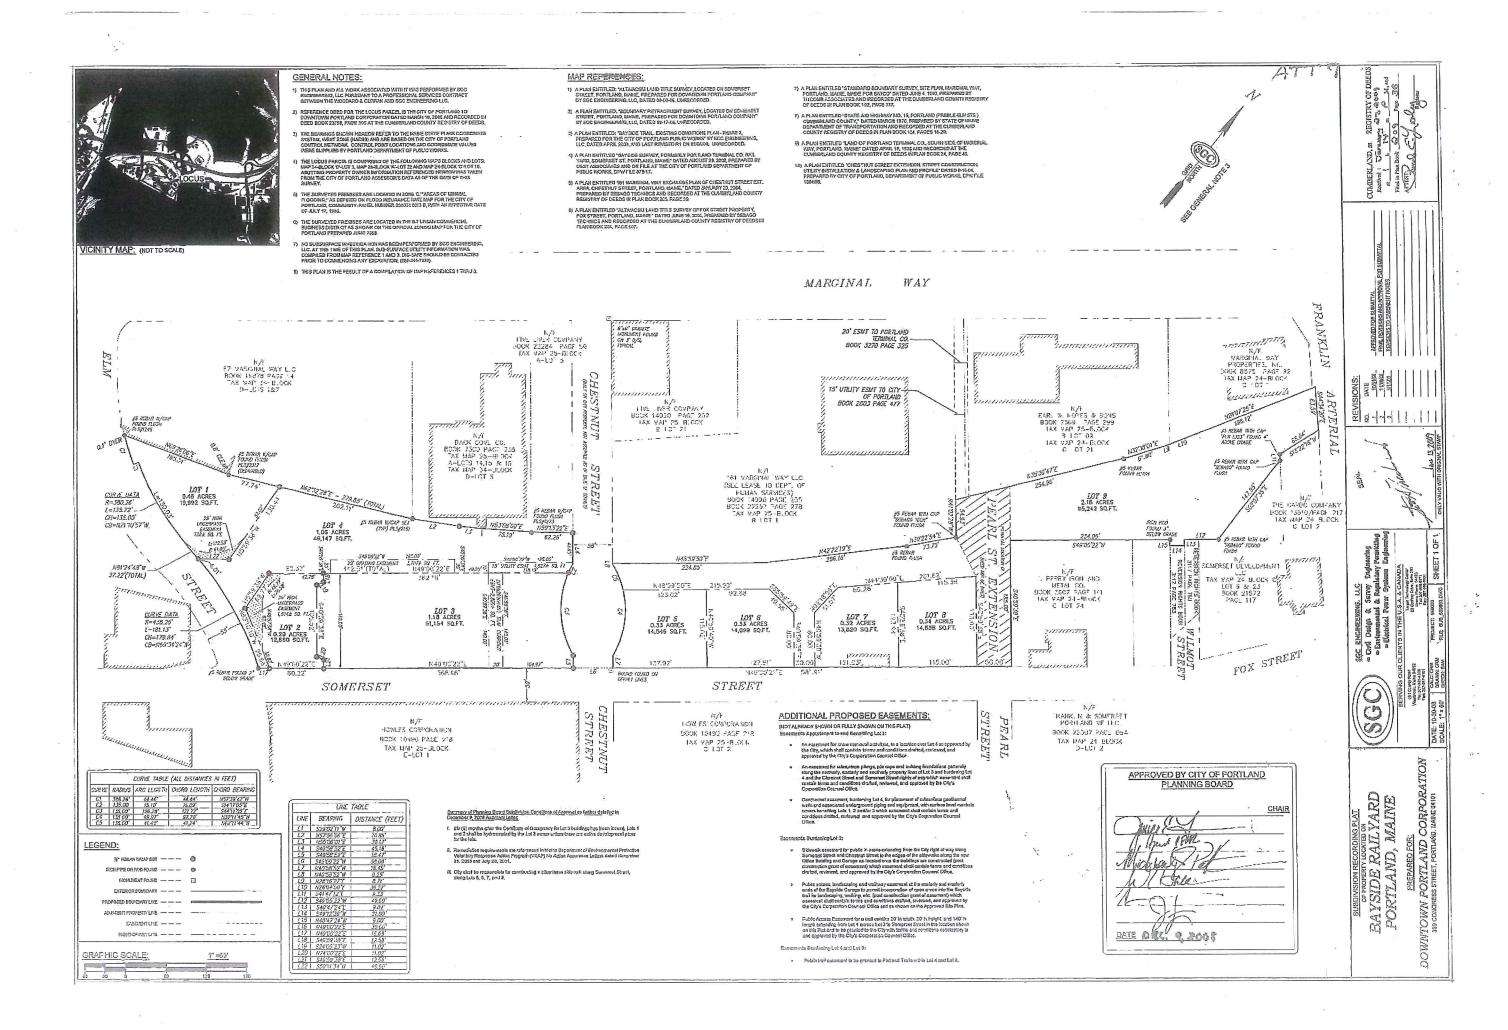




17 September 2013

Portland midtown preliminary design

- 1. aerial view 1
- 2. street elevations
- 3. aerial view 2
- 4. perspective view _ building a
- 5. building a ground floor plan
- 6. elevation at somerset street
- 7. elevation at pearl street
- 8. west elevation
- 9. elevation at bayside trail.
- 10. garage elevation at somerset street
- 11. garage elevation at bayside trail
- 12. garage elevation at chestnut street
- 13. phase two development concept
- 14. phase three development concept
- 15. signage concept
- 16. winds
- 17. rainfall
- 18. snow





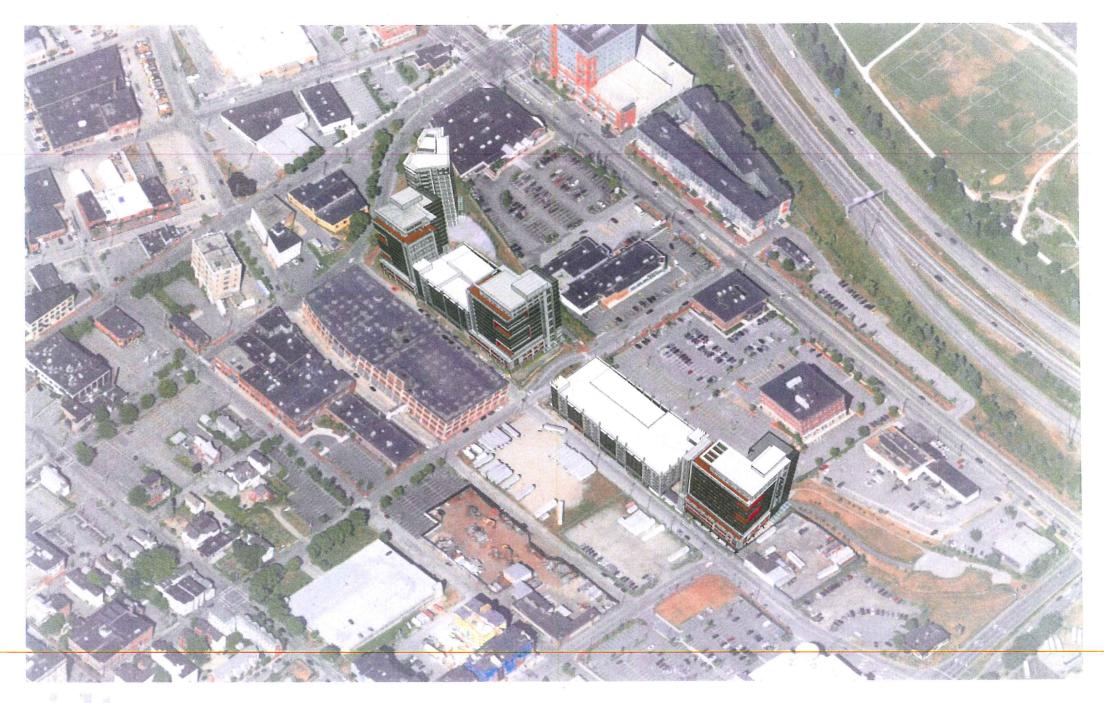


Portland, ME

aerial view 1

cbt





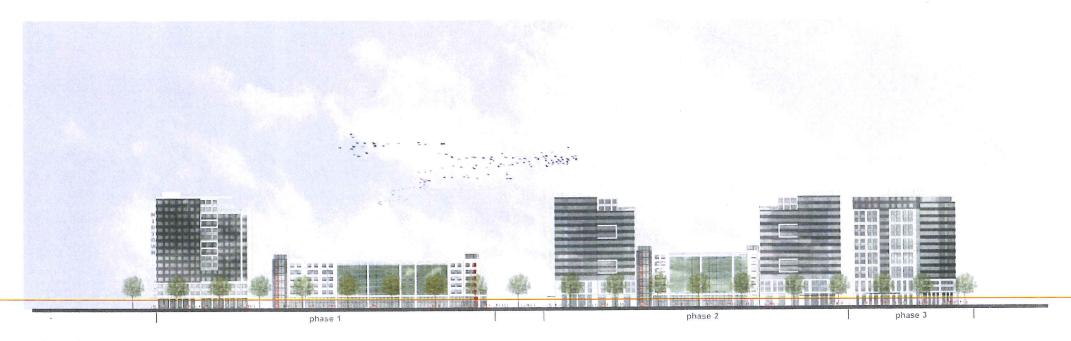

midtown

street elevations

THE FEDERATED COMPANIES

cbt



aerial view 2








own

perspective view



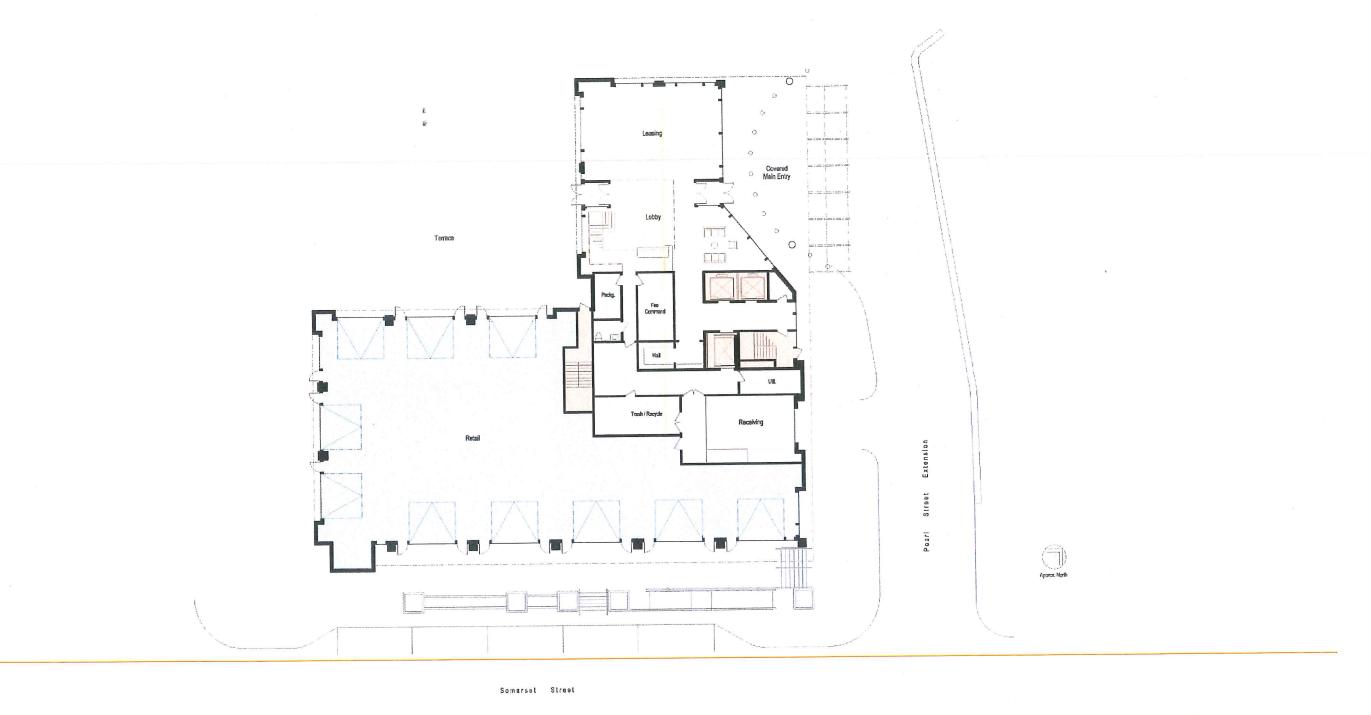

ground floor plan

Portland, ME

cbt





Portland, ME

elevation at somerset street





Portland, ME

elevation at pearl street





west elevation













garage elevation at somerset street





midtown

garage elevation at bayside trail





garage elevation at chestnut street

Portland, ME







elevation at bayside trail







phase two development concept



cbt





elevation at bayside trail



elevation at somerset street



phase three development concept






signage concept




cbt

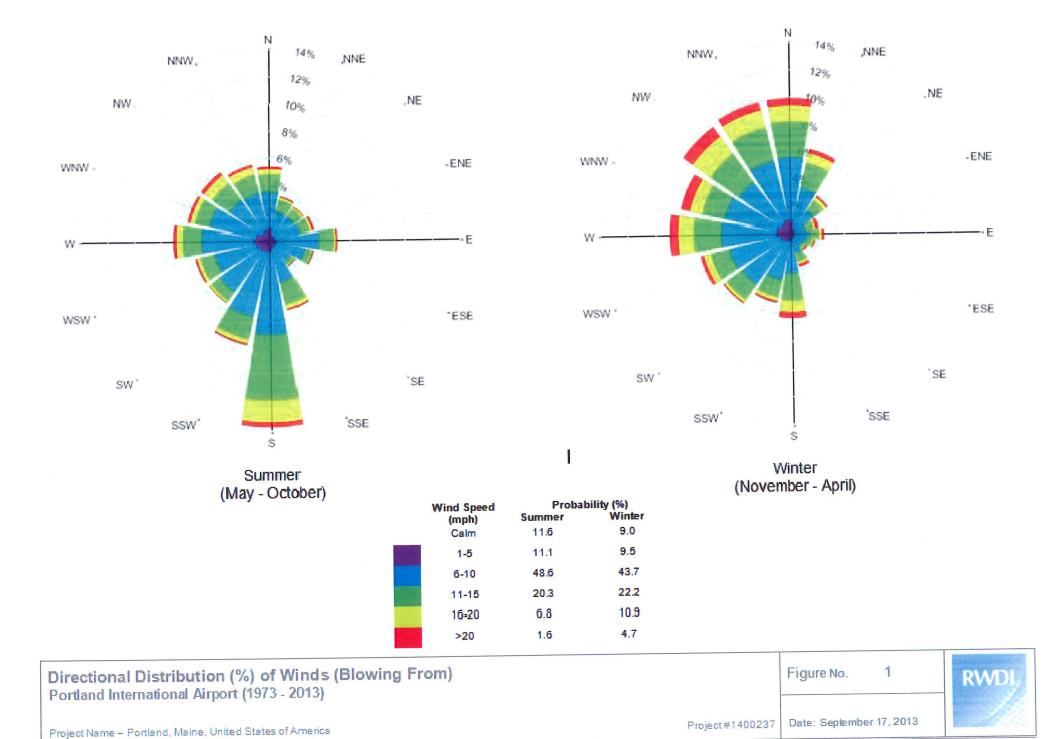


midtown

summer and winter winds

THE FEDERATED COMPANIES

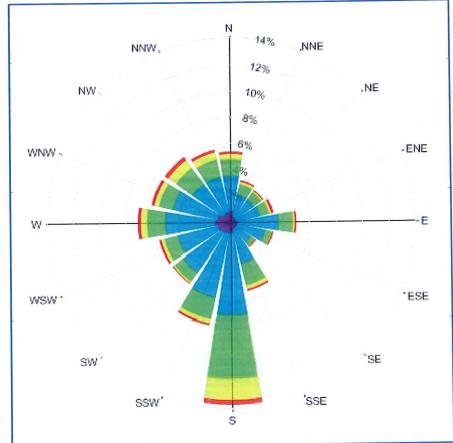


Summer Winds

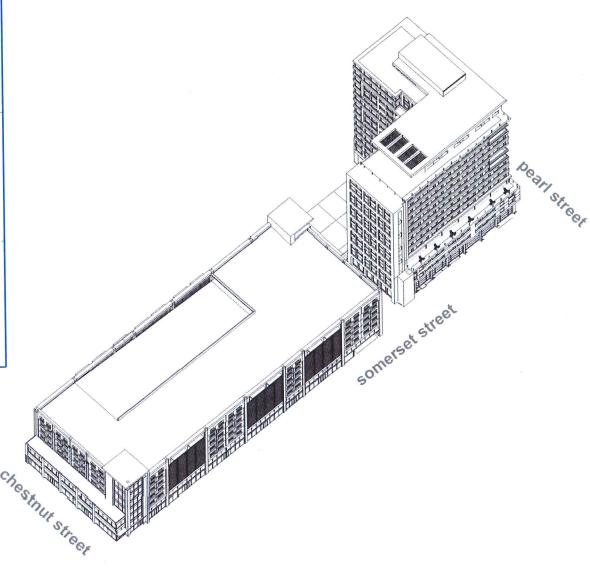






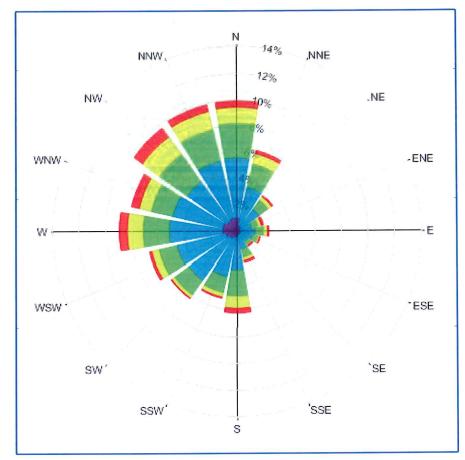


Winter Winds

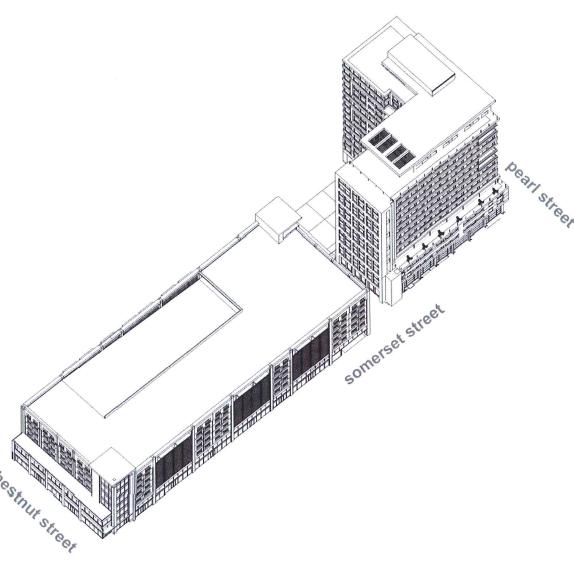







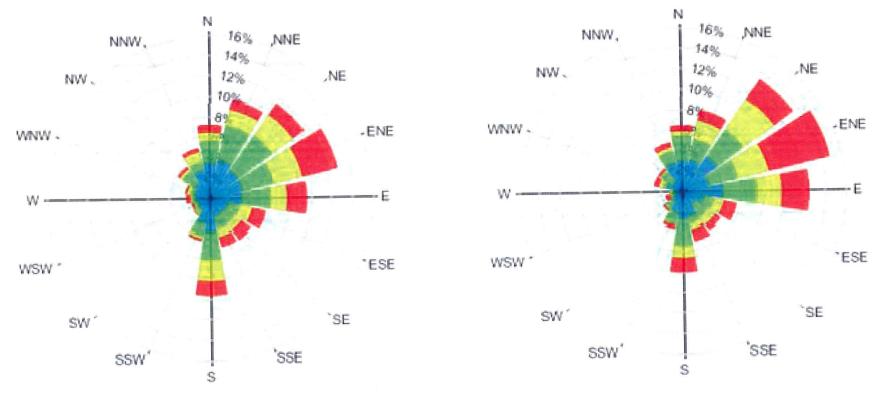

Winds During Moderate Rainfall

Winds During Heavy Rainfall

% Of Overall: 5.1% Calm

Percentage of Rain over All Winds: 9.6%

		Overall Probability (%)			
	Wind Speed (mph)	All Rains	Light Rains	Moderate Rains	Heavy Rains
	1-5	7.14%	6.53%	0.45%	0.16%
	6-10	44.73%	39.59%	3.97%	1.16%
	11-15	25.12%	21.23%	3.01%	0.88%
	16-20	11.92%	9.27%	2.02%	0.63%
100000	>20	6.04%	3.78%	1.59%	9.67%

Directional Distribution (%) of Winds (Blowing From)
Portland International Airport (1973 - 2013)

Project#1400237 2013

Project Name - Portland, Maine, United States of America

Date: September 17,


Figure No.




midtown

driven rain

THE FEDERATED COMPANIES

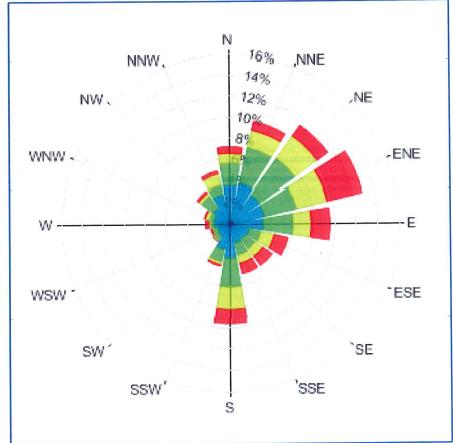


Winds during Moderate Rainfall

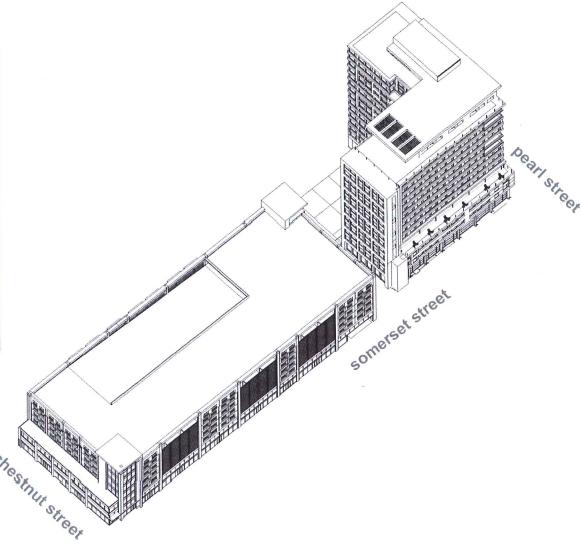






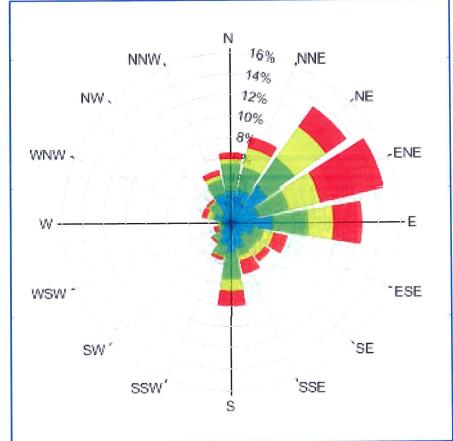


Winds during Heavy Rainfall

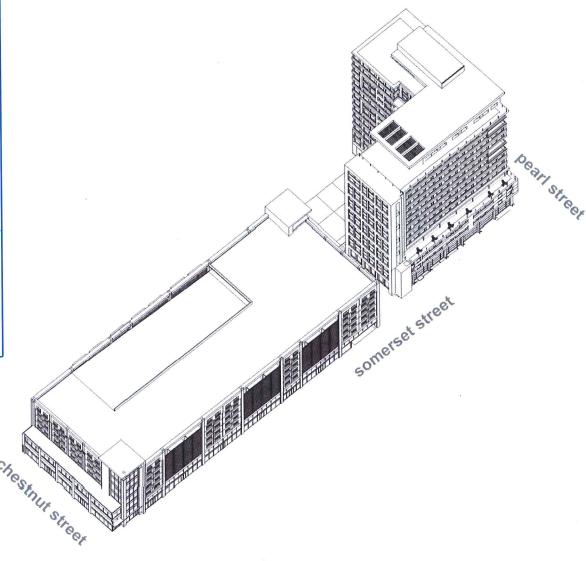





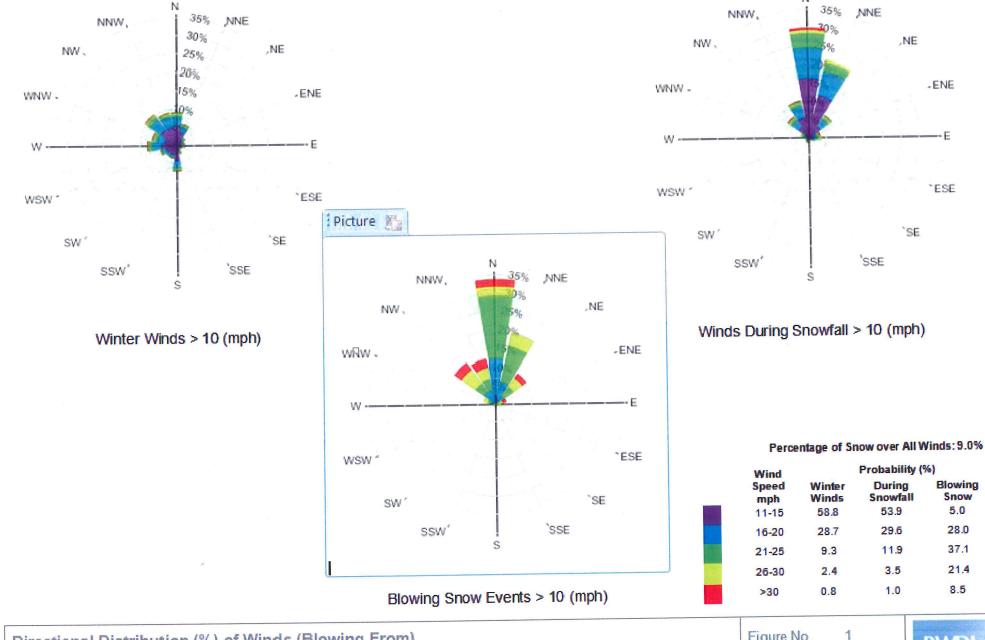

Directional Distribution (%) of Winds (Blowing From)

Portland International Airport (1973 - 2013)

November - April

Project Name - Portland, Maine, United States of America

Figure No. 1


RWDI

Project #1400237


Date: September 17, 2013





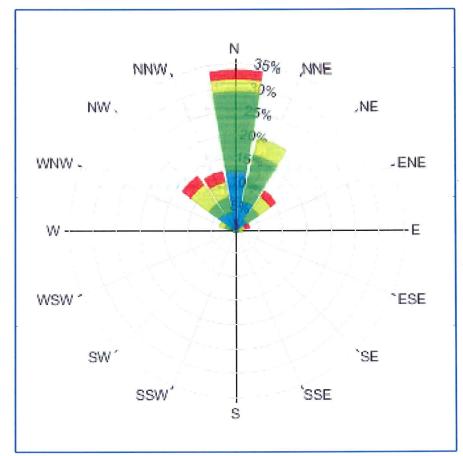


Blowing Snow Events

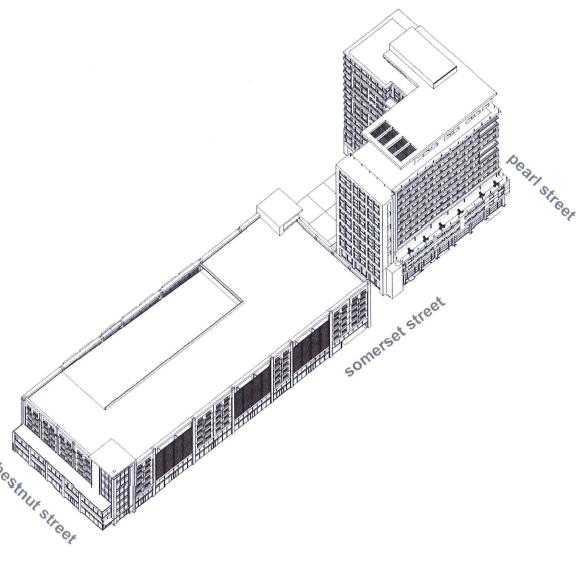






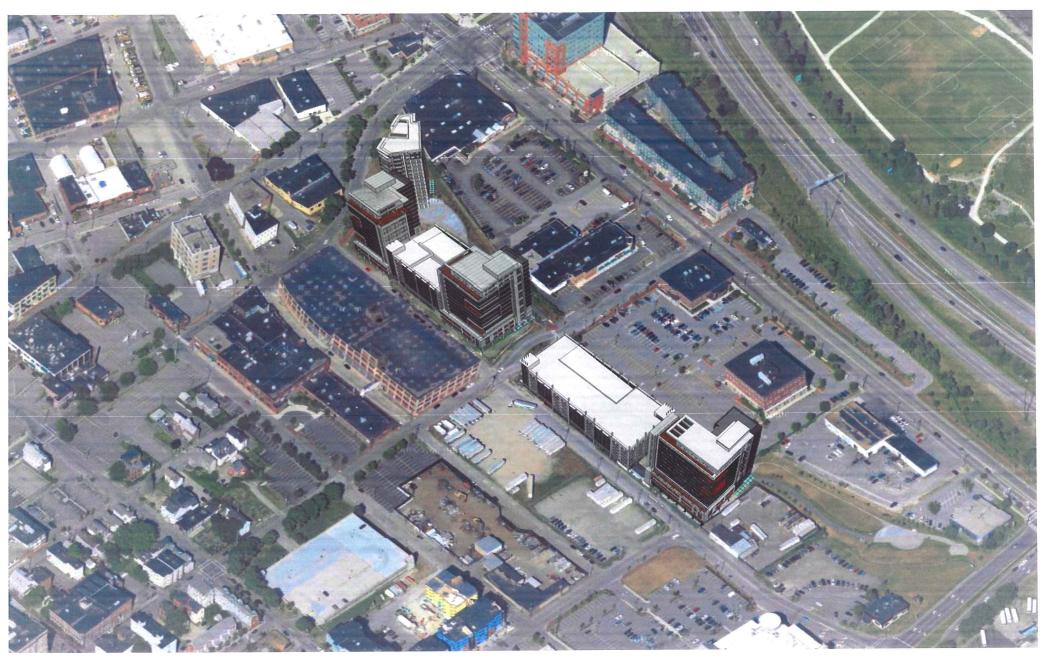


midtown
Portland, ME

aerial view 1



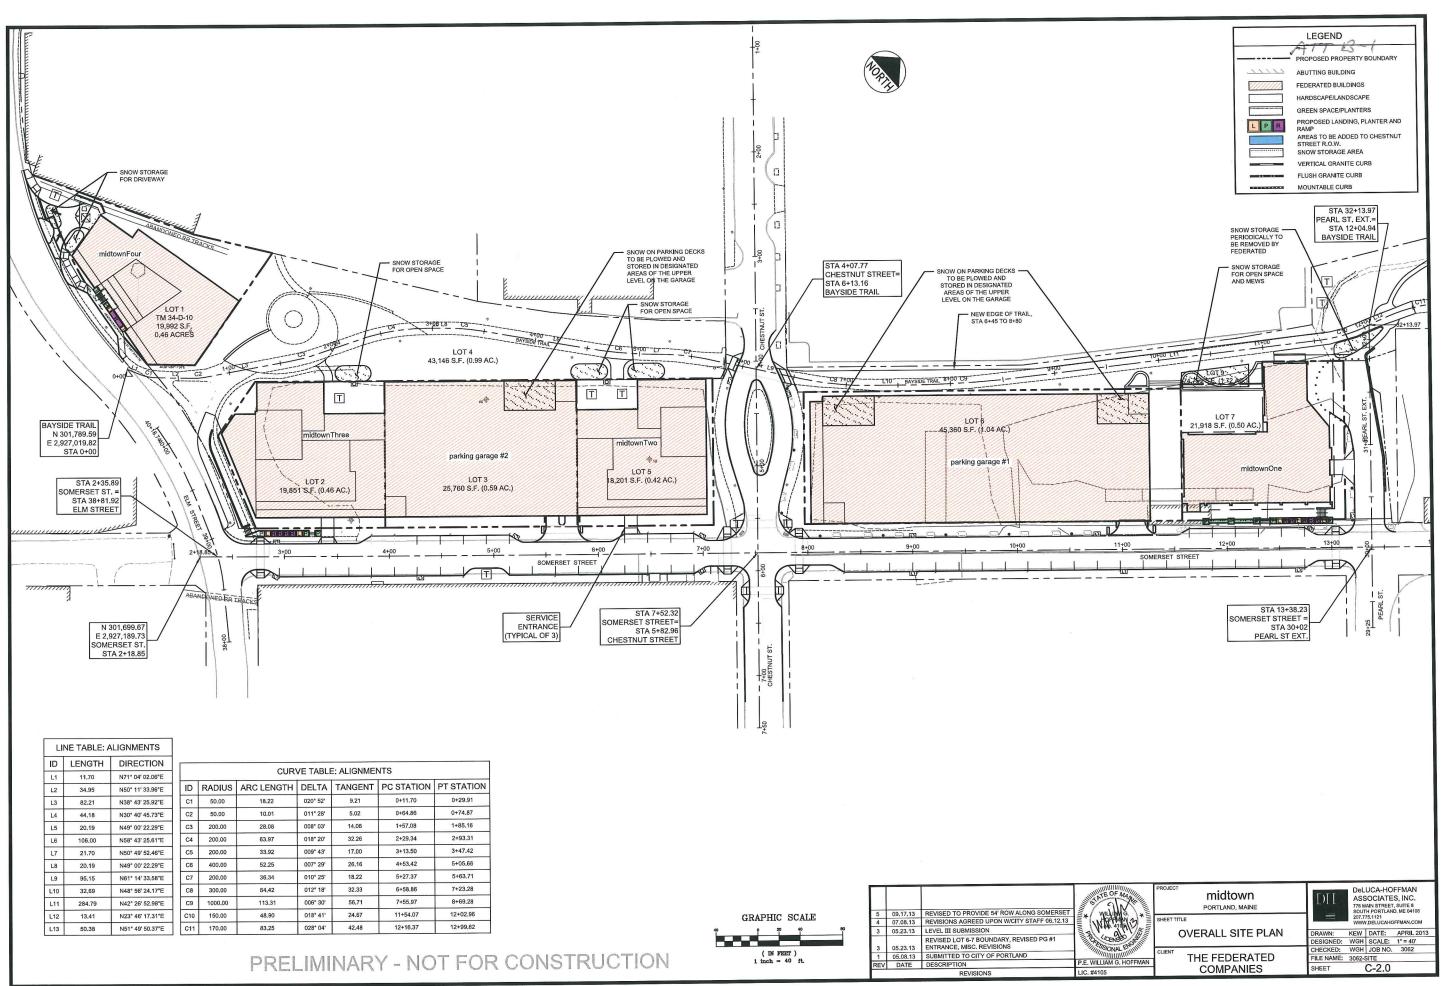

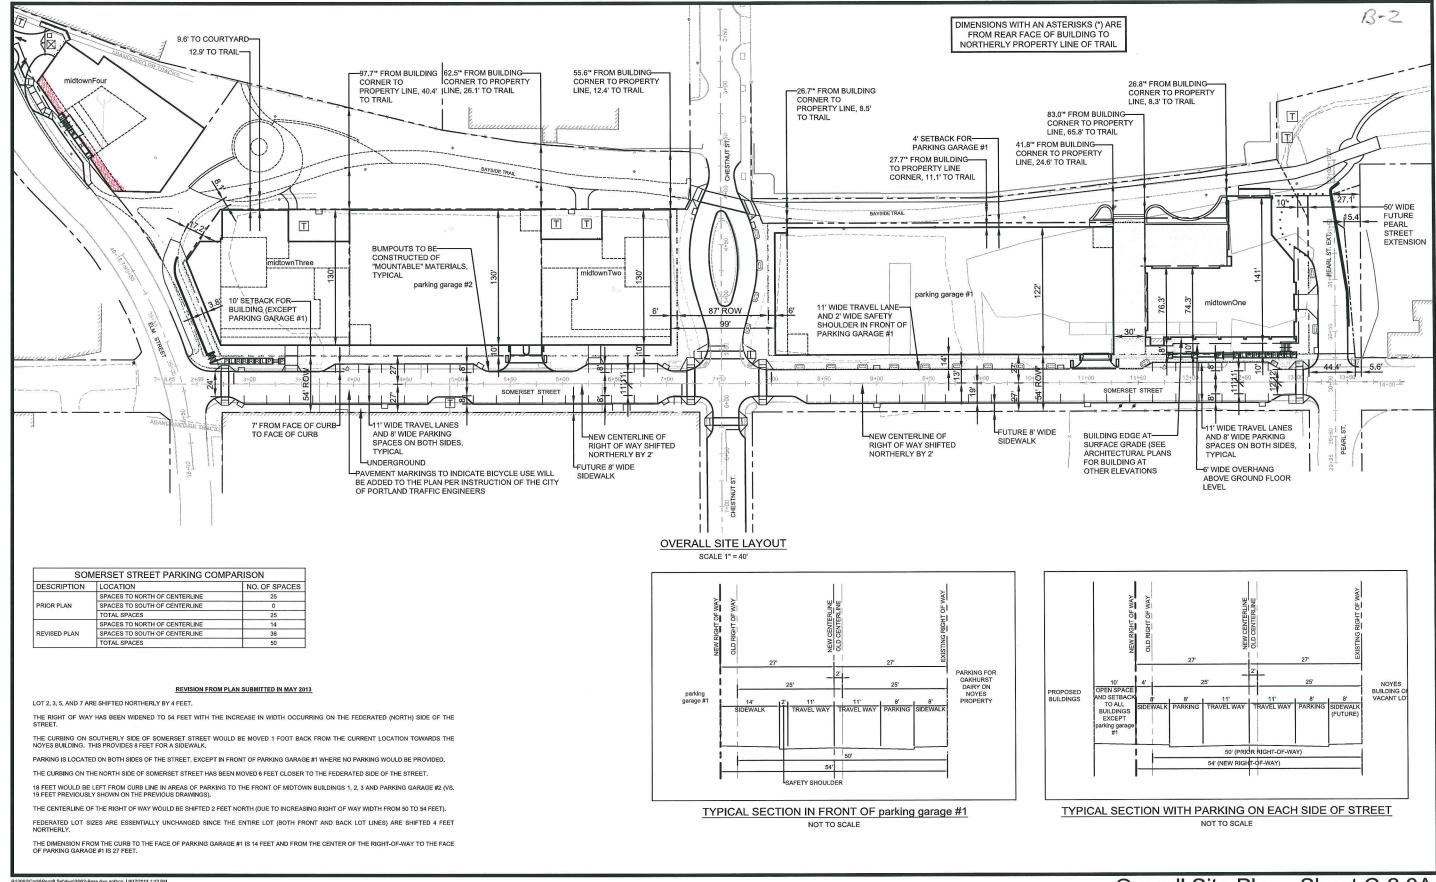


FST, INC. formerly DHAI







Overall Site Plan - Sheet C-2.0A Federated's midtown

Portland, Maine SEPTEMBER 17, 2013

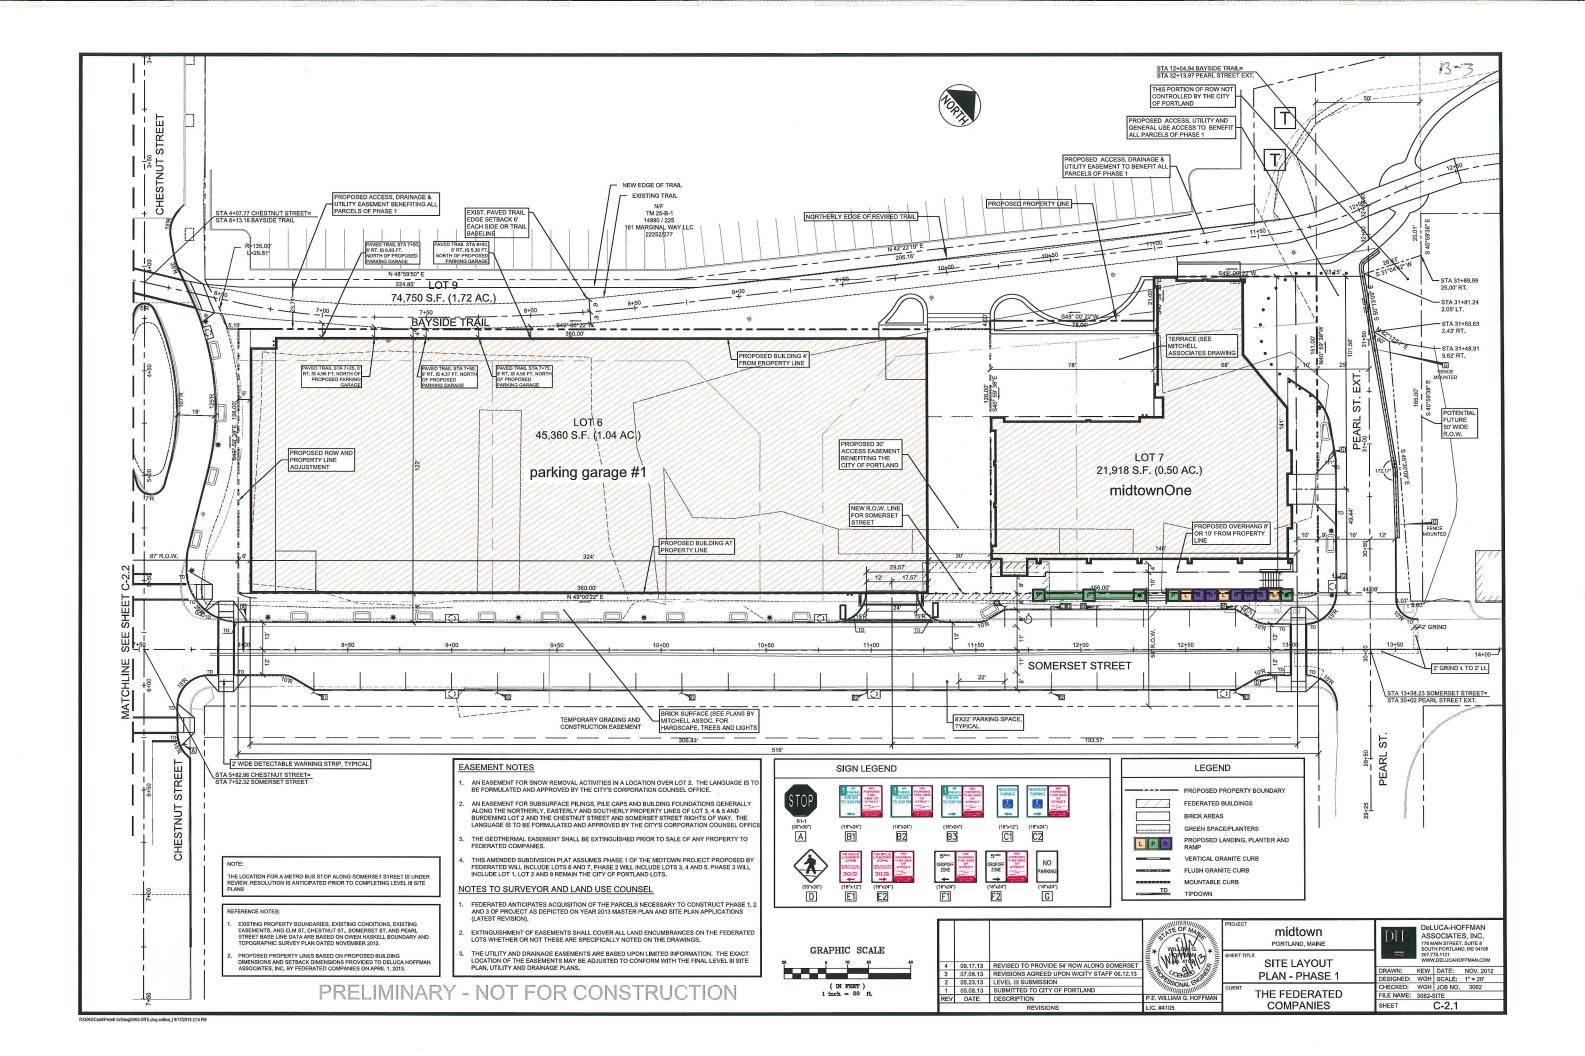

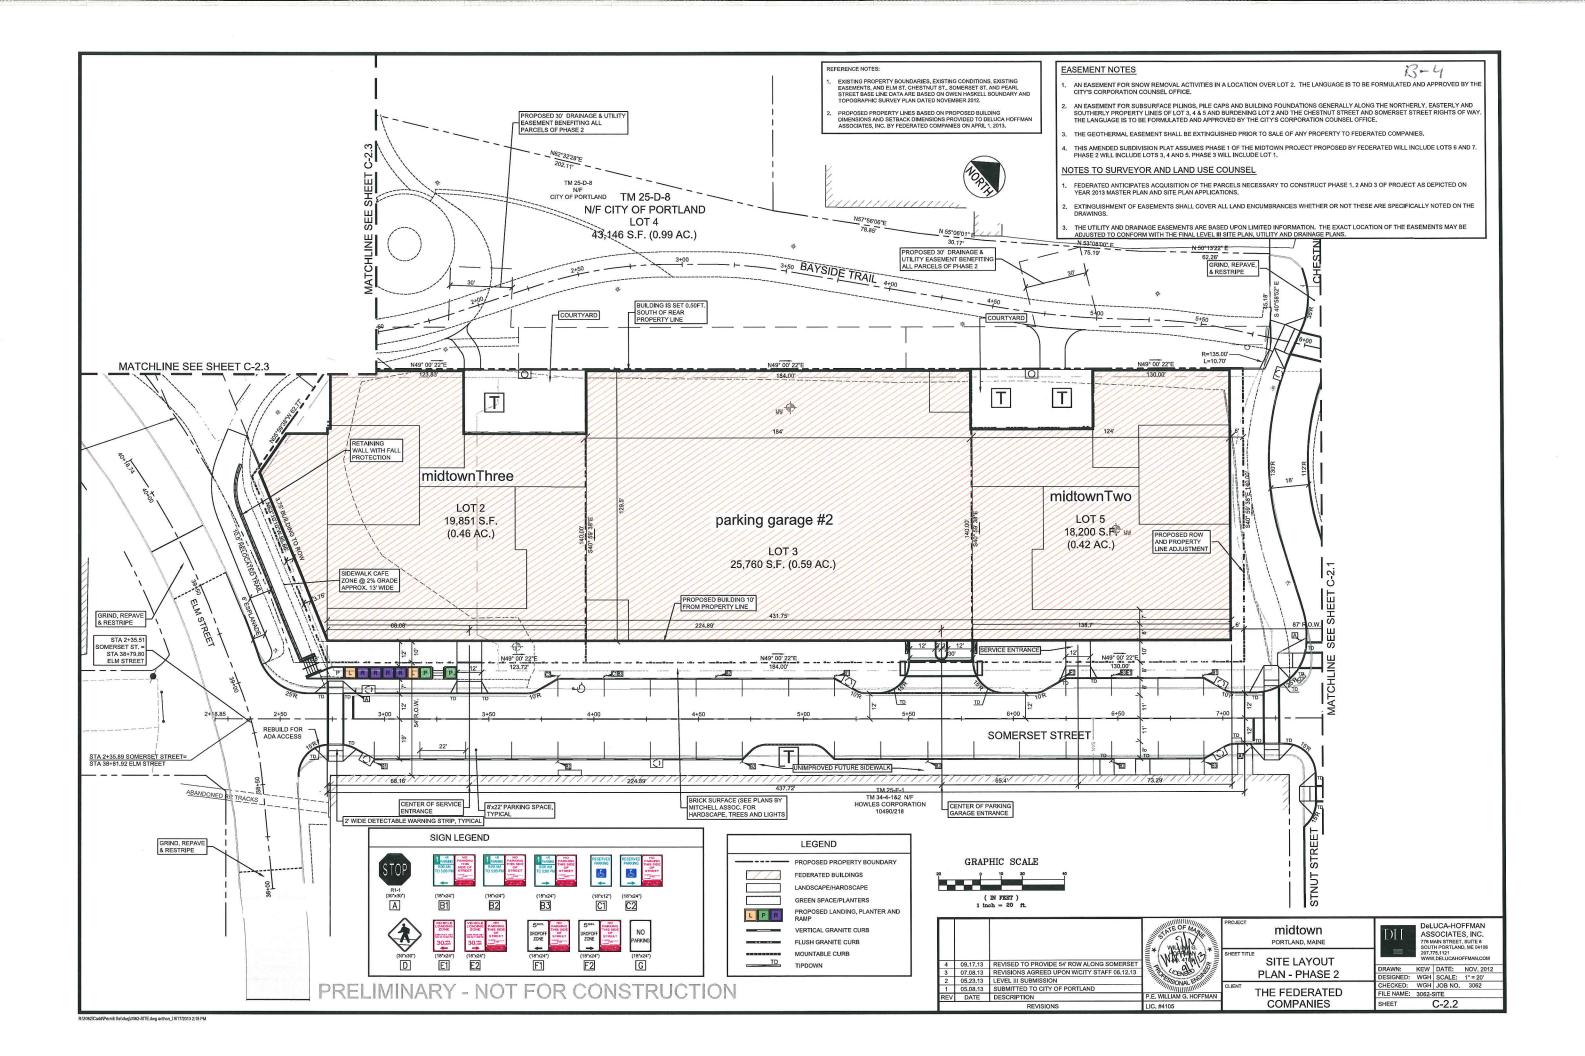

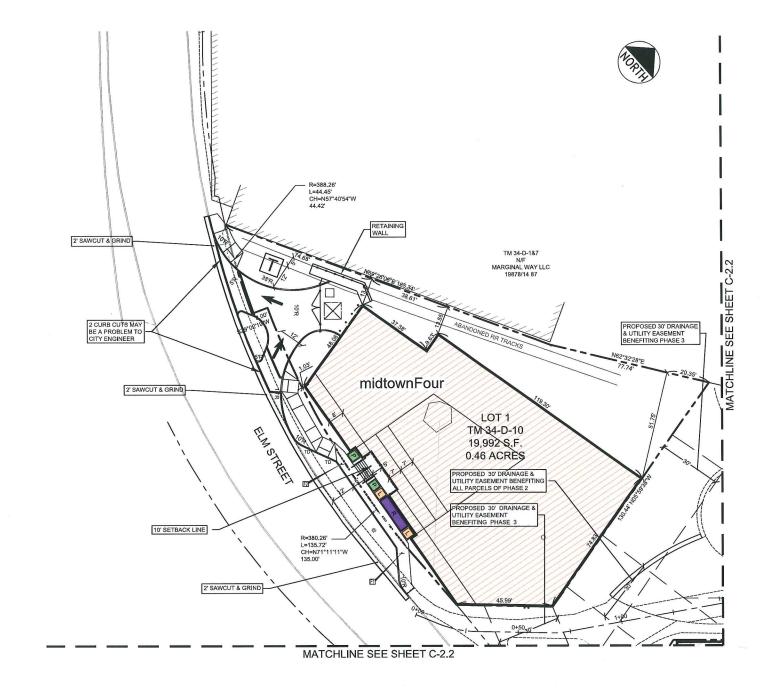



- EXISTING PROPERTY BOUNDARIES, EXISTING CONDITIONS, EXISTING EASEMENTS, AND ELM ST. CHESTNUT ST., SOMERSET ST. AND PEARL STREET RASE LINE DATA ARE BASED ON OWEN HASKELL BOUNDARY AND TOPOGRAPHIC SURVEY PLAN DATED NOVEMBER 2012.
- PROPOSED PROPERTY LINES BASED ON PROPOSED BUILDING DIMENSIONS AND SETBACK DIMENSIONS PROVIDED TO DELUCA HOFFMAN ASSOCIATES, INC. BY FEDERATED COMPANIES ON APRIL 1, 2013.


- AN EASEMENT FOR SNOW REMOVAL ACTIVITIES IN A LOCATION OVER LOT 2. THE LANGUAGE IS TO BE FORMULATED AND APPROVED BY THE CITY'S CORPORATION COUNSEL OFFICE.
- AN EASEMENT FOR SUBSURFACE PILINGS, PILE CAPS AND BUILDING FOUNDATIONS GENERALLY ALONG THE NORTHERLY, EASTERLY AND SOUTHERLY PROPERTY LINES OF LOT 3, 4 & 5 AND BURDENING LOT 2 AND THE CHESTNUT STREET AND SOMERSET STREET RIGHTS OF WAY. THE LANGUAGE IS TO BE FORMULATED AND APPROVED BY THE CITY'S CORPORATION COUNSEL OFFICE.
- THE GEOTHERMAL EASEMENT SHALL BE EXTINGUISHED PRIOR TO SALE OF ANY PROPERTY TO FEDERATED COMPANIES.
- THIS AMENDED SUBDIVISION PLAT ASSUMES PHASE 1 OF THE MIDTOWN PROJECT PROPOSED BY FEDERATED WILL INCLUDE LOTS 6 AND 7. PHASE 2 WILL INCLUDE LOTS 3, 4 AND 5, PHASE 3 WILL INCLUDE LOT 1.

NOTES TO SURVEYOR AND LAND USE COUNSEL

- FEDERATED ANTICIPATES ACQUISITION OF THE PARCELS NECESSARY TO CONSTRUCT PHASE 1, 2 AND 3 OF PROJECT AS DEPICTED ON YEAR 2013 MASTER PLAN AND SITE PLAN APPLICATIONS.
- EXTINGUISHMENT OF EASEMENTS SHALL COVER ALL LAND ENCUMBRANCES WHETHER OR NOT THESE ARE SPECIFICALLY NOTED ON THE DRAWINGS,
- THE UTILITY AND DRAINAGE EASEMENTS ARE BASED UPON LIMITED INFORMATION, THE EXACT LOCATION OF THE EASEMENTS MAY BE ADJUSTED TO CONFORM WITH THE FINAL LEVEL III SITE PLAN, UTILITY AND DRAINAGE PLANS.

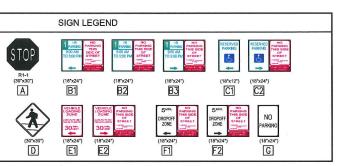

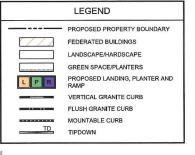

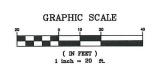

			THIRING THE PARTY OF THE PARTY
4	09.17.13	REVISED TO PROVIDE 54' ROW ALONG SOMERSET] = .
3	07.08.13	REVISIONS AGREED UPON W/CITY STAFF 06.12.13	
2	05.23.13	LEVEL III SUBMISSION] 3
1	05.08.13	SUBMITTED TO CITY OF PORTLAND	1
REV	DATE	DESCRIPTION	P.E.
		REVISIONS	LIC.


ATE OF MA	PRO
* WIRFAMNY 3 *	SHE
E. WILLIAM G. HOFFMAN	CLIE


midtown


SITE LAYOUT PLAN - PHASE 3 DeLUCA-HOFFMAN ASSOCIATES, INC. 778 MAIN STREET, SUITE 8 SOUTH PORTLAND, ME 04106 207.775.1121 WWW.DELUCAHOFFMAN.COM


DRAWN: KEW DATE: NOV. 2012
DESIGNED: WGH SCALE: 1" = 20'
CHECKED: WGH JOB NO. 3062
FILE NAME: 3062-SITE
SHEET C-2.3 THE FEDERATED COMPANIES


PRELIMINARY - NOT FOR CONSTRUCTION

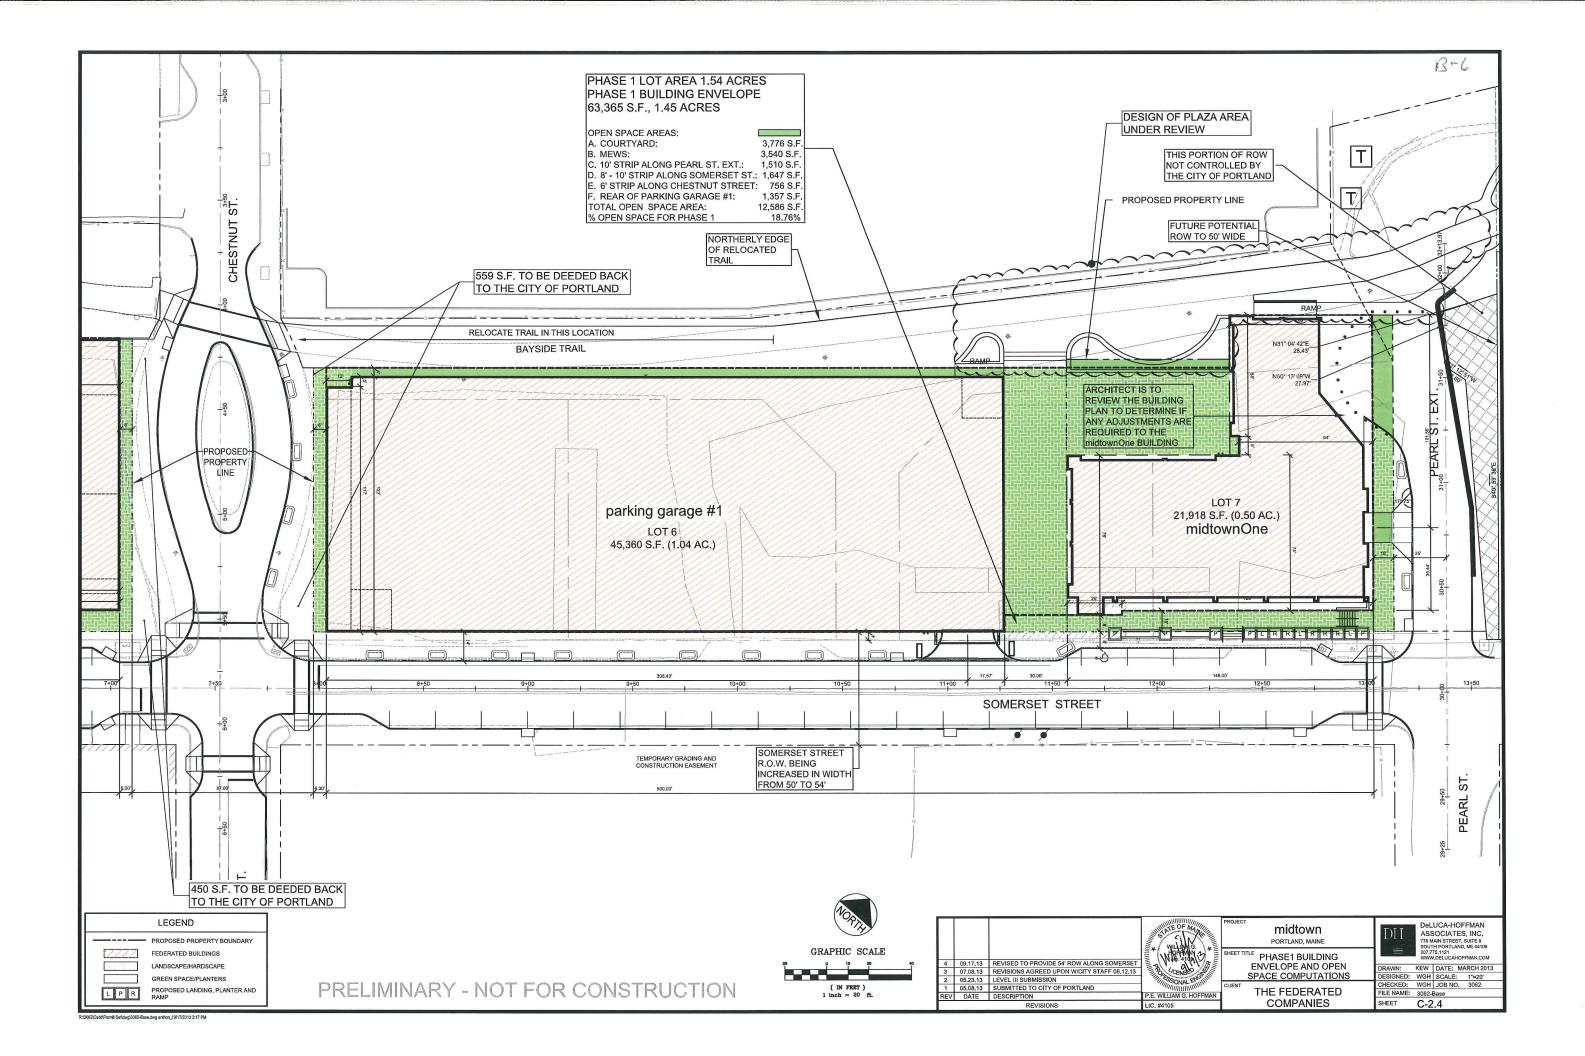


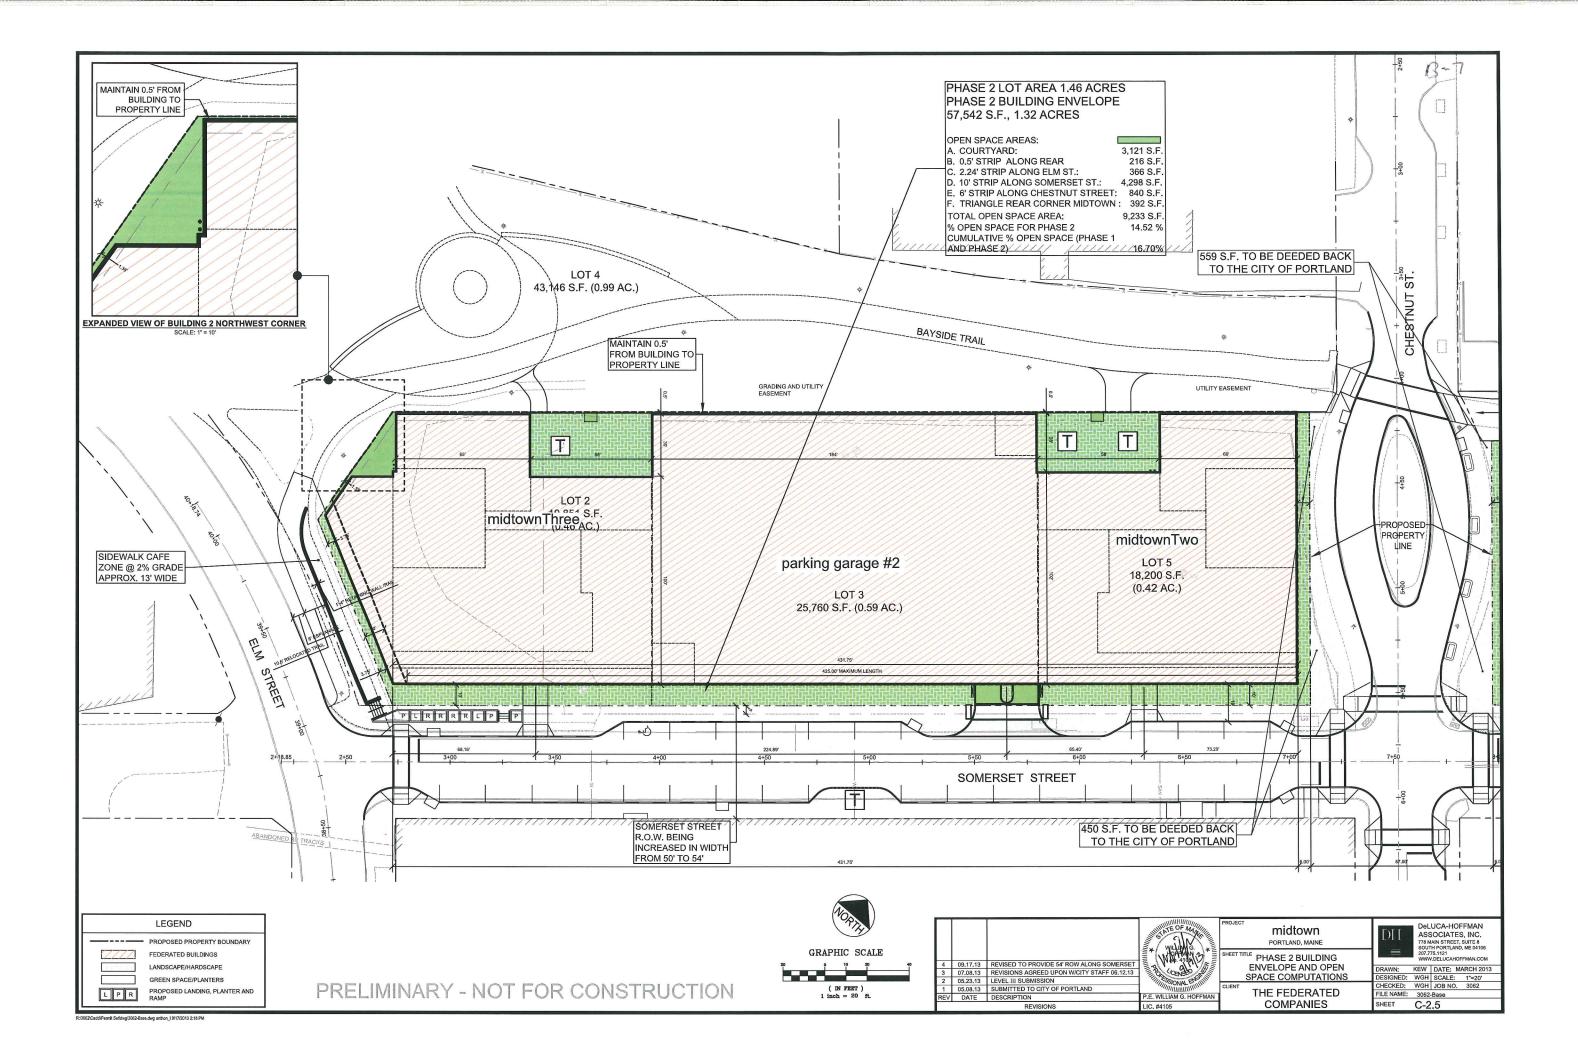


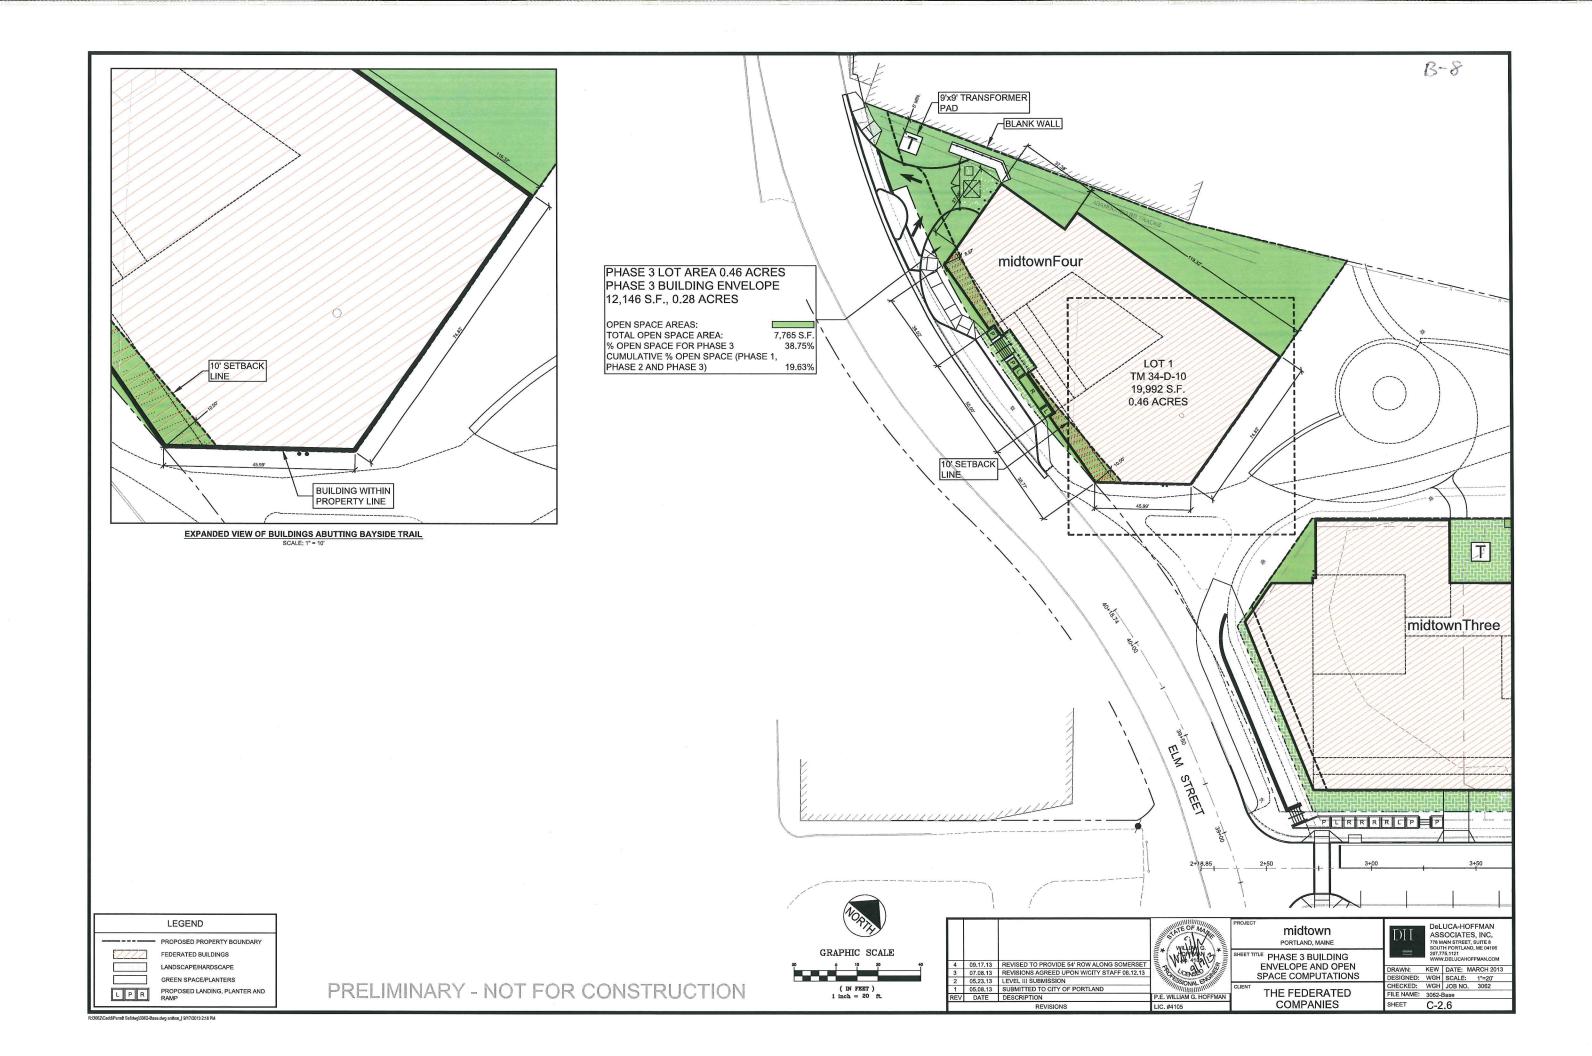

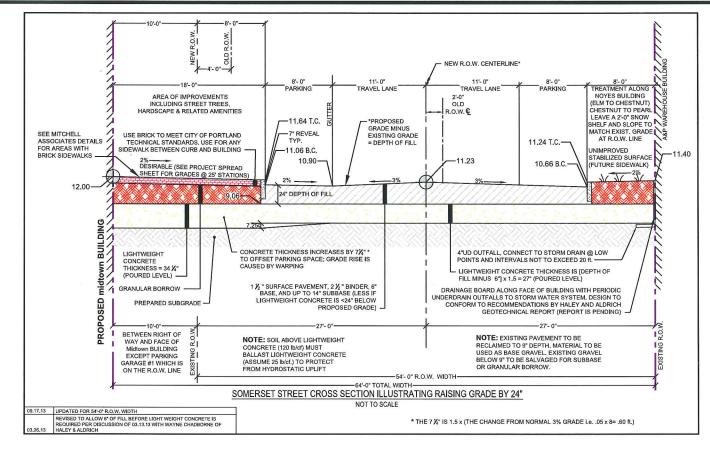

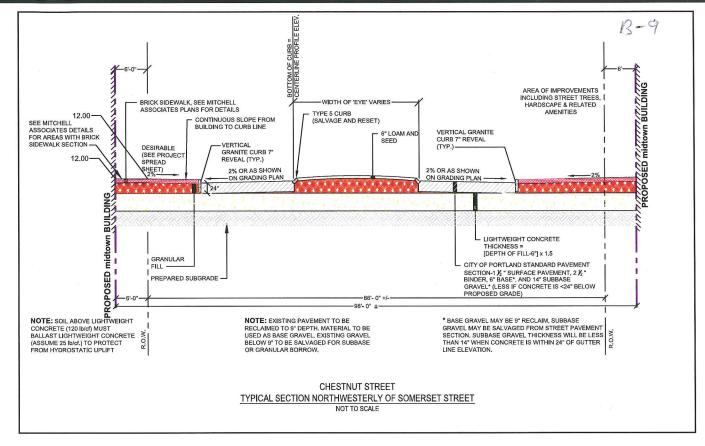

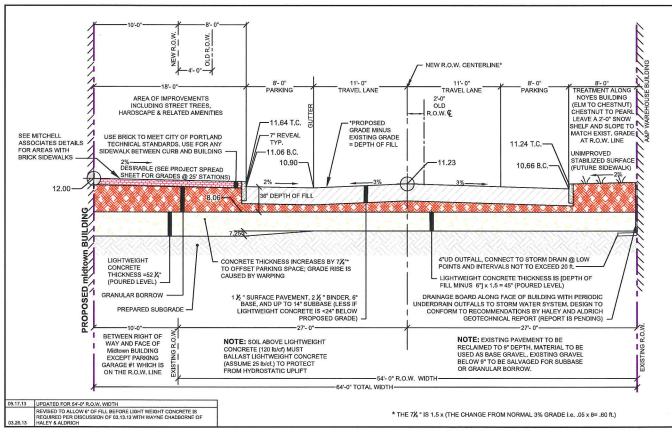

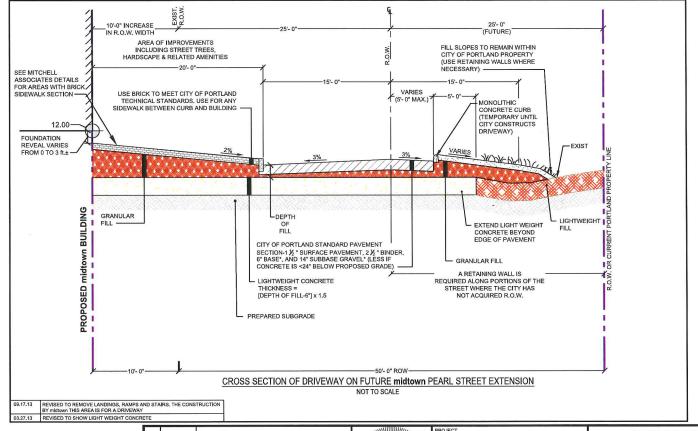



NOTE: SECTIONS ARE SUBJECT TO RECEIPT AND FINAL REVIEW OF THE GEOTECHNICAL REPORT FOR THE FEDERATED COMPANIES


PRELIMINARY - NOT FOR CONSTRUCTION

DeLUCA-HOFFMAN ASSOCIATES, INC.
778 MAIN STREET, SUITE 8
SOUTH PORTLAND, ME 04106 207.775.1121 WWW.DELUCAHOFFMAN.COM

DRAWN: LA DATE: MAR 2013 DESIGNED: WGH SCALE: N.T.S. CHECKED: WGH JOB NO. 3062 FILE NAME: 3062-DET C-7.0

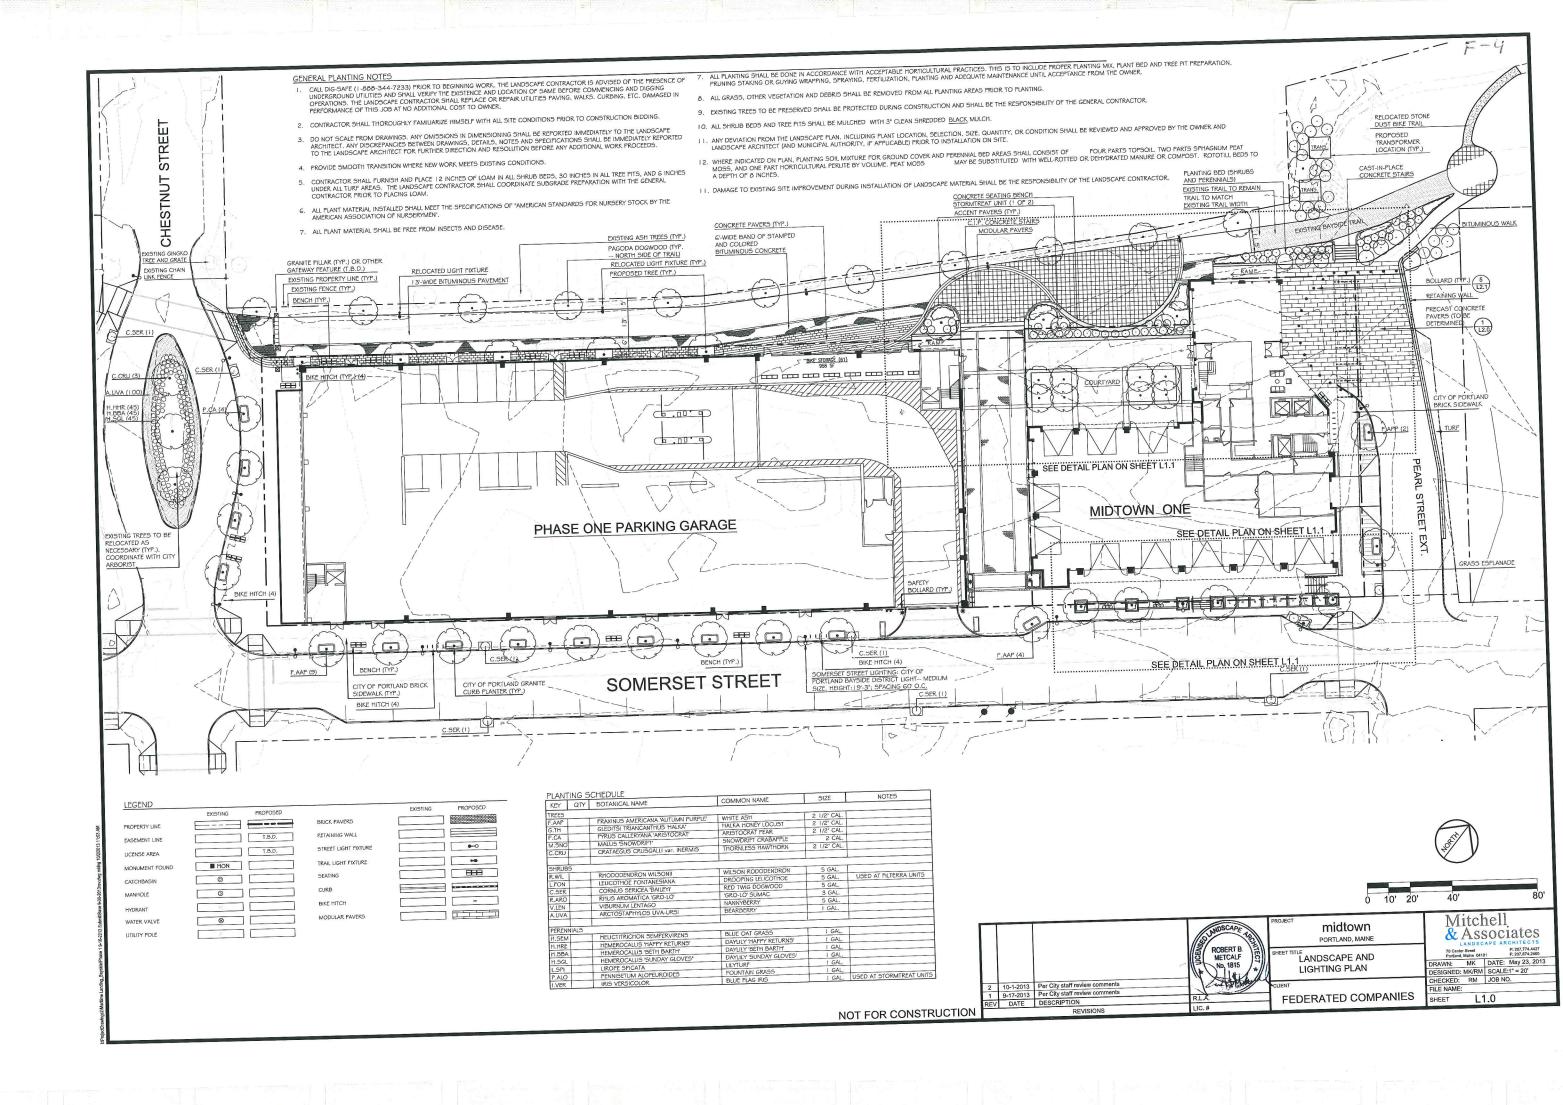

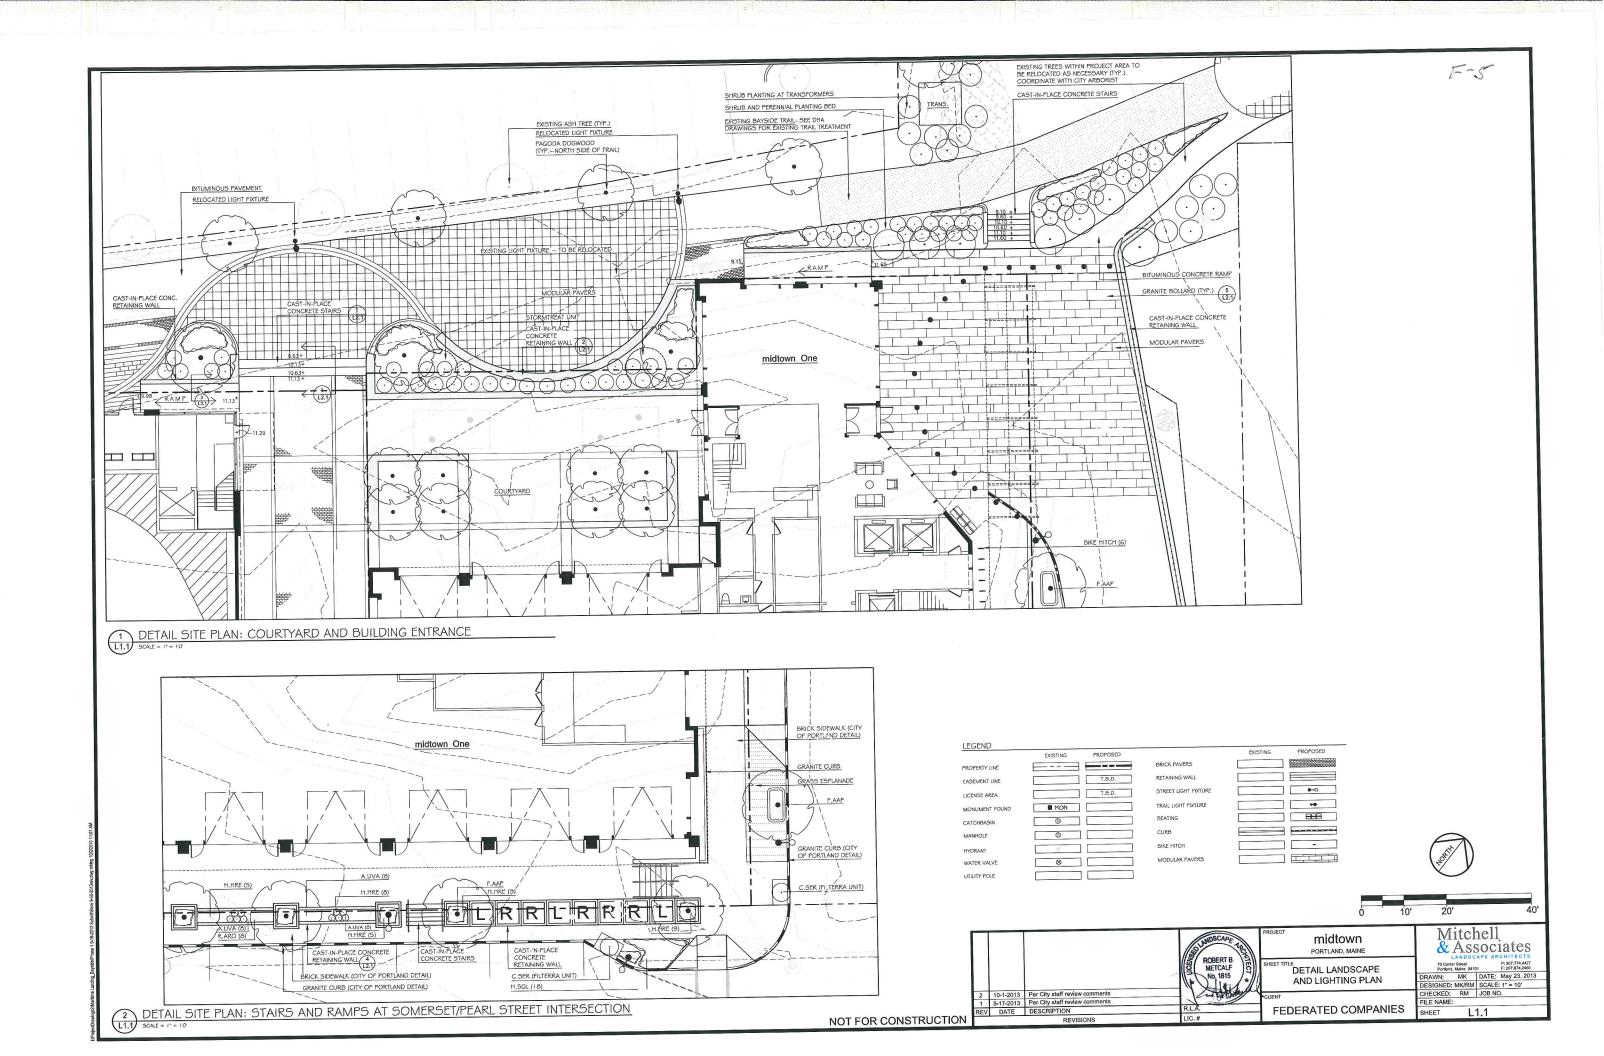

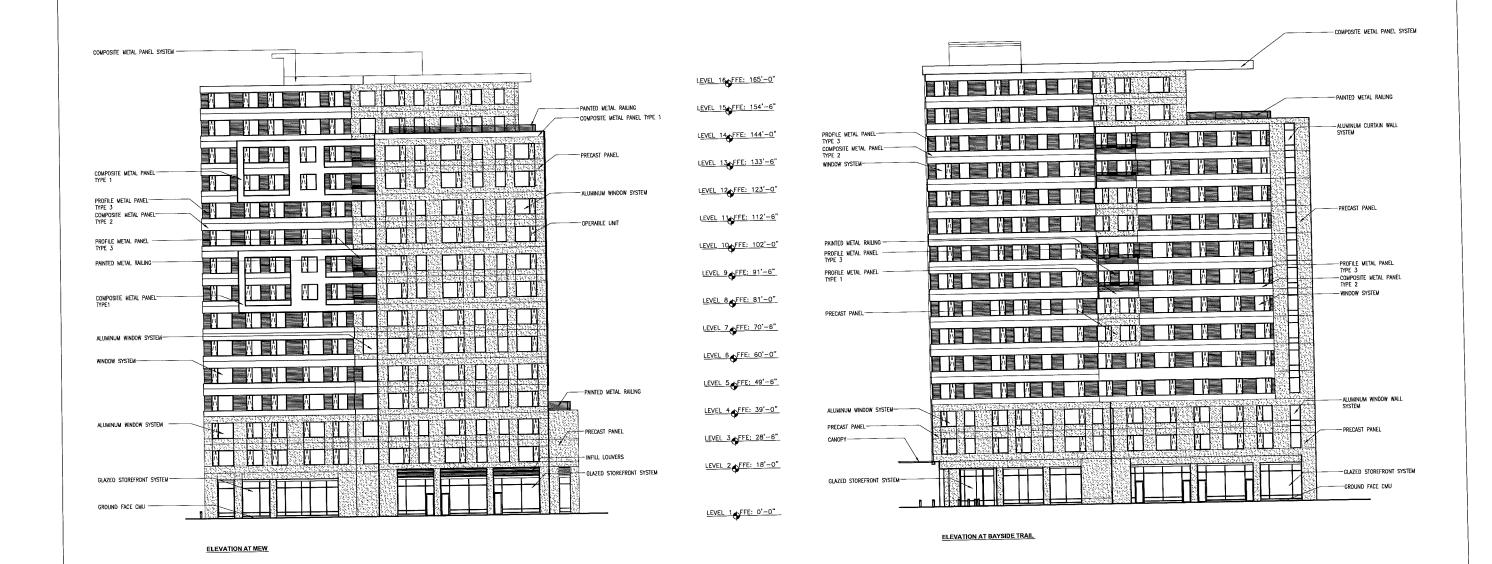


elevations -2

SCALE PROJECT # DATE ISSUED 1/16"=1'-0" 136070.00 10.01.2013

A202

REVISIONS
DATE DESCRIPTION midtown One - Phase I - Building A

617 262 4354 cbtarchitects.com 110 canal street boston, ma 02114

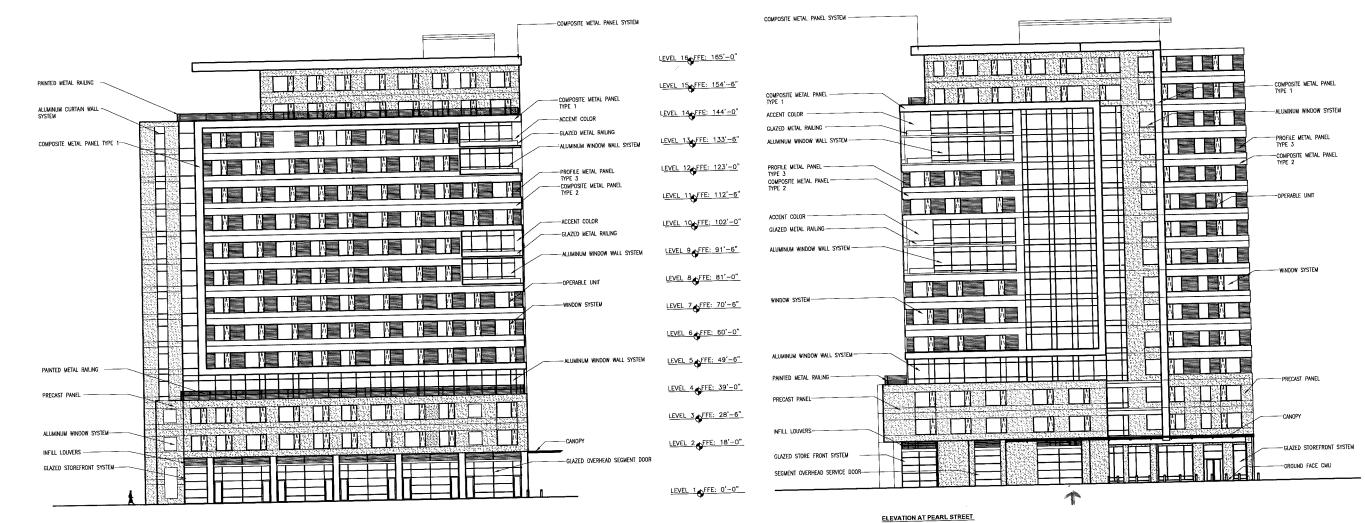

ELEVATION AT SOMERSET STREET


REVISIONS # DATE DESCRIPTION 10/01/13 not for construction


elevations -1

617 262 4354 obtarchitects.com 110 canal street boston, ma 02114

midtown One - Phase I - Building A

A201

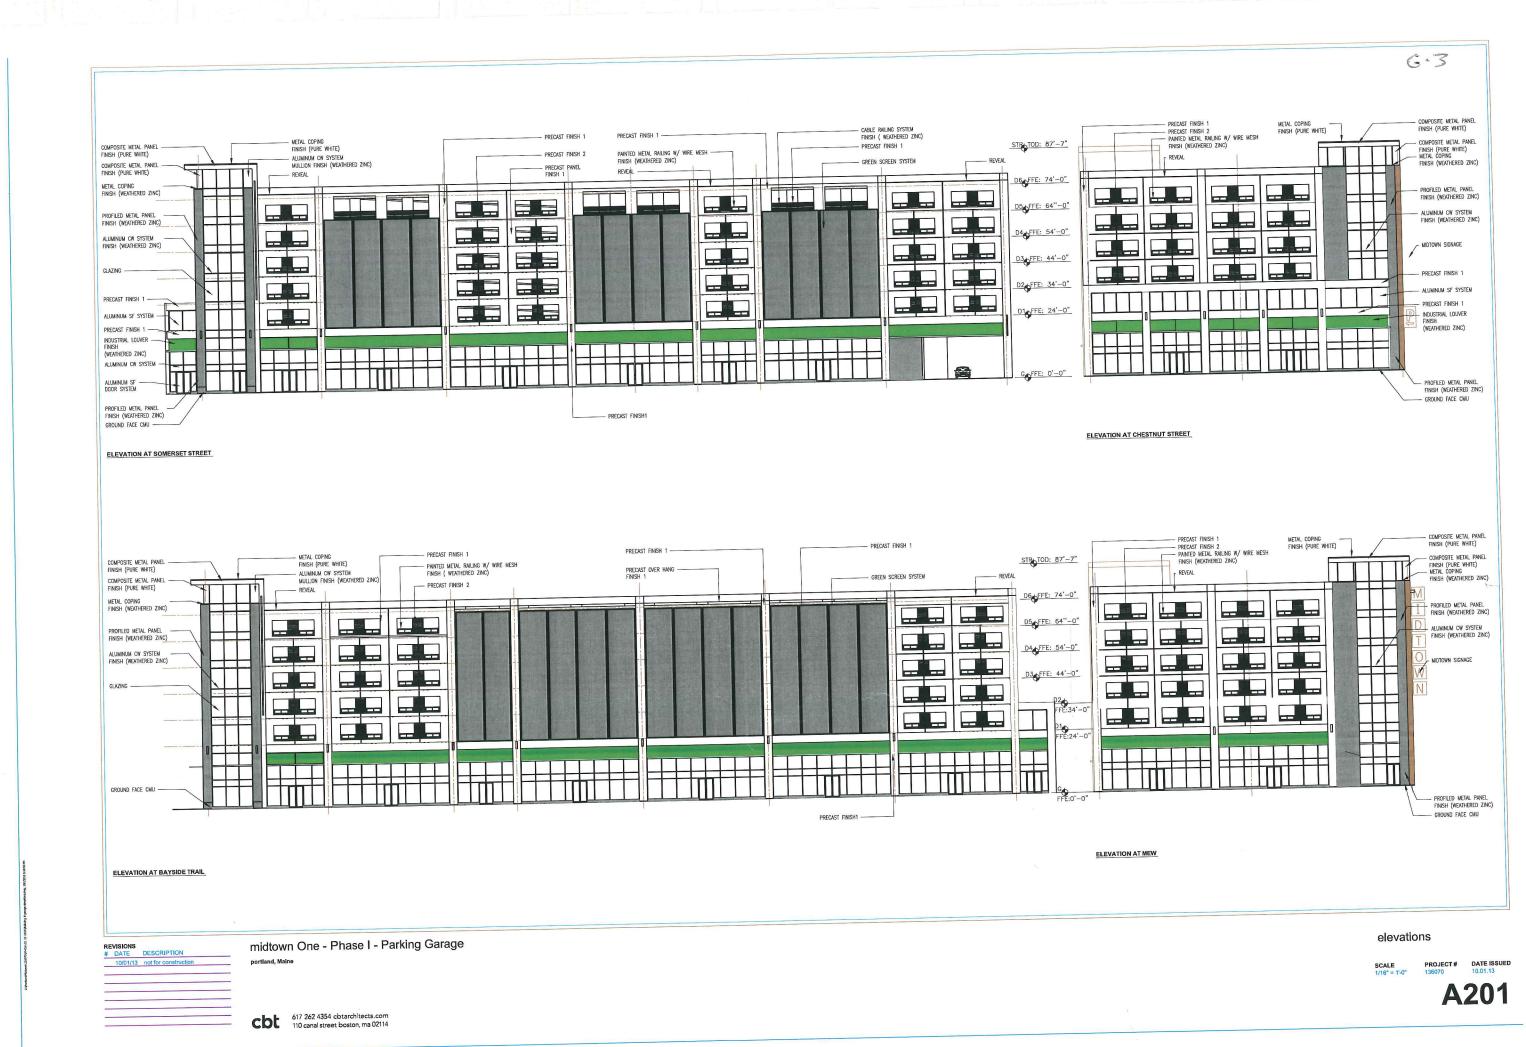

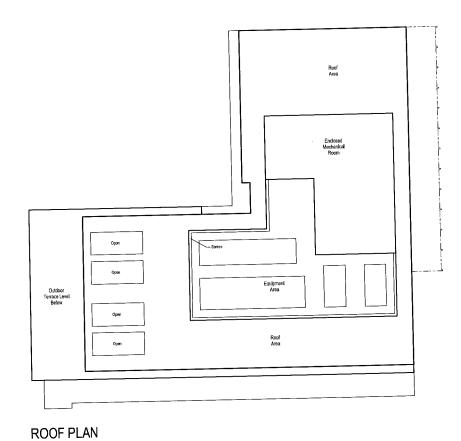

Unit 14 Studio TYPICAL FLOOR PLAN

midtown One - Phase I - Building A


typical floor plan and roof plan

A102

617 262 4354 obtarchitects.com 110 canal street boston, ma 02114

DATE DESCRIPTION

10/D1/13 not for construction

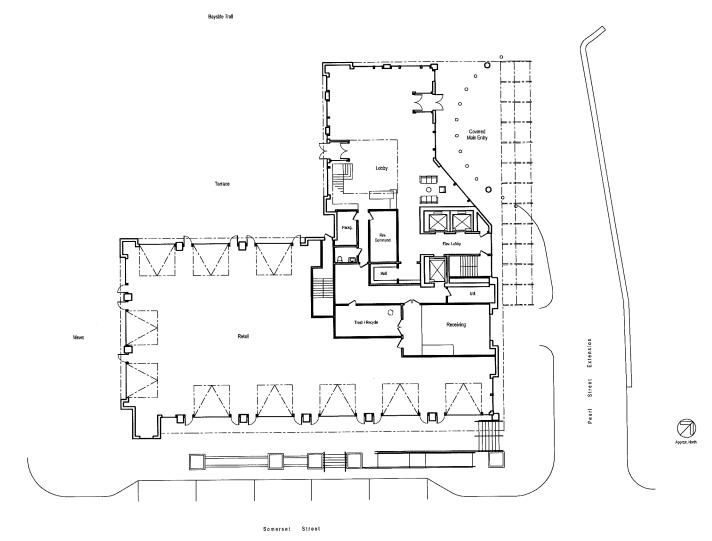

GROUND FLOOR PLAN


DATE DESCRIPTION
10/01/13 not for construction


midtown One - Phase I - Building A


cbt 617 262 4354 obtarchitects.com 110 canal street boston, ma 02114


ground floor plan


A101

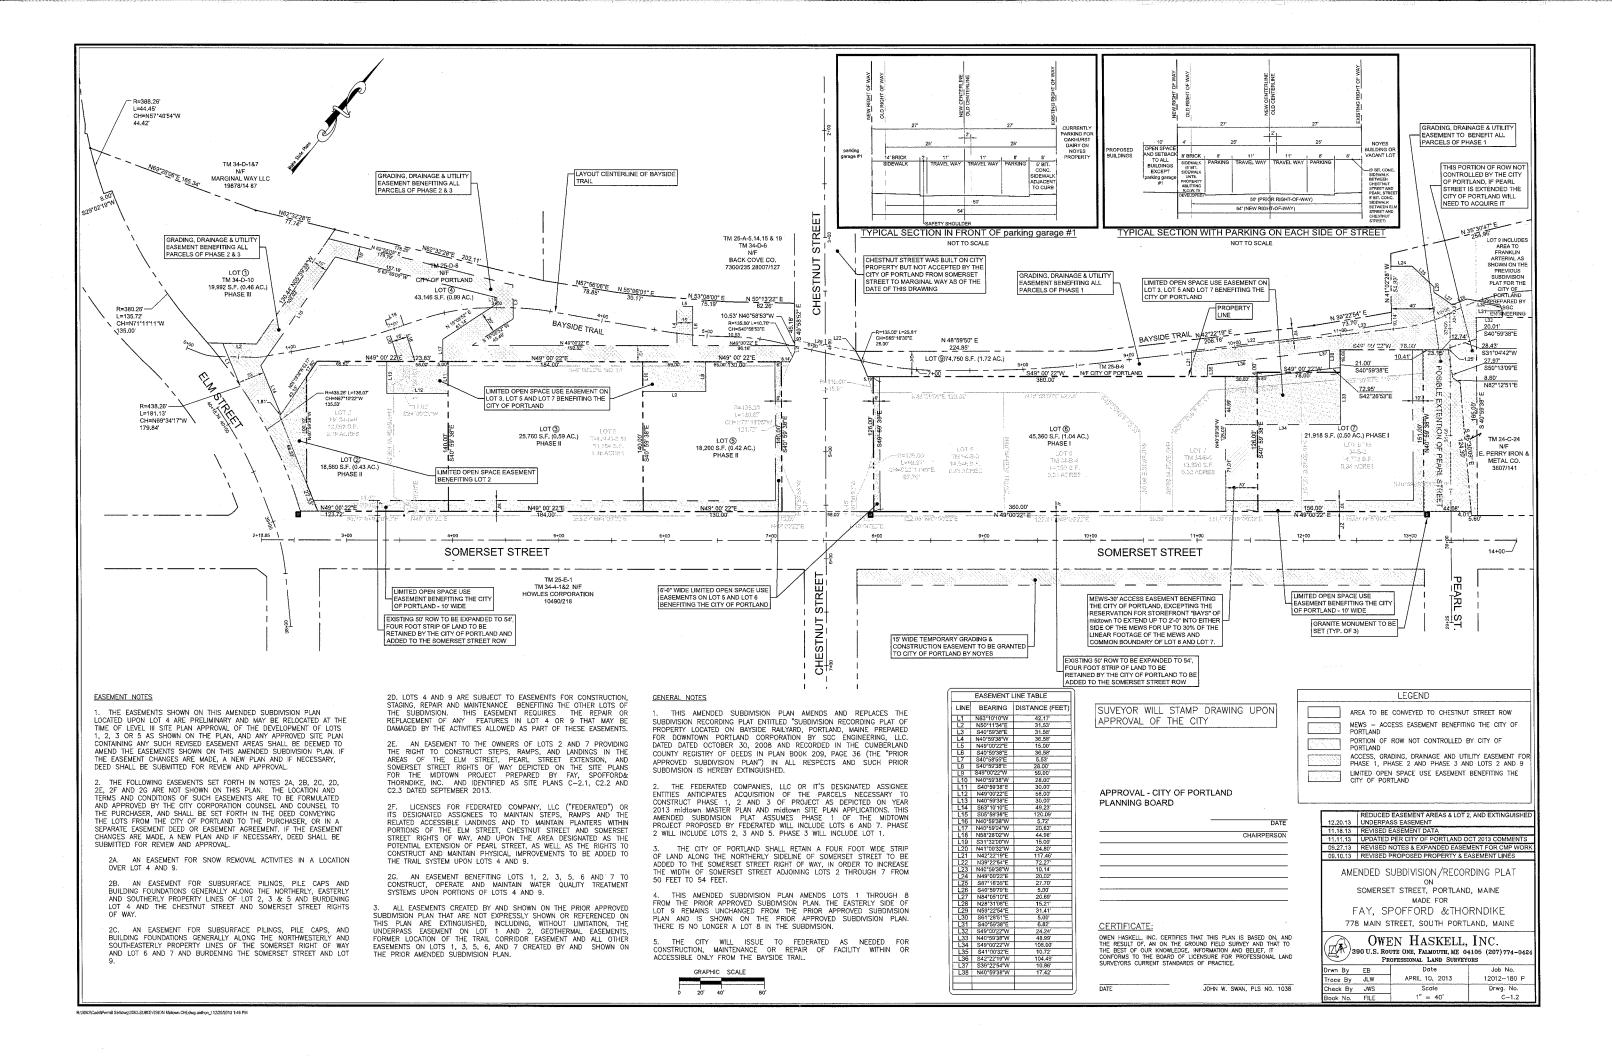

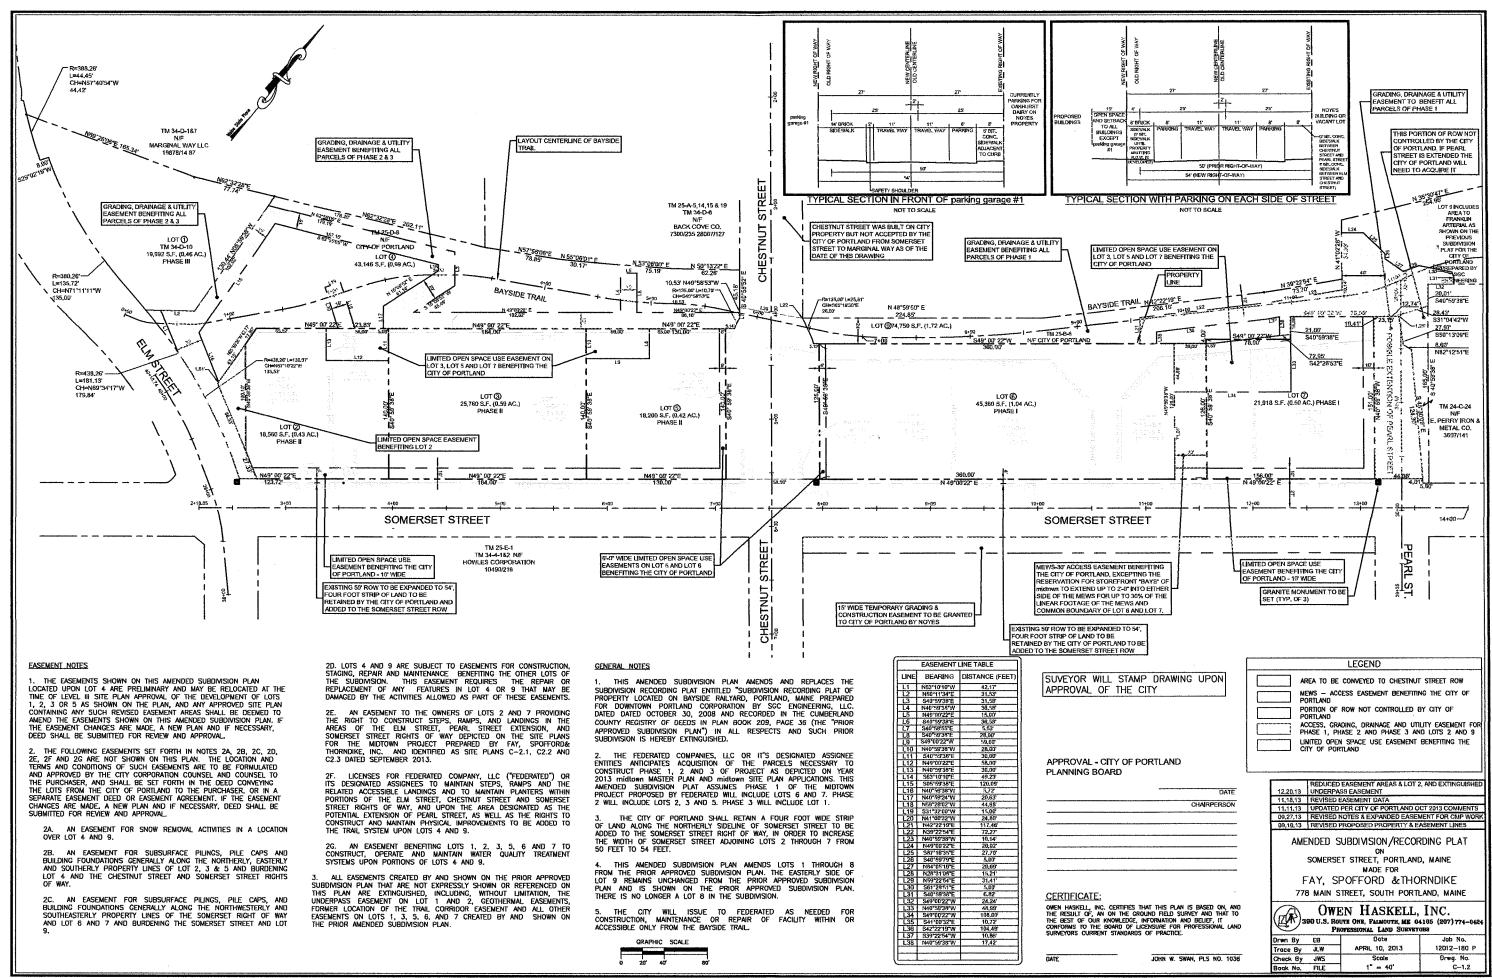

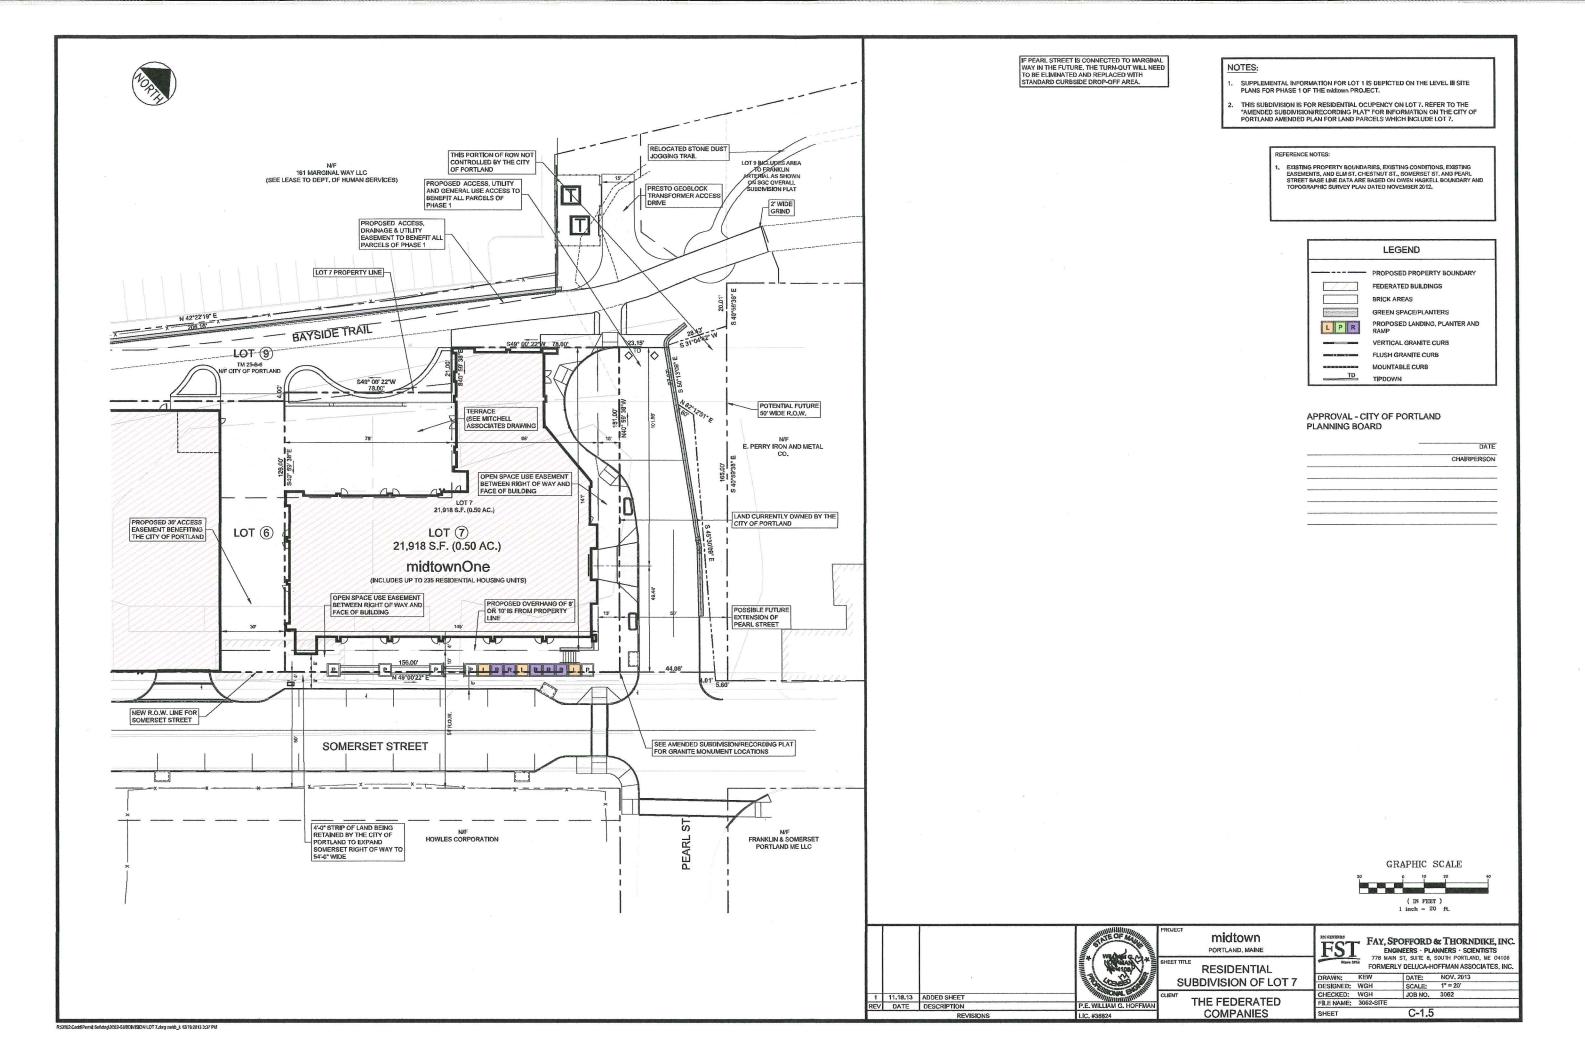

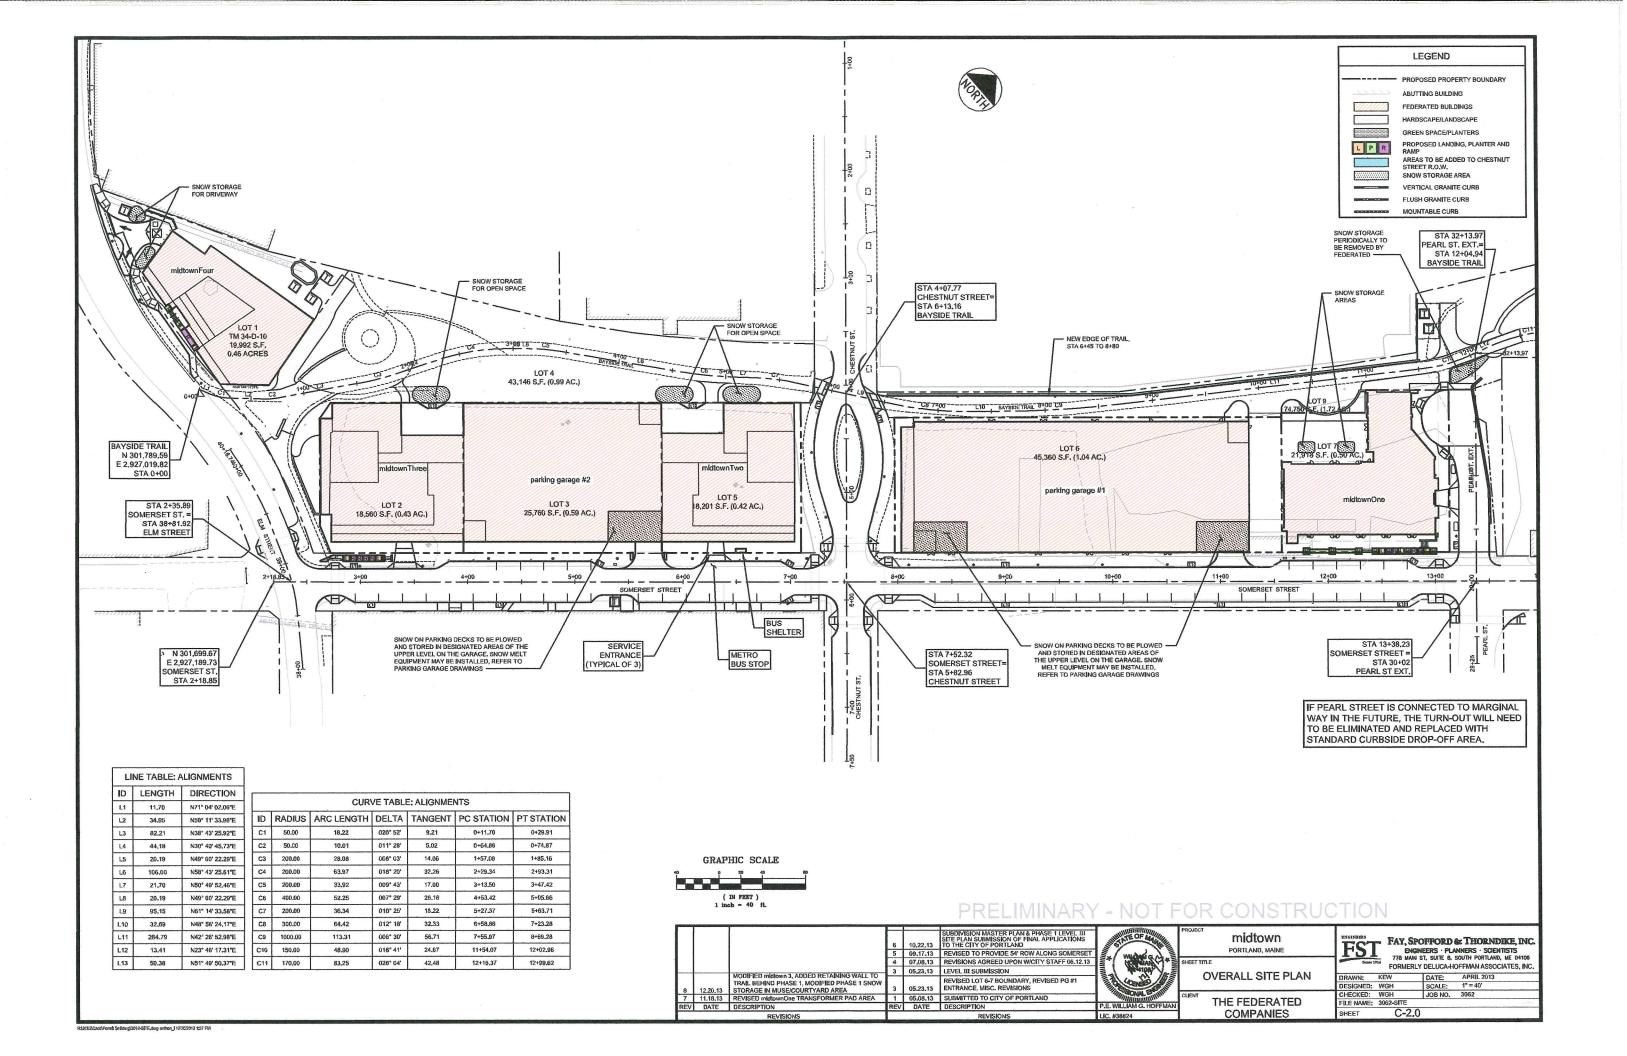

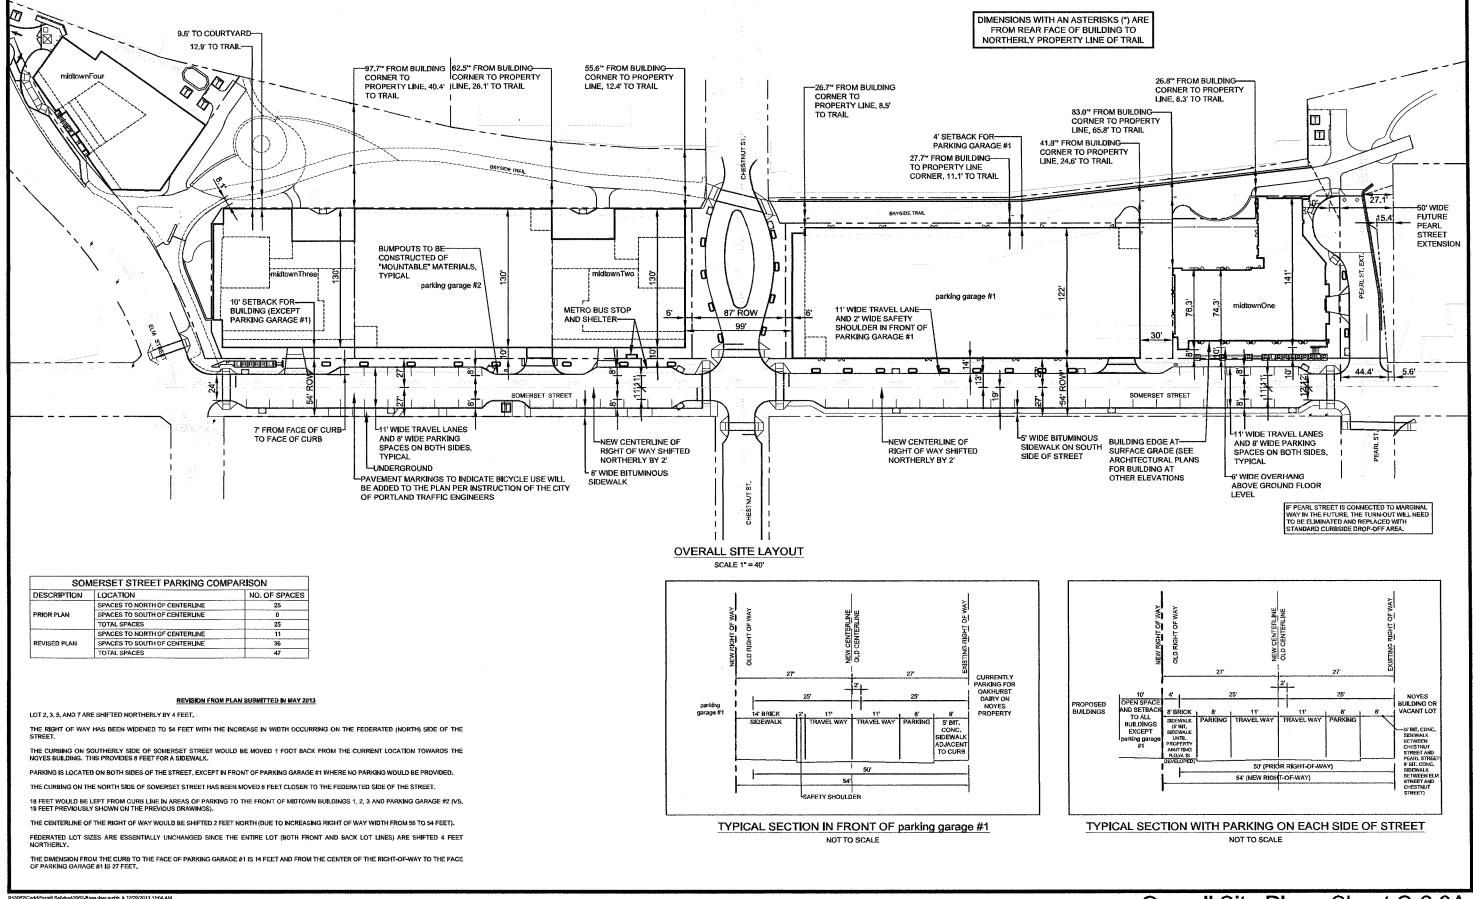

FST, INC.


GRAPHIC SCALE


O 20 40


(IN FEET)
1 inch = 40 ft.





Overall Site Plan - Sheet C-2.0A Federated's midtown

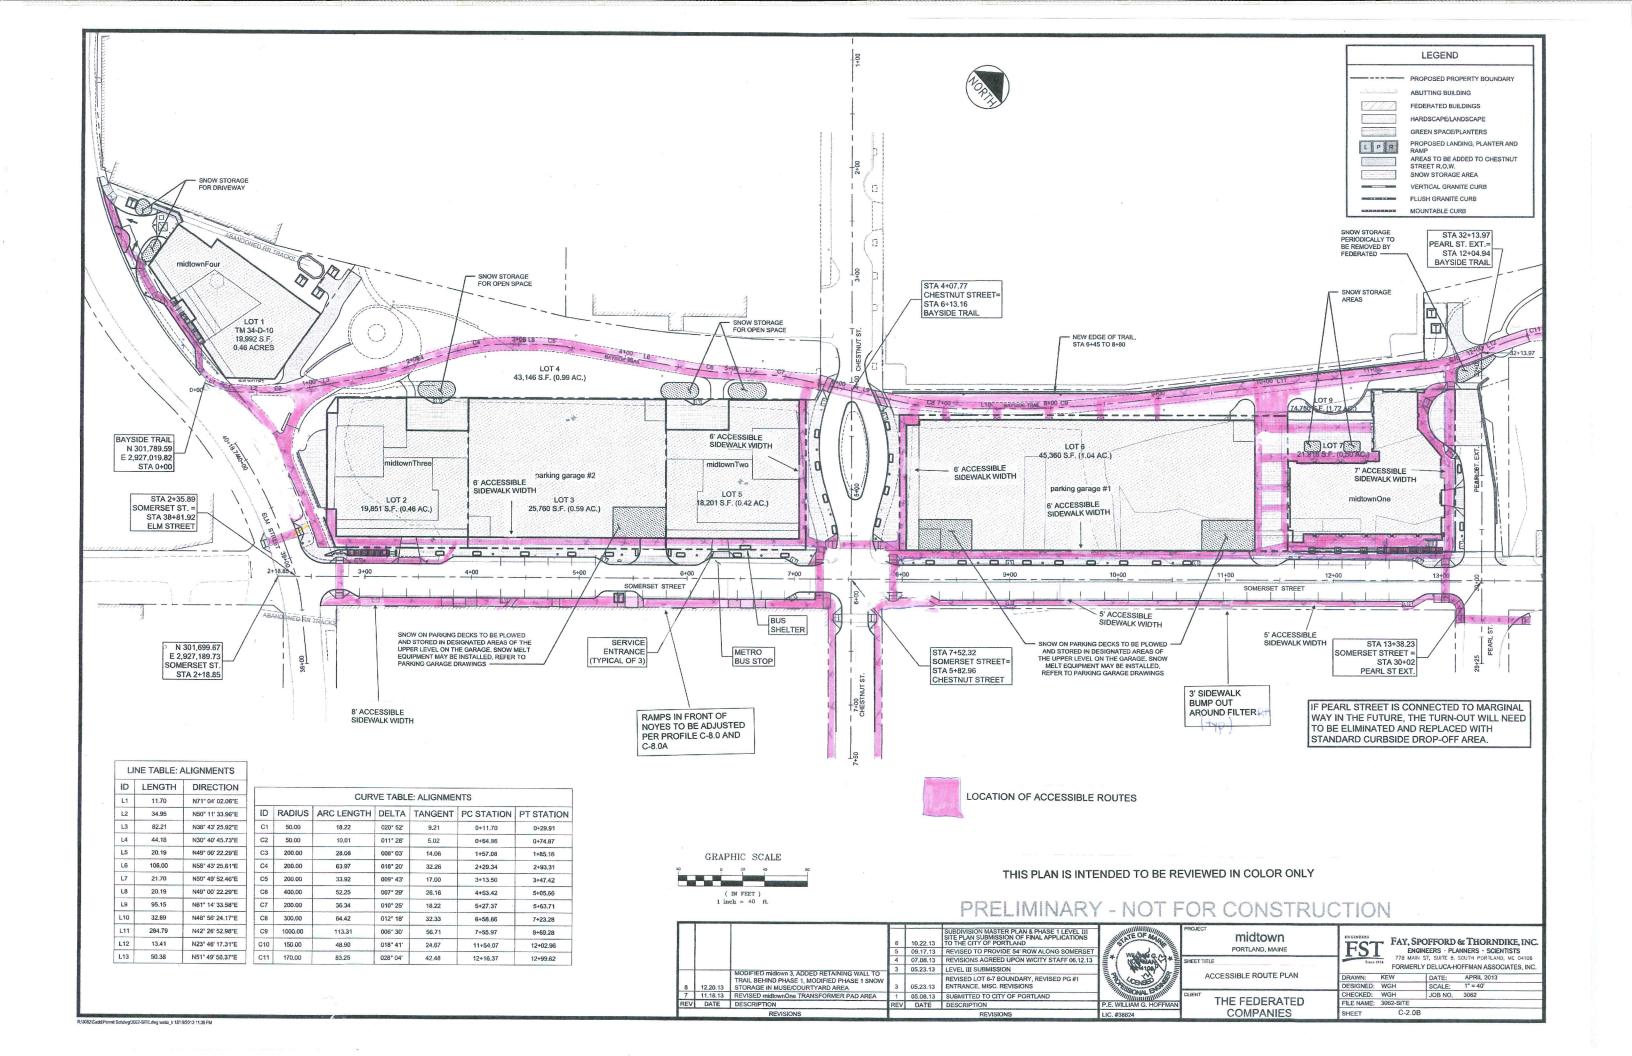

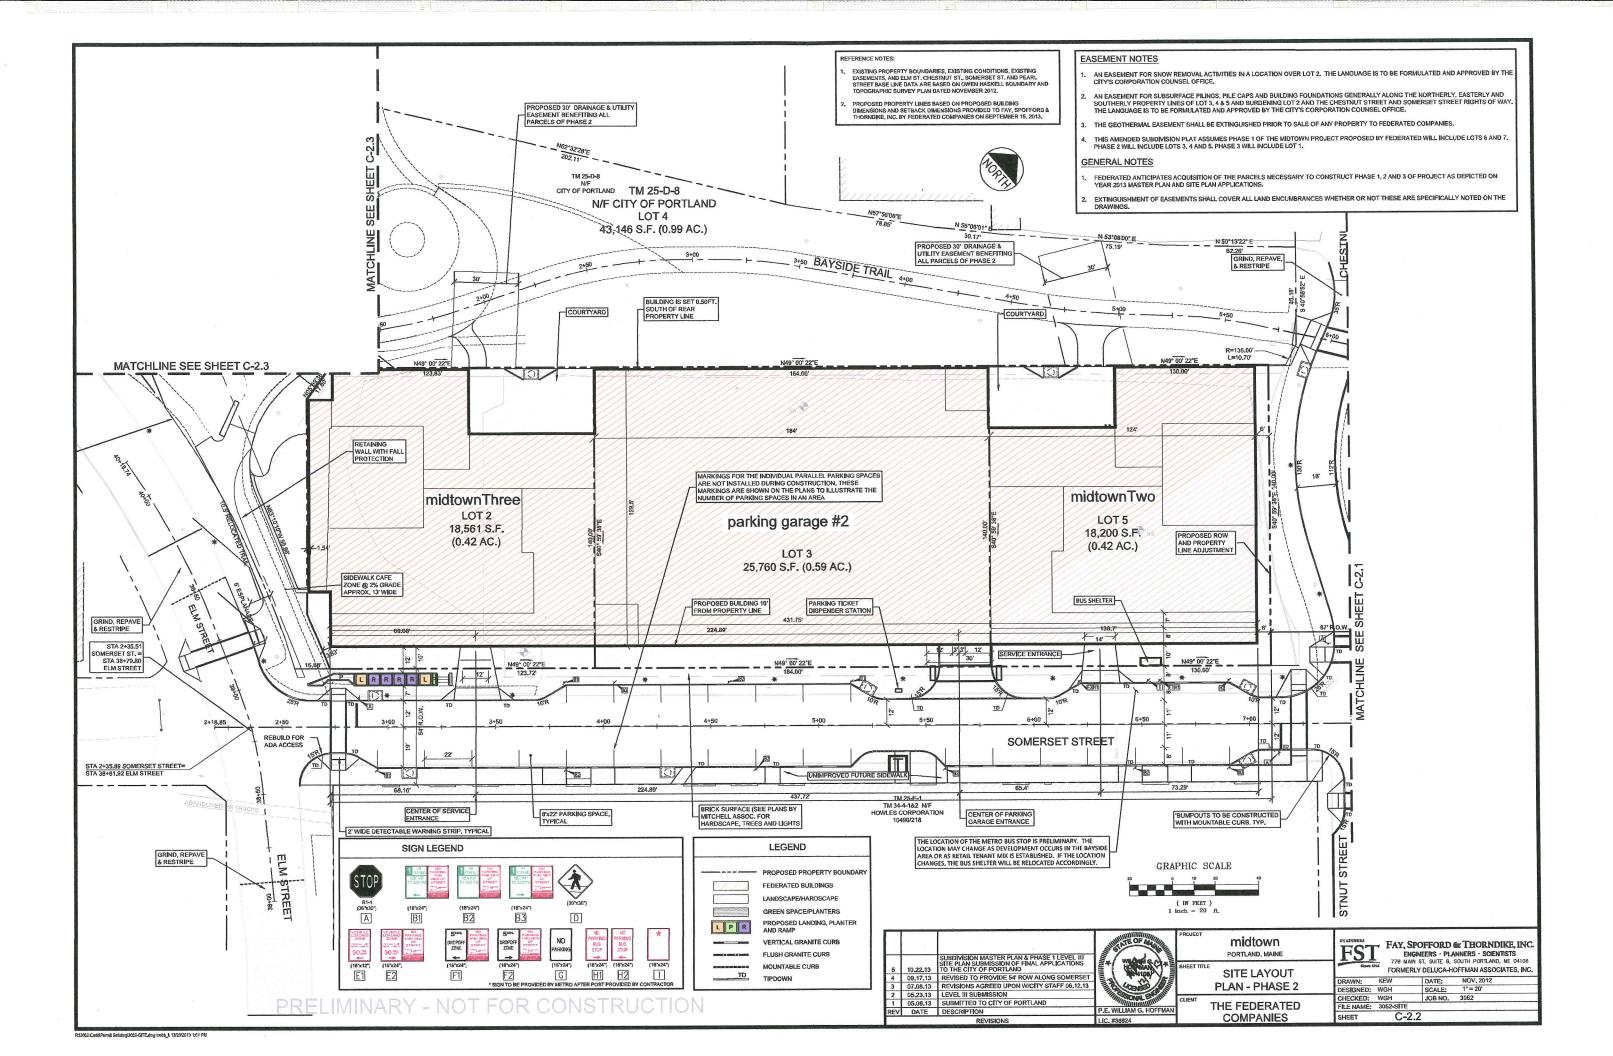

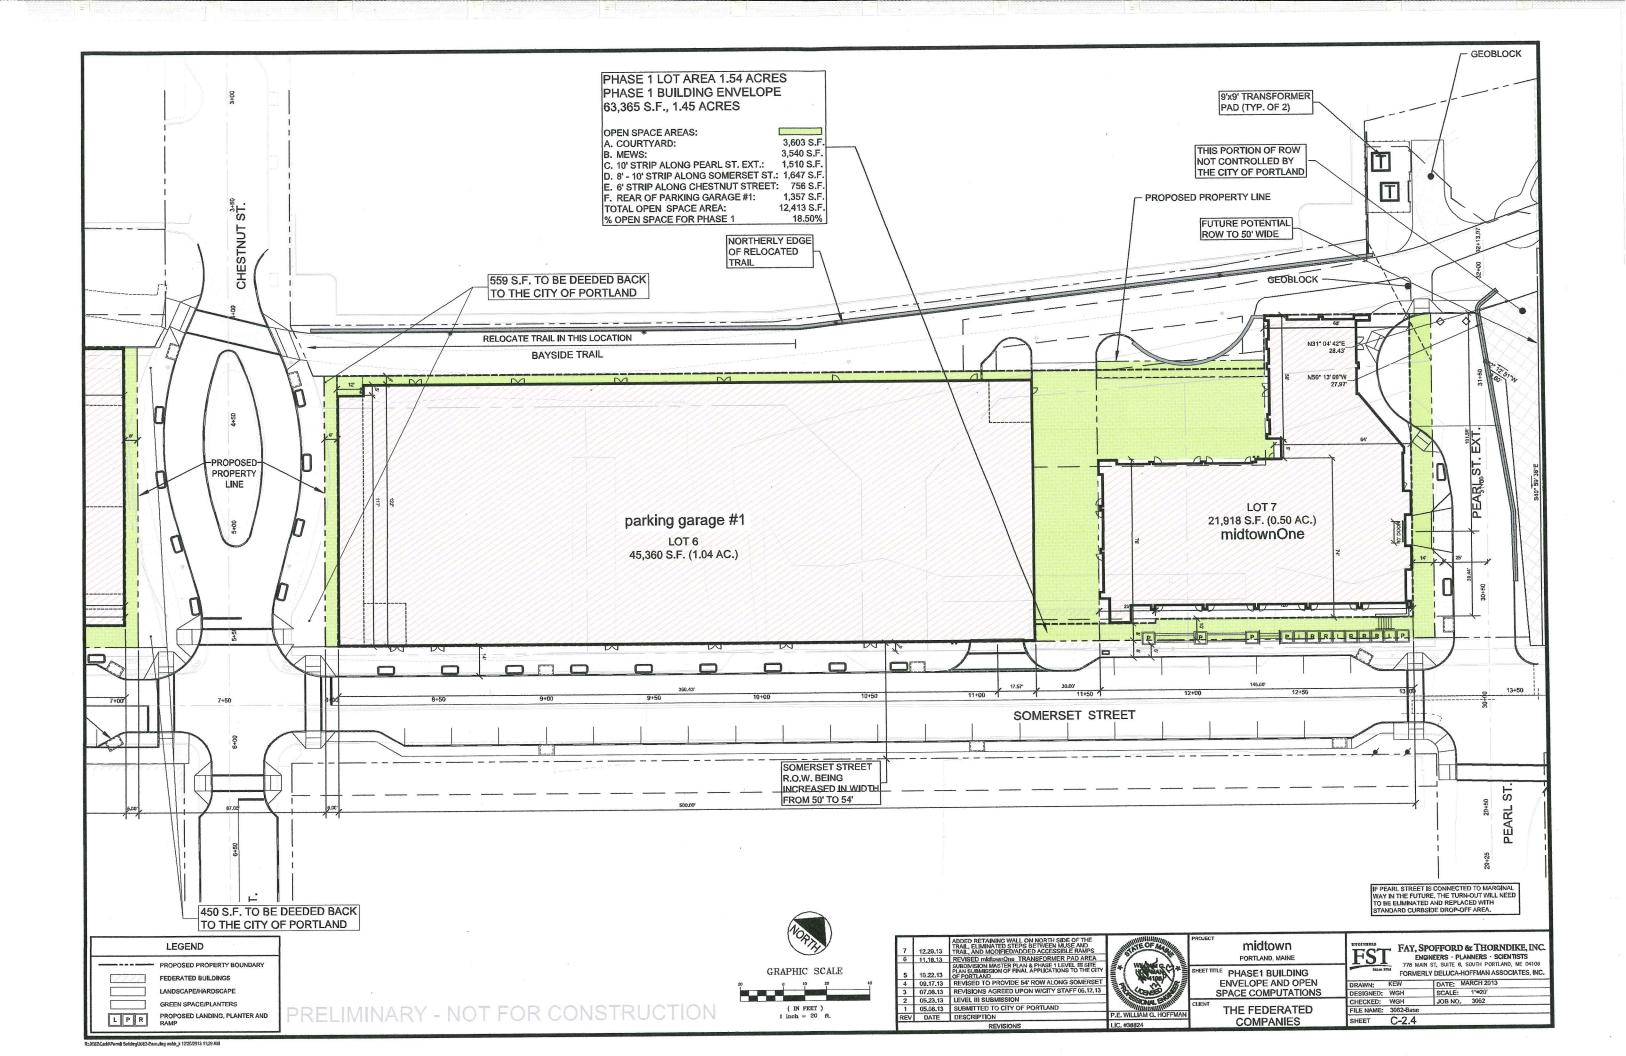

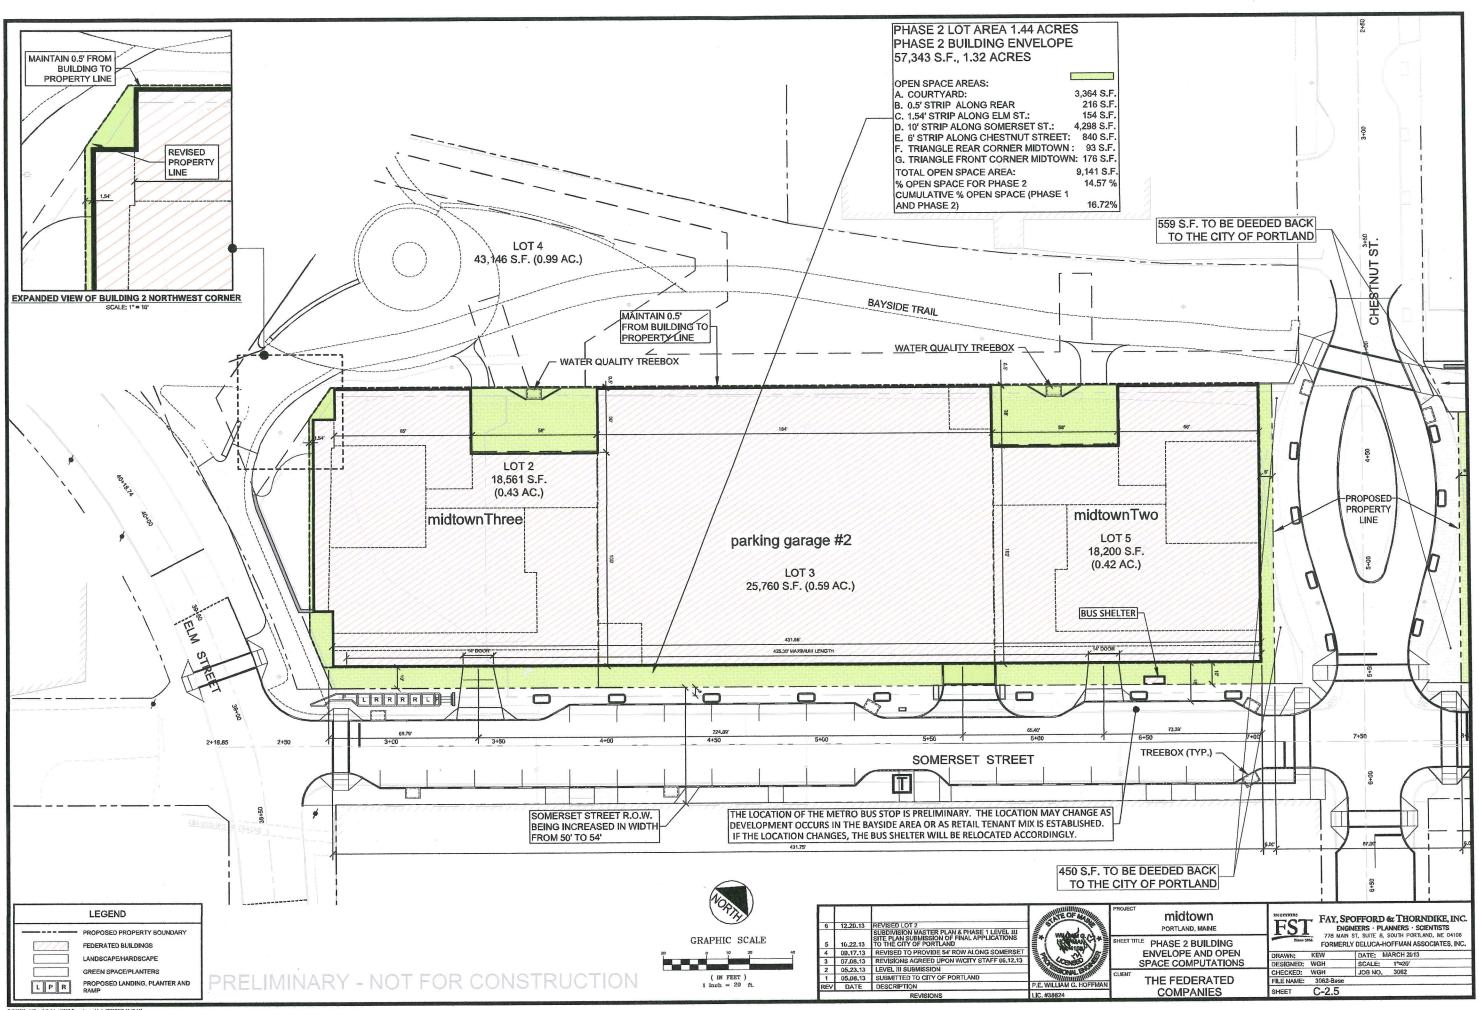

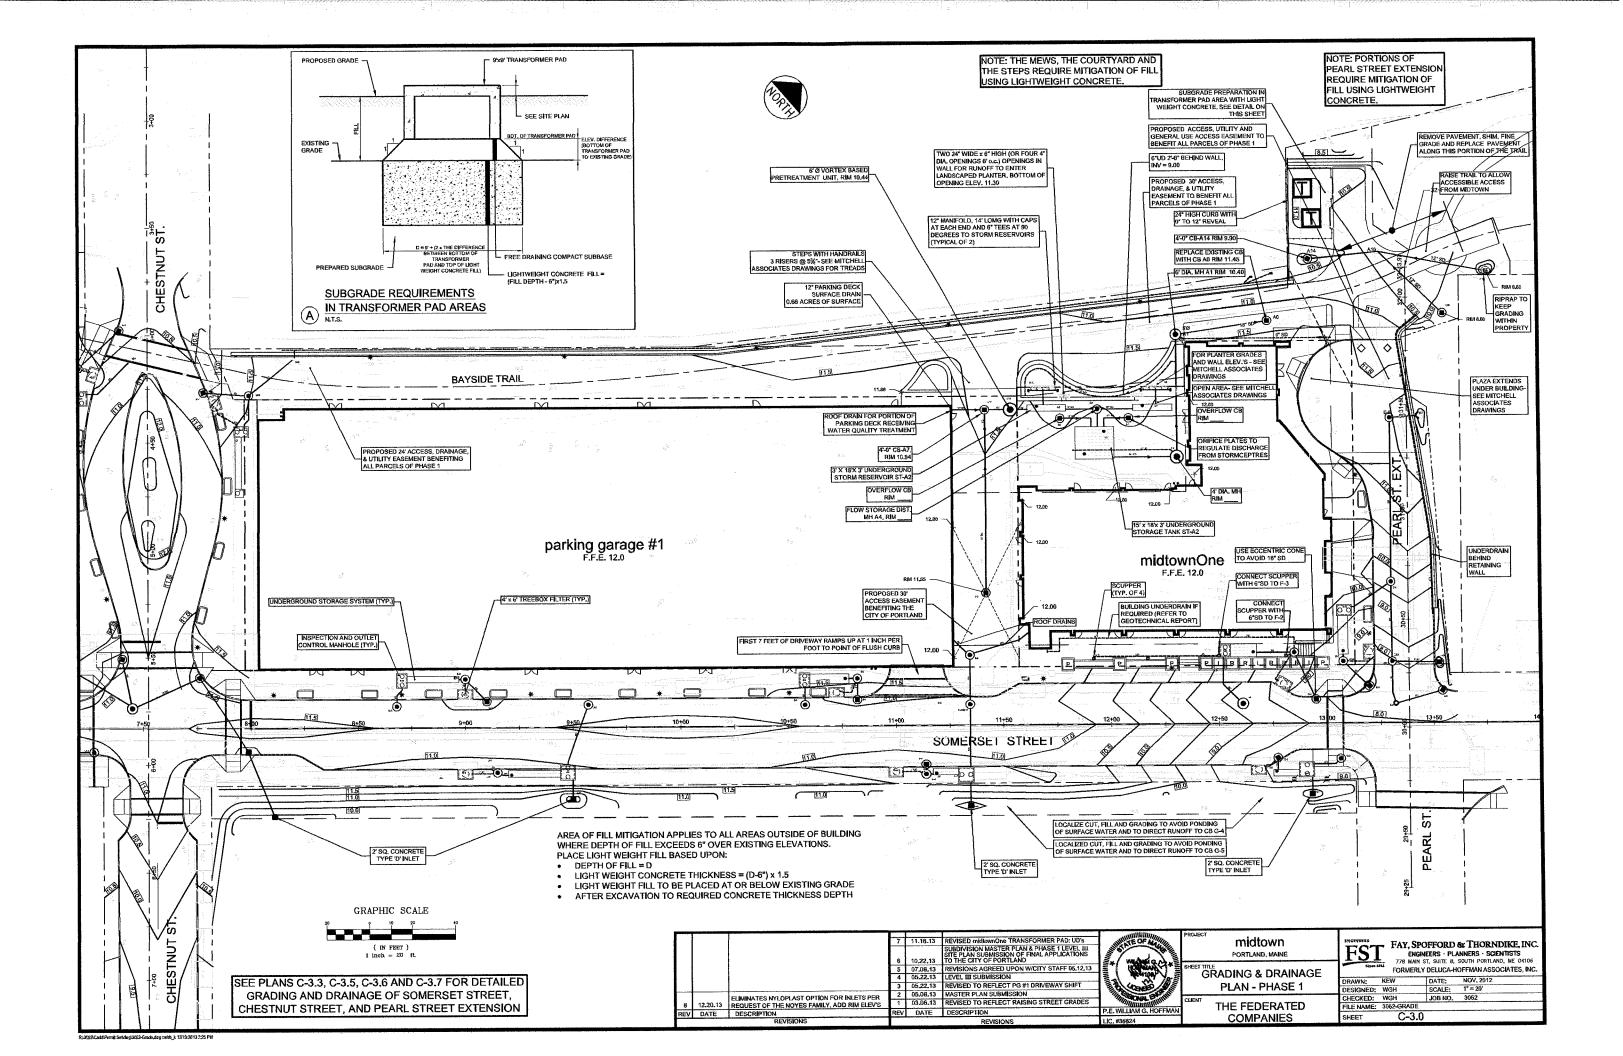

Proposed Somerset Street Elevations and Mass Earthwork Lightweight Concrete is Used After New Dead Load Exceeds 60 lbs./s.f.

Station	Existing Elevation	Design Centerline Elevation	Offset Grown Left of Centerline	Slope from Crown to Edge of Travel Way Left	Elevation at 11' Left	Is there No Parking? If so Add 0.58	Elevetion to 12' Left (.04 Higher Than 11' Left Plus .58 for the Curb)	Average Blope Between Curb and Accessible Route (4 to 6' Off Building)	Elevation 6' in Front of the Building Face (This permits a 246 cross !=stope on a 6"=0" sidewalk area in front of the building per discussions with City staff on 10/22/13).	Left to 19' Left When Parking is Adjacent	Is Curb Incated at 19' left? (Yes=.58; Ne=8)	Elevetion at 19.01' Left	Elevation at 11' Right		Slope From 11' Right to 19' Right		Elevation at Back of Sidewalk When There is No Flush Curb at the Gutter (Sidewalk Cross Slope is 1-24% Up from the Curb - See Davo, C-7.8A)	Statio Elevatio at Gutts n Left	fi Edge of Function a Edge of Parking Left	Elevation at Top or Curb	11 to	Elevation Difference ot Centerlins	Thickness of Lightweig ht Concrete Required	Required After Adjustment for Loveling	Excavetion Valume	Elevation at BOE at Centerline of Right of Way	Added Concrete Dus to Worp of parking		Added Excevation in Ramp Area	Concrete for 25 Foot Section	Amount of Federated Side
																					ļ			l			ļ				
2+25	7.66	7.94		-3.00%	7.61	0.58	6.23	24.13%	11.85	3.00%	0.00	8.97		-3.00% -3.00%	-3.00%		8.07 8.47	2+50 8.81	8.17	9.75	10.06%	0.50	0.00	0.85	50,37		0.00	0.00	0.00		0.00
2+50	7.64	8.34			8.01	0.58	8.63 9.12	20.79% 16.71%	11.86	3.00%	0.00	9.37	8.50	-3.00%	-3.00%	8.22	8.96	2+75 9.50	8,66	9.24	15.33%	1.07	0.96	0.99	58.67		0.00		0.00	0.00	0.80 31.56
2+75 3+00	7.75	8.83 9.36		-3.00% -3.00%	9.50	0.58	9.65	12,29%	11.86	3.00%	8.00	10.39	9.03	-3.08%	~3.00%	8.75			9,19			1.44	2.03	1.55 2.16	91.56	6.38	0.01	1.99		201.96	31.55
3+25	8.05	9.90	0.28	-1.50%	9.74	0.58	10.35	5.30%	11,96	3.50%	0.00	11.22			-3.50% -3.50%		9.51 9.99	3+25 9,57 3+50 10.05	10.33	10.75	6,94%			2.78	164.44	5,35	0.28	1.04	26.04	234.77	36.68
3+50	8.12	10,38	D.28	-1.50%	10.55	0.00	10.25 10.58	6.21% 3.46%	11.86	3,50%	0.58	11.45		-3.00%		9.82	10.32	3+75 10.39	10.66	11.09	5.11%	2.52	3.03	3.17						241.58 253.63	37,75 39,63
3+75 4+00	8.19 8.13	10.71 10.88	D.28 0.33	-1.50% -1.50%	10.72	0.00	10.75	2,04%	11.66	3,50%	0.58	11.62	10.22	-3.00%		9.94		4+00 10.55	10.83	11.25	4.17%	2.75	3,38	3,51		4.62		0.63		266.07	41.57
4+25	7.99	10.88	0.33	-1.50%	10.72	0.00	10.75	2.04%	11.86	3.58%		11.62 11.51	10.22	-3.00% -3.00%	-3,50% -3,50%	9,94	10.44	4+25 10.55 4+50 10.44					3.72		228,44	3.94	0.28	0.00	0.00	237.04	37.04
4+50	7.79	10,77	0.33	-1.50% -1.50%	10.61	0.00	10.64	2.96%	11.86		0.58	11.43		-3.00%	-3.50%	9.75	10.25	44.75 10.36	10.64	11.06	5.22%	3.07	3.86	3.99	.236.44	3.63		0.00		245.04 246.81	38.25 38.55
4+75 5+80	7,62	10.67	0.33	-1.50%		0.00	10.54	3.79%	11.65	3.50%	0.58	11.41	10.06	-3.00%	-3.50%			5+00 10.34 5+25 10.37	10.62	11.04	5,33%	3.09	3.89	4.02	238.22	3.56		0.00	0.00	250.37	39.12
5+25	7.57	10.70	0.28	-1.50%	10.54	0.00	10.57	3.54%	11,86	3,50%				-3.00%	-3.50% -3.50%	9.81	10.31	5+25 10.37 5+50 10.47	10.65	11.17	4.61%	3.13	3.95	4.0B	241.78	3.59	0.28	0.00	0.08	250.37	39.12
5+50	7.67	10.80 10.89	0.28 0.28	-1,50% -1,50%	10.73	0.00	10.76	1.96%	11.86 11.86	3,50%			10.28	-3.00%	-3.50%	10.00	10.50	54.75 ID 56	10.R4	11.26	4.11%	. 3.13	3.95	4.08	241.78	3,68	0.28	0.00		250.37	39.12 37.73
5+75 5+00	7.76	10.99	0.28	-1.50%	10.85	0.00	10.88	0.96%	11.86	3.50%	0.58	11.75		-3.00%	-3.50%	10.03	10,53	6+00 10,59	10.87	11.29	3.94%	3.03	3.80	3.93	232,89	3.96	0.28 0.28	0.00			34.81
6+25	8.07	10.09	0,28	-1.50%	10,92		10.85	1.21%	11.86	3,50%				-3.00% -3.00%	-3.50% -3.50%	10.00	10.50	6+50 10.50		11.16	4,67%	2.54	3.06	3.20	1 189.33	5.06	0.28	1 0.04	0.00	197.93	30.93
6+50	8,25	10.79 10.72	0.28 0.28	-1.50% -1.50%	10.72 10.65		10.75 10.68	2,04%	11.86	3.50%			10.11	-3.00%		9.83	10.33	6+75 10.39	10.67				2.57	2,81			0.28	0.00	0.00	174.81 165.93	27.31 28.93
6+75 7+00	6.44 8.58	10.75	0.28	-1,50%	10,69	0.00	10.72	2.29%	11.86	3.50%	0.58		10.15	-3.00%	-3,50%	9.87		7+00 10.43			4,83%	0.00	2.07	2,66	150 11	5.93 6.02	0.13	0.00	0.00	358.66	24.79
7+25	8.70	10.90		-3.DD%	10.57	B.00	10.61	4.29%	11.86 11.86	3,00%	0.58	11.35	10.57	-3,00%	-3.00%	10.29	11.03	7+25 10.52 7+50 10.83	10.99	11.57	2.39%	2.32	2.73.	2.87	169.78	5.98	0.13	0.00	D.00	169.32	26.46
7+50 In front of Parking Garage #1	FI.64	11.16			10.83	1f.no.enter 0.58	Gutter at 13' Left	Computed Side Walk Slope	Elevation Face of Garage				1	1.000	2.00%	10.01	11.49	7+75 11.05	11.25	11.83	1.2%	2.45	2.93	3.06	153.00	5,91	0.15	0.00		153.79	0.00
7+75	8.97	11.42			11.09	0.58	11,61	1.79% 0.79%	11.86 11.86	3.00%	0.00	11.77 11.91	11.23	-3.00%	-3.00%	10.95	11.63	8+00 11.23	11.39	11.97	0.2%	2.27	2,65	2.79	139.50	6.50	0.15	0.00		140.29	0.00
B+00 B+25	9.29 9.36	11.56 11.60		-3.00% -3.00%	11.23	0.58	11.79	0,50%	11.86	3.00%	0.00	11.95	11,27	-3,00%	-3.00%	10.99	11.67	B+25 11.2			0.4%	2.24	2.51	2.75	137.25 124.50	6.62	0.15 0.15	0.00	0.00		0.00
B+50	9.46	11.53		-3.00%	11.20	0.58	11.72	1,00%	11,86		0.00	11.66	11,20	-3.00% -3.00%	-3,00%	10.92	11.60 11.51	8+50 11.20 8+75 11.11					1.94		103.50			0.00	0.00	104.29	0.00
B+75	9.65	11.44		-3.00% -3.00%	11.11	0.58	11.63 11.59	1.64%	11.86 11.86	3.00%	0.00			-3.00%			11.47	9+00. 11.0	11,23	11.81		1.54	1.56	1.70	84.75			0.00	0.00		0.00
9+00 9+25	9.86 10.06	11.40		-3.00%	11.11	0.58	11.63	1.64%	11.95	3.00%	0.00	11.79	11.11	-3.00%	-3.00%	10.83	11.51	9+25 11.11				1,39	1.32	1,46		9.61		0.00	8.00		0.00
9+50	10.27	11.53		-3.00%	11.20	0.58	11.72	1.00%	11.86	3.00%	0.00	11.88	11.20	-3.00% -3.00%	-3.00%	10.92	11.60	9+50 11.20 9+75 11.20				1.16		1.13		9.34		0.00	0.00		0.08
9+75	10.46	11.62		-3.00%	11.29	0.59	11.01	8,36% 0,07%	11.86 11.86		0.00	12.01	11.33	-3.00%	-3.00%	11.05	11.73	10+00 11.3	11.49	12.07	-0.5%	1.04	0.81			9.68			0.00		0.00
10+00 10+25	10.62 10.60	11.66 11.62		-3.00% -3.00%	11,33	0.59	11.81	0.36%	11.86	3.00%	0.00	11.97	11.29	-3.00%	-3.00%	11.01	11.69	10+25 11.25 10+50 11.25			0.4%	1.02		0.91	45,75	9.69			0.00		9.90
10+50	10.53	11.53		-3,00%	11.20	0.59	11.72	1.00%	11.86		0.00	11.99		-3,00%			11.50 11.48	10+50 11.20 10+75 11.00	11.24	11.82	1,3%	1.04	0.91	0.95	47.25	9.43	0.15	0.00	. 0.00	48,04	0.00
10+75 11+00	10.37	11.41 11.34		-3.00% -3.00%	11.09	0.58 0.58	11.60	1,86% 2,36%	11.86 11.86	3.00%	0.00	11.69	. 11.01	-3,00%	-3.00%	10.73	11.41	11+00 11.0	11.17	11.75	1.8%	1.12	0.93	1.07	53,25	9.16		0.00	0.00		0.00
11+00	10.22	11.49		-3.00%	11.07	0.58	11.59	1.93%	11.86	2.000	0.00	11 75	11.07	-3.00%	-3.00%	10.79	11.47	11+25 11.0 11+50 11.1	11.23	11.81	1.4%	1.33	1.25	1.38	69.00 87.00	8.69				87.79	
11+50	9.92	11.49		-3.00%	11.16	0.58	11.69	1,29%	11.86	3.00%	0.00	11.84	11.16	-3.00%	-3.00%	10.88	11.56	1					l .	0.14						1	
In Parking Near Muse	9,79	11.32	 	-3,00%	10.99	0.58	Gutter at 12' Left 11.61	1.34%	Elev at 31 feet left 11.86	3.00%	0.00	11.77	10.99	-3,00%	-3.00%	10.71	11.39	11+75 10.9	11.15	11.73	1.9%	1.53	1.55	1.68	99.56	8.11	0.13	0.00	0.00	99.10	15.48
11+75	9.79			2,002	*****	1					1					-		 					+	0.14	 	 		1	†		
Separation by Steps.					<u> </u>		Elevation at	19 to 31%	ļ	 	+	+	+	+	 	+	t	1				1		0.74				-			
Landings, Ramps or Planters 12+00	9,40	10.65	 	-3,00%	10.52	0.58	13 feet left 11.15	6.04%	11.86	3,00%	0.00	11,30	10.52	-3.00%	-3.00%	10.24	10.92	12+00 10.5	10.68	11.26	5.3%	1,45	1.43	1.56	92.44	7.84	0.13	0.62	15,42	129.53	20.08
12+25 12+50 12+75	8,98 8,68 8,39	10.12 9.37 8.80		-3.00% -3.00% -3.00%	9,79 9,04 8,47	0.00 0.00 0.00	9,83 9,08 8,51	16.96% 23.21% 27.96%	11.86 11.86 11.86	3,00% 3,00% 3,00%	0.58 0.58	10.57	9.79	-3.00% -3.00% -3.00%	-3.00% -3.00%	9.51 8.76	1,,,,	12+25 9.75 12+50 9.0- 12+75 8.4	9,95 9,20 8,63	10.53 9.78 9.21	15.9%	0.69	0.96 0.29 0.00	1.10 0.42 0.14	54,69 39,00 40,00	7,89 8,26 8,26	0.13 0.13 0.13			137.03 39.00 40.00	
Near Pearl Street Intersection						ļ	<u> </u>		 	 	+		 	+	 		 	1				1									
13+00	8,19	9.42	ļ	-3.00%	8.19	0.50	9 71	17.53%	11.86	3.00%	0.58	9,45	8.09	-3.00%	-3.00%	7.81	8.49		8.25		22.6%				40.00		0.13		70,42	40.00	6.25
13±00 13±25	8.19	8.21		-3.00%	7.68	0.58	8.50	18.69%	11.86	3,00%	0.58	9,24	7.88	-3.00%	-3.00%	7.60	8.28 9.13	13+26 7.95 13+50 7.73	8.04	8,62	24.1%	0.12	0.00	0.85	0.00	7.21	0.13	2.94	73.54		9.00
13+50	8.06	8.06		-3.00%	7.73	D.00	7.77	22.75%	11.86	3.00%	0.00	7.93	7.73	-3.00%	3.00%	J/,95	8,1,7	1.437301 /./.		0,47											

1	6.056.34	Lightweight Congrete (cv)
- 1		Excavation (cv)
- 1	719.95	Binder (tons)
- 1		Surface Payement (tons)
ļ	977.78	Redaim (cv)
. 1		Salvaged Subbase Below Reclaim
-		Required Subbase or Granular Above Wast
1		Deduction for Salvaged Subbase
	1 522 40	Net Subbase

PROPOSED CHESTNUT STREET ELEVATIONS AND MASS EARTHWORK

LIGHTWEIGHT CONCRETE IS USED FOR MITIGATION WHEN NET NEW DEAD LOAD EXCEEDS 60 POUNDS PER CUBIC FOOT.

Station	Existing Elevation	Proposed Elevation at Centerline or Edge of "Eye"	Blops from Centerline or Edge of "Eye" to Gutter	Elevation at Gutter	Curb	Elevetion at Top of Curb	Width of Pavement Each Side of Eye	Distance from Centerline to Curb	Elevation 6' from Face of Building	Excavation (CY)	Lightweight Concrete (CY)	Grade Change	Concrete Thickness	Base Concrete Volume (CY)
3+75	9,92	10,27	-3.00%	9.91	0.58	10.49	12	15,00	11.88	0	. 0	0.35		0.0
4+00	10.00	10.62	-2.80%	10.30	0.58	10.68	. 16	14.00	12.88		0	0.62		
4+25	10.27	10.97	~2.00%	10.59	0.58	11.17	. 19	23,50	11.88	0		0.70		
4+S0	10.42	11.30	-2.00%	10.94	0.58	11.52	18	29.00	11.88		- 11	0.69		
4+75	.10.19	11.54	-2.00%	11.1B	0.58	11.76	18	31,50	11.00	116	116	1.35		
5+00	9.43	11.68	-2.00%	11.30	0.58	11.66	19	23,50	11.88	319	319	2.25		
5+25	8.60	11.72	-2,50%	11.25	0.50	11.83	19	19.00	11.88	515	515	3.12		
5+50	8,56	11.66	~3.00%	11.27	0.58	11,85	13	16,00	11.88	510	510	3.10	3.90	343.1
			T						<u> </u>					
6+25	8.89	10.90	-3.00%	10.66	0.58	11.24		17.00	11.89	265	265	2.01	2.27	104.9
6+50	9.16	10.44	-3,00%	10.20	0.58	10.78		17.00	11.89	101	101	1.28		
5+75	9,26	9.98	-3.00%	9.74	0.58	10.32		17.00	11.88			0.72		
7+00	9,40	9.70	-3.00%	9.46	0.59	10.04		17.00	11.68	1		0.30	L	1 0.0

	Eim Street	Somerset Street	Chestnut Street	Total
Excavation (CY)	75	6,364	***** **	
Lightweight Concrete (CY)	75	6,056	***** **	****
Reclaim (CY)		978	185	*****
Salvage Subbase (CY)	0	978	185	*****
Binder Pavement (tons)	0	720	. 96	816
Surface Pavement (tons)	0	360	57	417
Subbase (CY)	g	1.522	***** **	20000 B
Grind or Reshap Surface (SY)	974		630	*****
Shim and Overlay (tons)	190		120	310


The quantities shown on this drawing are for the use of FST only. Do Not Use for Contract Pricing


REVISED DECEMBER 20, 2013 FOR MODIFIED X-SECTIONS BETWEEN STA. 3+25 TO 7+20


REVISED OCTOBER 29, 2013 For 2% Cross Slope Within 6' of Building and to Add Other Quantities

SUBMITTED 10.22.2013 SUBDIVISION, MASTER PLAN & PHASE 1 LEVEL 3 SITE PLAN SUBMISSION OF FINAL APPLICATIONS TO THE CITY OF PORTLAND

SHEET C-3.9 DATA SUMMARY SHEET FOR SOMERSET AND CHESTNUT STREETS

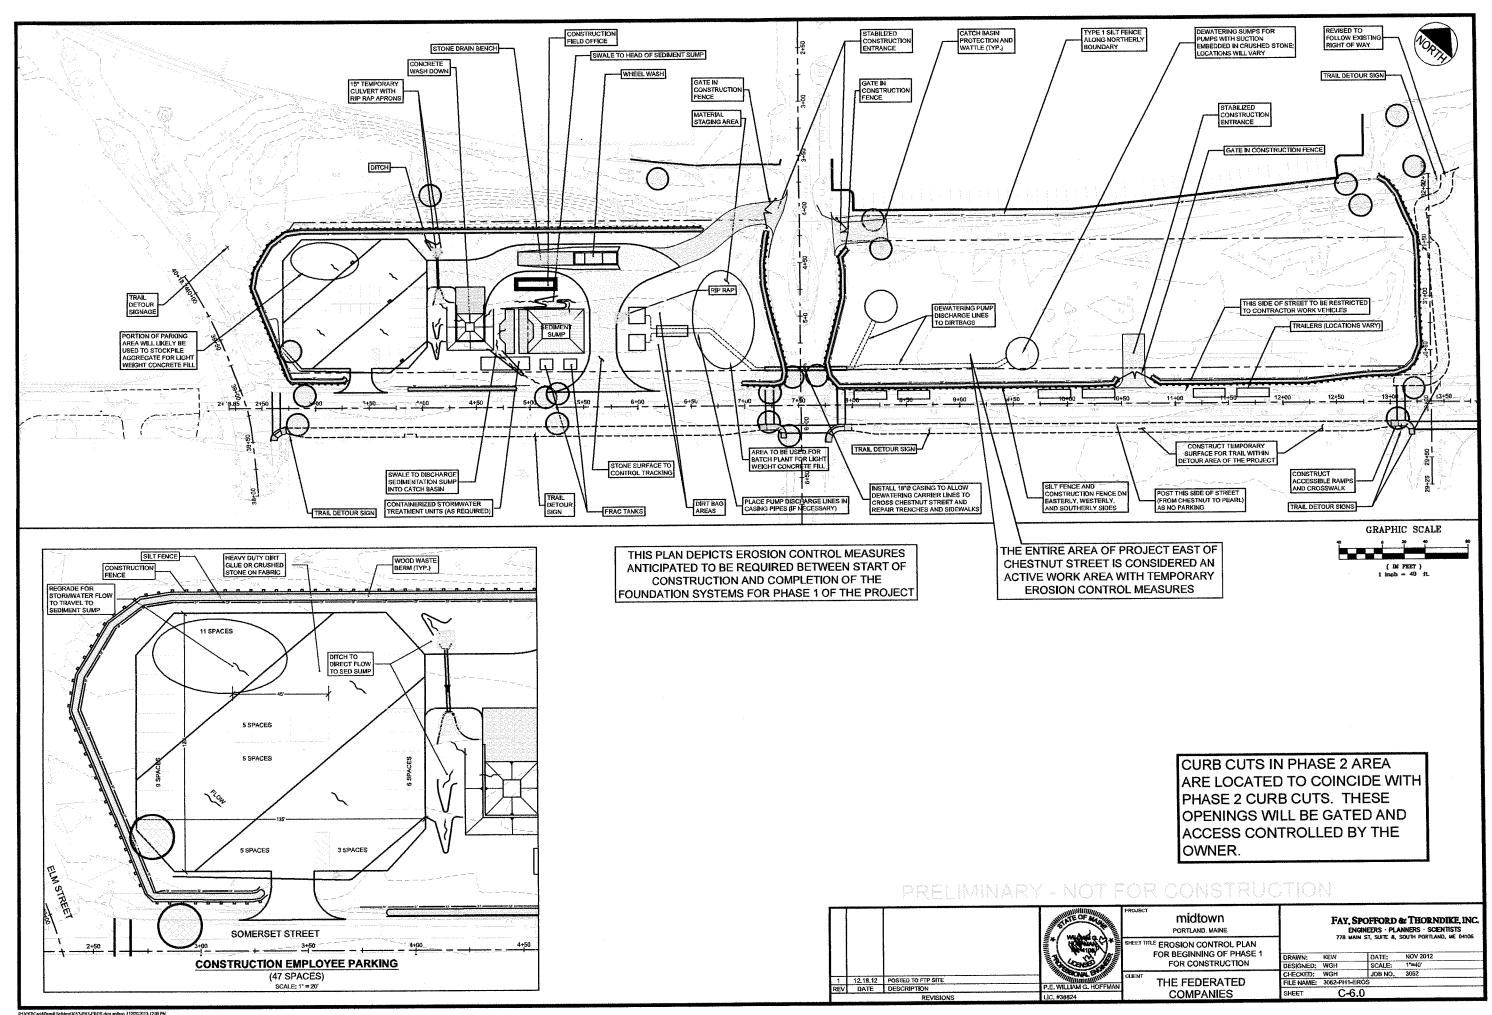

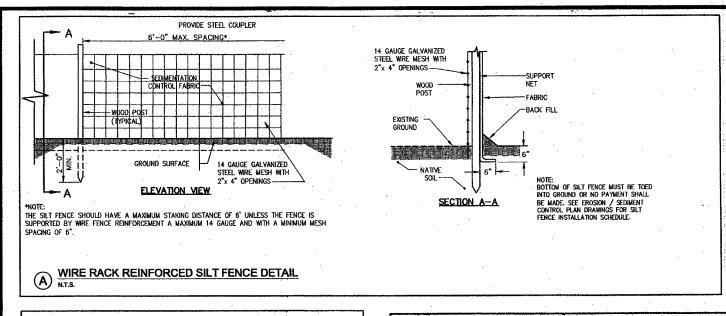

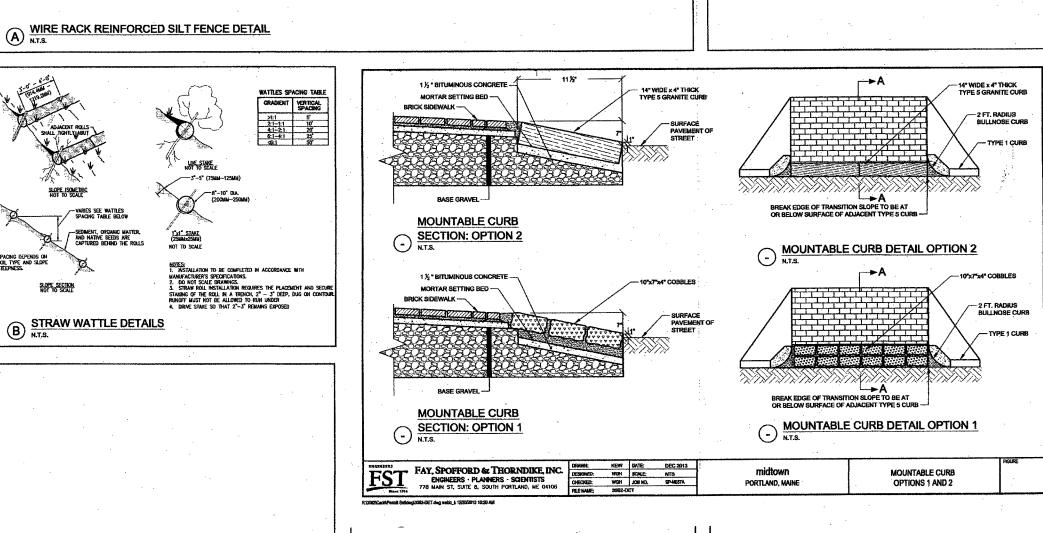

:

SUBDIVISION MASTER PLAN & PHASE 1 LEVEL III
STE PLAN SUBMISSION OF FINAL APPLICATIONS
10.22.13 TO THE CITY OF PORTLAND
3 07.06.13 REVISIONS AGREED UPON WICHTY STAFF 06.12.13
2 05.22.13 LEVEL III SUBMISSION
1 05.06.13 SUBMITTED TO CITY OF PORTLAND
REV DATE DESCRIPTION

WHIT WAS

E. WILLIAM G. HOFFMA

MIDITION
PORTLAND, MAINE

EROSION CONTROL AND
MOUNTABLE CURB DETAILS

THE FEDERATED COMPANIES

FAY, SPOFFORD & THORNDIKE, INC.


ENGINEERS - PLANNERS - SCIENTSS


THORNDIKE, INC.


ENGINEERS - PLANNERS - SCIENTSS

FORMERLY DELUCA-HOFFMAN ASSOCIATES, INC.

DRAWN: KEW DATE: NOV 2012
DESIGNED: WGH SCALE: N.T.S.
CHECKED: WGH JOB NO. 3062
FILE NAME: 3150-DET EROS
SHEET C-6.3

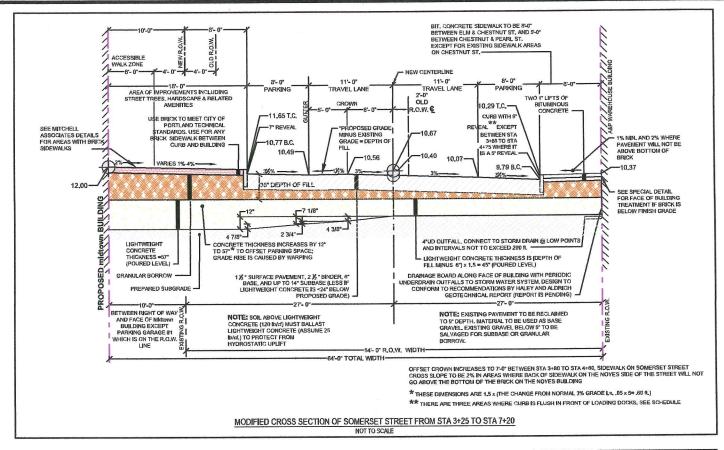

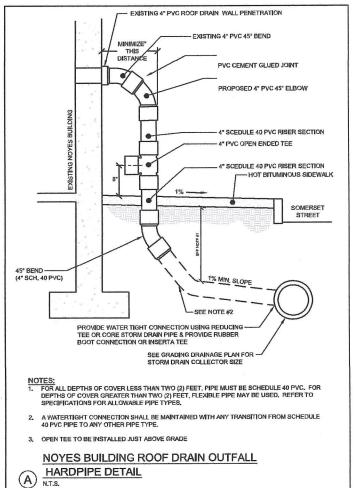

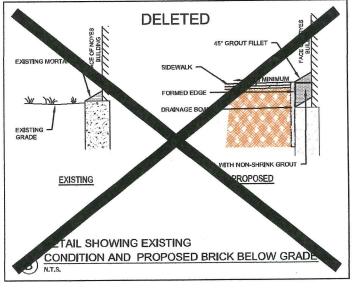

STATION T	O STATION	CURB TYPE
3+71	3+82	TIPDOWN
3+82	3+94	FLUSH CURB IN FRONT OF LOADING DOCK 4
3+94	4+05	TIPDOWN
6+39	6+50	TIPDOWN
6+50	6+62	FLUSH CURB IN FRONT OF LOADING DOCK 11
6+62	6+73	TIPDOWN
6+82	6+93	TIPDOWN
6+93	7+05	FLUSH CURB IN FRONT OF LOADING DOCK 12


7+05 7+16 TIPDOWN

Station	Normal Centerline Grade	11' Left	19' Left	31' Left	Average Grade 19' to 31' Left	Grade 31' Left to Building (37' Left)	Condition
3+50	10.38	10.22	11.18	11.88	5.83%	2.00%	Mountable Curb at Service Entrance
3+75	10.70	10.54	11.44	11.88	3.71%	2.00%	Parking
4+00	10,86	10,70	11.02	11,88	2,38%	2.00%	Landscape
4+25	10,85	10,69	11.01	11.88	2.46%	2.00%	Parking
4+50	10,73	10,57	10,89	11.88	3,46%	2,00%	Parking
4+75	10,63	10.47	10.79	11,88	4.29%	2.00%	Parking
5+00	10,61	10.45	10.77	11.88	4.46%	2,00%	Parking
5+25	10,65	10.49	10,81	11.88	4,12%	2,00%	Landscape
5+50	10.76	10.60	11.50	11.88	3.21%	2.00%	Landscapa
5+75	10,87	10.71	11.61	11.88	2,29%	2.00%	Landscape
6+00	10.91	10.75	11.72	11,88	1,33%	2,00%	Mountable Curb at Service Entrance
6+25	10,89	10.73	11.05	11.88	2.12%	2.00%	Parking
6+50	10.80	10.64	18.96	11,88	2.87%	2.00%	Landscape
6+75	10.72	10,56	10,88	11.88	3,54%	2.00%	Parking
7+00	10.76	10.60	11,50	11.88	3.21%	2.00%	Landscape
7+25	10,90	10.74	11.06	11.88	6,83%	2,00%	ADA Ramp

Somerset Street Station	Old Centerline (Nov. 2013)	New Centerline (Normal)	6' Offset Crown	Grade at 11' Right	Gutter at 19' Right	Top of Curb Right	Bottom of Brick	Grade at Face of the Noyes Building	Distance from Bottom of Brick to Sidewalk Grade (in.)	Centerline Elevation with Offset Crown	Curb at Gutter
3+50	10,81	10,38	0.27	9.78	9,50	10,00	10.65	10.08	6,84	10,11	Flush
3+75	11.21	10.70	0.27	10.10	9.82	10.32	10.57	10,40	2.04	10,43	6"
4+00	11.41	10,86	0,32	10,21	9.93	10,35	10,52	10,43	1,08	10,54	5"
4+25	11,42	10,85	0,32	10,20	9,92	10,34	10,51	10,42	1,08	10,53	5"
4+50	11.30	10.73	0.32	10.08	9.80	10.22	10.49	10.30	2.28	10.41	5 ⁿ
4+75	11.21	10,63	0,32	9,98	9,70	10.12	10,63	10,20	5,16	10,31	5"
5+00	11.18	10.61	0.27	10.01	9.73	10.23	10.64	10.31	3.96	10.34	6"
5+25	11.21	10.65	0.27	10.05	9,77	10,27	10,68	10,35	3,96	10,38	6"
5+50	11,30	10.76	0.27	10,16	9.88	10.38	10,74	10,46	3,36	10,49	6"
5+75	11.39	10.87	0.27	10.27	9.99	10.49	10.86	10.57	3,48	10.60	6"
6+00	11,42	10,91	0.27	10.31	10,03	10,53	10,86	10.61	3,00	10,64	6"
6+25	11.39	10.89	0.27	10,29	10,01	10.51	10.85	10.59	3.12	10.62	6"
6+50	11,30	10,80	0,27	10.20	9,92	9.92	10.90	10,00	10.80	10,53	Flush
6+75	11,21	10.72	0.27	10.12	9.84	10.34	10.96	10.42	6.48	10.45	6"
7+00	11.20	10.76	0.27	10.16	9.88	9.88	11.02	9.96	12.72	10,49	Flush
7+25	11.26	10,90	0,00	10,57	10,29	10,79	11.02	10,87	1,80	10,90	6°
	in the drawing set					1	778 MAIN S	ORD AND THORN STREET, SUITE 8 RTLAND, ME 0410			

		SUM	IMARY OF GR	ADES ALONG N	IOYES LOADING	DOCKS			
DESCRIPTION	LOCATION	DOCK ELEVATION	PROPOSED ELEVATION	DIFFERENCE BETWEEN DOCK AND FINISH GRADE (INCHES)	MEASURED DOCK TO BOTTOM OF BRICK (INCHES)	ELEVATION OF BOTTOM OF BRICK	IS PROPOSED GRADE HIGHER THAN BOTTOM OF BRICK?	CONDITION	DISTANCE BETWEEN BRICK AND PROPOSED GRADE (INCHES)
DOCK 1	STATION 2+97.5 - 3+05.4	11.60	10.11	17.88	11	10.68	No	6" Curb	6.9
DOCK 2	STATION 3+19.4 - 3+31.3	11,65	10,31	16.08	12	10.65	No	6" Curb	4.1
DOCK 3	STATION 3+43,3 - 3+51,3	11.65	10,27	16.56	12	10,65	No	6" Curb	4,6
DOCK 4	STATION 3+82.7 - 3+94.1	11.61	10.13	17.76	13	10.53	No	Flush Curb	4.8
DOCK 5	STATION 4+37,5 - 4+52,2	11.49	10.46	12,36	12	10,49	Yes	5" Curb	0,4
DOCK 6	STATION 4+59.5 - 4+71.6	11.49	10.42	12.84	12	10.49	Yes	5" Curb	8,0
DOCK 7	STATION 4+81.5 - 4+93.3	11.46	10.33	13,56	10	10,63	No	6" Curb	'3.6
DOCK 8	STATION 5+42.6 - 5+54.5	11.63	10.45	14.16	9	10,88	No	6" Curb	5.2
DOCK 9	STATION 5+85.5 - 5+97.6	11.72	10,63	13.08	10	10.89	No	6" Curb	3.1
DOCK 10	STATION 6+04,9 - 6+08,0	11.72	10,63	13,08	11	10,80	No	6" Curb	2.1
DOCK 11	STATION 6+50.0 - 6+62.1	10,90	9.90	12.00	ū	10.90	No	Flush Curb	12.0
DOCK 12	STATION 6+92.9 - 7+05.0	11,02	9.99	12.36	0	11.02	No	Flush Curb	12.4
		L		L	 		FAY, SPOFFORD & THORNDIKE		
							778 Main Stre	et, Suite 8	
						†	South Portlan	d, ME 04106	

NOTE: SECTIONS ARE SUBJECT TO RECEIPT AND FINAL REVIEW OF THE GEOTECHNICAL REPORT FOR THE FEDERATED COMPANIES

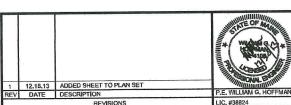


midtown


PORTLAND, MAINE
SHEET TITLE
MISCELLANEOUS SECTIONS
AND DETAILS

THE FEDERATED COMPANIES


FAY, SPORFORD & THORNDIKE, INC.
ENGNEERS - PLANNERS - SCENTISTS
778 MAIN ST, SUITE 8, SOUTH PORTLAD, NE O4108
FORMERLY DELUCA-HOFFMAN ASSOCIATES, INC.


PRELIMINARY - NOT FOR CONSTRUCTION

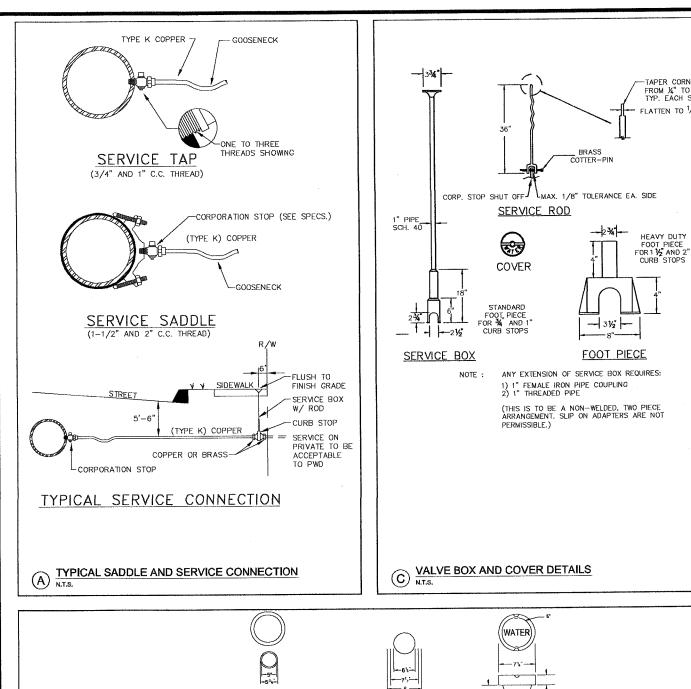


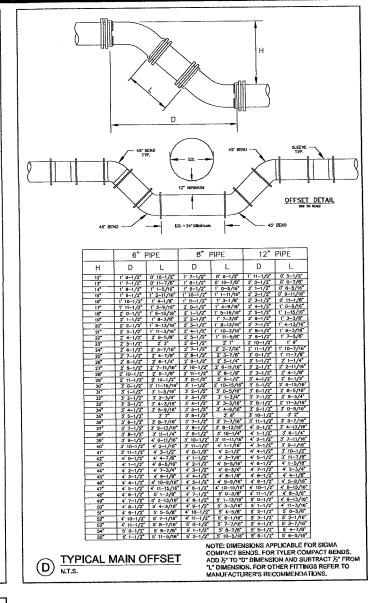



TAPER CORNERS FROM ¼" TO ൃ6" TYP. EACH SIDE FLATTEN TO 1/4

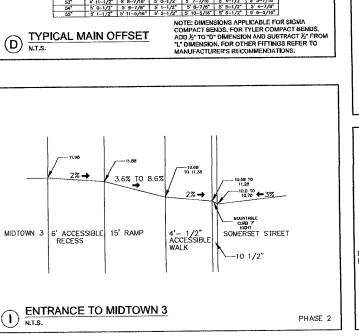


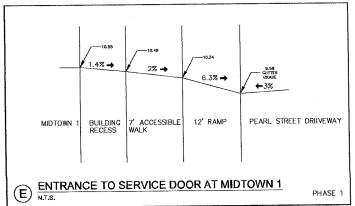


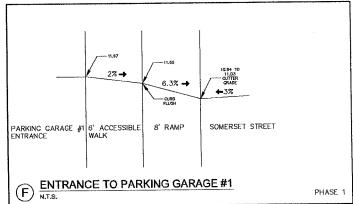

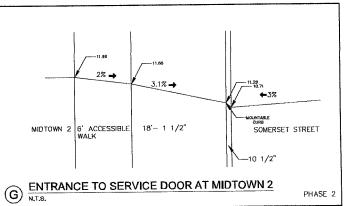

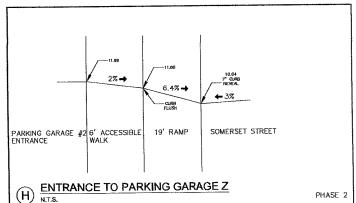

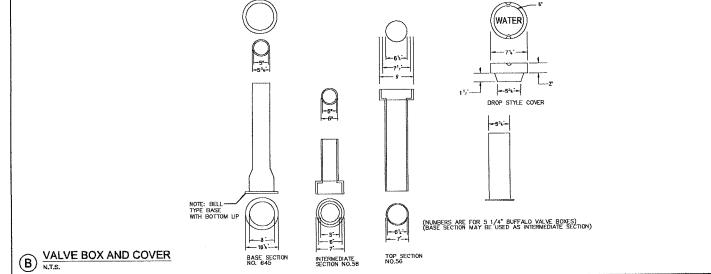

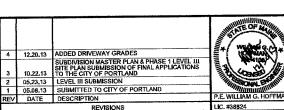



midtown


PORTLAND, MAINE WATER DETAILS AND CROSS SECTIONS AT MIDTOWN DRIVEWAYS


> THE FEDERATED **COMPANIES**


FST FAY, SPOFFORD & THORNDIKE, INC. ENGINEERS - PLANNERS - SCIENTISTS 778 MAIN ST, SUITE 8, SOUTH PORTLAND, ME 04108 FORMERLY DELUCA-HOFFMAN ASSOCIATES, INC. DATE: APRIL 2013 SCALE: NTS DESIGNED: WGH CHECKED: WGH CHECKED: WGH JOB NO. 3062 FILE NAME: 3062-DETAIL SHEETS C-7.5

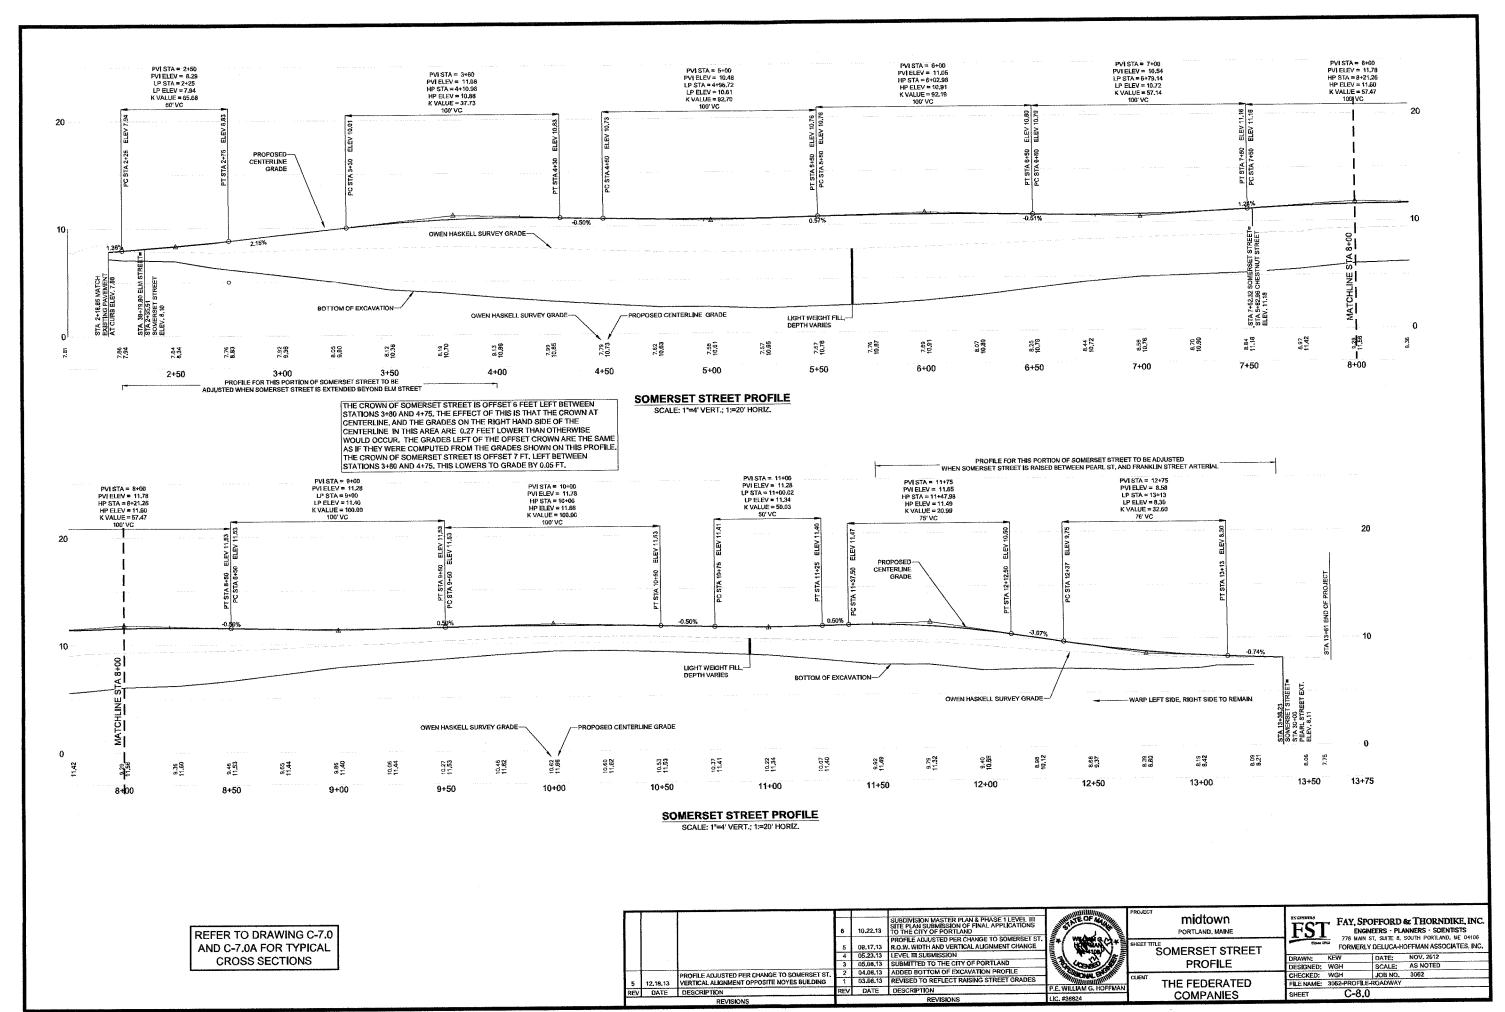


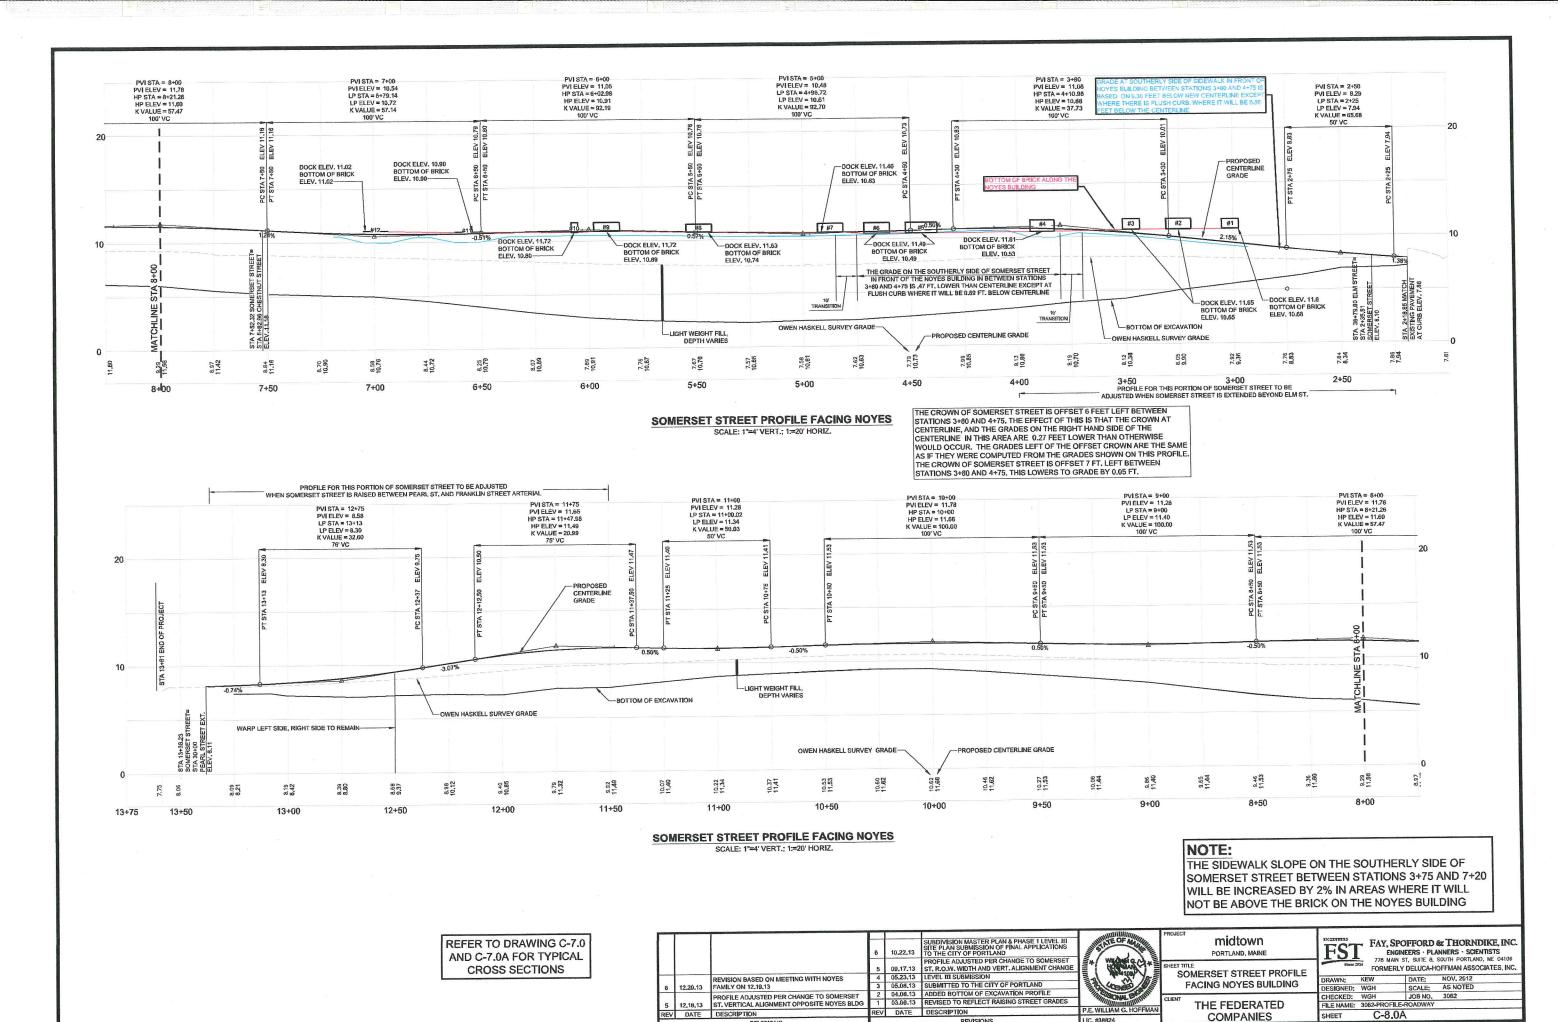


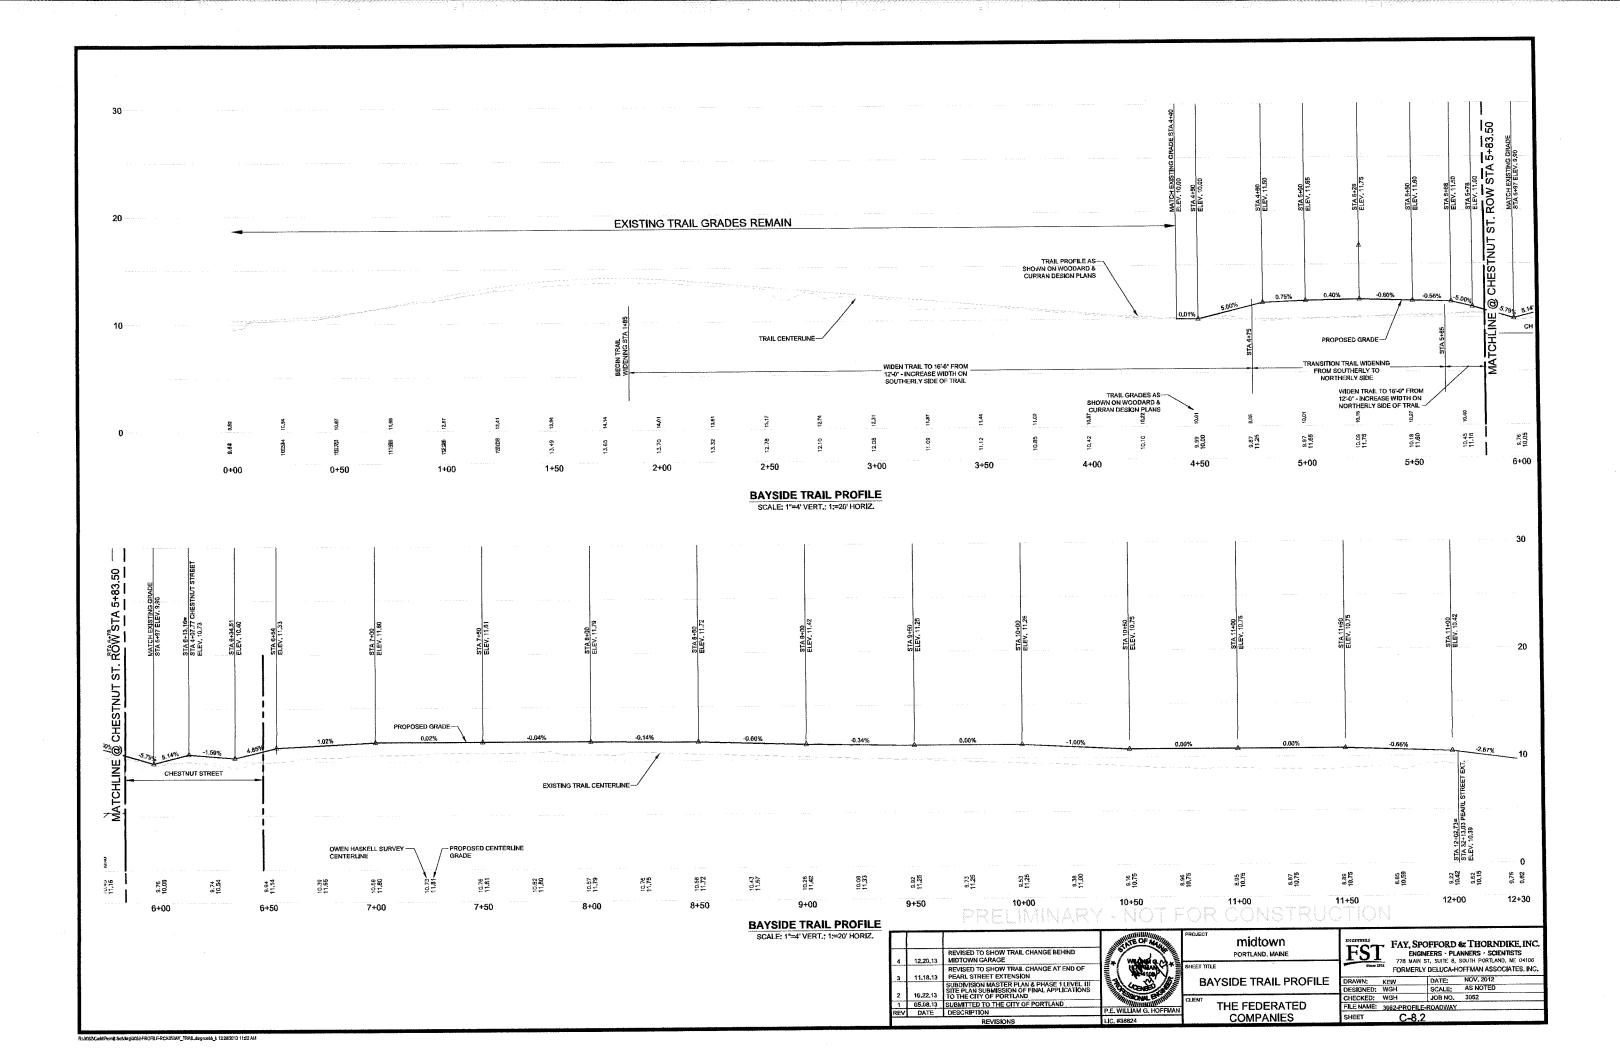


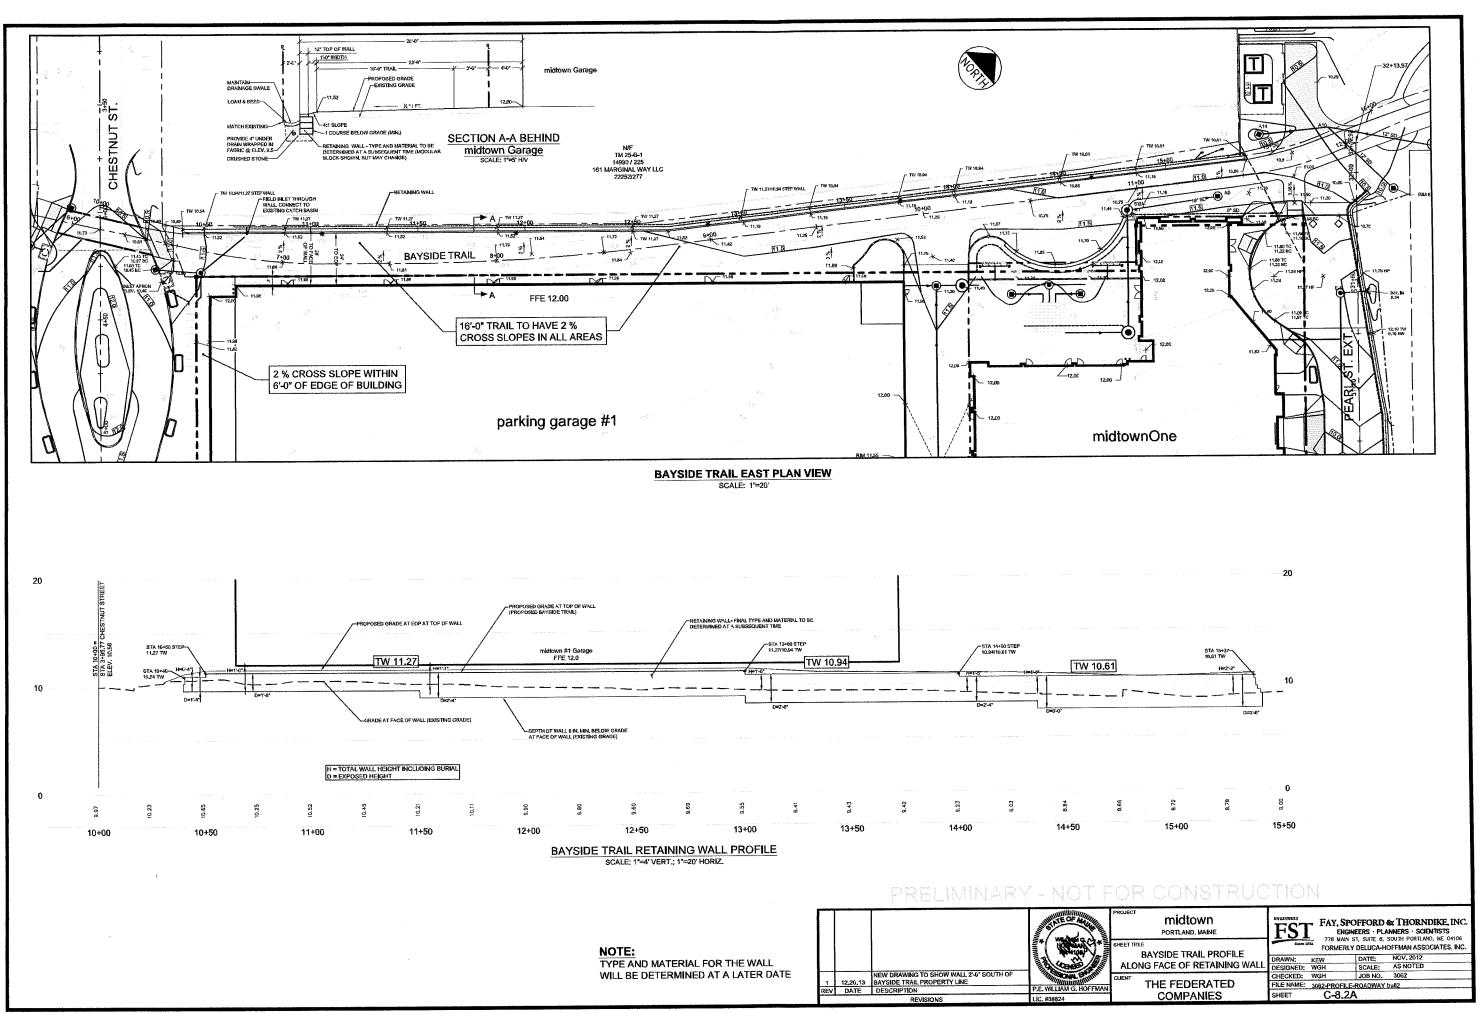

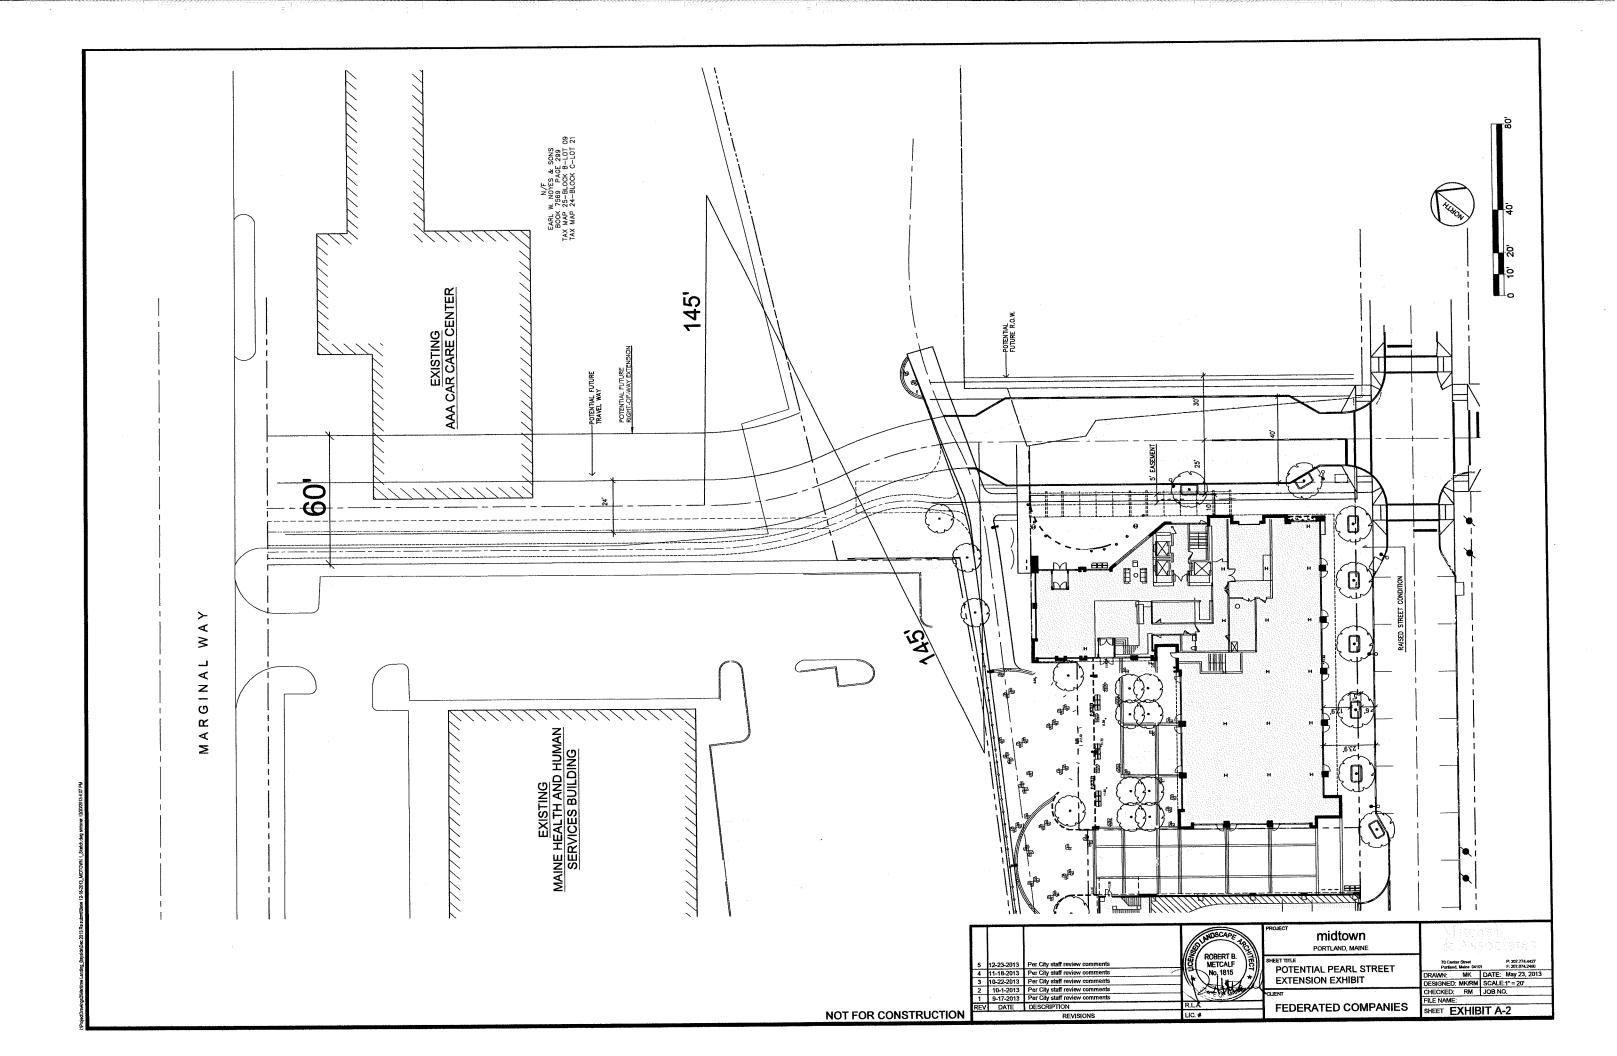

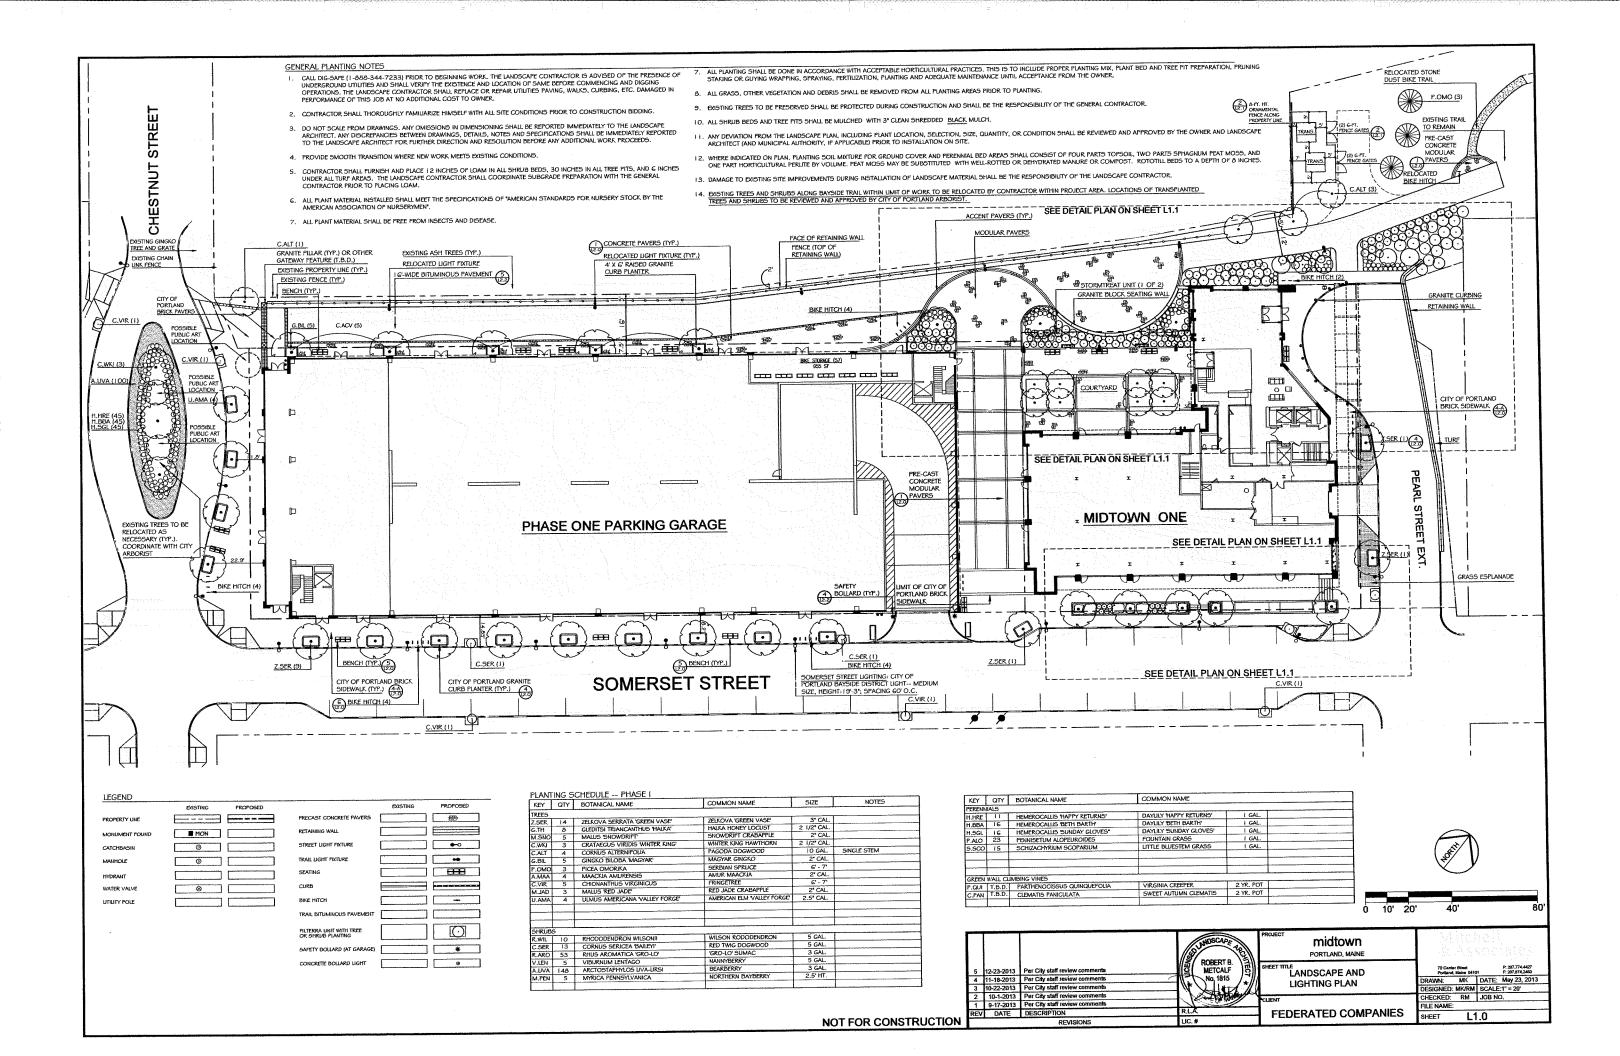

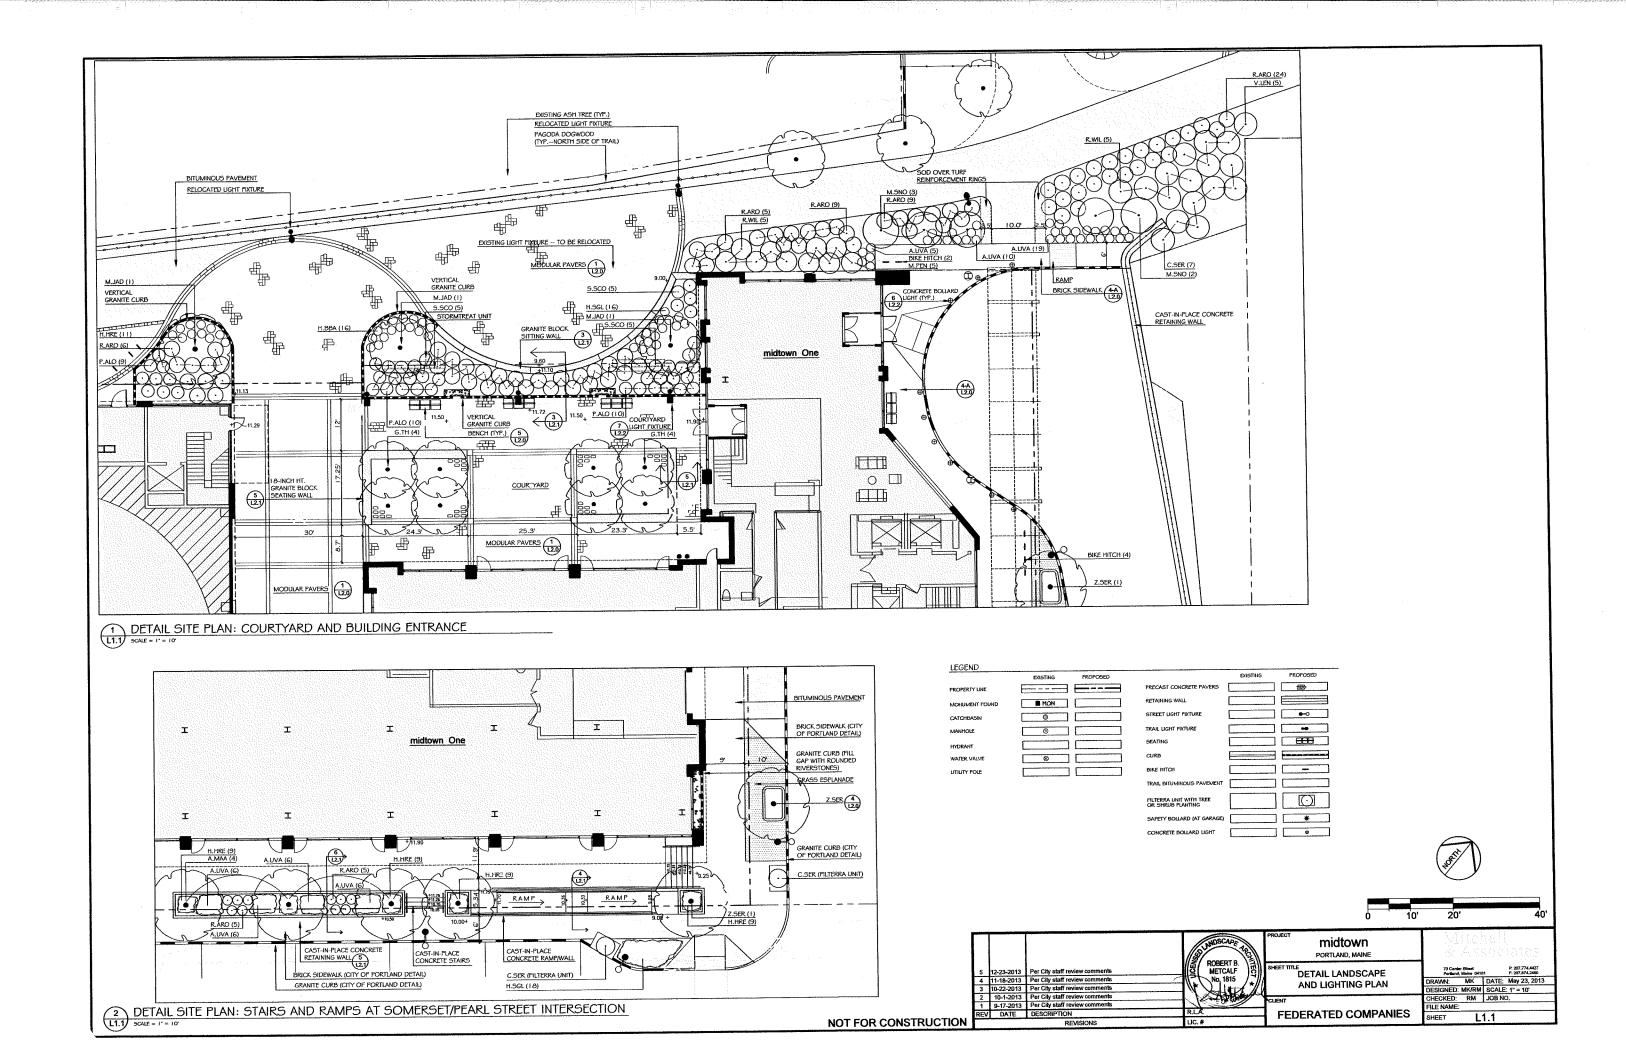

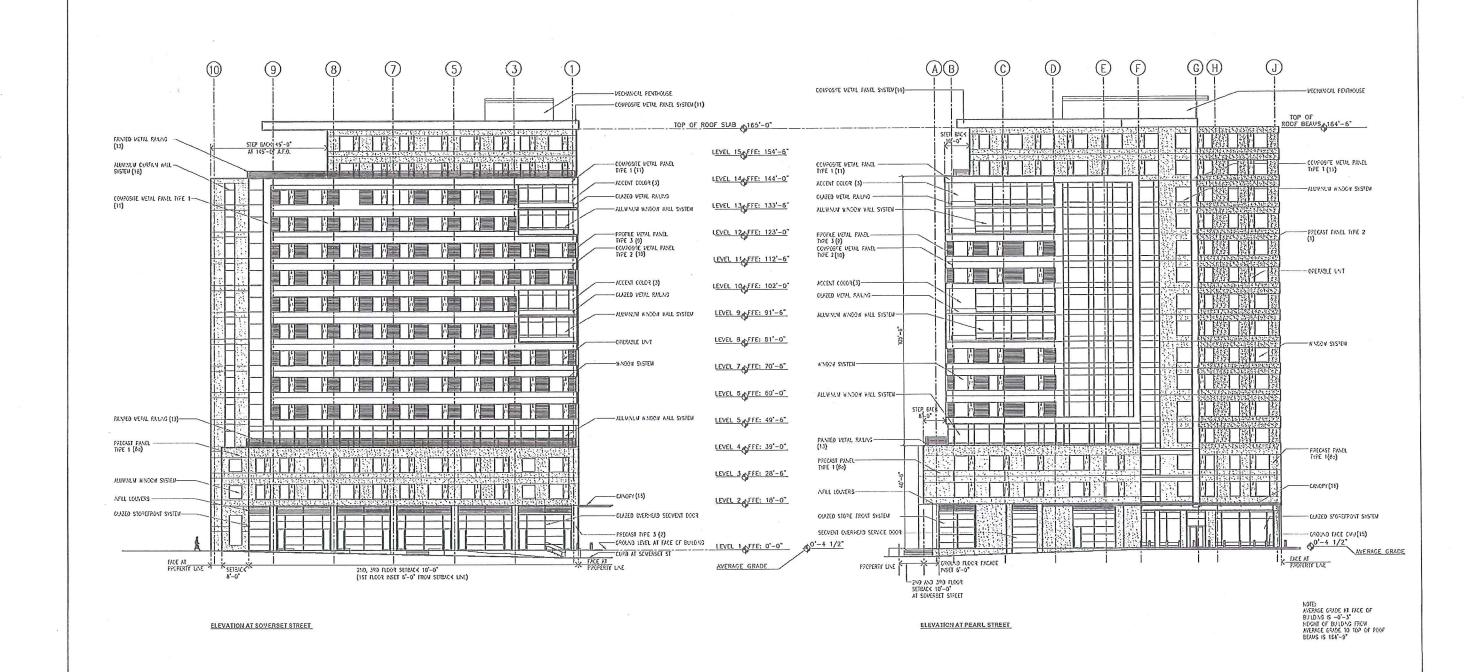

REVISIONS # DATE DESCRIPTION M

1000/1/3 not for construction Per

midtown One - Phase I - Apartment Building

Portland, ME

617 262 4354 obtarch/tects.com 110 canal street boston, ma 02114


shinberg CWS ARCHITECTS

elevations -1

CALE P. (16°=1'-0' 13

PROJECT # DATE ISSU 135070 00 11.01 2013

A20'

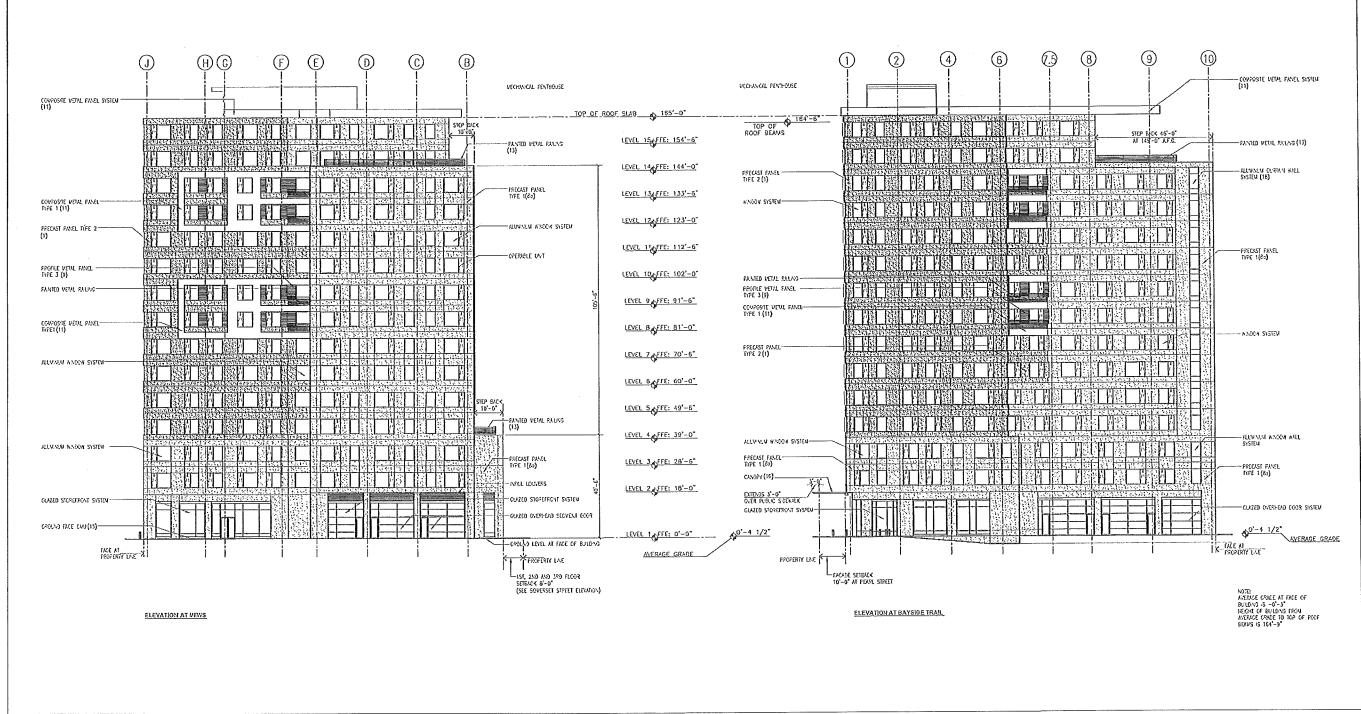


REVISIONS # DATE DESCRIPTION midtown One - Phase I - Apartment Building 10/01/13 not for construction

617 262 4354 obtarchitects.com 110 canal street boston, ma 02114

shinking CWS ARCHITECTS

elevations -2


PROJECT# DATE ISSUED 135070.00 11.012013

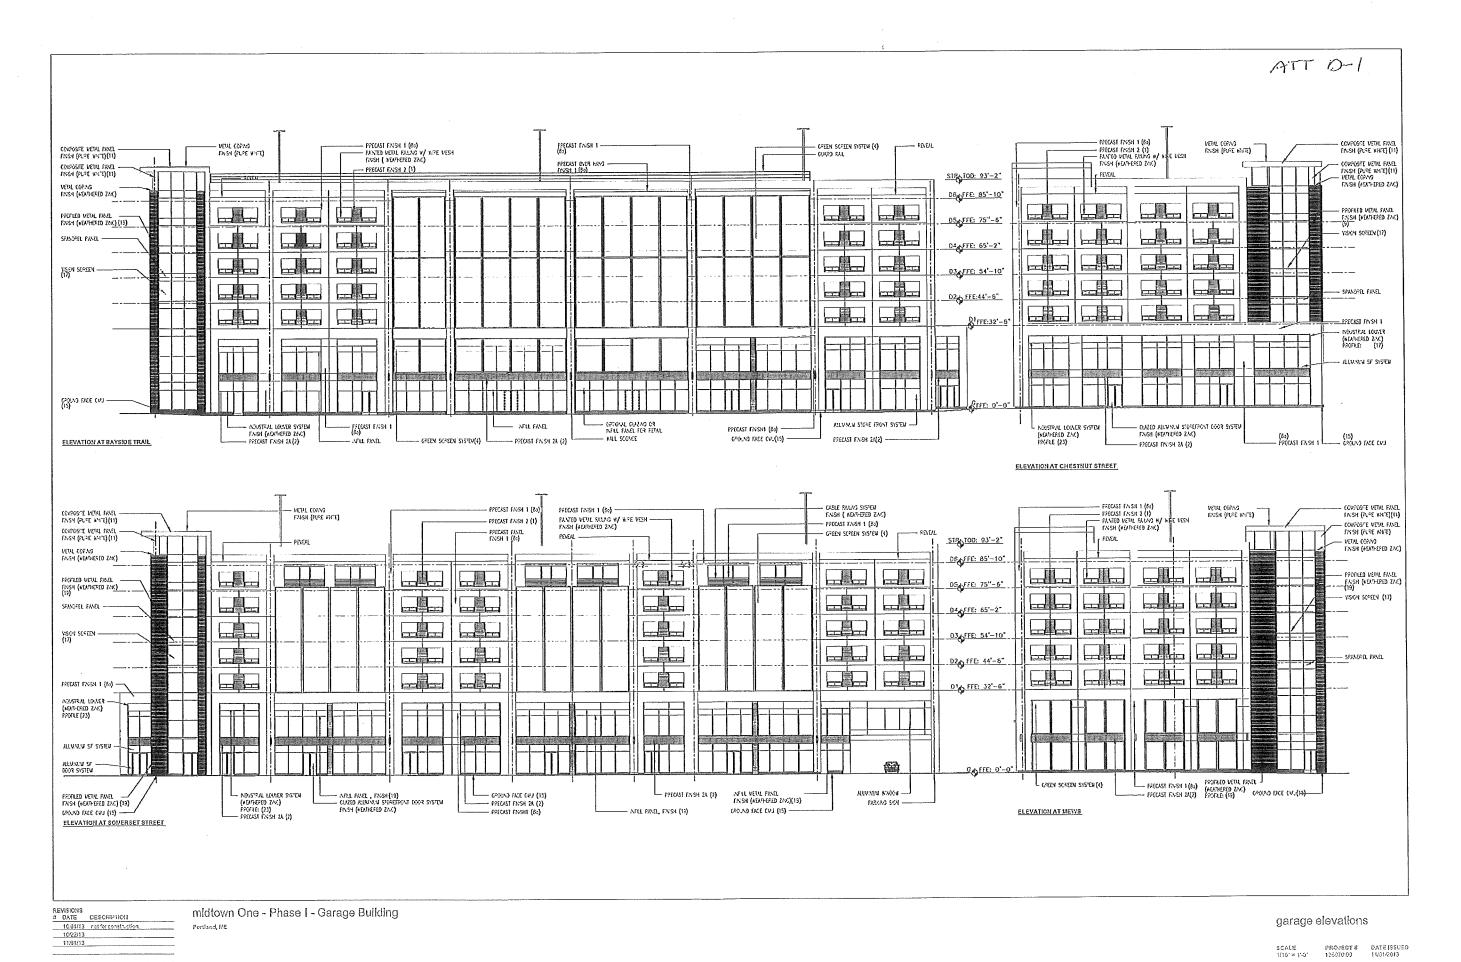

617 262 4354 obtarchitects.com 110 canal streat boston, ma 02114

shinberg CWS ARCHITECTS

A201

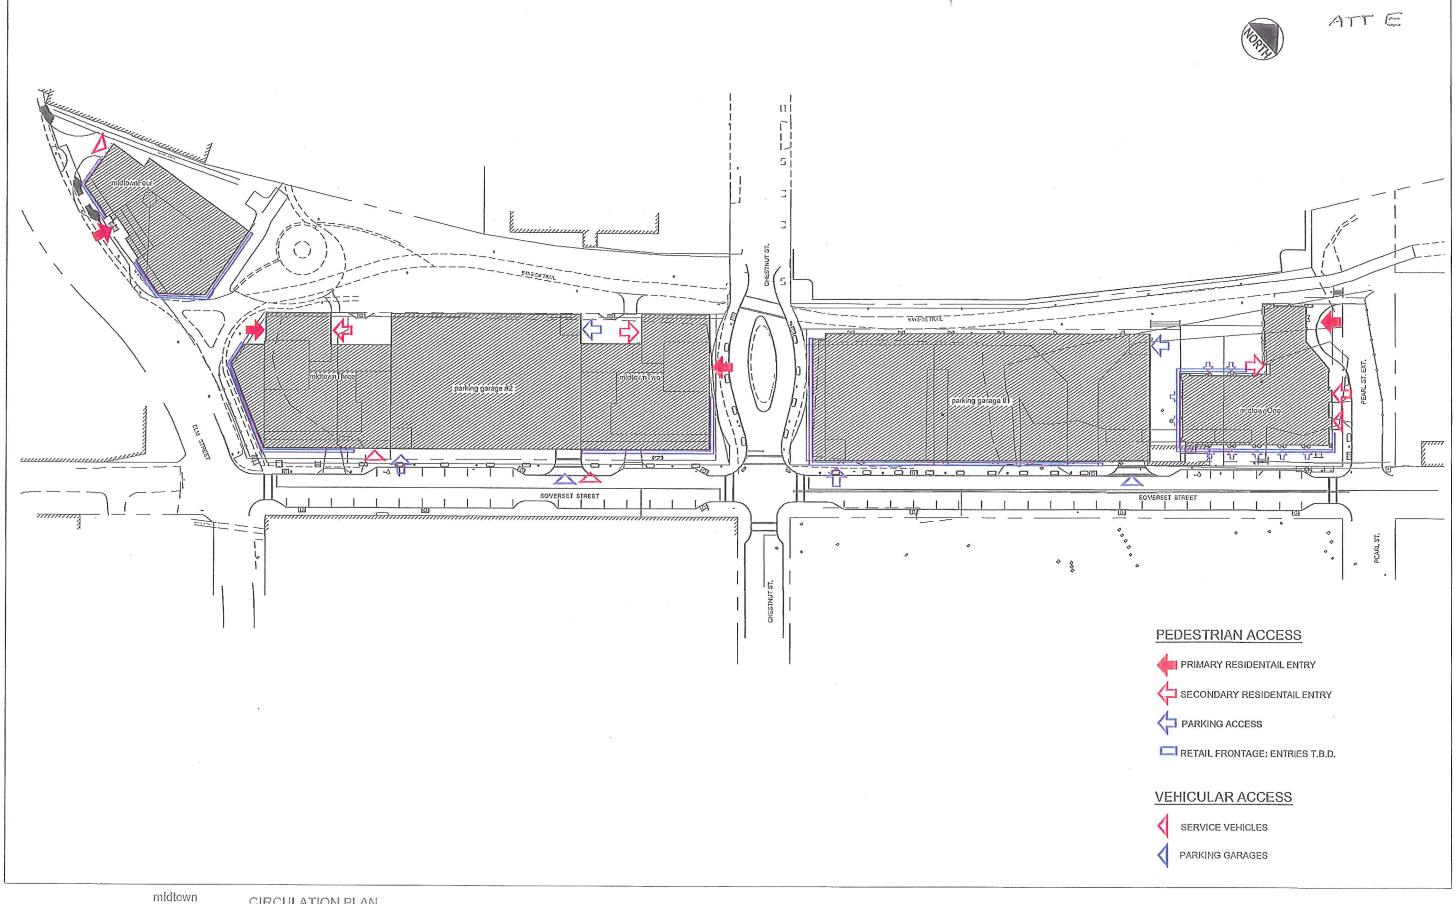

CIRCULATION PLAN

PROJECT# DATE ISSUED 13:070,00