


NOTES:

- FOR GENERAL NOTES SEE S6001
- TYPICAL DECK: CONCRETE SLAB ON 2W120 GALV. COMPOSITE DECK. REINF. 6x6-W2.1AW2.1. TOTAL FLOOR DECK THICKNESS 6 1/2". T.O. CONC. DECK EL. 44'-10".
- THE CONCRETE DECK THICKNESS SHALL BE INCREASED IF REQUIRED TO COMPENSATE FOR BEAM DEFLECTION DURING CONCRETE POUR.
- T.O.S. EL. 44'-3 1/2" TYP. U.N.O.
- REACTIONS, INDICATED XXX, ARE PROVIDED AT END OF MEMBER. REINFORCING BARS SHALL BE WELDED TO CONCRETE SLAB FOR CONNECTION DESIGN. SEE S6001 FOR ADD'L REQUIREMENTS.
- NUMBERS IN BRACKETS SHOWN THRU [] INDICATE THE REQUIRED NUMBER OF STEEL CONNECTIONS. CONNECTIONS SHALL BE FIELD WELDED TO THE BEAM TOP FLANGE. SPACE UNIFORMLY ALONG SPAN. SEE S6001 FOR REQUIREMENTS.
- "c-x" DESIGNATES REQUIRED CAMBER AT MIDSPAN.
- SHADED AREAS SHOW RECESSED CONCRETE DECK & SHOWERS. REFER TO ARCH. DRAWINGS FOR RECESSED AREA DIMENSIONS.
- SURFICIAL LIGHT SUPPORT BEAM. REFER TO DWG. SF505 FOR ADD'L INFO. LIGHT LOCATIONS SHOWN ARE APPROXIMATE. C.C. SHALL COORDINATE EXACT LOCATIONS W/ ARCHITECTURAL DRAWINGS.

REV.	ISSUED FOR CONSTRUCTION	DESCRIPTION	DATE
0			9-19-06

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9-19-06

CURRENT ISSUE STATUS:

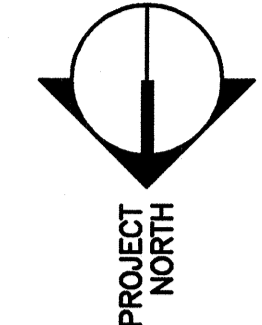

S.M. R.T.
ARCHITECTURE ENGINEERING PLANNING
141 Fore Street P.O. Box 618
Portland, Maine 04104
tel. (207) 772-3846
fax. (207) 772-1070


MERCY HOSPITAL AT FORE RIVER
PROJECT 2
LOCATION

LEVEL 4
FLOOR FRAMING PLAN

SHEET TITLE: AS NOTED DATE: 9-19-06
PROJECT MANAGER: ELB GRAPHIC SCALE: 1"=10'-0"

JOB CAP/DESIGN: HCC
A/E OF RECORD: JSW
SHEET NO. SF104

PROJECT NO. 05034

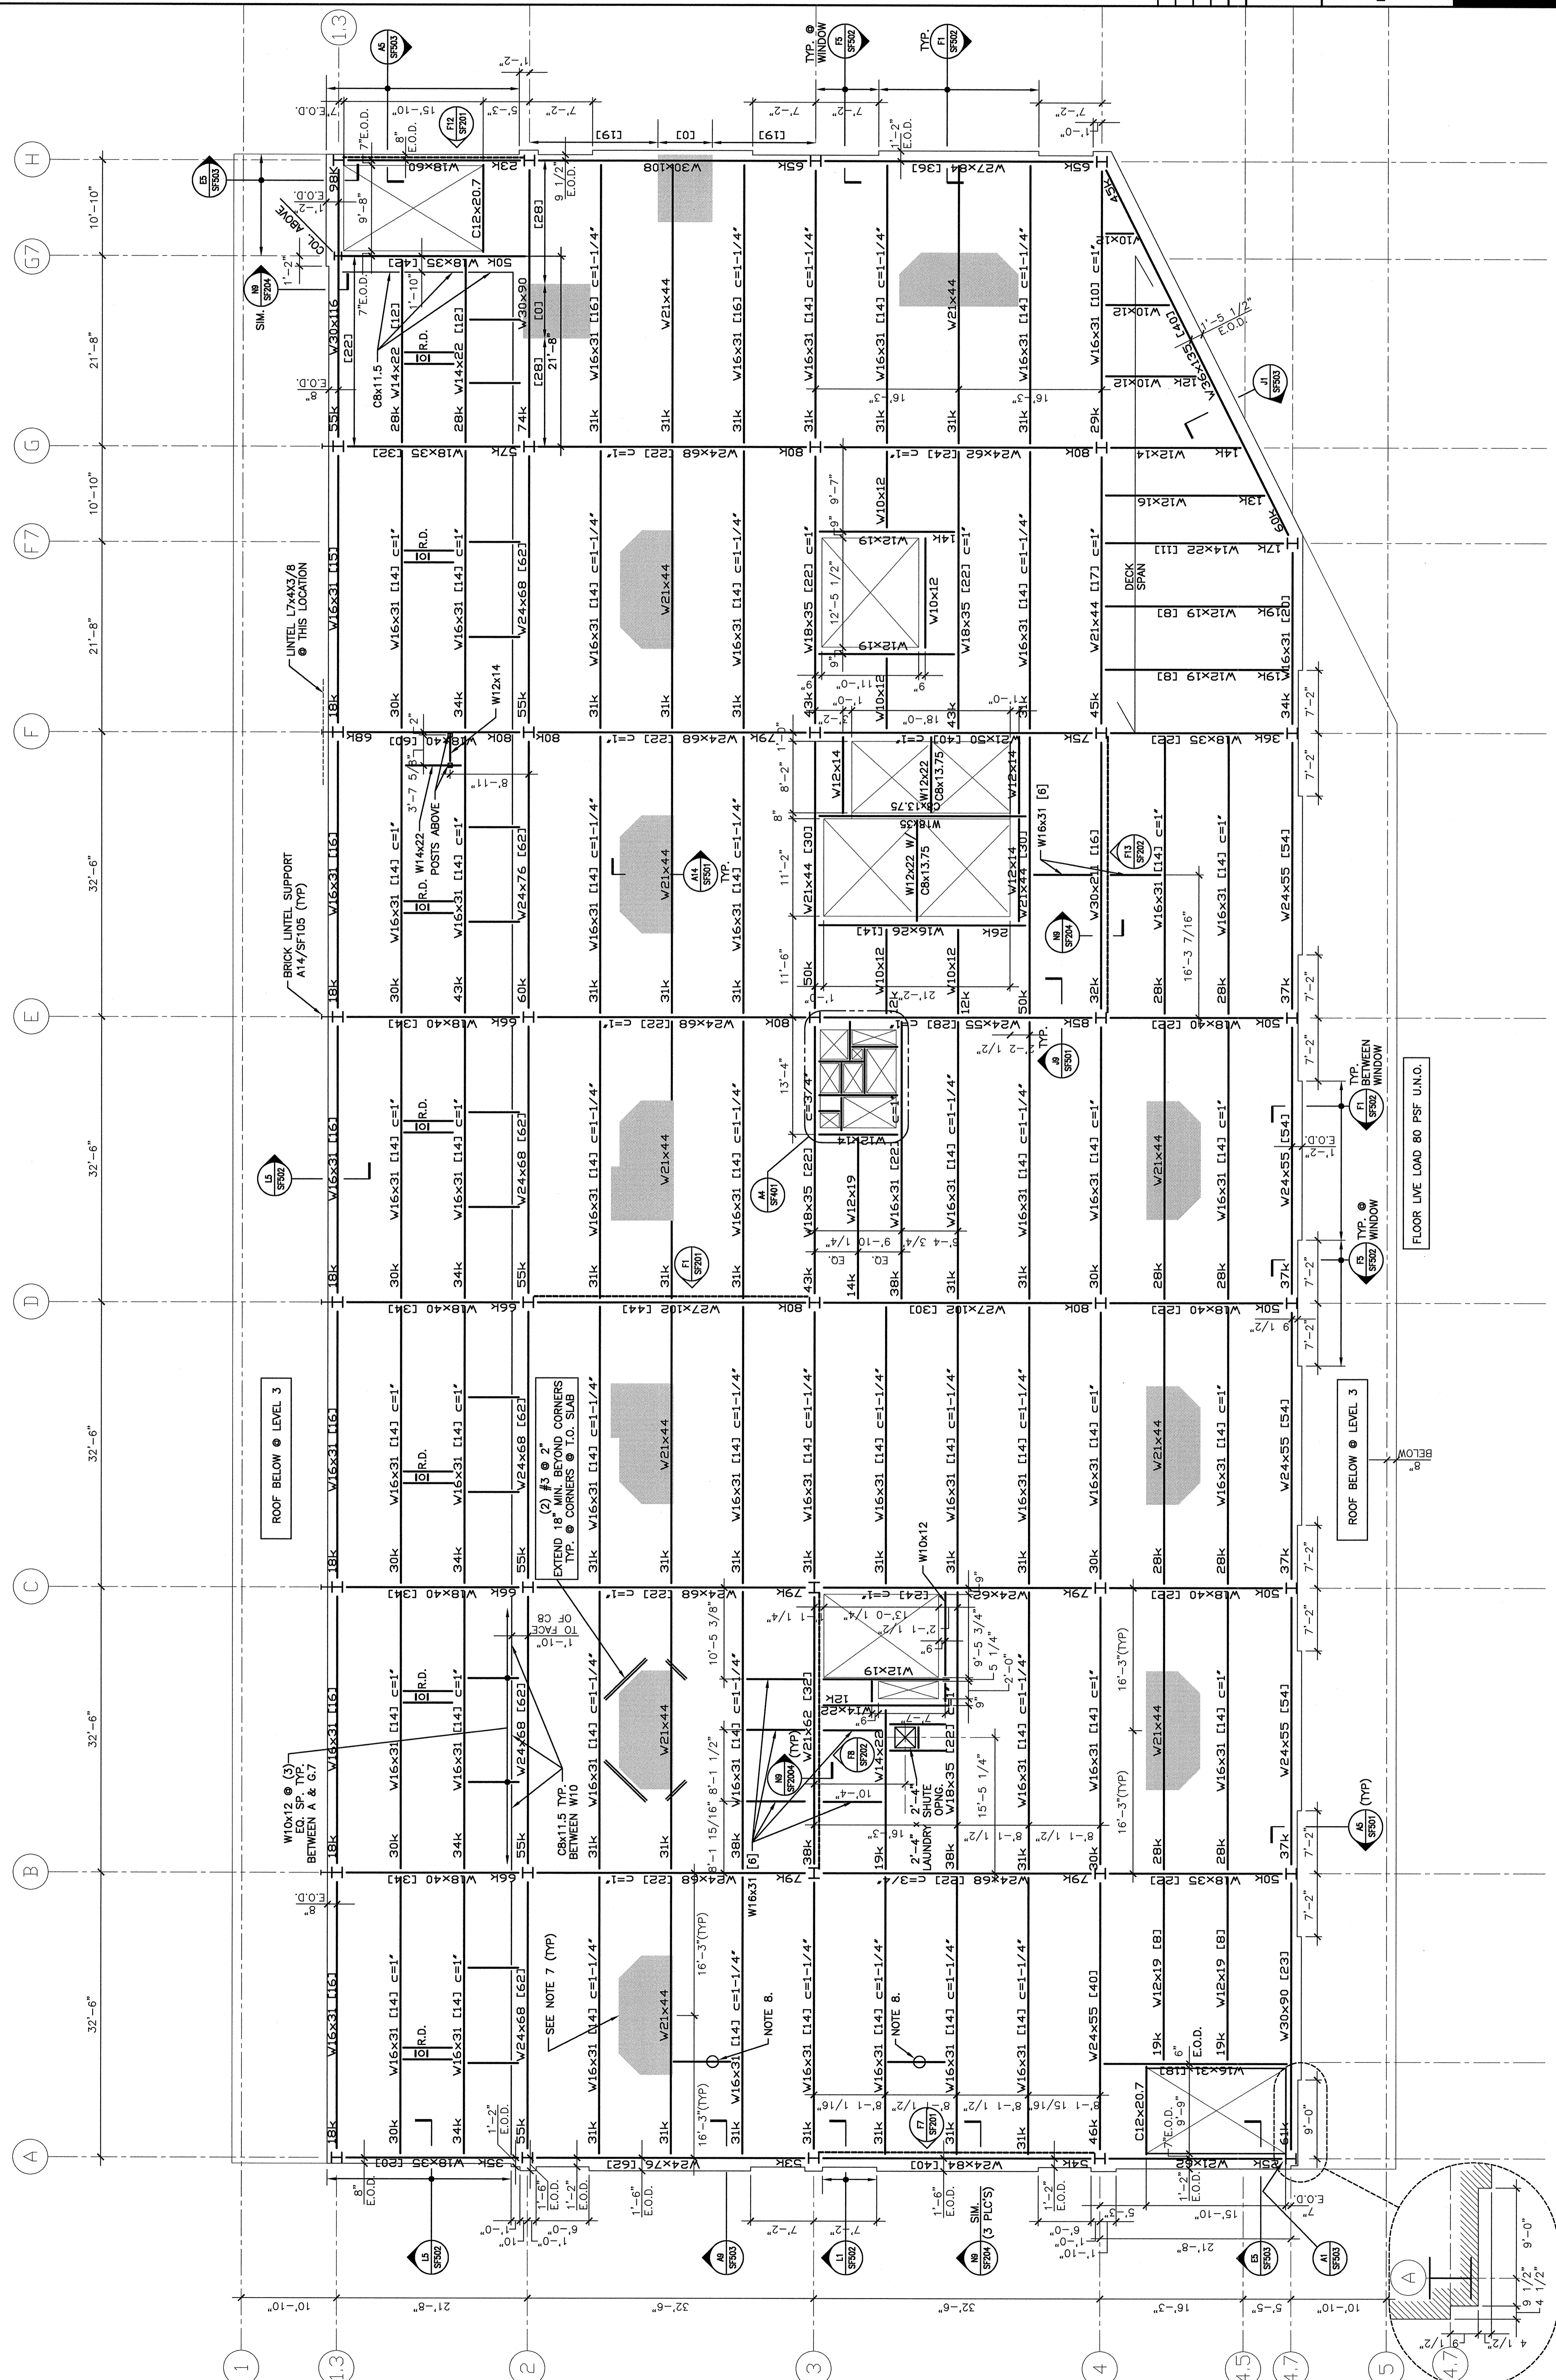

A1 LEVEL 4 FLOOR FRAMING PLAN

1/8"=1'-0"