


NOTES:

- FOR GENERAL NOTES SEE S6001
- TYPICAL DECK: CONCRETE SLAB ON 2W20 GALV. COMPOSITE DECK REINF. 6#6-W2.1W2.1, TOTAL DECK THICKNESS 6 1/2". T.O. CONC. DECK EL. 15'-2".
- THE CONCRETE DECK THICKNESS SHALL BE INCREASED IF REQUIRED TO COMPENSATE FOR BEAM DEFLECTION DURING CONCRETE POUR.
- T.O.S. EL. 14'-7 1/2" TYP. U.N.O.
- REACTIONS, INDICATED XXX, ARE PROVIDED AT END OF BEAMS, DESIGNED AS COMPOSITE W/ THE CONCRETE DECK. CONNECTION DESIGN, SEE S6001 FOR ADD'L REQUIREMENTS.
- NUMBERS IN BRACKETS SHOWN THIS [X] INDICATE THE LOCATION OF BRACKETS TO BE WELDED TO THE BEAM TOP FLANGE, SPACE UNIFORMLY ALONG SPAN. SEE S6001 FOR REQUIREMENTS.
- "o-x" DESIGNATES REQUIRED CAMBER AT MIDSPAN.

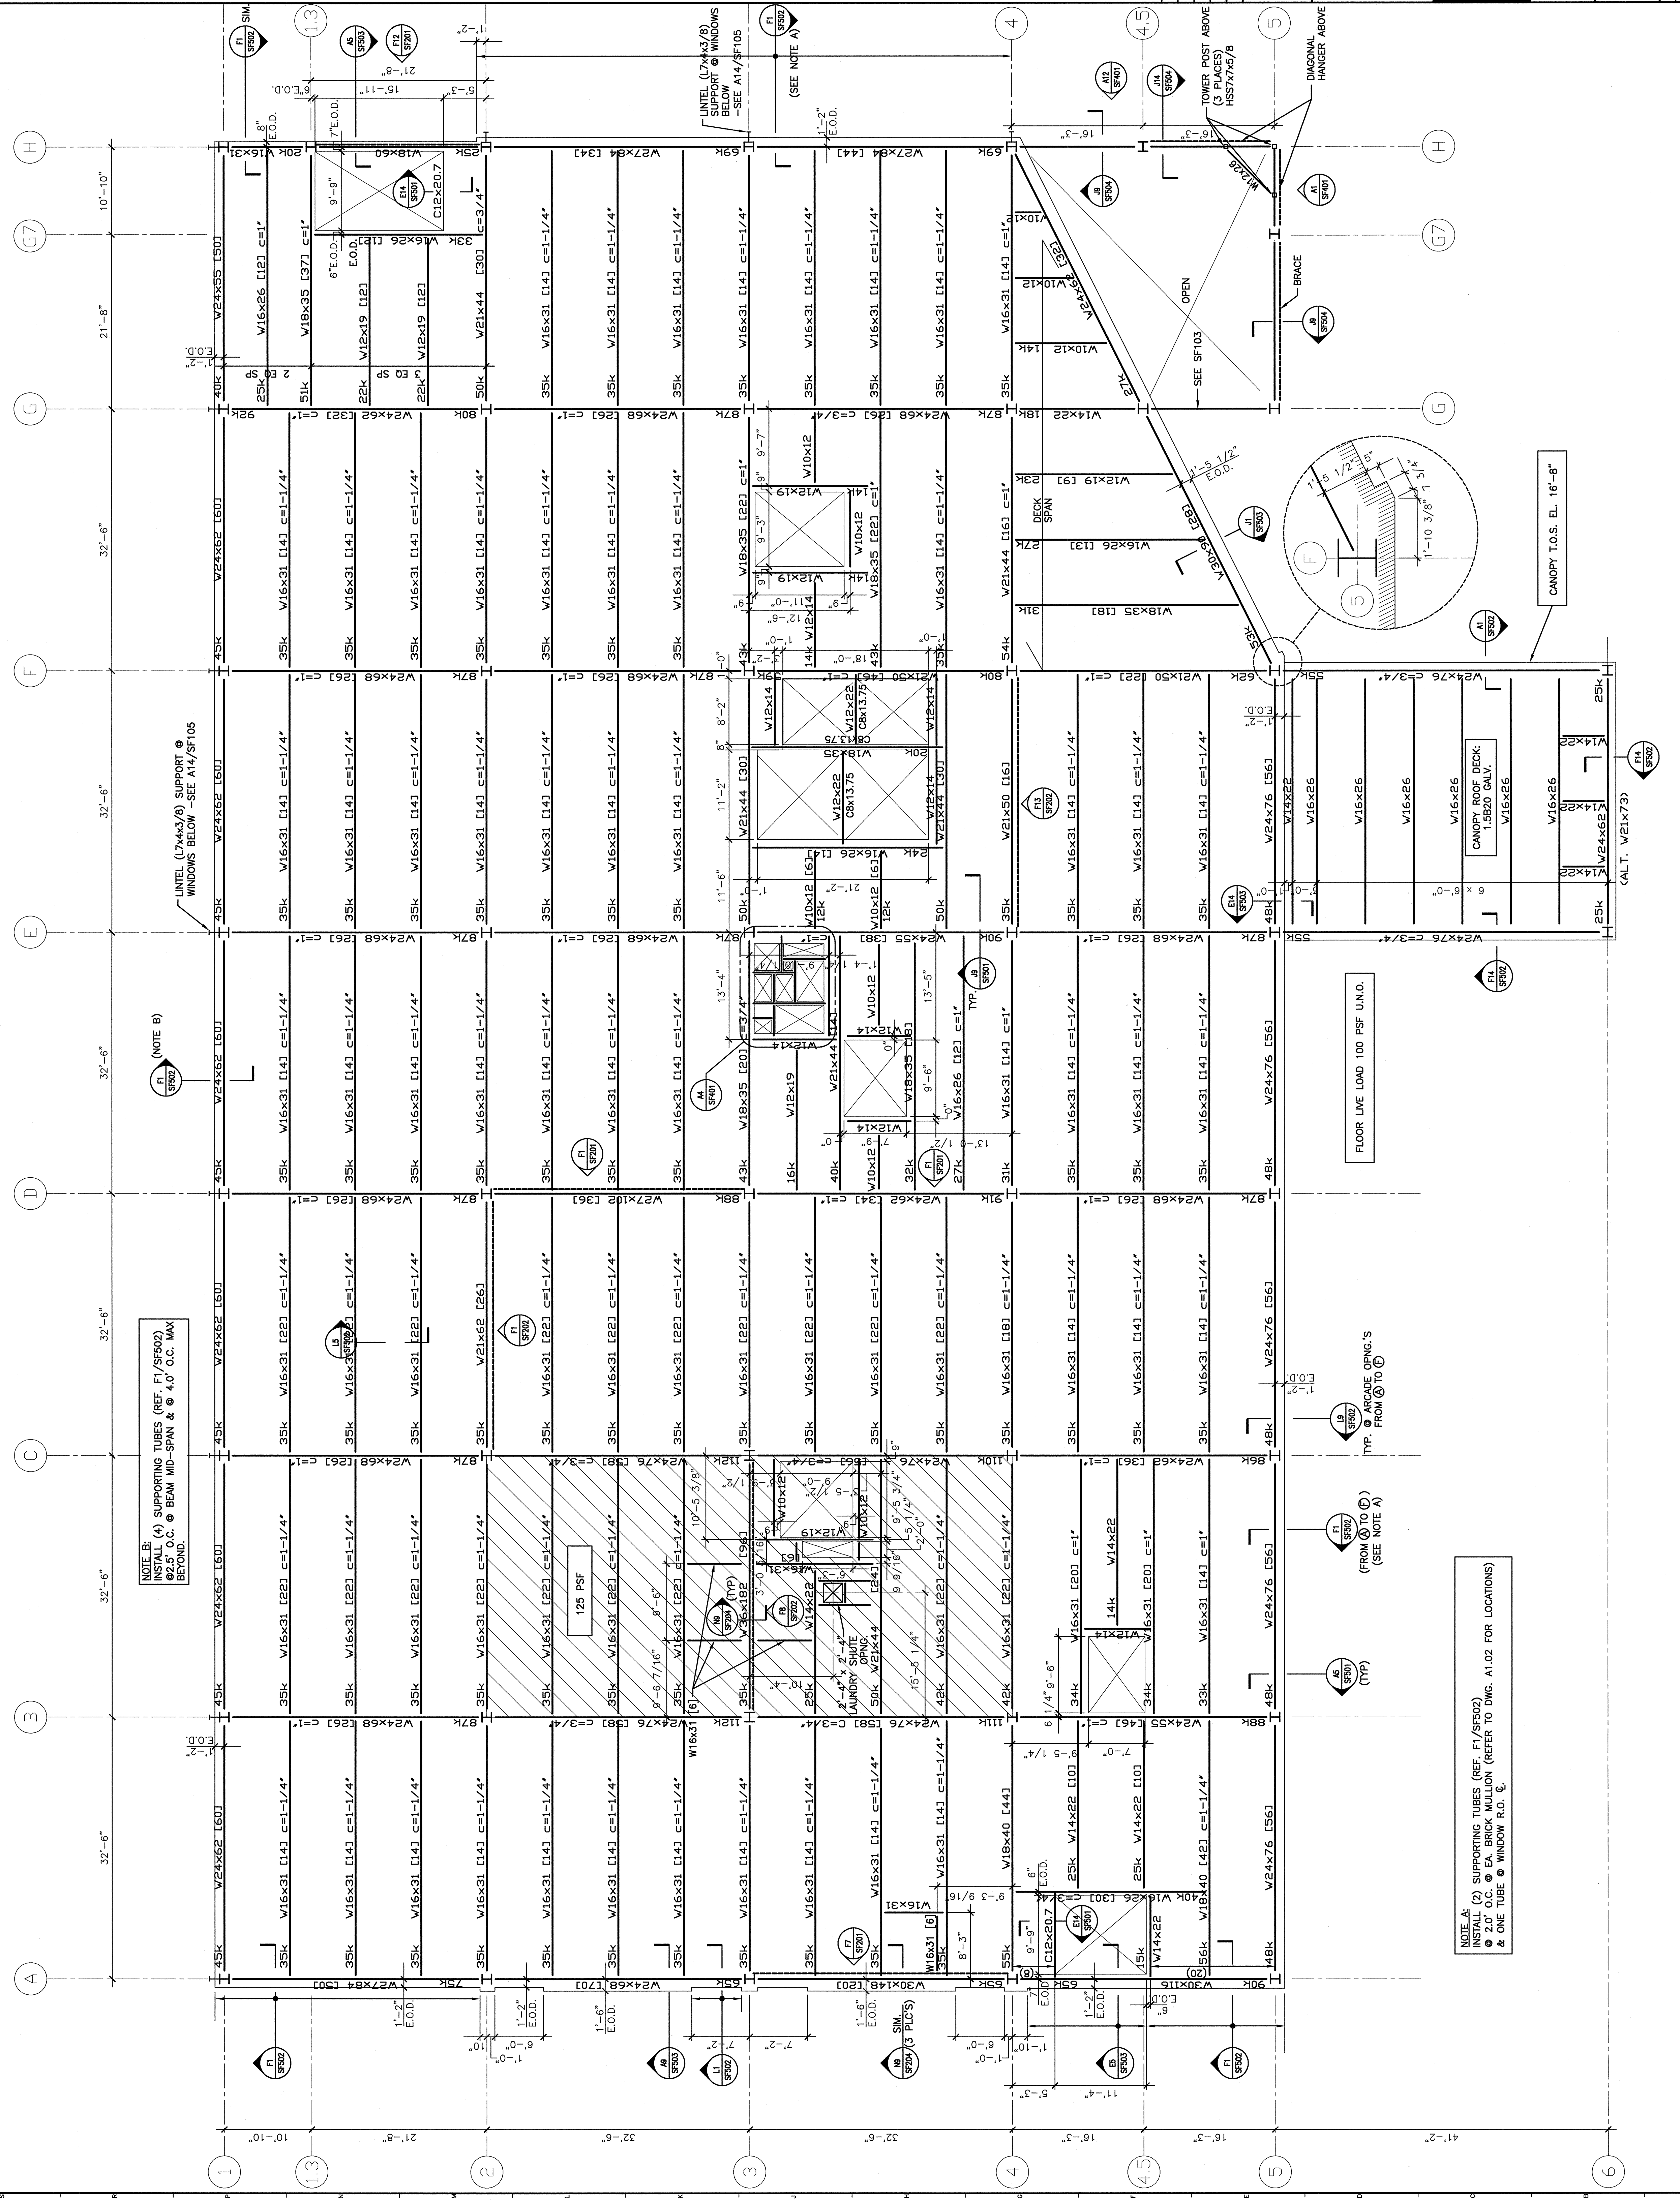

NOTE B:
INSTALL (4) SUPPORTING TUBES (REF. F1/SF502) @ 2.0' O.C. @ BEAM MID-SPAN & @ 4.0' O.C. MAX BEYOND.

NOTE A:
(2) SUPPORTING TUBES (REF. F1/SF502) @ 2.0' O.C. @ EA BRICK MULLION (REFER TO DWG. A1.02 FOR LOCATIONS) & ONE TUBE @ WINDOW R.O. E.

FLOOR LIVE LOAD 100 PSF U.N.O.


TYP. @ ARCADE OPENING'S FROM (D) TO (E) (SEE NOTE A)

CANOPY T.O.S. EL. 16'-8"

ISSUED FOR CONSTRUCTION
9-19-06

REV.	DESCRIPTION	DATE
0	ISSUED FOR CONSTRUCTION	9-19-06

CURRENT ISSUE STATUS:

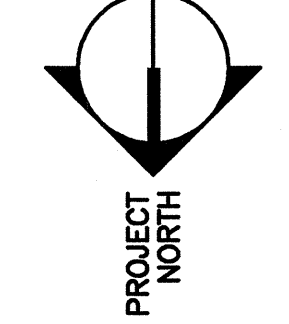

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MERCY HOSPITAL AT FORE RIVER
PROJECT 2
LOCATION

LEVEL 2
FLOOR FRAMING PLAN

SHEET TITLE: AS NOTED DATE: 9-19-06
PROJECT MANAGER: ELL GRAPHIC SCALE: 0'
JOB CAP/DRAWN: HCC
DATE OF RECORD: JSW
SMART CAD FILE: SF102-05034
PROJECT No. 05034

A1 LEVEL 2 FLOOR FRAMING PLAN
1/8"=1'-0"

SHEET No. **SF102**