

NOTES:

- FOR GENERAL NOTES SEE S6001
- TYPICAL DECK CONCRETE SLAB ON 2X12 GALV. STUDS W/ 8" CONC. DECK EL. 0'-0". DECK THICKNESS 6 1/2". T.O. CONC. DECK EL. 0'-0". THE CONCRETE DECK THICKNESS SHALL BE INCREASED IF COMPENSATE FOR BEAM DEFLECTION DURING CONCRETE POUR.
- T.O.S. EL. (-0'-6" 1/2") TYP. U.M.O.
- REACTIONS, INDICATED XXX, ARE PROVIDED AT END OF BEAMS, DESIGNED AS COMPOSITE W/ THE CONCRETE SLAB, FOR CONNECTION DESIGN. SEE S6001 FOR ADD'L REQUIREMENTS.
- NUMBERS IN BRACKETS SHOWN THUS [X] INDICATE THE REQUIRED NUMBER OF SHEAR CONNECTORS. THE NUMBER OF SHEAR CONNECTORS SHALL BE UNIFORM ALONG THE FLANGE SPACE UNLESS OTHERWISE NOTED. SEE S6001 FOR REQUIREMENTS.
- "e-x" DESIGNATES REQUIRED CAMBER AT MIDSPAN.
- BRG-P1, BRG-P2, ETC. DESIGNATE BEAM BEARING PLATE TYPE. REFER TO DET. A9/SF501.

R14 DETAIL
1 1/2" x 1'-0"

R15 DETAIL
1'-0" x 1'-0"

R16 DETAIL
1'-0" x 1'-0"

R17 DETAIL
1'-0" x 1'-0"

R18 DETAIL
1'-0" x 1'-0"

R19 DETAIL
1'-0" x 1'-0"

R20 DETAIL
1'-0" x 1'-0"

R21 DETAIL
1'-0" x 1'-0"

R22 DETAIL
1'-0" x 1'-0"

R23 DETAIL
1'-0" x 1'-0"

R24 DETAIL
1'-0" x 1'-0"

R25 DETAIL
1'-0" x 1'-0"

R26 DETAIL
1'-0" x 1'-0"

R27 DETAIL
1'-0" x 1'-0"


R28 DETAIL
1'-0" x 1'-0"

R29 DETAIL
1'-0" x 1'-0"

R30 DETAIL
1'-0" x 1'-0"

R31 DETAIL
1'-0" x 1'-0"

R32 DETAIL
1'-0" x 1'-0"

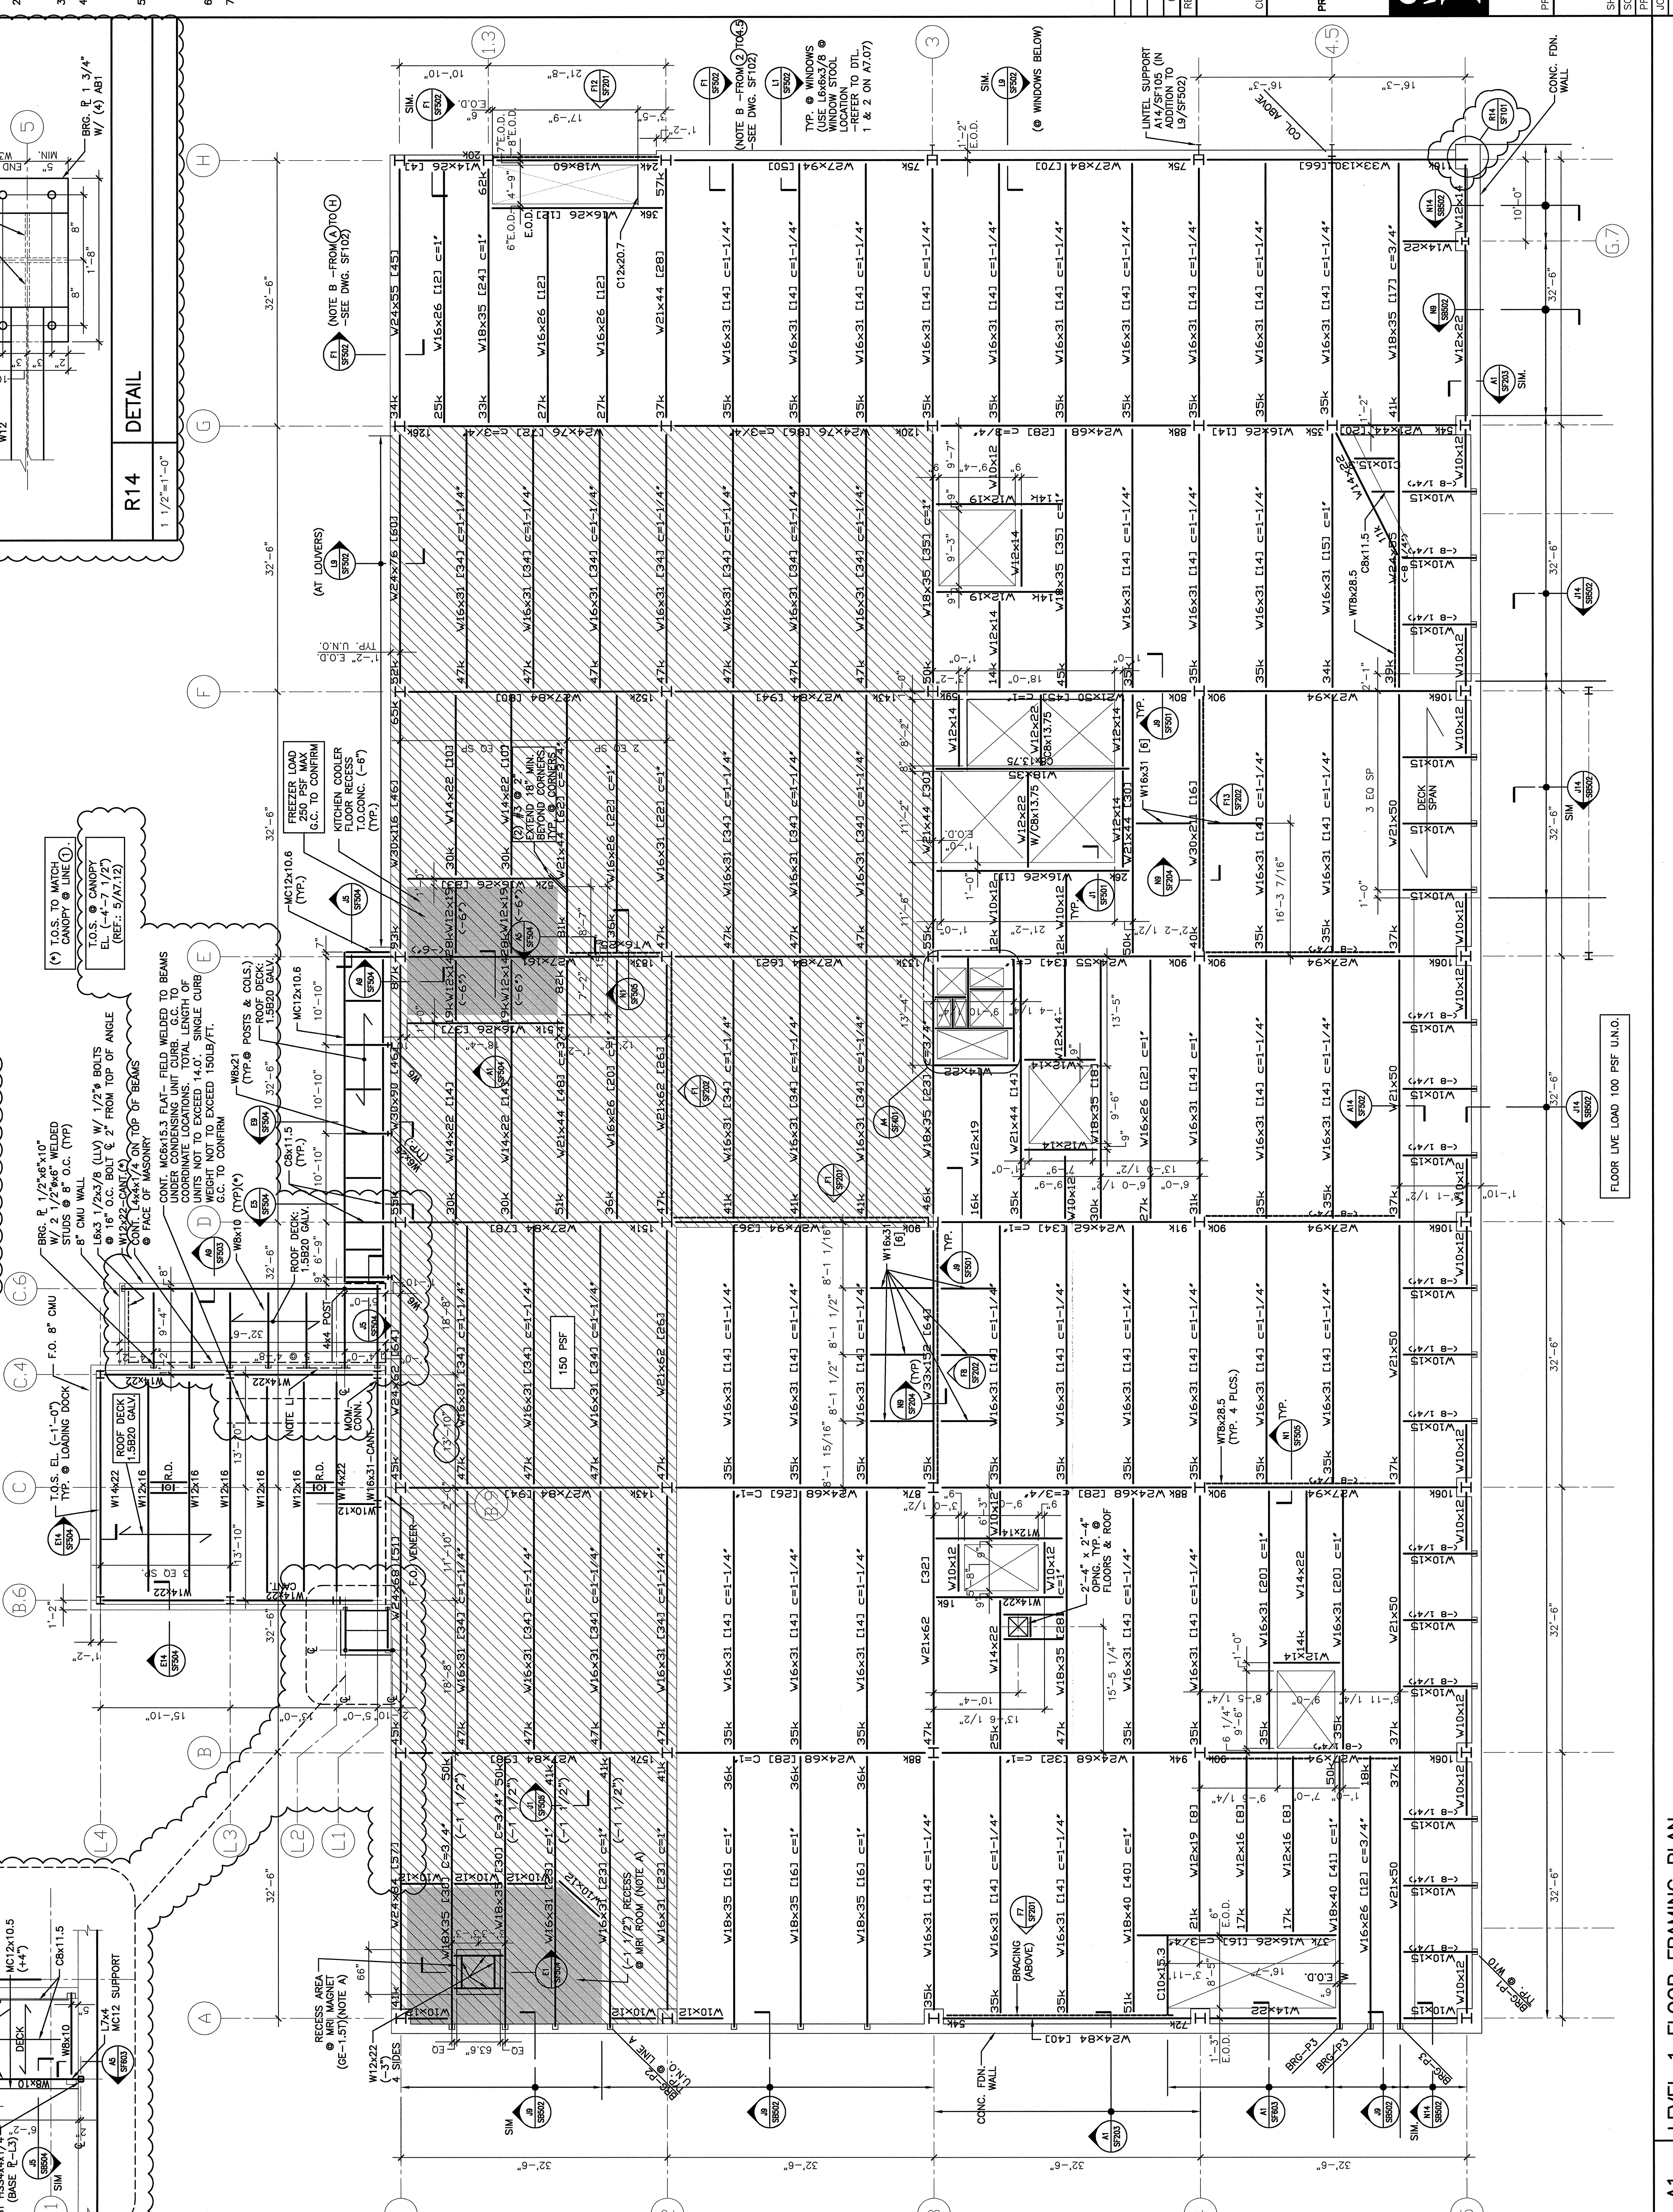

REV.	DESCRIPTION	DATE
0	ISSUED FOR S1-3	11-10-06

**ISSUED FOR S1-3
11-10-06**

CURRENT ISSUE STATUS:

PROJECT NORTH

SM
RT
ARCHITECTURE ENGINEERING PLANNING

SMRT
144 Fore Street, P.O. Box 618
Portland, Maine 04104
Tel. (207) 772-8866
Fax. (207) 772-1000

MERCY HOSPITAL AT FORE RIVER
PROJECT 2
LOCATION

PROJECT: LEVEL 1
FLOOR FRAMING PLAN

SHEET TITLE:	AS NOTED	DATE:	9-19-06
SCALE:	ELB	GRAPHIC SCALE:	0'
PROJECT MANAGER:	HCC	JOB CAF/DRAWN:	JSW
A/E OF RECORD:	JSW	SHEET No.	SF101
SWRT. CAD. FILE:	SF101-05034		
PROJECT No.	05034		

A1
1/8"=1'-0"

LEVEL 1 FLOOR FRAMING PLAN

FLOOR LIVE LOAD 100 PSF U.M.O.