
WOOD FRAMING NOTES:

- 3. LAMINATED VENEER LUMBER: EQUIVALENT TO BOISE 2.0E 3100 FB OR BETTER
- 4. LUMBER SIZE SHOWN ARE NOMINAL EXCEPT FULL SIZE NOTED BY (R) FOR ROUGH CUT
- 4 PLY LVL'S WHICH ARE BOLTED WITH ½" DIAMETER BOLTS.
- 8. PROVIDE GALVANIZED METAL JOIST HANGERS AT FLUSH FRAMED CONNECTIONS. WALLS/MEMBERS, UNLESS SHOWN OTHERWISE.
- 11. PROVIDE MIN OF (2) 2X STUDS AT ENDS OF BUILT UP MEMBERS 12. PROVIDE PRESSURE TREATED LUMBER FOR ALL LUMBER IN CONTACT WITH MASONRY OR CONCRETE.
- 14. POSTS AT CORNERS OR EXTERIOR WALLS: PROVIDE 6X6 OR (3) 2X6 MINIMUM.
- 15. PROVIDE FULL DEPTH BLOCKING OF ALL JOISTS AND RAFTERS AT SUPPORT LOCATIONS. 16. PROVIDE FULL DEPTH BLOCKING AT 8 FEET ON CENTER FOR ALL JOISTS AND LOW SLOPE RAFTERS.
- AND COMPRESSIVE STRENGTH IS PROVIDED.

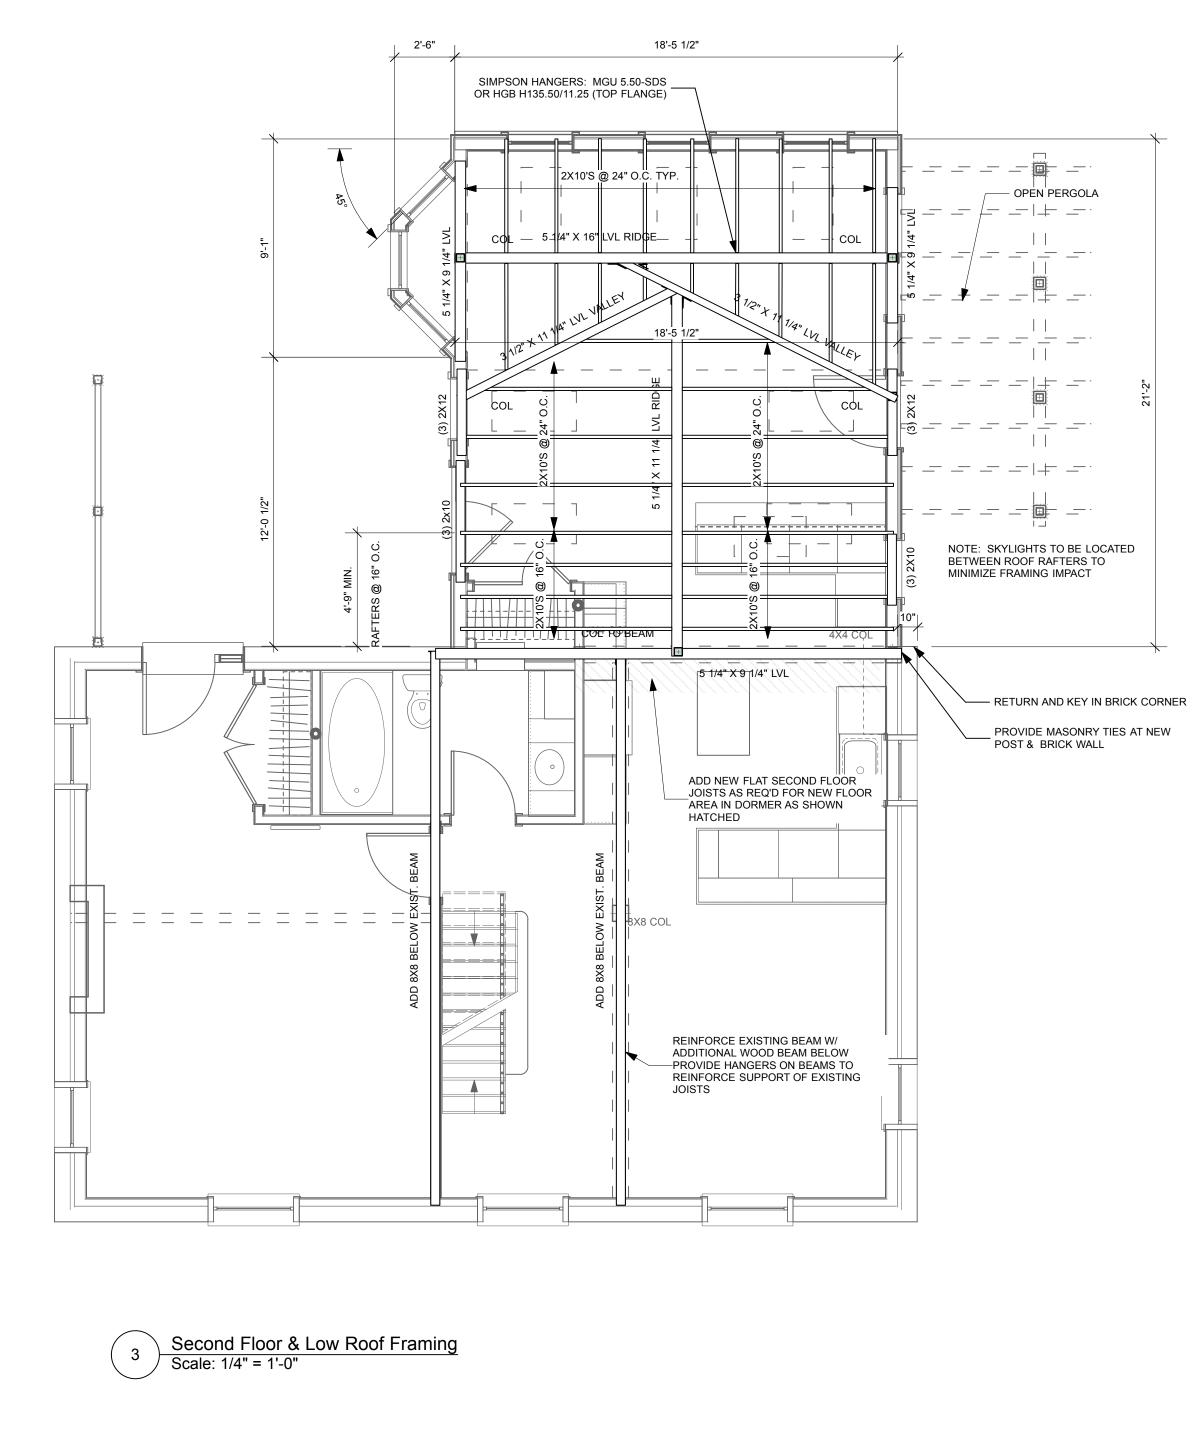



1. STRUCTURAL LUMBER: NO. 2 SPRUCE-PINE-FIR OR BETTER, 19% MAXIMUM MOISTURE CONTENT. 2. PRESSURE TREATED LUMBER: NO. 2 SOUTHERN YELLOW PINE OR BETTER

5. DESIGN CODE: NATIONAL DESIGN SPECIFICATION FOR WOOD CONSTRUCTION BY THE AMERICAN FOREST AND PAPER ASSOCIATION. 6. FASTENERS: COMPLY WITH INTERNATIONAL BUILDING CODE LATEST ADDITION UNLESS SHOWN OTHERWISE ON DRAWINGS.

7. SPIKE TOGETHER ALL FRAMING MEMBERS WHICH ARE BUILT UP USING 2 ROWS OF 16d NAILS AT12" oc STAGGERED, EXCEPT

9. PROVIDE GALVANIZED METAL RAFTER TIES EQUAL TO SIMPSON H2.5 BETWEEN RAFTERS/TRUSSES AND SUPPORTING

10. PROVIDE DOUBLE TOP PLATE IN ALL EXTERIOR WALLS AND ALL BEARING WALLS. STAGGER TOP PLATE SPLICES 4'-0"


13. USE SIMPSON POST CAPS AND BASES EQUIVALENT TO BC UNLESS NOTED OTHERWISE ON DRAWINGS.

17. PROVIDE 1/2" DIAMETER ANCHOR BOLTS WITH 8" MINIMUM EMBEDMENT INTO CONCRETE FOUNDATION AT ALL SILL

PLATES. PROVIDE A MINIMUM OF 2 BOLTS PER SECTION OF PLATE AND ONE BOLT WITHIN 12" OF EACH END OF SECTION. 18. WHERE POSTS FRAME THROUGH FLOOR LEVELS, PROVIDE A CONTINUOUS LOAD PATH THROUGH FLOORS TO BEAM OR

FOUNDATION BELOW. POSTS MAYBE SPLICED AT FLOOR LEVELS PROVIDED SOLID BLOCKING OF EQUAL OR GREATER AREA



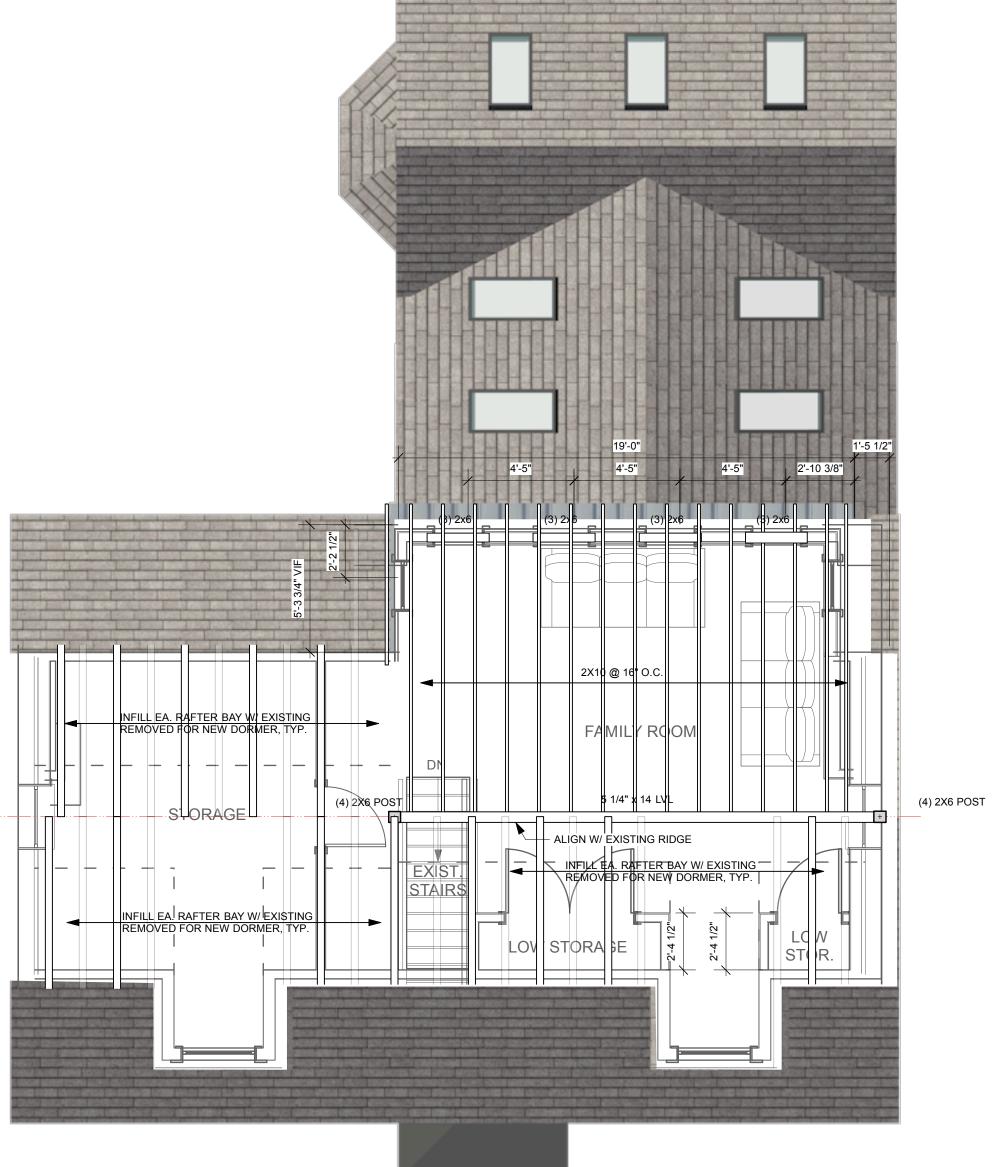



4 New Dormer Framing Scale: 1/4" = 1'-0"



PERMIT SET - REV. 2

			Sheet Status Permit Set		
	RESIDENTIAL DESIGN STUDIO, LLC Carol A. Morrissette 174 Danforth Street Portland, Maine 04102 T 207.699.4184 C 207.671.7965	Marshall Residence Portland, Maine 467 Danforth Street CBL 71/A/3	Project Number 13.70	^{Date} 30 December 2013	
			Drawn By CAM	Sheet No.	
	Revisions 1 1/13/14 - SCALE BAR 2 1/ 31/14 - LOT COVERAGE REV.	Sheet Title Framing Plans & Notes	Sheet Scale 1/4" = 1'-0" UNO CAD File Number	S1.2	
ban	3		093		