



PLOT DATE & TIME: 8/16/2007 9:32 AM
 FILE PATH & NAME: F:\DATA\PROJECTS\MCDONALD'S-M-1000S\M-1032-PORTLAND, ME ARCHITECTURAL-DRAWINGS\M-1032-A-1-0-FLOOR-PLAN

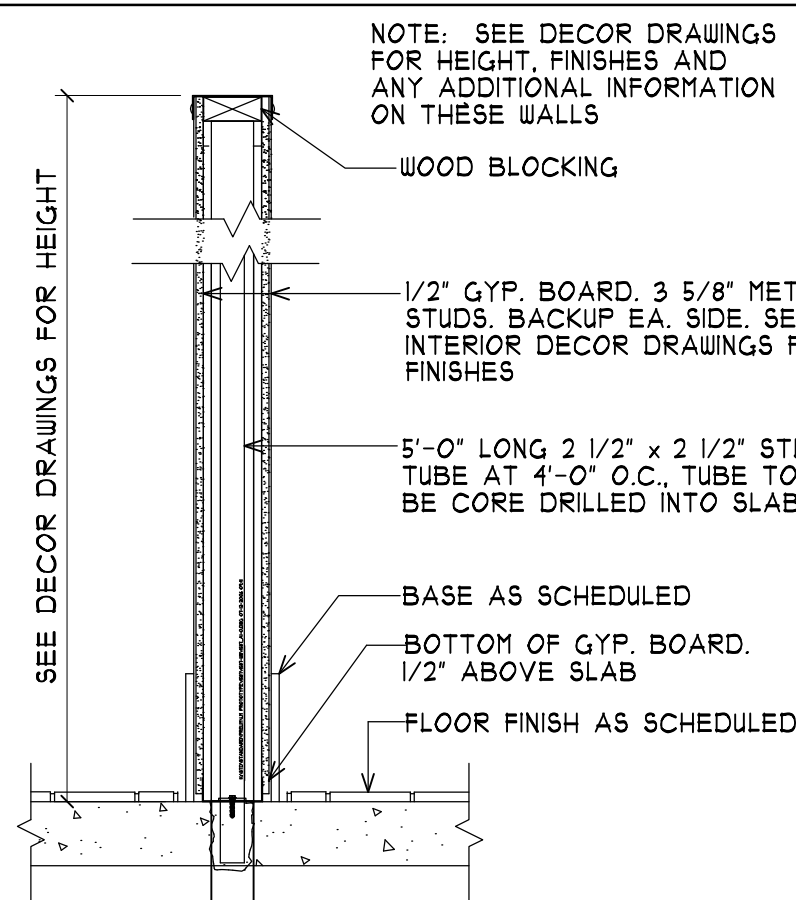

3 PARTIAL HEIGHT PARTITION DETAIL
 A-1.0 SCALE: N.T.S.

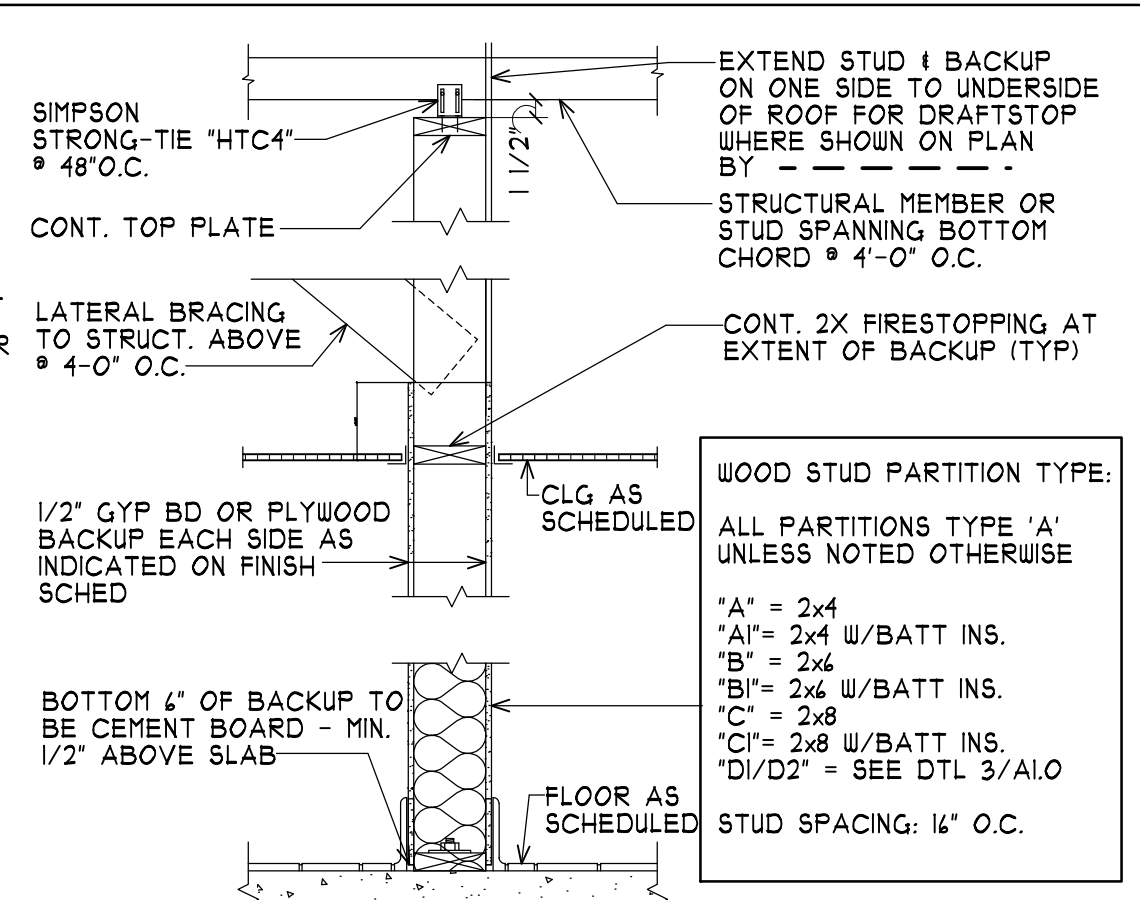

2 INTERIOR PARTITION
 A-1.0 SCALE: 3/4"=1'-0"

GENERAL NOTES


- EXTERIOR DIMENSIONS ARE TO COLUMN REFERENCE LINES AND EXTERIOR FACE OF FINISH UNLESS OTHERWISE NOTED. INTERIOR DIMENSIONS ARE TO FACE OF FINISH.
- SEE 1/A5.0 FOR EXTERIOR WALL ASSEMBLY TYPES. SEE 2/A1.0 FOR INTERIOR PARTITION TYPES. INTERIOR PARTITIONS ARE TYPE 'A' UNLESS NOTED OTHERWISE.
- SEE EXTERIOR ELEVATIONS FOR WINDOW TYPES
- SEE SHEET A4.0 FOR DOOR AND ROOM FINISH SCHEDULES
- SEE SITE PLAN FOR SIDEWALKS, RAMPS, ETC.
- GC TO PROVIDE ADA SIGNAGE PACKAGE AND INSTALL SIGNS AT LOCATIONS AND POSITIONS INDICATED IN PACKAGE OR AS REQUIRED BY LOCAL CODES. SIGNAGE PACKAGE SUPPLIED BY:
 FORREST PERMA-SIGN 1-800-214-8145
 424 1ST ST. BOX 588 www.forrestpermasigns.com
 NEW ROCHELLE, NY 10802
- MAXIMUM OCCUPANCY SIGN TO BE POSTED PER LOCAL CODE. SIGN FURNISHED AND INSTALLED BY GENERAL CONTRACTOR.

SYMBOL LEGEND

- (A) PARTITION TYPE TAG SEE 2/A1.0
- - - DRAFT STOPPING - SEE 2/A1.0
- (2) DOOR TAG - SEE DOOR SCHEDULE ON A4.0
- CT CERAMIC WALL TILE * CUSTOMER SERVICE AND KITCHEN SERVING AREAS TO BE COORDINATED W/ FINAL DINING DECOR SCHEME 1 MCDONALD'S PROJECT MANAGER.
- DS KEY NOTE

KEY NOTES

- A AWNING ABOVE - BY OTHERS
- CG G.C. TO PROVIDE 4"x4"x5'-0" HIGH STAINLESS STEEL CORNER GUARDS AT ALL EXPOSED LOCATIONS IN KITCHEN/SUPPORT AREA CORNERS STARTING AT FINISH FLOOR. ATTACH WITH WOOD SCREWS INTO WOOD BLOCKING - BULLNOSE COVE BASE WHERE TILE MEETS STAINLESS STEEL CORNER. SEE DETAIL 2/A-5.4
- CP CONCRETE EQMT PAD - SEE STRUCTURAL
- DC SUSPENDED DECORATIVE CEILING TREATMENT. SEE DECOR DRAWINGS FOR ADDITIONAL INFORMATION.
- DS DROPPED SOFFIT ABOVE - SEE REFLECTED CEILING PLAN
- FB CO2 FILL BOX (EQPM SCHEDULE ITEM 49.00)
- FB CO2 FILL BOX (EQPM SCHEDULE ITEM 100.18) CONFIRM USE WITH MCDONALD'S PROJECT MANAGER
- RL ROOF ACCESS LADDER W/HATCH ABOVE SEE STRUCTURAL FRAMING PLAN FOR LOCATING DIMENSIONS.
- T TRELLIS SYSTEM ABOVE SEE 1/A5.0 FOR NOTES SEE ROOF PLAN FOR DIMENSIONS

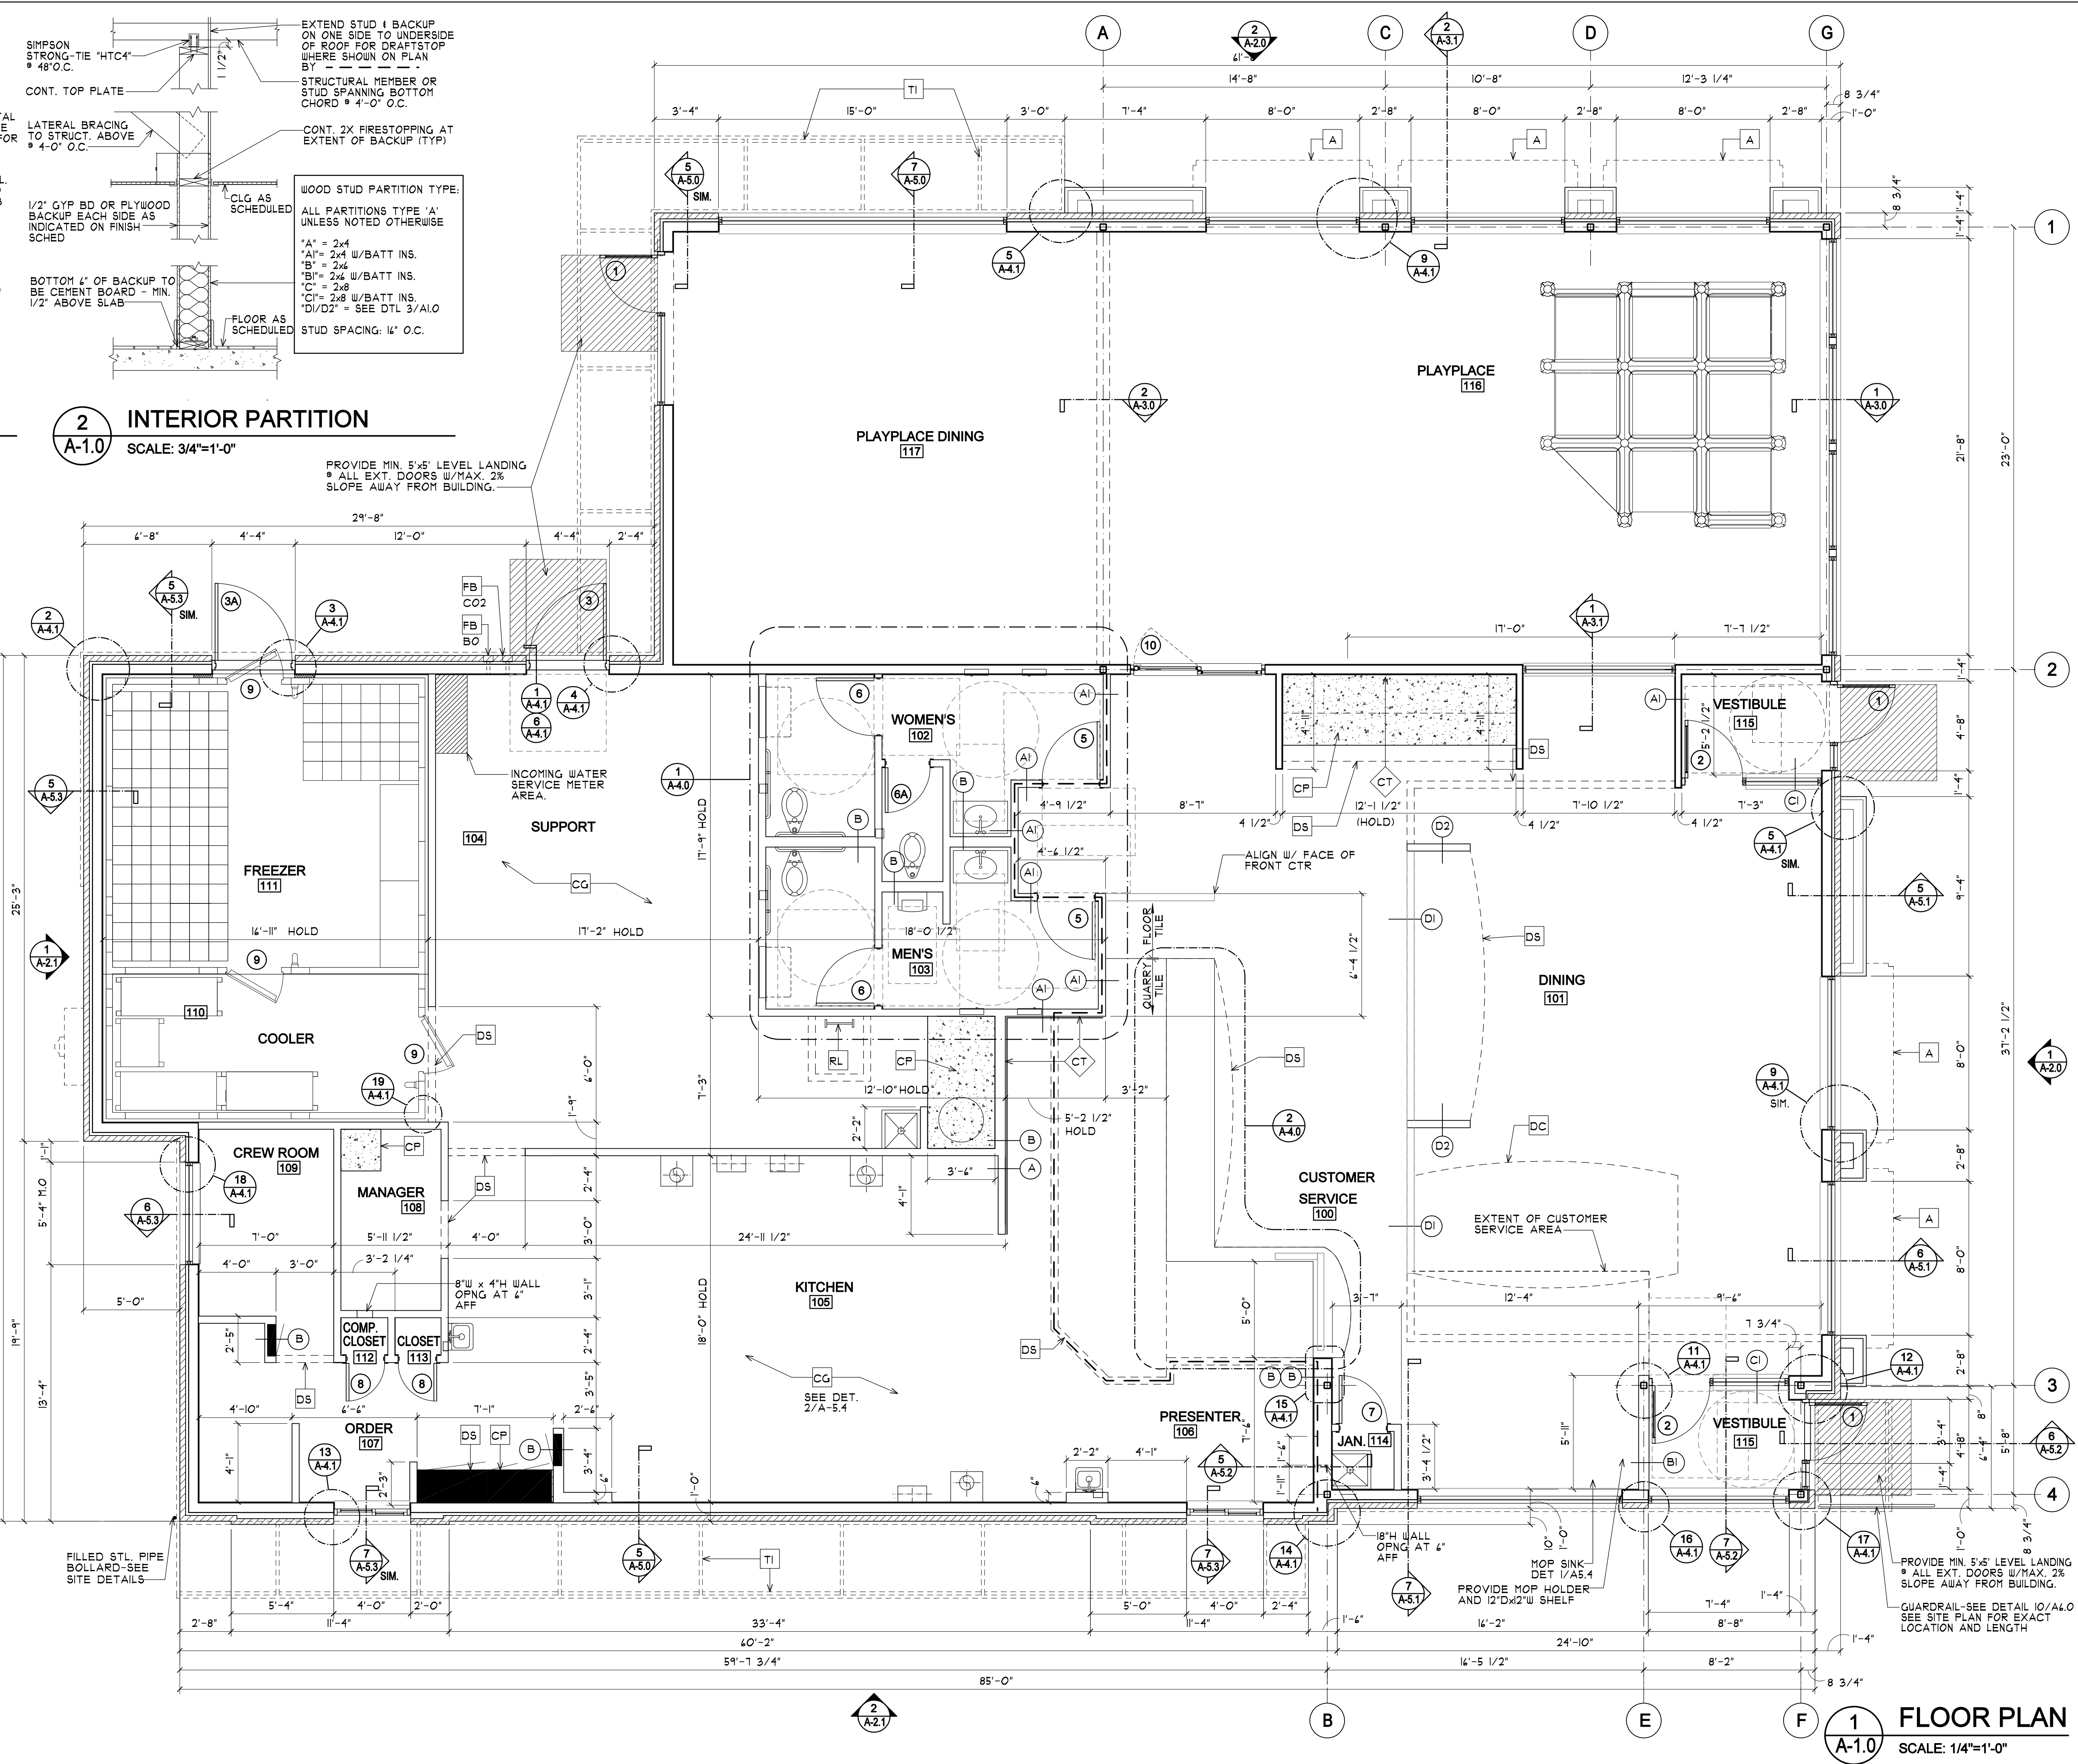

1 FLOOR PLAN
 A-1.0 SCALE: 1/4"=1'-0"

NO.	DATE	REVISIONS
1		
2		
3		
4		
5		
6		
7		

Landry ARCHITECTS
 300 BROADWAY, SUITE 200
 PORTLAND, ME 04101
 TEL: 603.886.6414 FAX: 603.884.4359

CONSULTANT:

DATE ISSUED: 08/14/07
 DATE DRAWN: 04/17/07
 SCALE: AS NOTED
 JOB NUMBER: M-1032

McDonald's

FLOOR PLAN, NOTES AND DETAILS

RESTAURANT LOCATION:
 332 St. John Street
PORTLAND, ME

PREPARED FOR:
McDonald's USA, LLC
 MCDONALD'S PLAZA
 OAK BROOK, ILLINOIS 60521

SHEET NUMBER:
A-1.0