

REVISIONS


Job Number:	3044
Drawn By:	AN
Checked By:	AM
Phase:	CANOPY DOCUMENTS

Drawing Title:	ROOF FRAMING PLAN
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SHEET NUMBER:	S-102
DATE:	JUNE 30, 2017

- ROOF PLAN NOTES**
- FOLLOWING FINISH FLOOR ELEVATION RELATIVE TO LEVEL 1 FINISH FLOOR DATUM 100'-0" IS AS FOLLOWS (UNO), F.V.:
 FIRST FLOOR: 100' - 0"
 SECOND FLOOR: 108' - 8"
 THIRD FLOOR: 117' - 4"
 FOURTH FLOOR: 126' - 0"
 ROOF: 135' - 4"
 - SHEET INDEX:
 GENERAL NOTES - S-000
 TYPICAL DETAILS - S-301, S-501
 STEEL COLUMN SCHEDULE - S-501
 - TYPICAL EXISTING CONSTRUCTION (F.V.)
 SLOPED 8" HOLLOW CORE PLANK
 TAPERED INSULATION
 - FIELD VERIFY ALL DIMENSIONS PRIOR TO FABRICATION OF MATERIALS AND CONSTRUCTION

MECH/L DUNNAGE NOTE:
 1. G.C. TO COORDINATE MEMBER LOCATION WITH MECH/L UNIT SUPPLIER.
 2. DIMENSION NOT TO EXCEED 6'-0"
 3. HOT DIP GALVANIZE STEEL COMPONENTS (BEAMS, POSTS, PLATES AND BOLTS) AT NEW STEEL DUNNAGE. COAT EXPOSED FIELD WELDS W/ ZINC-ENRICHED PAINT
 4. GC TO COORDINATE EXACT LOCATION OF NEW ROOF TOP UP WITH MECHANICAL DRAWINGS AND EXISTING ROOF OBSTRUCTION. THE DESIGN INTENT IF FOR NEW STEEL DUNNAGE CLEAR EXIST LAUNDRY CHUTE.

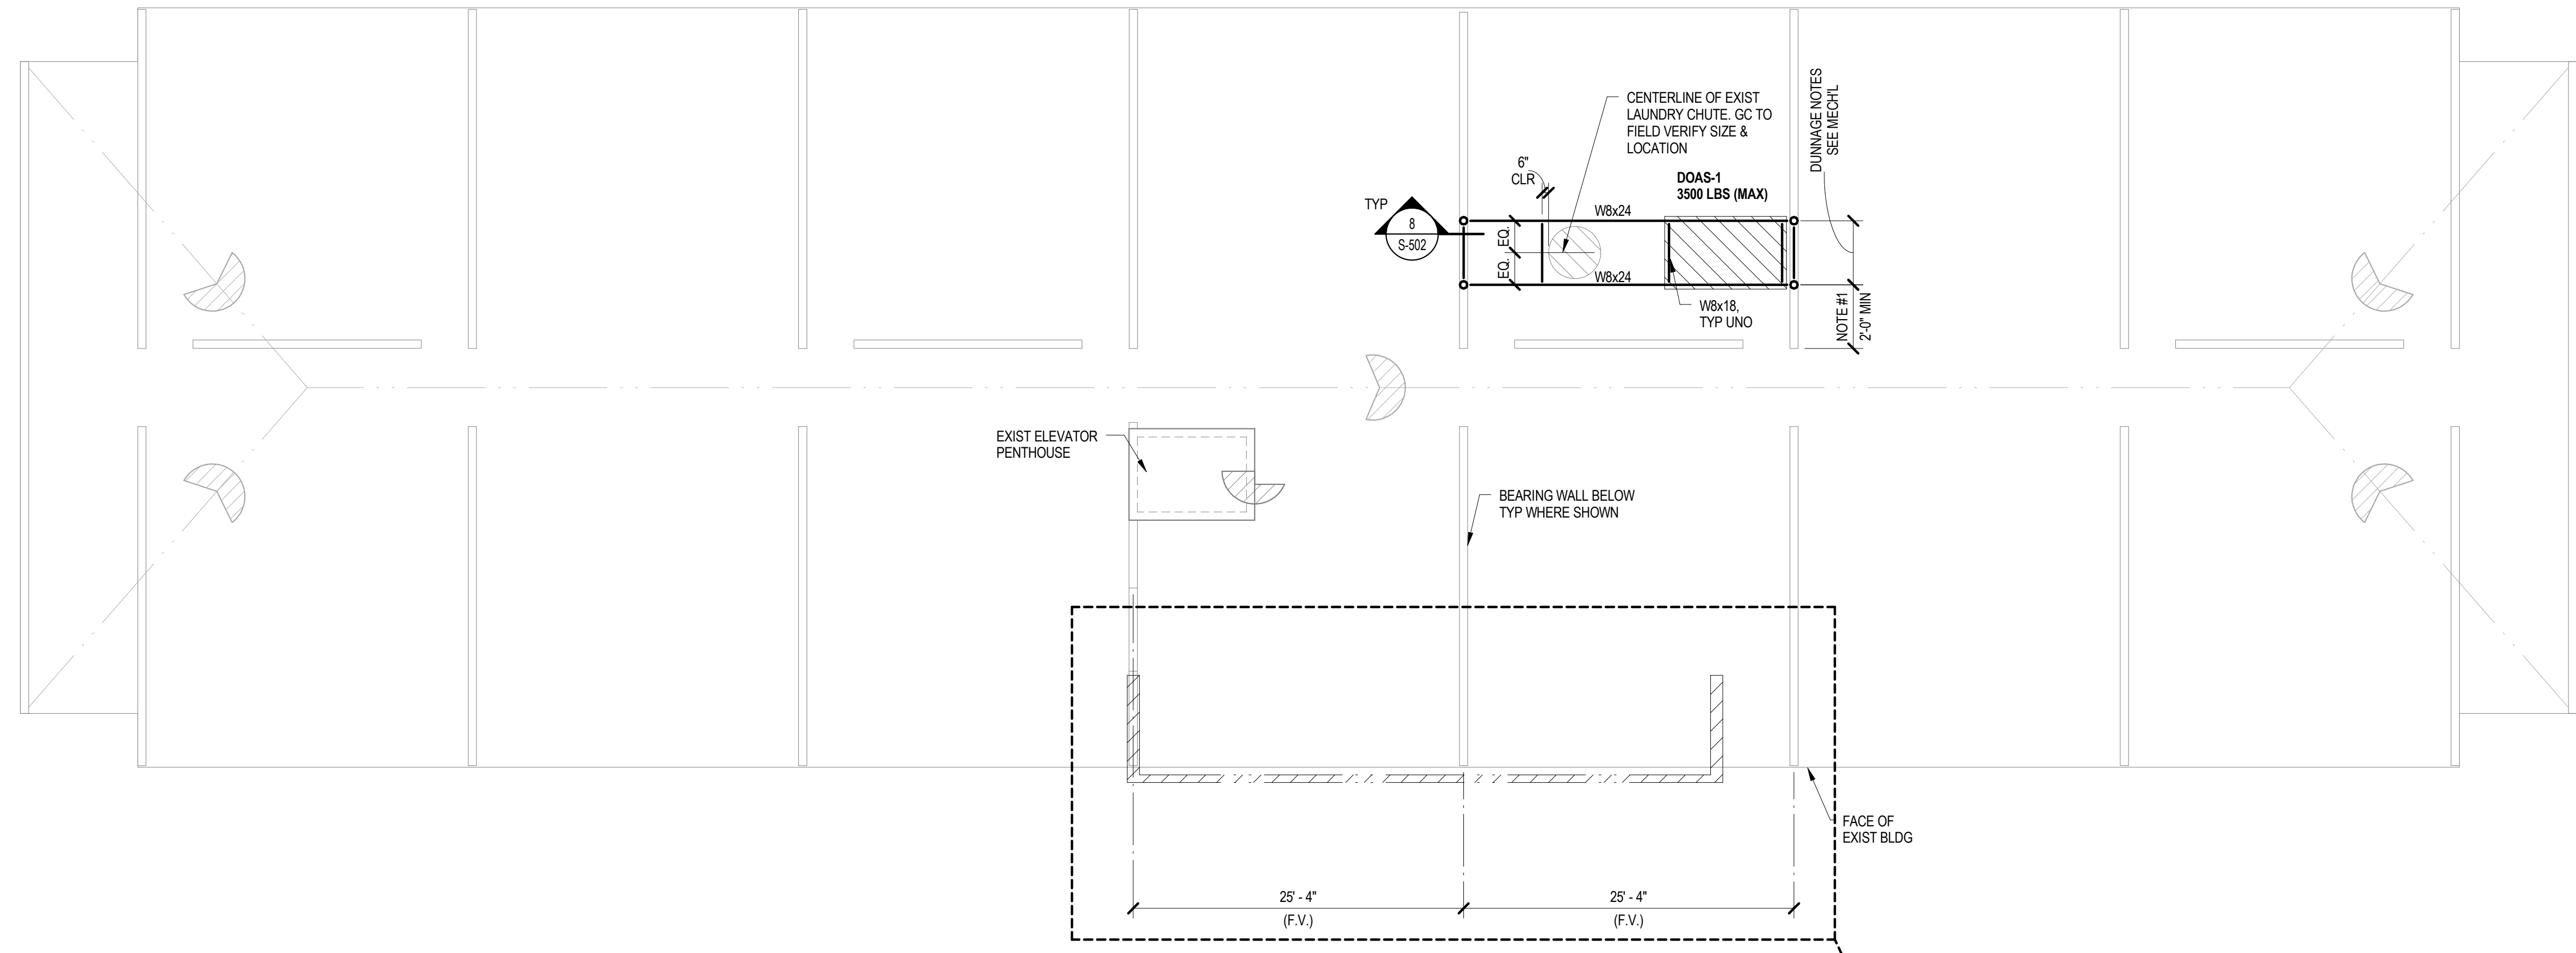

VESTIBULE/LOBBY ADDITION FRAMING SHOWN FOR REFERENCE ONLY. REFER TO "LOBBY AND ADA DOCUMENTS" PACKAGE FOR LOBBY RENOVATION PACKAGE.

INDICATES APPROXIMATE LOCATION OF NEW COLD FORM METAL PARAPET BY BUILDING ENVELOPE DESIGNER. SEE ARCHITECTURAL DRAWINGS FOR EXTENT. SEE BUILDING ENVELOPE DESIGN DRAWINGS FOR PARAPET FRAMING AND SUPPLEMENTAL ROOF REINFORCEMENT, WHERE REQUIRED.

1 ROOF FRAMING PLAN
 1/8" = 1'-0"