


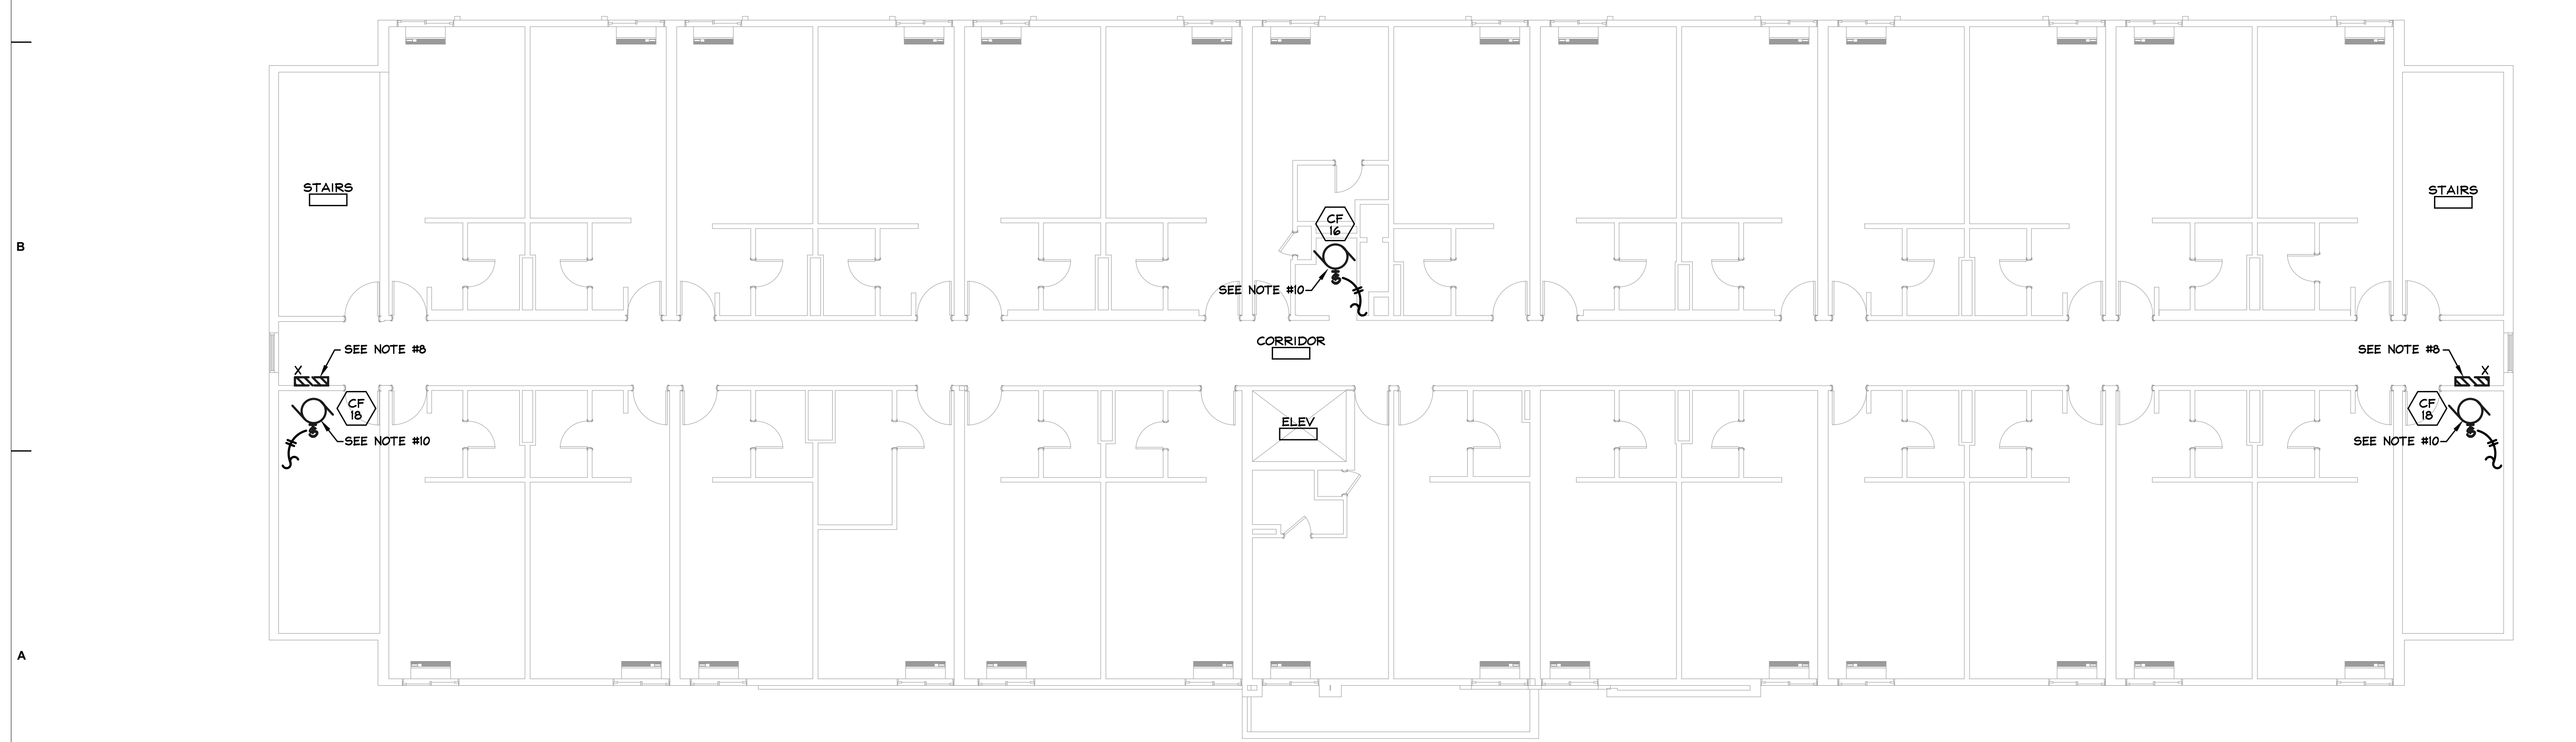

**MECHANICAL POWER PLAN NOTES**

- |   |   |
|---|---|
| <p>1. COORDINATE WITH THE MECHANICAL DRAWINGS BEFORE COMMENCING WORK.</p> <p>2. MAINTAIN EXISTING BRANCH CIRCUITS OUTSIDE OF RENOVATED AREAS.</p> <p>3. PROVIDE HOMERUN(S) TO NEW 20A-1P C/B(S) INSTALLED IN AVAILABLE SPACE IN EXISTING PANELBOARD DESIGNATED.</p> <p>4. PROVIDE HOMERUN TO NEW CIRCUIT BREAKER INSTALLED IN AVAILABLE SPACE IN PANELBOARD DESIGNATED.</p> <p>5. EACH ITEM REFERRED TO THIS NOTE IS AN EXISTING UNIT OF MECHANICAL EQUIPMENT TO BE ELECTRICALLY DISCONNECTED BY THE ELECTRICAL CONTRACTOR, AND RELOCATED AS SHOWN BY THE MECHANICAL CONTRACTOR. THE ELECTRICAL CONTRACTOR SHALL EXTEND THE EXISTING MECHANICAL EQUIPMENT BRANCH CIRCUITRY OR FEEDER TO THE NEW LOCATION INDICATED ON THE FLOOR PLAN.</p> <p>6. EACH ITEM REFERRED TO THIS NOTE IS AN EXISTING UNIT OF MECHANICAL EQUIPMENT TO BE RELOCATED (ALONG WITH ITS</p> | <p>ASSOCIATED POWER CIRCUITRY) TO THE LOCATION INDICATED.</p> <p>7. CONNECT TO AREA UNSWITCHED 120V RECEPTACLE CIRCUIT.</p> <p>8. EACH ITEM REFERRED TO THIS NOTE IS AN EXISTING UNIT OF MECHANICAL EQUIPMENT TO BE ELECTRICALLY DISCONNECTED BY THE ELECTRICAL CONTRACTOR AND REMOVED BY THE MECHANICAL CONTRACTOR. THE ELECTRICAL CONTRACTOR SHALL REMOVE THE MECHANICAL EQUIPMENT BRANCH CIRCUIT BACK TO ITS POINT OF SUPPLY.</p> <p>9. PROVIDE HOMERUN (AS INDICATED) TO NEW CIRCUIT BREAKER INSTALLED IN AVAILABLE SPACE IN PANELBOARD DESIGNATED.</p> <p>10. EACH ITEM REFERRED TO THIS NOTE IS AN EXISTING EXHAUST FAN TO BE ELECTRICALLY DISCONNECTED BY THE ELECTRICAL CONTRACTOR AND REMOVED BY THE MECHANICAL CONTRACTOR. THE MECHANICAL CONTRACTOR SHALL INSTALL NEW EXHAUST FAN AT THE SAME LOCATION AND THE ELECTRICAL CONTRACTOR SHALL ELECTRICALLY CONNECT NEW EXHAUST FAN TO THE EXISTING BRANCH CIRCUITRY AT THAT LOCATION.</p> |
|---|---|

**SECOND FLOOR MECH. POWER PLAN**  
1/8" = 1'-0"



**THIRD FLOOR MECH. POWER PLAN**  
1/8" = 1'-0"

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**REVISIONS**


Job Number:	216266
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Checked By:	RFQ/JH
Phase:	PROGRESS SET

Drawing Title:

**SECOND AND THIRD FLOOR MECHANICAL POWER PLANS**

SHEET NUMBER:

**E2.2**

DATE: 27 JANUARY 2017