
# BRAMHALL RESIDENT

# 25 BRAMHALL STREET


PORTLAND, MAINE 04104

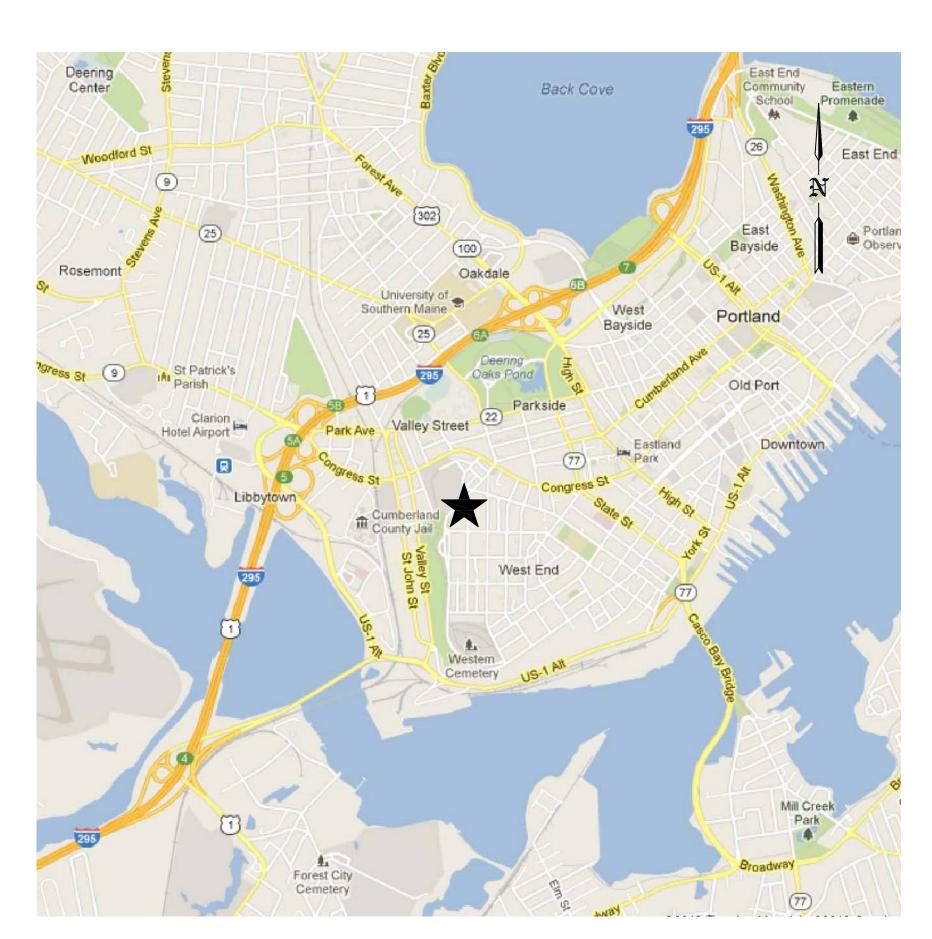

SITE MAP



SITE LOCATION

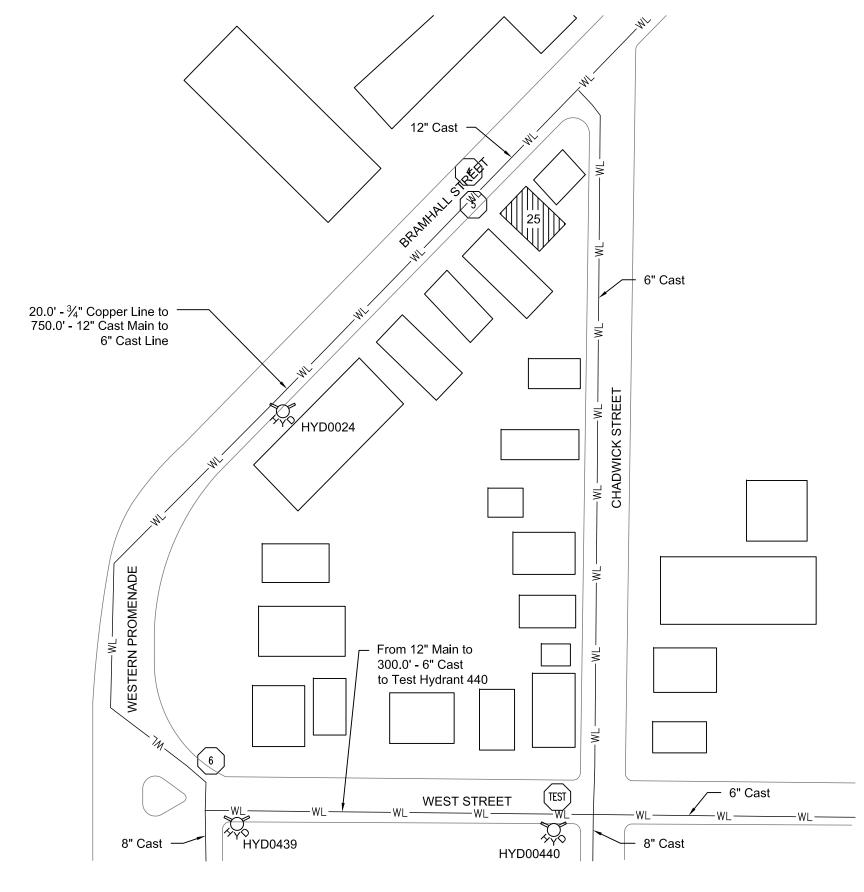

SITE UNDERGROUND HYDRANTS AND LINES



6 DOWD ROAD, BANGOR, MAINE 04401 Ph: 207-942-8809, Fax: 207-941-1910 mailto:service@mefirepro.com


### **HYDRANT INFORMATION**

No.	DATE	STATIC	RESID	FLOW	ELEV
0024	08/21/1991	42		830	152.0
0439	08/09/2007	48		1342	156.0
0440	08/09/2007	49	45		152 0

## **DRAWING LIST**


#### Page No. DESCRIPTION

FP-1 BASEMENT & FIRST FLOOR PLAN & DETAILS
FP-2 SECOND & THIRD FLOOR PLAN & DETAILS

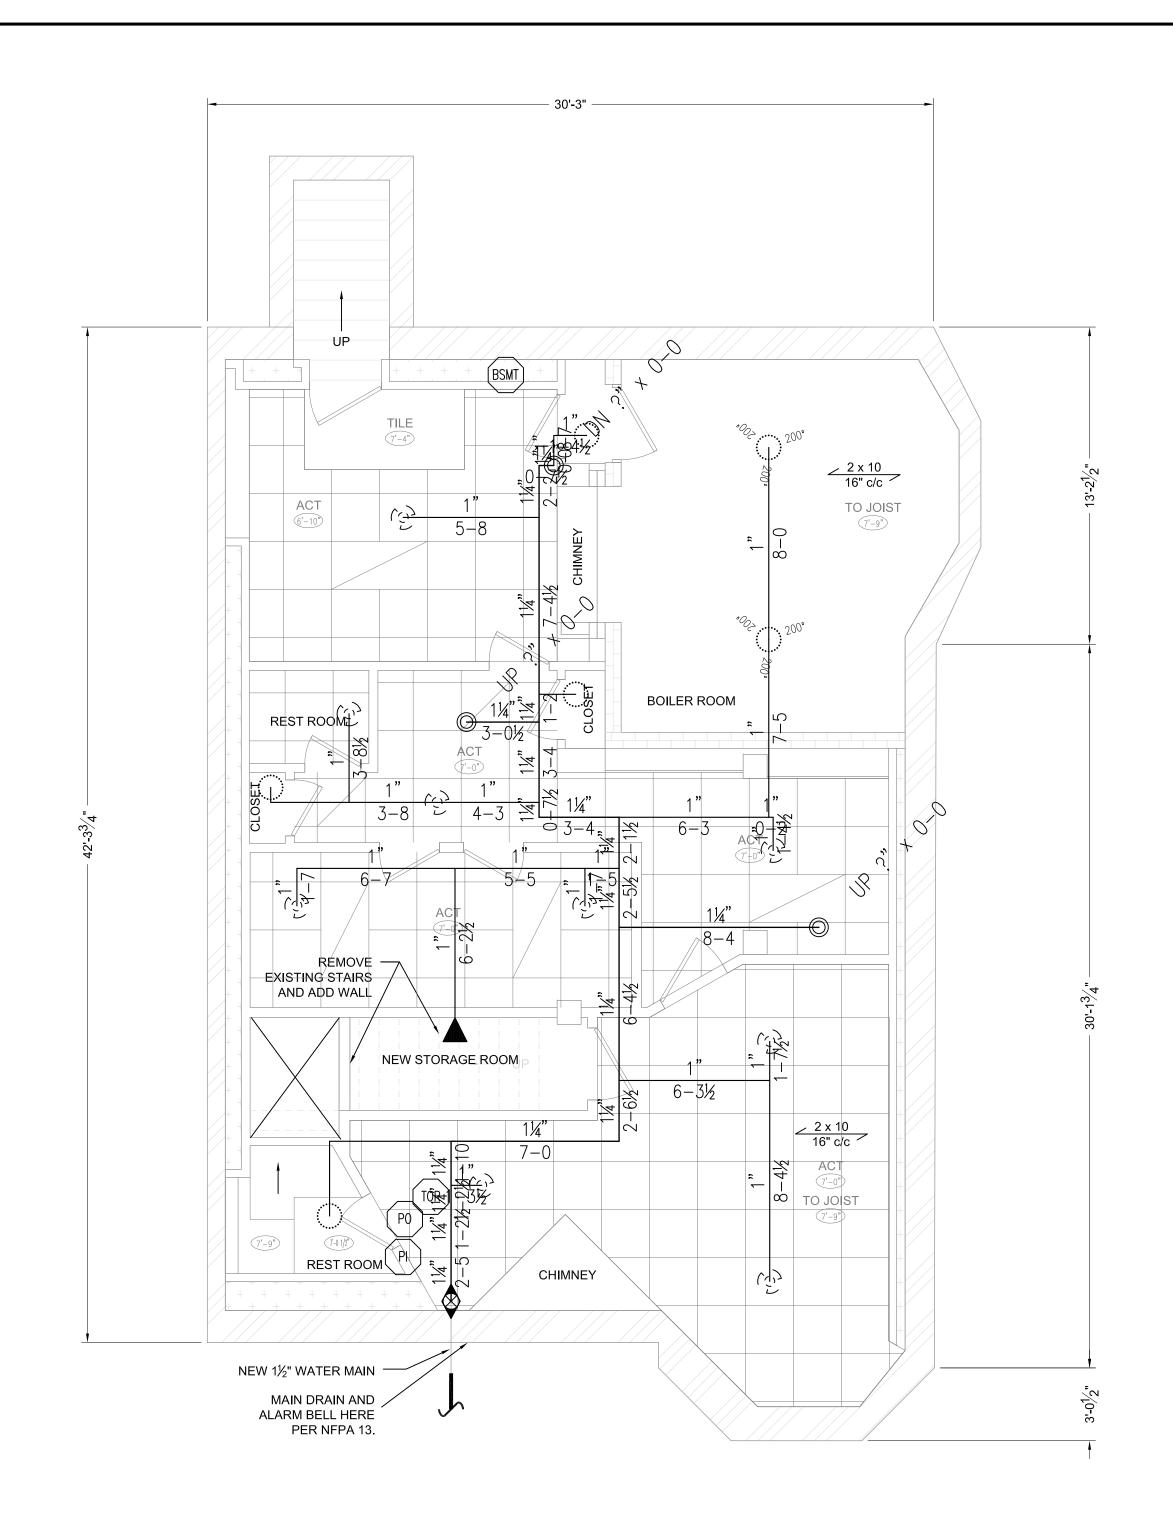


**BASEMENT PLAN** 

1/4"=1'-0"

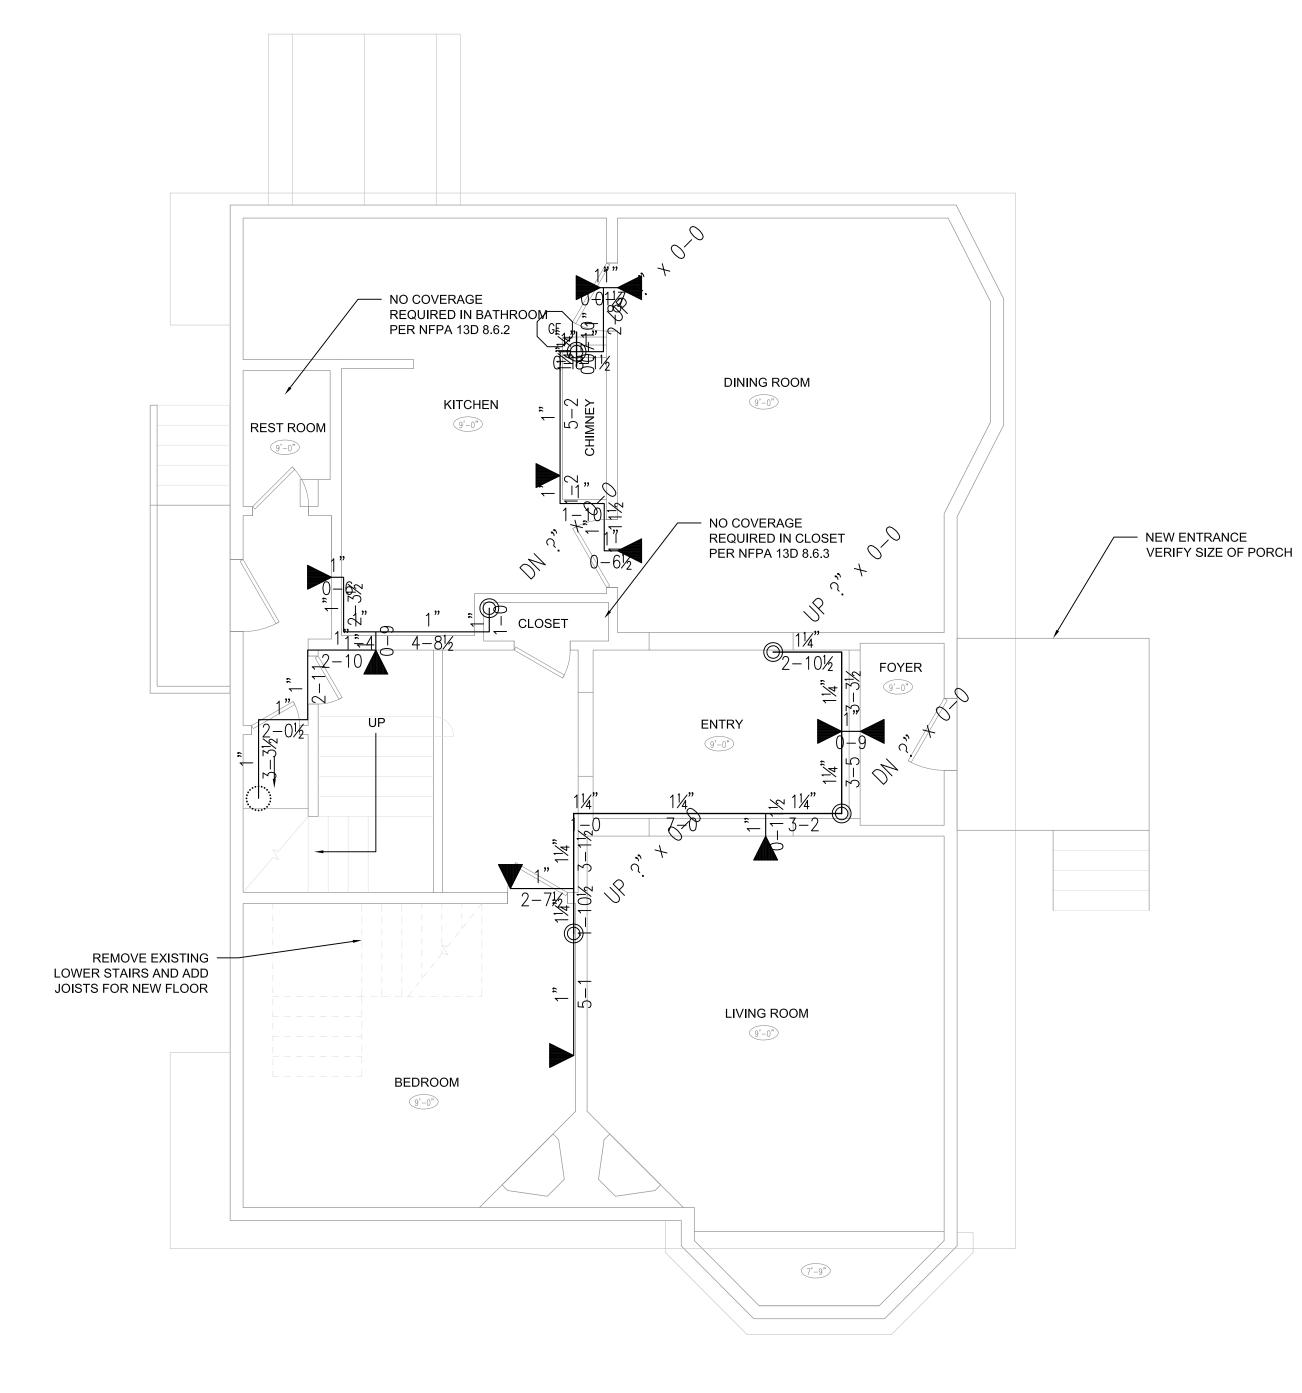


FIRST FLOOR PLAN 1/4"=1'-0"

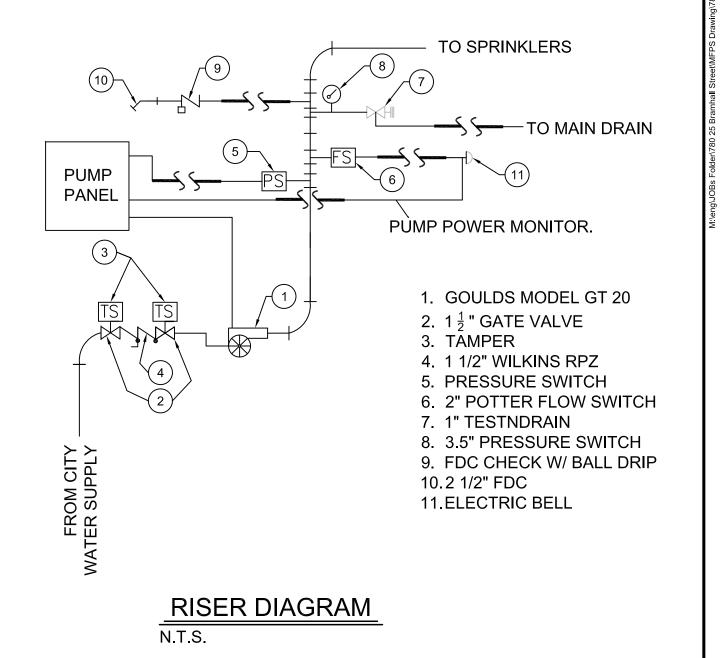


#### JOB SCOPE:

- 1. INSTALL WET TYPE SPRINKLER SYSTEM PER NFPA 13D IN EXISTING THREE STORY HOUSE w / BASEMENT OUTSIDE OF DWELLING AREA. BASEMENT ACCESS SEPERATE FROM REST OF BUILDING.
- SPRINKLER SYSTEM FED FROM CITY WATER SUPPLY w / GOULDS PUMP, MODEL GT20 50/50.
- 3. TWO FOOT ELEVATION CHANGE FROM HYDRANT 440 TO RISER.
- 4. SPRINKLERS APPROX. 45

GENERAL NOTES ALL DIMENSIONS SHOWN ARE CENTER TO CENTER.
PIPE 1-1/2" AND SMALLER TO BE SCHEDULE 40
WITH THREADED CAST IRON FITTINGS.
PIPE 2" AND LARGER TO BE SCHEDULE 10 WITH
GROOVED FITTINGS.
ALL PIPES AND HANGERS ARE TO BE INSTALLED
PER NFPA 13, 2010.
HANGERS ARE TO BE U.L. LISTED AND F.M.
APPROVED.
OWNER SHALL PROVIDE ADEQUATE HEAT TO
PREVENT WET-PIPE SPRINKLER PIPING FROM
FREEZING. OWNER SHALL MAINTAIN SPRINKLER
SYSTEM IN ACCORDANCE WITH NFPA 25 AND ALL
APPLICABLE FEDERAL, STATE, AND LOCAL LAWS.
THIS SYSTEM HAS BEEN DESIGNED BY AND
SHALL BE INSTALLED BY MAINE FIRE PROTECTION SYSTEMS AND USE OF THESE DRAWINGS FOR OTHER PURPOSES IS STRICTLY PROHIBITED.

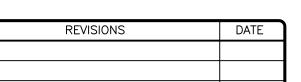

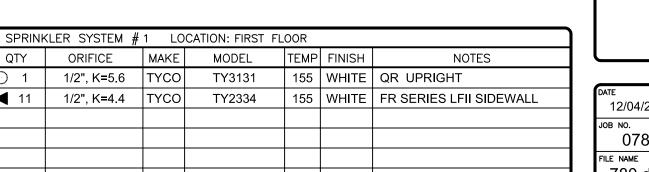


SPRINKLER SYSTEM # 1 LOCATION: BASEMENT							
QTY	ORIFICE	MAKE	MODEL	ТЕМР	FINISH	NOTES	
안 12	1/2", K=5.6	TYCO	TY3131	155	WHITE	QR PENDENT ON DROP	
<b>)</b> 4	1/2", K=5.6	TYCO	TY3131	155	BRASS	QR UPRIGHT	
<b>1</b>	1/2", K=4.4	TYCO	TY2334	155	WHITE	FR SERIES LFII SIDEWALL	
<sup>200</sup> 2	1/2", K=5.6	TYCO	TY3131	200	BRASS	QR UPRIGHT	
2000							


1/2", K=4.4 TYCO




DATE	CONTRACTOR			
12/04/2012	MAINE FIRE PROTECTION 6 DOWD ROAD			
JOB NO.				
0780				
FILE NAME	BANGOR, ME 04401			
780.dwg				
DESIGNED BY	DRAWN BY	APPROVAL BY		
CEM	DPW	ST FIRE MARSHAL		

BRAMHALL RESIDENT 25 BRAMHALL STREET PORTLAND, MAINE 04101 BASEMENT & FIRST FLOOR PLAN & DETAILS SHEET 1 OF 2

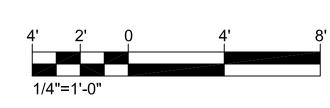

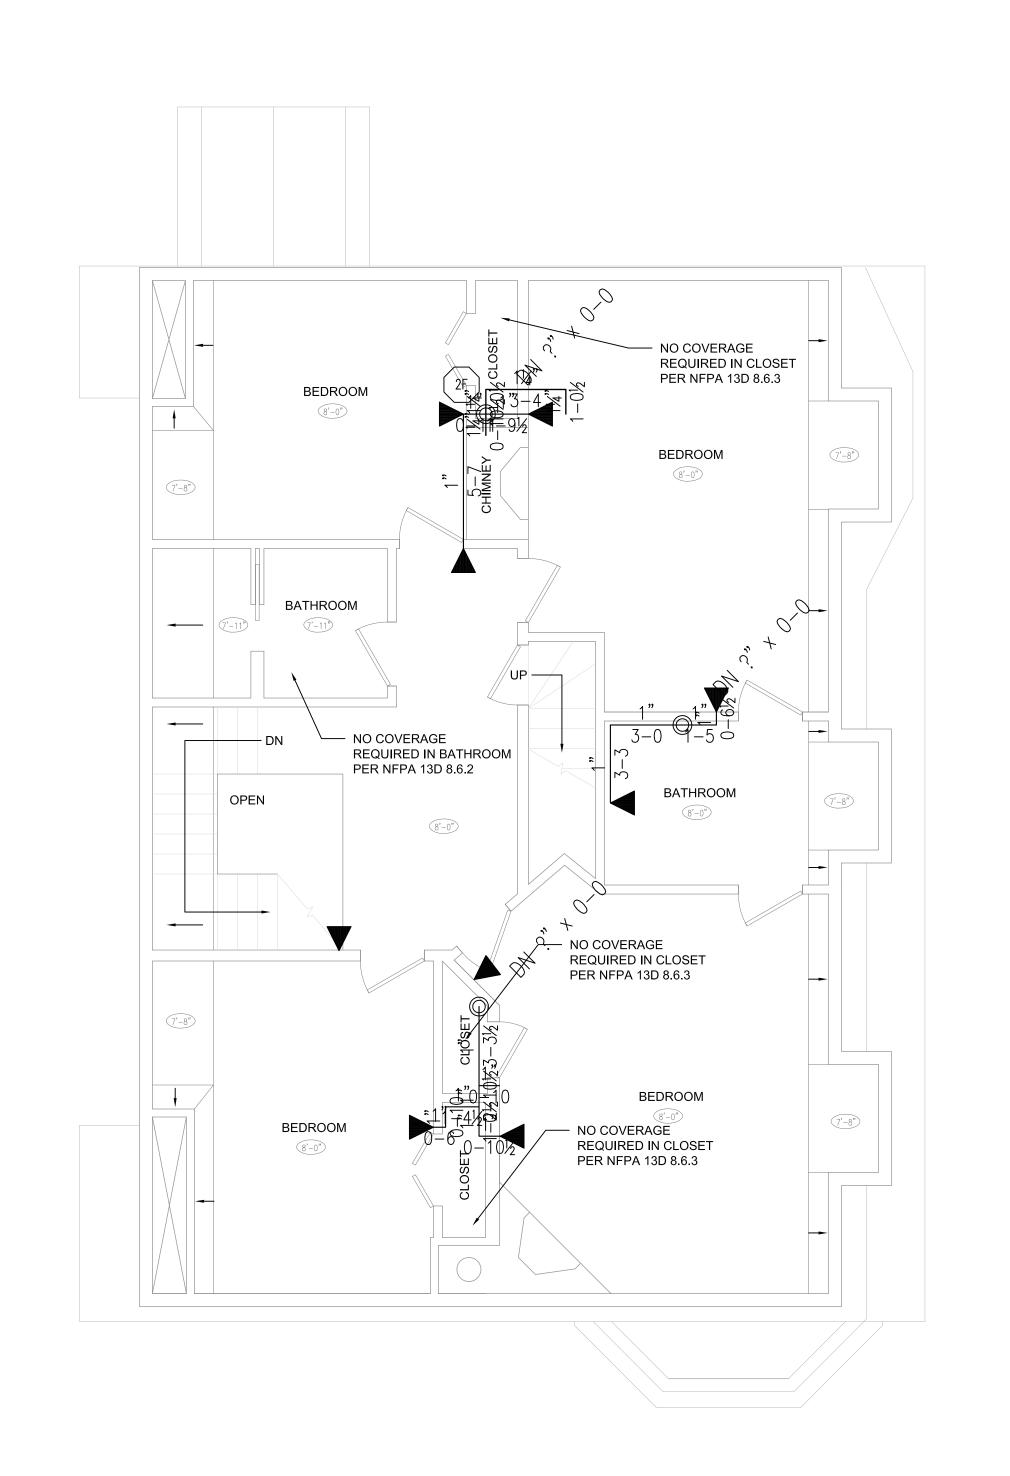


SECOND FLOOR PLAN
1/4"=1'-0"

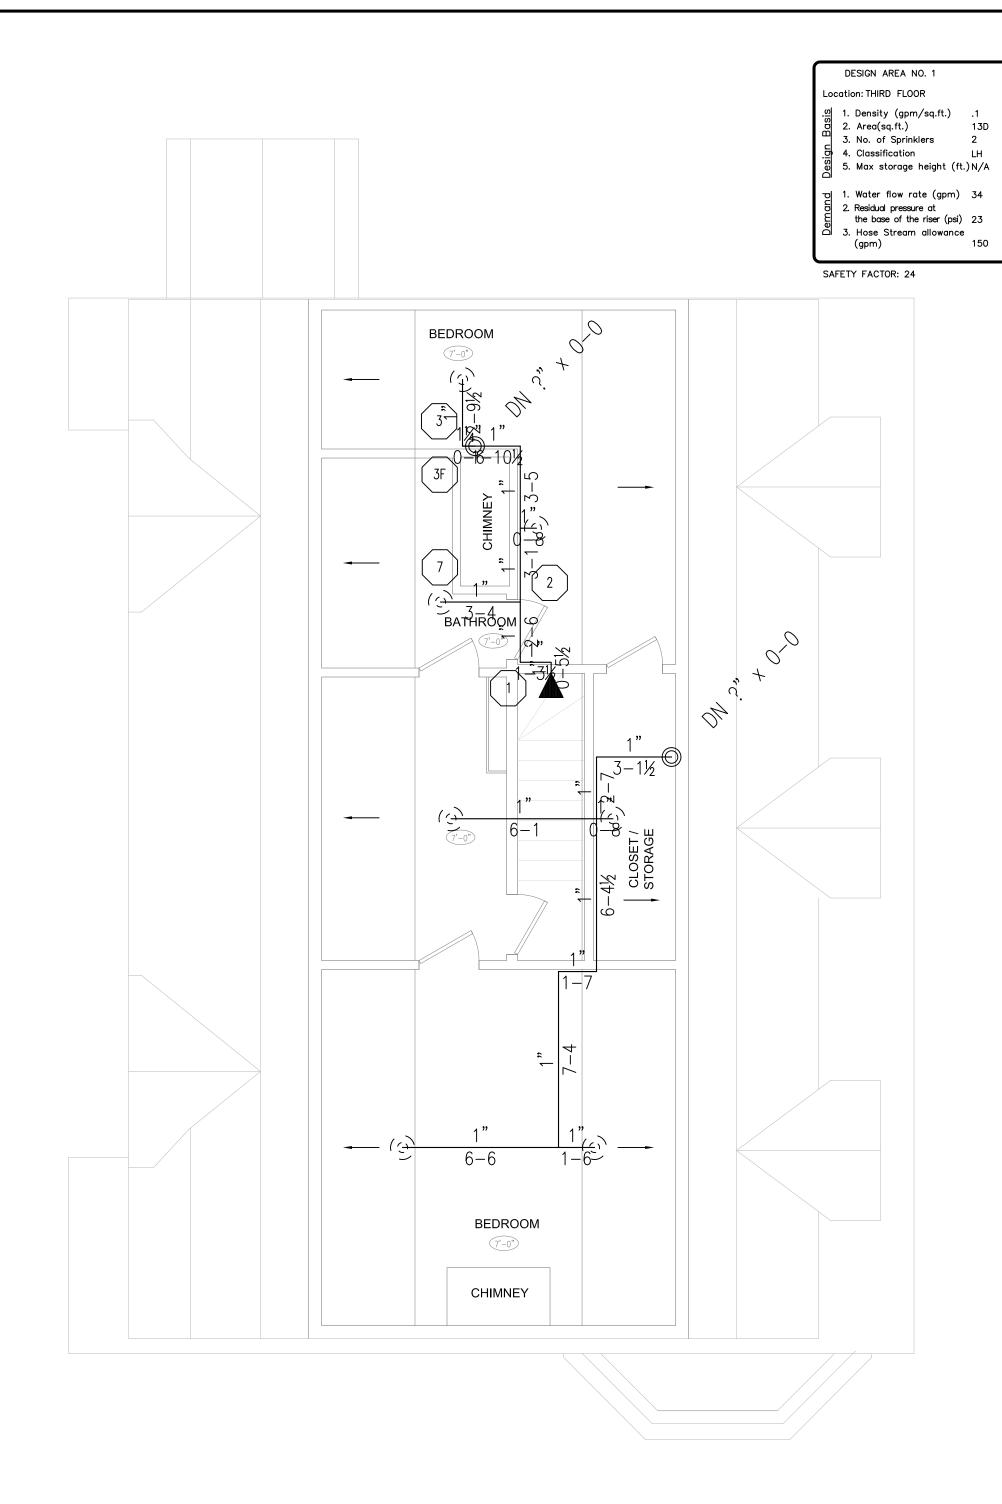


THIRD FLOOR PLAN


1/4"=1'-0"

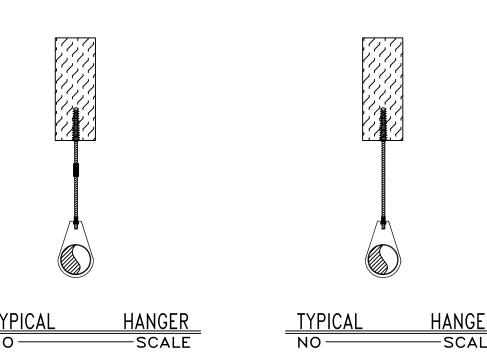

1 —— Coach Screw Rod 1 —— Ring

1 -- Coach Screw Rod
1 -- All Thread Rod (4" Shorter Than Overall Length)
1 -- Ring
1 -- Rod Coupling

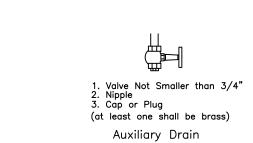

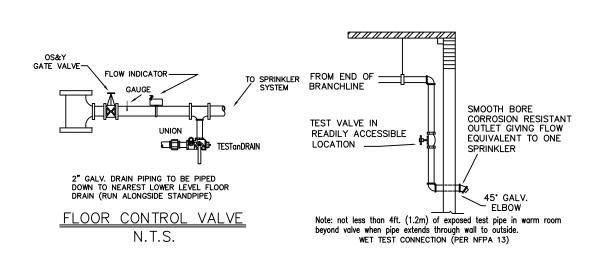

GENERAL NOTES

ALL DIMENSIONS SHOWN ARE CENTER TO CENTER.
PIPE 1-1/2" AND SMALLER TO BE SCHEDULE 40
WITH THREADED CAST IRON FITTINGS.
PIPE 2" AND LARGER TO BE SCHEDULE 10 WITH
GROOVED FITTINGS.
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APPLICABLE FEDERAL, STATE, AND LOCAL LAWS.
THIS SYSTEM HAS BEEN DESIGNED BY AND
SHALL
BE INSTALLED BY MAINE FIRE PROTECTION
SYSTEMS AND USE OF THESE DRAWINGS FOR
OTHER PURPOSES IS STRICTLY PROHIBITED.

REVISIONS	DATE

SPRINKLER SYSTEM # 1 LOCATION: THIRD FLOOR							
QTY	ORIFICE	MAKE	MODEL	TEMP	FINISH	NOTES	
<u>ල</u> 7	1/2", K=4.9	TYCO	TY2234	155	WHITE	FR SERIES LFII PENDENT	
<b>1</b>	1/2", K=4.4	TYCO	TY2334	155	WHITE	FR SERIES LFII SIDEWALL	

SPRINKLER SYSTEM # 1 LOCATION: SECOND FLOOR							1
QTY	ORIFICE	MAKE	MODEL	ТЕМР	FINISH	NOTES	
<b>⋖</b> 9	1/2", K=4.4	TYCO	TY2334	155	WHITE	FR SERIES LFII SIDEWALL	
					1		

MAINE FII PROTECTI SYSTEMS	ON
,	RMS LICENS

DATE	CONTRACTOR			
12/04/2012	MAINE FIRI	MAINE FIRE PROTECTION		
от образования об		WD ROAD		
FILE NAME 780.dwg	BANGO	R, ME 04401		
DESIGNED BY CEM	DRAWN BY	APPROVAL BY ST FIRE MARSHAL		
JOB NAME	-			

BRAMHALL RESIDENT

25 BRAMHALL STREET

PORTLAND, MAINE 04101

SECOND & THIRD FLOOR PLAN

& DETAILS

4" = 1'-0"

SHEET 2\_0F\_2



