

◆ PARTITION SCHEDULE

[REFER TO PARTITION GENERAL NOTES ALSO]

"A" PARTITIONS -

- ◆ 8" STEEL STUDS EXTEND FROM FLOOR RUNNER TO RUNNER AT STRUCTURE ABOVE.
- ◆ PROVIDE:
 - ONE LAYER 1/2" PLYWOOD SUBSTRATE (SIDE LABELED "P")
 - ONE LAYER 5/8" TYPE "X" BOARD ON CORRIDOR SIDE OF WALL - FULL HEIGHT TIGHT TO DECK ABOVE
 - SOUND ATTENUATION INSULATION
 - ONE LAYER 5/8" TYPE "X" ON OPPOSITE SIDE OF WALL - FULL HEIGHT TIGHT TO DECK ABOVE
 - ONE HOUR RATING
- ◆ PROVIDE:
 - 1/2" PLYWOOD SUBSTRATE (BOTH SIDES OF WALL)
 - ONE LAYER 5/8" TYPE "X" GWB (BOTH SIDES OF WALL) - FULL HEIGHT TIGHT TO DECK ABOVE
 - SOUND ATTENUATION INSULATION
 - 1" SOUND ISOLATION CLIP W/ 7/8" STL CHANNEL - LOCATE ON SIDE MARKED "R"
 - ONE HOUR RATING
- ◆ PROVIDE:
 - ACOUSTIC FABRIC PANEL (AUDITORIUM SIDE OF WALL)
 - ONE LAYER 5/8" TYPE "X" BOARD ONE SIDE OF WALL
 - ONE HOUR RATING
- ◆ PROVIDE:
 - 1/2" PLYWOOD SUBSTRATE (BOTH SIDES OF WALL)
 - ONE LAYER 3/8" HARDWOOD VENEER PLYWOOD PANELING - SOUND ATTENUATION INSULATION
 - ONE HOUR RATING

"B" PARTITIONS -

- ◆ 8" STEEL STUDS EXTEND FROM FLOOR RUNNER TO RUNNER AT STRUCTURE ABOVE.
- ◆ PROVIDE:
 - ONE LAYER 5/8" GWB BOTH SIDES OF WALL
 - SOUND ATTENUATION INSULATION
- ◆ ADD TO ASSEMBLIES NOTED "R":
 - 1" SOUND ISOLATION CLIP W/ 7/8" STL CHANNEL
- ◆ PROVIDE:
 - 1/2" PLYWOOD SUBSTRATE BOTH SIDES OF WALL
 - ONE LAYER 5/8" GWB BOTH SIDES OF WALL
 - SOUND ATTENUATION INSULATION
- ◆ PROVIDE:
 - CERAMIC TILE OVER BACKER BOARD ON BATHROOM SIDE OF WALL
 - ONE LAYER 1/2" PLYWOOD SUBSTRATE (SIDE LABELED "P")
 - ONE LAYER 5/8" GWB ON OTHER SIDE OF WALL

"B" PARTITIONS CONTINUED-

- ◆ PROVIDE:
 - 1/2" PLYWOOD SUBSTRATE BOTH SIDES OF WALL
 - ONE LAYER TYPE "X" 5/8" GWB BOTH SIDES OF WALL
 - ONE HOUR RATING
- ◆ PROVIDE:
 - 3/8" HARDWOOD VENEER PLYWOOD PANELING (BOTH SIDES OF WALL)
 - ONE LAYER 5/8" TYPE "X" BOARD BOTH SIDES OF WALL
 - 1/2" PLYWOOD SUBSTRATE (BOTH SIDES OF WALL)
 - SOUND ATTENUATION INSULATION
 - ONE HOUR RATING
- ◆ PROVIDE:
 - ACOUSTIC FABRIC PANEL (AUDITORIUM SIDE OF WALL)
 - SOUND ATTENUATION INSULATION
 - 1/2" PLYWOOD SUBSTRATE (OTHER SIDE OF WALL)
 - ONE LAYER 5/8" TYPE "X" BOARD BOTH SIDES OF WALL
 - ONE HOUR RATING
- ◆ PROVIDE:
 - CERAMIC TILE OVER 1/2" BACKER BOARD (BOTH SIDES OF WALL)
 - SOUND ATTENUATION INSULATION

"B" PARTITIONS CONTINUED-

- ◆ PROVIDE:
 - CERAMIC TILE OVER 1/2" BACKER BOARD (BATHROOM SIDE OF WALL)
 - 1/2" PLYWOOD SUBSTRATE @ 16" O.C.
 - SOUND ATTENUATION INSULATION
 - ONE LAYER 1/2" PLYWOOD SUBSTRATE (SIDE LABELED "P")
 - ONE LAYER 5/8" GWB OTHER SIDE OF WALL
- ◆ PROVIDE:
 - ONE LAYER 1/2" PLWD SUBSTRATE (SIDE LABELED "P")
 - ONE LAYER 5/8" GWB BOTH SIDES OF WALL
 - SOUND ATTENUATION INSULATION
 - 1" SOUND ISOLATION CLIP W/ 7/8" STL CHANNEL - LOCATE ON SIDE MARKED "R"


"C" PARTITIONS -

- ◆ 8" STEEL STUDS EXTEND FROM FLOOR RUNNER TO RUNNER AT STRUCTURE ABV. & AT:
- ◆ PROVIDE:
 - ONE LAYER 5/8" BOARD ON BOTH SIDES OF WALL
- ◆ PROVIDE:
 - ONE LAYER 1/2" PLWD SUBSTRATE (SIDE LABELED "P")
 - ONE LAYER 5/8" GWB ON BOTH SIDES OF WALL
- ◆ PROVIDE:
 - ONE LAYER 1/2" PLWD SUBSTRATE BOTH SIDES
 - ONE LAYER 5/8" GWB BOTH SIDES OF WALL
 - SOUND ATTENUATION INSULATION
- ◆ PROVIDE:
 - CERAMIC TILE OVER 1/2" BACKER BOARD ON BATHROOM SIDE OF WALL
 - SOUND ATTENUATION INSULATION
 - ONE LAYER 1/2" PLWD SUBSTRATE (OTHER SIDE)
 - ONE LAYER 5/8" GWB BOARD ON OTHER SIDE OF WALL
- ◆ PROVIDE:
 - ONE LAYER 3/8" HARDWOOD VENEER PLYWOOD PANELING
 - ONE LAYER 1/2" PLWD SUBSTRATE (BOTH SIDES)
 - ONE LAYER 5/8" GWB ON OTHER SIDE OF WALL
- ◆ PROVIDE:
 - ONE LAYER 5/8" TYPE "X" GWB (BOTH SIDES OF WALL)
 - FULL HEIGHT TIGHT TO DECK ABOVE
- ◆ PROVIDE:
 - ONE LAYER 1/2" PLWD SUBSTRATE (SIDE LABELED "P")
 - ONE LAYER 5/8" GWB (ONE SIDE OF WALL)



"D" PARTITIONS - OMITTED

"E" PARTITIONS -

- ◆ PROVIDE:
 - ONE LAYER 3/8" HARDWOOD VENEER PLYWOOD PANELING
 - ONE LAYER 1/2" PLWD SUBSTRATE
 - ONE LAYER 5/8" GWB TYPE "X" (ON BOTH SIDES) - FULL HEIGHT TIGHT TO DECK ABOVE
 - 8" STEEL STUDS EXTEND FROM FLOOR RUNNER TO RUNNER AT STRUCTURE ABOVE
 - SOUND ATTENUATION INSULATION
 - 3" AIR SPACE
 - 3" 5/8" STEEL STUDS EXTEND FROM FLOOR RUNNER TO RUNNER AT STRUCTURE ABOVE
 - ONE LAYER 1/2" PLWD SUBSTRATE
 - ONE LAYER 5/8" GWB (CORRIDOR SIDE)
 - ONE HOUR RATING
- ◆ PROVIDE:
 - ONE LAYER 3/8" HARDWOOD VENEER PLYWOOD PANELING
 - ONE LAYER 1/2" PLWD SUBSTRATE
 - 8" FURRING ABOVE PROSCENIUM (SEE A3.3)
 - 6" STEEL STUDS EXTEND FROM TOP OF PROSCENIUM TO RUNNER AT STRUCTURE ABOVE
 - ONE LAYER 3/4" PLWD SUBSTRATE
 - ONE HOUR RATED WALL - - - - -

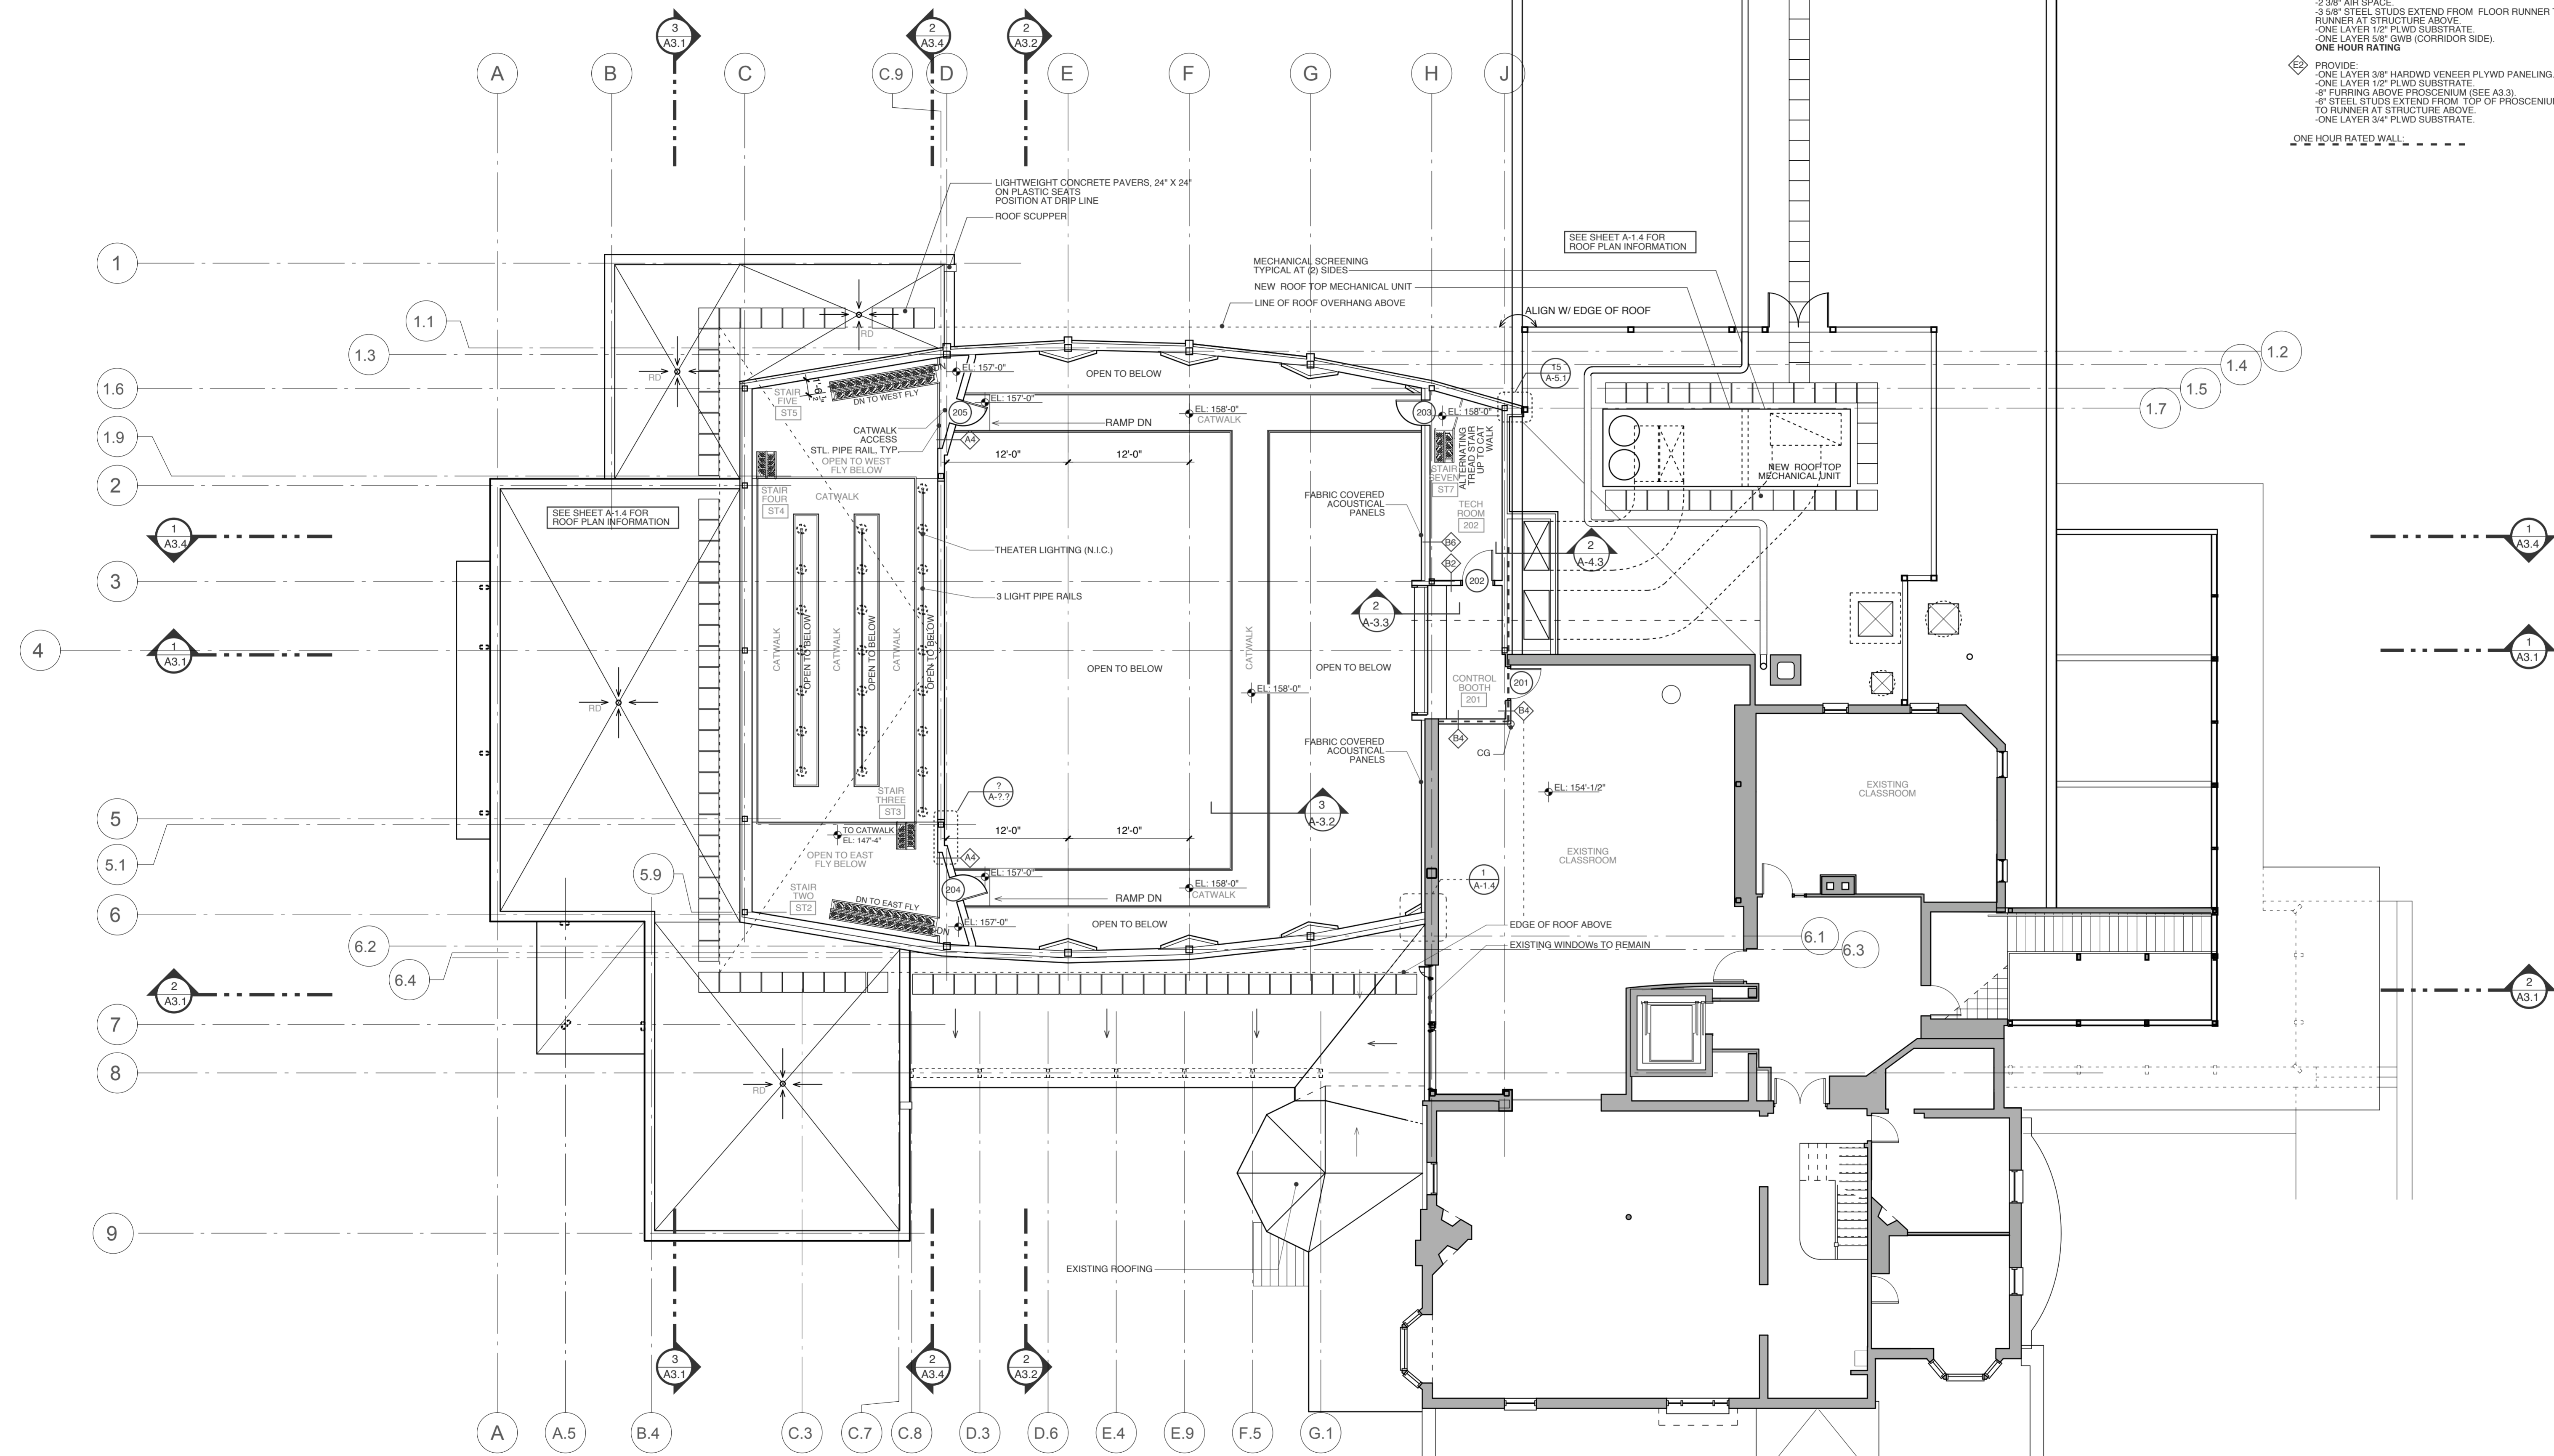

1 UPPER FLOOR PLAN
SCALE: 1/8" = 1'-0"

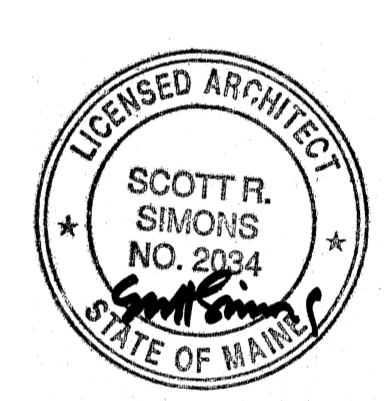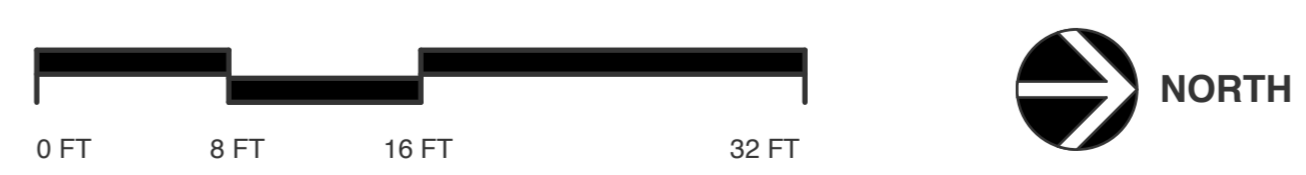

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PROJECT
WAYNFLETE ARTS CENTER PHASE TWO
ADDITION/ RENOVATION
360 SPRING STREET
PORTLAND, ME

TITLE
SECOND FLOOR PLAN

STATUS: **ISSUED FOR BIDDING**
CONSTRUCTION DOCUMENTS

DATE: 09.07.2007 REVISION /DATE:

PROJECT NO. 2003-0040.00
DRAWN BY:

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A-1.3