
SECTION: E-W LOOKING NORTH

SCALE: 1/4" = 1'-0"

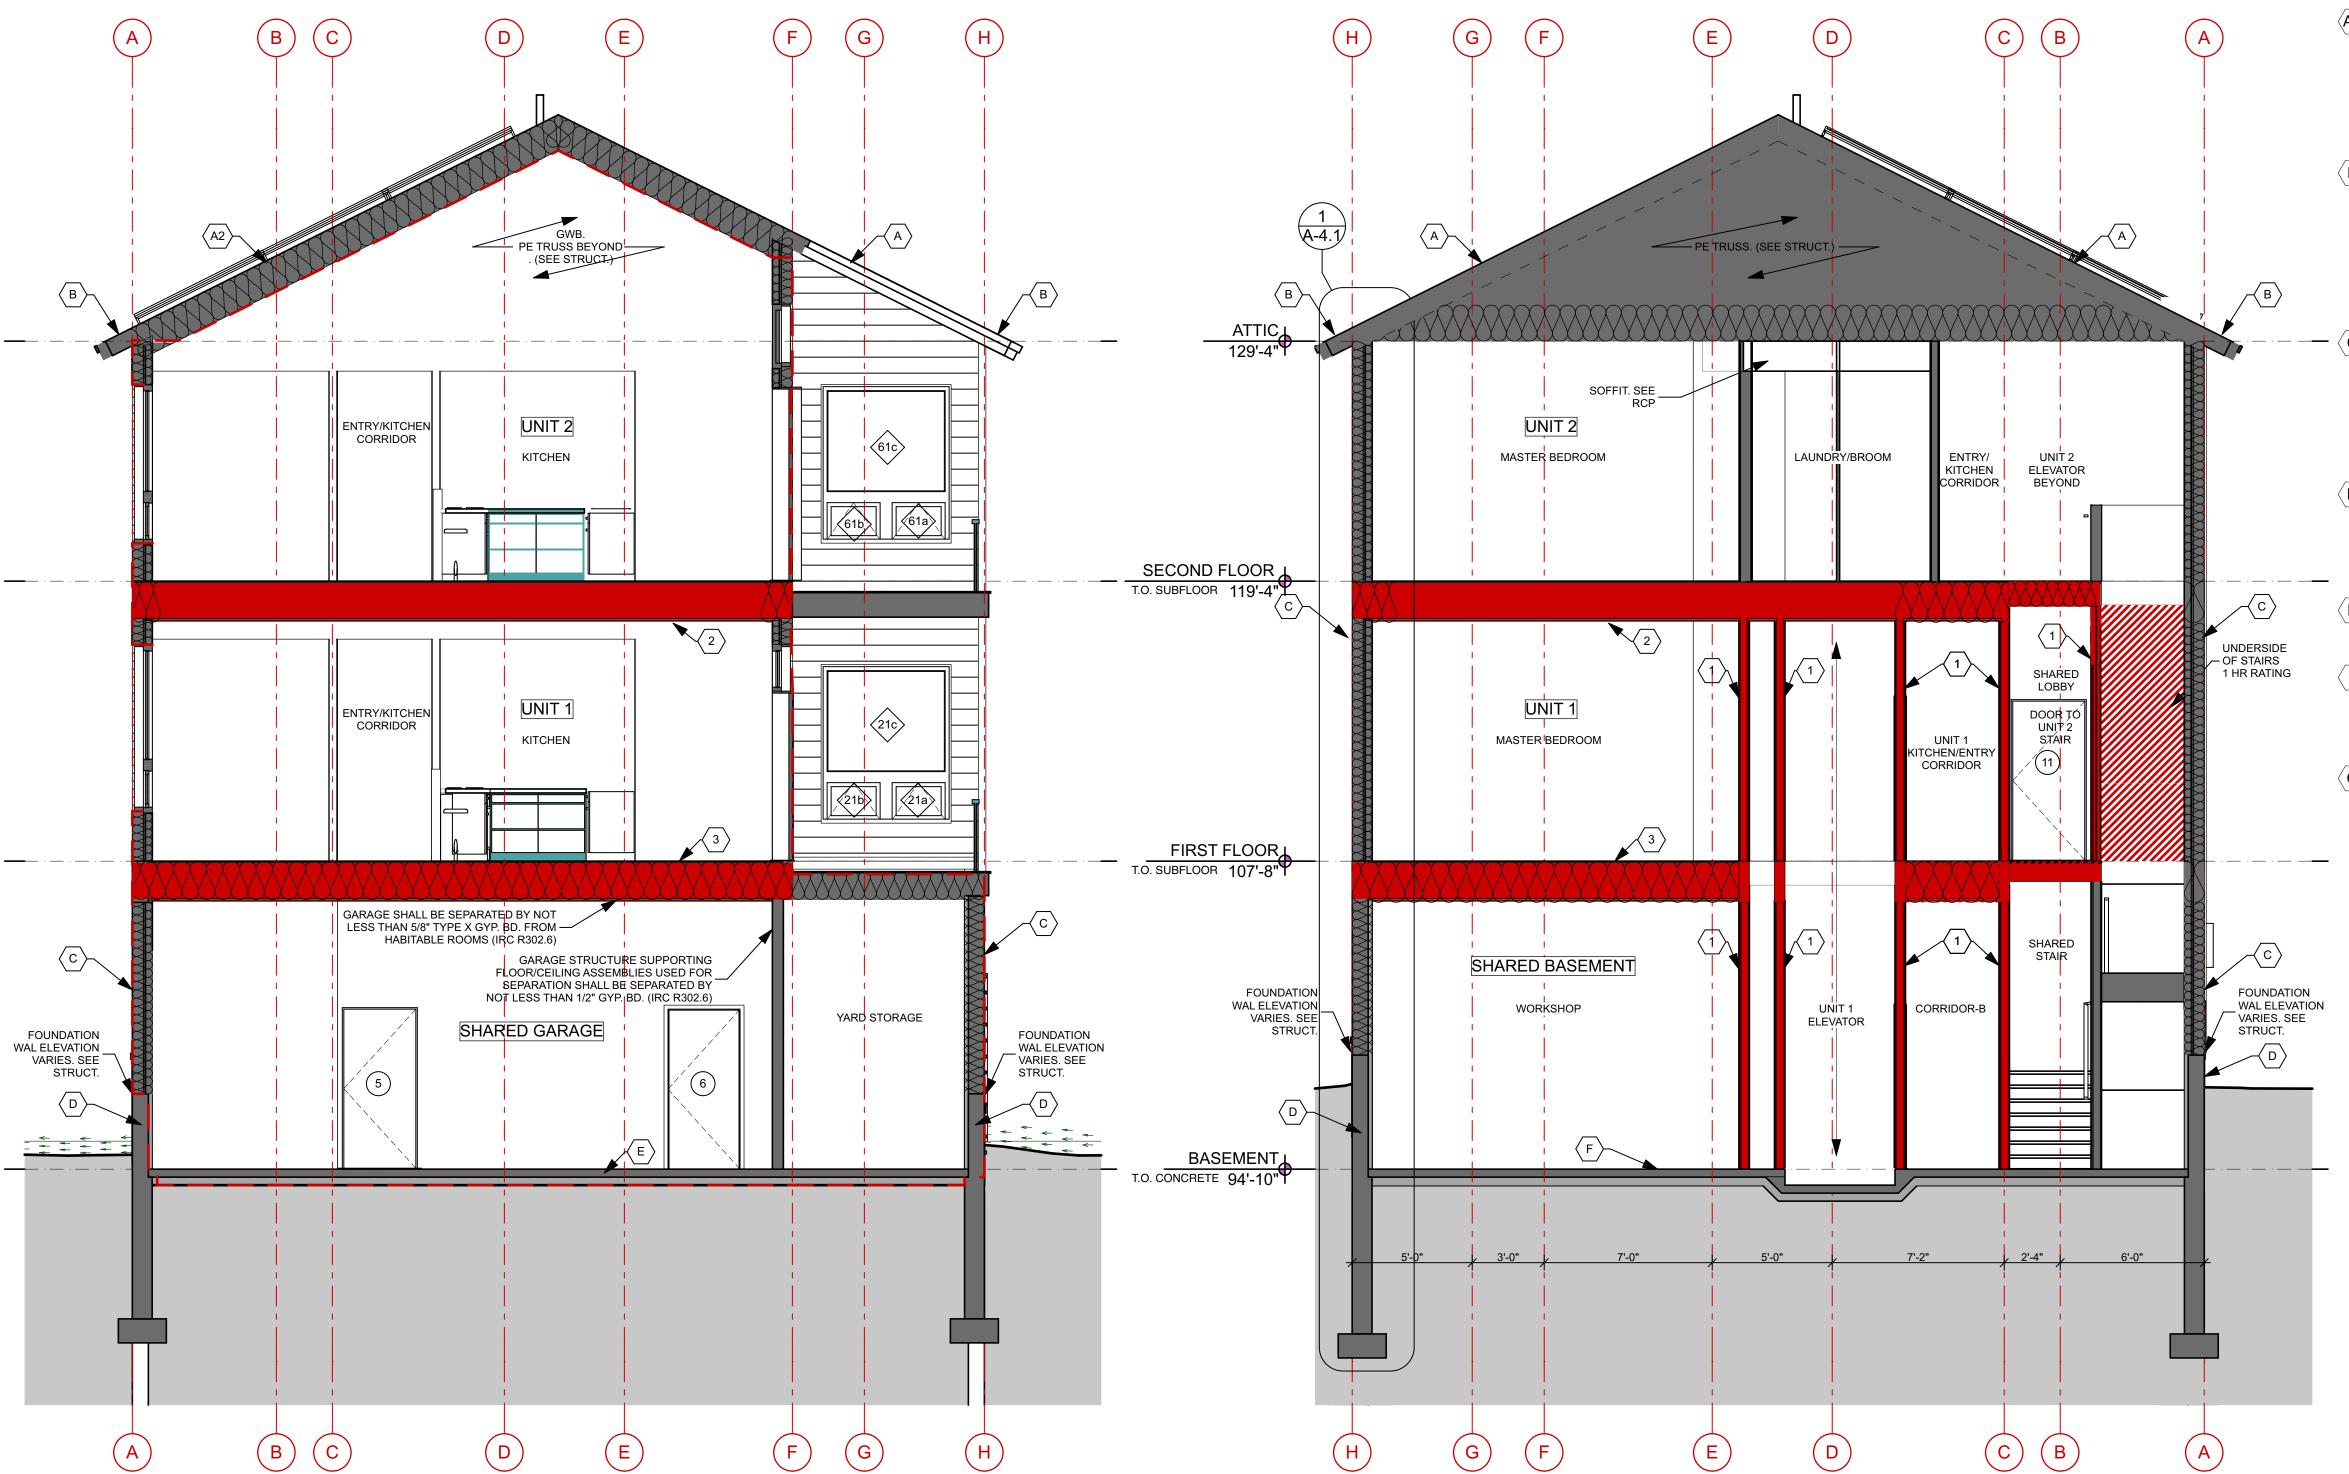

SECTION: E-W LOOKING SOUTH

SCALE: 1/4" = 1'-0"

## **ASSEMBLY NOTES**

A PITCHED ROOFS: ~ R-66.4 Self-Sealing Asphalt Shingles, On Roofing Underlayment, On Roof Sheathing w/ Taped Seams (Air Barrier)(See Struct.), On PE Truss (See Struct.) w/1'-6" Loose Fill Cellulose Insulation, On 1x Strapping On Vapor Retarder Membrane: Intello, ProClima or Certainteed, On GWB Ceiling,

Dropped Ceilings where applicable - See RCP

A2 PITCHED ROOFS (@ CATHEDRAL CEILING): Self-Sealing Asphalt Shingles, On Roofing Underlayment, On Roof Sheathing w/ Taped Seams (Air Barrier)(See Struct.), On PE Truss (See Struct.), w/ Loose Fill Cellulose Insulation full cavity On 1x Strapping
On Vapor Retarder Membrane: Intello, ProClima or Certainteed, On GWB Ceiling

B PITCHED ROOF (@ EAVES): Self-Sealing Asphalt Shingles, On Roofing Underlayment, On Roof Sheathing w/ Taped Seams (Air Barrier)(See Struct.), On PE Truss (See Struct.) On Painted MDO Soffit, See Details for Fascia and Drip Edge information, Overhangs Vary. See Roof Plan.

Exterior Fibercement Siding (Se Exterior Fibercement Siding (See Elevations for Extents), On (1x K.D. strapping w/ black vinyl bug screen), On Henry VP100, On 1/2" CDX Plywood (See Struct.), On 10" Double Stud Framing w/Full-Depth Dense Packed Cellulose On MemBrain Vapor Retarder Membrane, On GWB,

D CONC. FOUND. WALL: R-14.3 @ CONC. FOUND. STEPPED WALL Free Draining Backfill, On Sheet Waterproofing w/ Dimple Mat, Fluid-Applied Damproofing, On Reinforced Concrete Wall (See Struct.), On 2" Rigid EPS Insul. (R-8.5) Taped & Sealed, On 5/8" GWB

E CONC. FOUND. WALL (AT CRAWLSPACE EXTERIOR): Reinforced Concrete Wall (See Struct.),

F INTERIOR SLAB ON GRADE: ~ R-13.6
Sealed Reinforced 4" Concrete slab (See Struct), On 15 Mil. min. Poly Vapor Barrier Taped and Sealed, On 3" Rigid EPS Insulation, On 6" Crushed Gravel Fill (No Fines)

G EXPOSED FRAMED FLOORS: Finish Floor Material (See Interior Finish Schedule), On T+G Sheathing (See Struct.), On Floor Joists (See Struct.) w/Full-Depth Dense Packed Cellulose On 15/16" Pliteq Genie Clips (or equal) On 7/8" Hat Channels On 1/2" CDX Plywood,

On Henry VP100, On 1x Furring, On Painted MDO Soffit

SEE A-4.1 FOR INTERIOR FRAMED FLOOR DETAILS

SEE A-4.1 FOR INTERIOR FIRE RATED WALL DETAIL

BMF2

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**NEW TWO-FAMILY** 

PORTLAND ME 04101

PROJECT:

**DWELLING** 

380 DANFORTH

BUILDING SECTIONS

NOT FOR CONSTRUCTION

PROJECT NO: DATE: 10/11/16 JT/CA DRAWN BY: PHASE: SCHEMATIC DESIGN