


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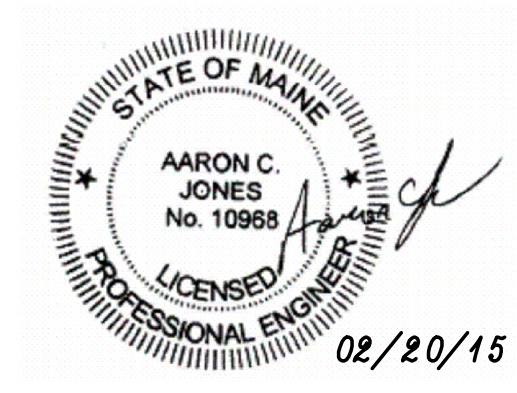
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FRAMING PLAN SYMBOLS KEY	
□	WOOD POST
○	STEEL COLUMN
(X)	NUMBER OF WOOD STUDS IN POST BELOW
A	COLUMN ABOVE THIS LEVEL
C	COLUMN CONTINUOUS THROUGH THIS LEVEL
/E/	EXISTING COLUMN BELOW
—	JOIST BEARING
—	CONTINUOUS JOIST WITH INTERMEDIATE BEARING
—	FLUSH FRAMED JOIST BEARING WITH HANGER
—	WOOD STUD BEARING WALL BELOW
—	SHEAR WALL
"X"	NUMBER OF TRIM STUDS UNDER HEADER
"X"	NUMBER OF KING STUDS ADJACENT TO HEADER

ROOF FRAMING PLAN
SCALE 1/4"=1'-0"
NOTES:
1. SEE S1 FOR GENERAL STRUCTURAL NOTES.
2. ALL WOOD COLUMNS IN 2x6 WALLS SHALL BE 3-2x6 AND IN 2x4 WALLS SHALL BE (3) 2x4, UNO.
3. ALL WOOD BEAMS ARE FLUSH, UNO.
4. ALL HEADERS ARE (2) 2x6, UNO.

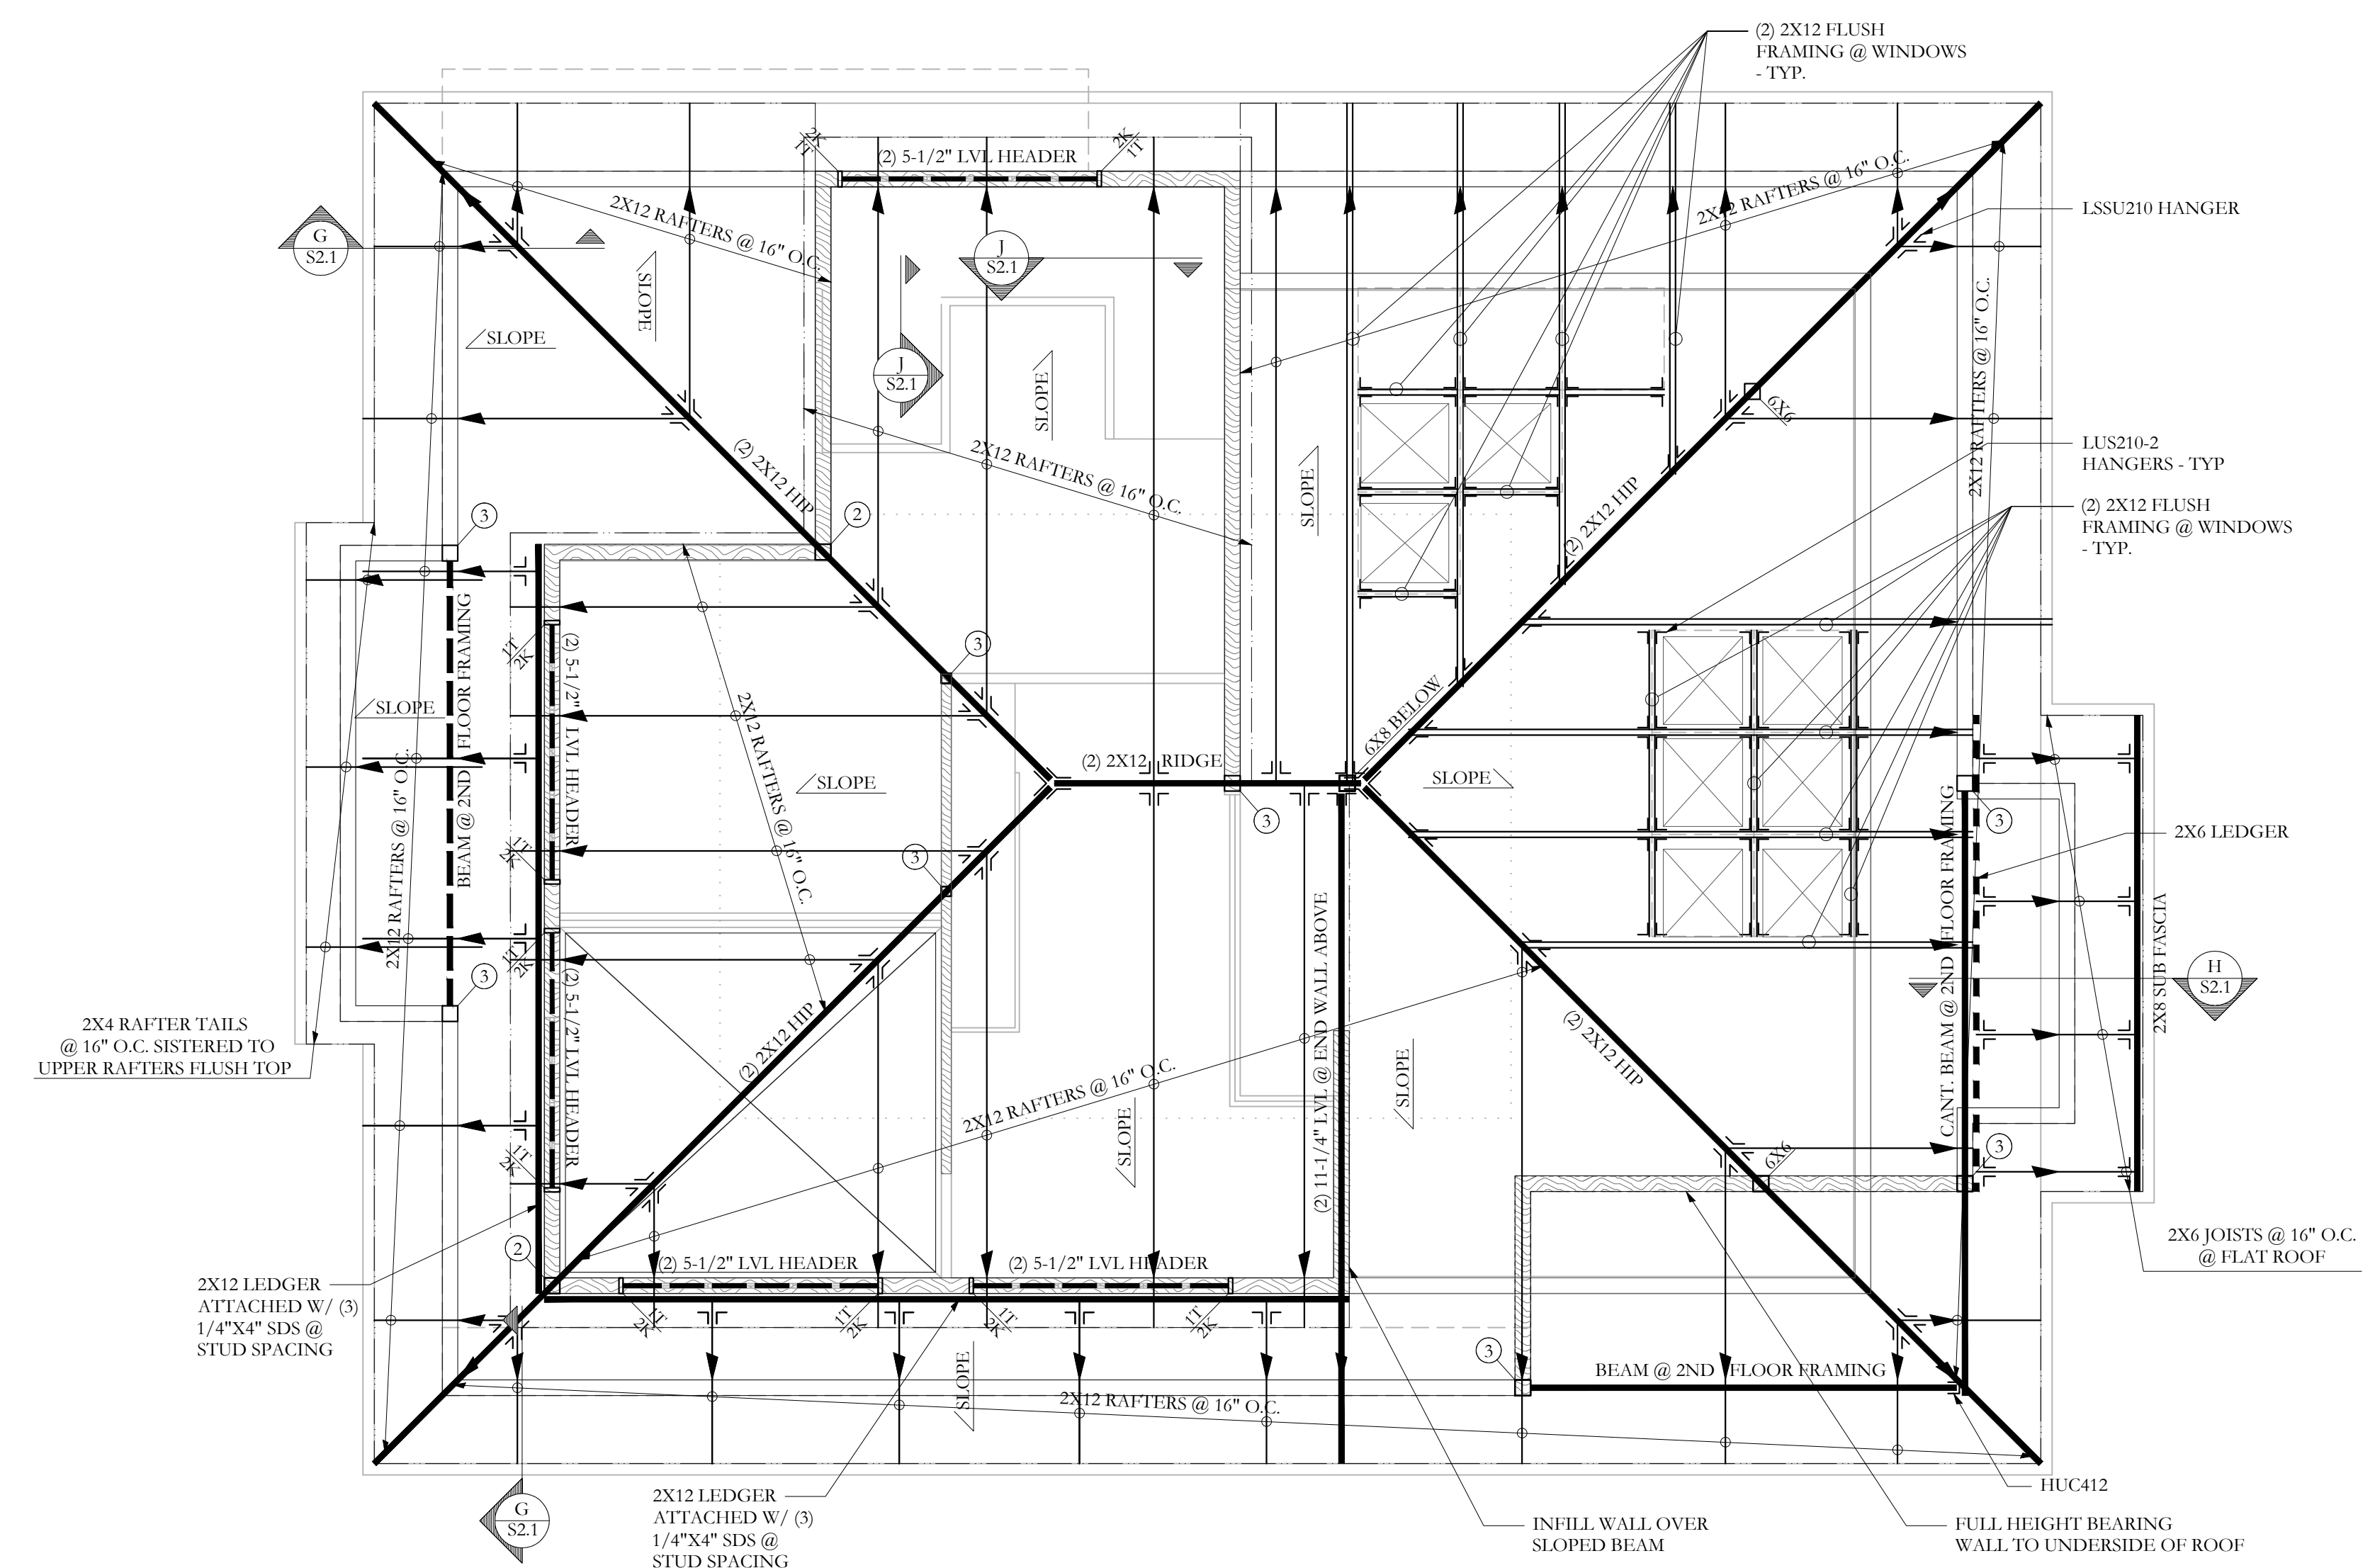

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REVISIONS OF
ROOF FRAMING PLAN

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DRAWN BY
WMC
CHECK BY
ACJ

S1.4