

Administrative Authorization Application Portland, Maine

Planning and Urban Development Department, Planning Division

PROJECT NA	ME: AT	&T MOBIL	ITY WIRELESS	SINSTALLA	TION LTE UPGRADE	
PROJECT AD	DRESS:	284 Danfo	orth Street		CHART/BLOCK/LOT: 57-F	-1
APPLICATION	I FEE:	\$50.00	_ (\$50.00)			
PROJECT DE	SCRIPTION	ON: (Please	Attach Sketch/P	lan of the Pro	posal/Development)	
Installation o	of 3 addi	itional ante	ennas, and addi	tion of asso	ciated equipment to existir	ng facility
CONTACT INF	ORMAT	ION:				
OWNER/A				CONSULT	ANT/AGENT	
Name:		— Mobility		Name:	Peter Cooke	
Name: Address:			al Services	Address:	POB 874	
Address.	800 M	larshall Ph	elps Rd	Addicss.	Wolfeboro, NH 03894	_
Work #:		or, CT 060	 ·	Work #:	978-399-8600	
Cell #:	860-4	20-8562		Cell #:	978-399-8600	· ·
Fax #:				Fax #:	888-	<u> </u>
Home #:				Home #:		
E-mail:	Mark Rob	erts <robertsm@< td=""><td>@nexlinkgs.com></td><td>E-mail:</td><td>pcooke@wellmanassociates.</td><td>net</td></robertsm@<>	@nexlinkgs.com>	E-mail:	pcooke@wellmanassociates.	net
Criteria for an					Applicant's Assessmen Y(yes), N(no), N/A	nt Planning Division Y(yes), N(no), N/A
a) Is the prop	osal with	in existing st	tructures?		Yes	h -a roof
b) Are there	any new l	ouildings, ad	lditions, or demolit	ions?	No	N.
c) Is the foot	print incre	ase less tha	an 500 sq. ft.?		Yes	<u> </u>
d) Are there	any new o	curb cuts, dr	iveways or parking	g areas?	No	Ņ
· .			sound condition?		N/A	<u> </u>
•			nply with ADA?		N/A No	4
J ,	-	nal parking?	•		No	
h) Is there ar					No	<u>N</u>
•	-		er problems?		Yes	10
		perty screeni	ing exist?	Yes	\	
k) Are there	•		2		No	
•	-	ng violations		oigo?	N/A	NULA
•			ated to minimize n glare, fumes or oth		No F	
		····	giaro, iamos or our	Date		
Signature of	Applican 100		gent for App	1		2012

Planning Division Use Only	Authorization Granted	Partial Exemption	Exemption Denied
Standard Condition of Approve from the Inspection Division (I	Room 315, City Hall (874-8703	I)) prior to the start of an	y construction.
Planner Signature	<u> </u>		
IMPORTANT NOTICE TO APPI from site plan review does not authorization for construction (207)874-8703, to determine w	<u>exempt</u> this proposal from one of the control of t	ther required approvals the Building Inspection	or permits, nor is it an s Office, Room 315, City Hall

PROVISION OF PORTLAND CITY CODE 14-523 (SITE PLAN ORDINANCE)

RE: Administrative Authorization

Sec. 14-523 (b). Applicability

No person shall undertake any development identified in Section 14-523 without obtaining a site plan improvement permit under this article. (c) Administrative Authorization. Administrative Authorization means the Planning Authority may grant administrative authorization to exempt a development proposal from complete or partial site plan review that meets the standards below, as demonstrated by the applicant.

- 1. The proposed development will be located within existing structures, and there will be no new buildings, demolitions, or building additions other than those permitted by subsection b of this section;
- Any building addition shall have a new building footprint expansion of less than five hundred (500) square feet;
- 3. The proposed site plan does not add any new curb cuts, driveways, or parking areas; the existing site has no more than one (1) curb cut and will not disrupt the circulation flows and parking on-site; and there will be no drive-through services
- The curbs and sidewalks adjacent to the lot are complete and in sound condition, as determined by the public works authority, with granite curb with at least four (4) inch reveal, and sidewalks are in good repair with uniform material and level surface and meet accessibility requirements of the Americans with Disabilities Act;
- The use does not require additional or reduce existing parking, either on or off the site, and the project does not significantly increase traffic generation;
- There are no known stormwater impacts from the proposed use or any existing deficient conditions of stormwater management on the site;
- There are no evident deficiencies in existing screening from adjoining properties; and
- Existing utility connections are adequate to serve the proposed development and there will be no disturbance to or improvements within the public right-of-way.
- 9. There are no current zoning violations;
- 10. Any emergency generators are to be located to minimize noise impacts to adjoining properties and documentation that routine testing of the generators occur on weekdays between the hours of 9 a.m. to 5 p.m. Documentation pertaining to the noise impacts of the emergency generator shall be submitted; and
- 11. There is no anticipated noise, vibration, glare, fumes or other foreseeable impacts associated with the project.
- Filing the Application. An applicant seeking an administrative authorization under this subsection shall submit an administrative authorization application for review, detailing the site plan with dimensions of proposed improvements and distances from all property lines, and stating that the proposal meets all of the provisions in standards 1-11 of Section 14-423 (b)1. The application must be accompanied by an application fee of \$50.
- Review. Upon receipt of such a complete application, the Planning Authority will process it and render a written decision of approval, approval with conditions or denial, with all associated findings.
- Decision. If a full administrative authorization is granted, the application shall be approved without further review under this article, and no performance guarantee shall be required. In the event that the Planning Authority determines that standards a and b of Section 14-523 (b) (1) and at least four (4) of the remaining standards have been met, the Planning Authority shall review the site plan according to all applicable review standards of Section 14-526 that are affected by the standards in this subsection that have not been met. If an exemption or partial exemption from site plan review is not granted, the applicant must submit a site plan application that will undergo a full review by the Planning Board or Planning Authority according to the standards of Section 14-526.

<u>Criteria for an Adminstrative Authorizations</u>: (See Section 14-523 (4) on page 2 of this application)

Applicant's Assessment Y(yes), N(no), N/A Planning Division Use Only

a) Is the proposal within existing structures?	Yes	Yes, on the roof
b) Are there any new buildings, additions, or demolitions?	No	No
c) Is the footprint increase less than 500 sq. ft.?	Yes	Yes
d) Are there any new curb cuts, driveways or parking areas?	No	No
e) Are the curbs and sidewalks in sound condition?	n/a	Yes
f) Do the curbs and sidewalks comply with ADA?	n/a	Yes
g) Is there any additional parking?	No	No
h) Is there an increase in traffic?	No	No
i) Are there any known stormwater problems?	No	No
j) Does sufficient property screening exist?	Yes	Yes
k) Are there adequate utilities?	Yes	Yes
l) Are there any zoning violations?	No	No
m)Is an emergency generator located to minimize noise?	n/a	n/a
n) Are there any noise, vibration, glare, fumes or other impacts?	No	No

The Administrative Authorization for 284 Danforth Street was approved by Barbara Barhydt, Development Review Services Manager on March 7, 2012 with the following required Standard Condition of Approval listed below:

1. <u>Standard Condition of Approval</u>: The applicant shall obtain all required City Permits, including building permits from the Inspection Division (874-8703) and any other permits required from the Department of Public Services (874-8801) prior to the start of any construction.

Barburn Surhydt 3/7/12

PROJECT INFORMATION

43° 38° 46.14" N

SCOPE OF WORK:

UNMANNED TELECOMMUNICATIONS FACILITY MODIFICATIONS

SITE ADDRESS:

284 DANFORTH STREET PORTLAND, ME 04102

LATITUDE:

43.646151 N

LONGITUDE: JURISDICTION: 70.266560 W

70° 15' 59.62" W NATIONAL, STATE & LOCAL CODES OR ORDINANCES

CURRENT USE: PROPOSED USE: TELECOMMUNICATIONS FACILITY

TELECOMMUNICATIONS FACILITY




SITE NUMBER: ME5048 SITE NAME: PORTLAND HARBOR

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START OUT GOING SOUTHWEST ON COCHITUATE RD / RT-30 W TOWARD BURR ST.MAPHIDE MAKE A U-TURN ONTO COCHITUATE RD / RT-30. TAKE THE RAMP TOWARD I-90 / MASSPIKE / SPRINGFILED / BOSTON. MERGE ONTO I-90 E / MASSACHUSETTS TURNPIKE / MASS PIKE TOWARD I-95 / BOSTON (PORTIONS TOLL). TAKE THE I-95 N / RT-128 N / RT-30 EXIT, EXIT 14, TOWARD N.H.-MAINE / POINTS NORTH. MERGE ONTO I-95 N VIA THE EXIT ON THE LEFT TOWARD WALTHAM / PORTSMOUTH NH (PORTIONS TOLL) (PASSING THROUGH NEW HAMPSHIRE, THEN CROSSING INTO MAINE). MERGE ONTO I-295 N VIA EXIT 44 TOWARD SOUTH PORTLAND / DOWNTOWN PORTLAND (PORTIONS TOLL). TAKE EXIT 4 TOWARD PORTLAND / WATERFRONT. TURN SLIGHT LEFT ONTO VALLEY ST. TURN SLIGHT RIGHT ONTO DANFORTH ST. 284 DANFORTH ST IS ON THE RIGHT.

VICINITY MAP

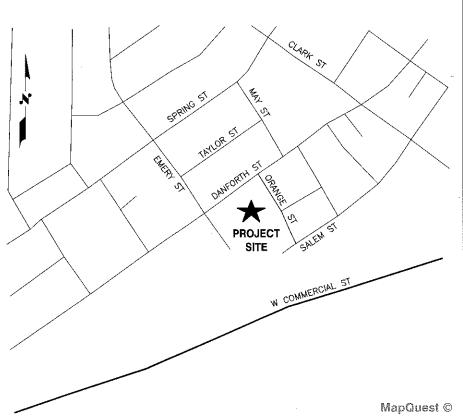

THIS DOCUMENT IS THE CREATION, DESIGN, PROPERTY AND COPYRIGHTED WORK OF AT&T. ANY DUPLICATION OR USE WITHOUT EXPRESS WRITTEN CONSENT IS STRICTLY PROHIBITED. DUPLICATION AND USE BY GOVERNMENT AGENCIES FOR THE PURPOSES OF CONDUCTING THEIR LAWFULLY AUTHORIZED REGULATORY AND ADMINISTRATIVE FUNCTIONS IS SPECIFICALLY

GENERAL NOTES

- THE FACILITY IS AN UNMANNED PRIVATE AND SECURED EQUIPMENT INSTALLATION. IT IS ONLY ACCESSED BY TRAINED TECHNICIANS FOR PERIODIC ROUTINE MAINTENANCE AND THEREFORE DOES NOT REQUIRE ANY WATER OR SANITARY SEWER SERVICE. THE FACILITY IS NOT GOVERNED BY REGULATIONS REQUIRING PUBLIC ACCESS PER ADA REQUIREMENTS.
- 3. CONTRACTOR SHALL VERIFY ALL PLANS AND EXISTING DIMENSIONS AND CONDITIONS ON THE JOB SITE AND SHALL IMMEDIATELY NOTIFY THE AT&T REPRESENTATIVE IN WRITING OF DISCREPANCIES BEFORE PROCEEDING WITH THE WORK OR BE RESPONSIBLE FOR SAME.



CALL

DIG SAFE



CALL TOLL FREE 888-DIG-SAFE

UNDERGROUNDISERVICE ALERT





SITE NUMBER: ME5048 SITE NAME: PORTLAND HARBOR

> 284 DANFORTH STREET PORTLAND, ME 04102 CUMBERLAND COUNTY



550 COCHITUATE ROAD FRAMINGHAM, MA 01701

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DATE		REVIS	SIONS		BY	COTIC!	666	1	7. V	' /	
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AT&T TITLE SHEET (LTE) THINING ENGLISH

GROUNDING NOTES

- 1. THE SUBCONTRACTOR SHALL REVIEW AND INSPECT THE EXISTING FACILITY GROUNDING SYSTEM AND LIGHTNING PROTECTION SYSTEM (AS DESIGNED AND INSTALLED) FOR STRICT COMPLIANCE WITH THE NEC (AS ADOPTED BY THE AHJ), THE SITE-SPECIFIC (UL, LPI, OR NFPA) LIGHTING PROTECTION CODE, AND GENERAL COMPLIANCE WITH TELCORDIA AND TIA GROUNDING STANDARDS. THE SUBCONTRACTOR SHALL REPORT ANY VIOLATIONS OR ADVERSE FINDINGS TO THE CONTRACTOR FOR RESOLUTION.
- 2. ALL GROUND ELECTRODE SYSTEMS (INCLUDING TELECOMMUNICATION, RADIO, LIGHTNING PROTECTION, AND AC POWER GES'S) SHALL BE BONDED TOGETHER, AT OR BELOW GRADE, BY TWO OR MORE COPPER BONDING CONDUCTORS IN ACCORDANCE WITH THE NEC.
- 3. THE SUBCONTRACTOR SHALL PERFORM IEEE FALL-OF-POTENTIAL RESISTANCE TO EARTH TESTING (PER IEEE 1100 AND 81) FOR NEW GROUND ELECTRODE SYSTEMS. THE SUBCONTRACTOR SHALL FURNISH AND INSTALL SUPPLEMENTAL GROUND ELECTRODES AS NEEDED TO ACHIEVE A TEST RESULT OF 5 OHMS OR LESS
- 4. METAL RACEWAY SHALL NOT BE USED AS THE NEC REQUIRED EQUIPMENT GROUND CONDUCTOR. STRANDED COPPER CONDUCTORS WITH GREEN INSULATION, SIZED IN ACCORDANCE WITH THE NEC. SHALL BE FURNISHED AND INSTALLED WITH THE POWER CIRCUITS TO BTS EQUIPMENT.
- 5. EACH BTS CABINET FRAME SHALL BE DIRECTLY CONNECTED TO THE MASTER GROUND BAR WITH GREEN INSULATED SUPPLEMENTAL EQUIPMENT GROUND WIRES. 6 AWG STRANDED COPPER OR LARGER FOR INDOOR BTS 2 AWG STRANDED COPPER FOR OUTDOOR BTS
- 6. EXOTHERMIC WELDS SHALL BE USED FOR ALL GROUNDING CONNECTIONS BELOW GRADE.
- 7. APPROVED ANTIOXIDANT COATINGS (I.E., CONDUCTIVE GEL OR PASTE) SHALL BE USED ON ALL COMPRESSION AND BOLTED GROUND CONNECTIONS:
- 8. ICE BRIDGE BONDING CONDUCTORS SHALL BE EXOTHERMICALLY BONDED OR BOLTED TO THE BRIDGE AND THE TOWER GROUND BAR
- 9. ALUMINUM CONDUCTOR OR COPPER CLAD STEEL CONDUCTOR SHALL NOT BE USED FOR GROUNDING CONNECTIONS.
- 10. MISCELLANEOUS ELECTRICAL AND NON-ELECTRICAL METAL BOXES, FRAMES AND SUPPORTS SHALL BE BONDED TO THE GROUND RING, IN ACCORDANCE WITH THE NEC.
- 11. METAL CONDUIT SHALL BE MADE ELECTRICALLY CONTINUOUS WITH LISTED BONDING FITTINGS OR BY BONDING ACROSS THE DISCONTINUITY WITH 6 AWS COPPER WIRE UL APPROVED GROUNDING TYPE CONDUIT CLAMPS
- 12. ALL NEW STRUCTURES WITH A FOUNDATION AND/OR FOOTING HAVING 20 FT. OR MORE 1/2" OR GREATER ELECTRICALLY CONDUCTIVE REINFORCING STEEL MUST HAVE IT BONDED TO THE GROUND RING USING AN EXOTHERMIC WELD CONNECTION USING #2 AWG SOLID TINNED COPPER GROUND WIRE, PER NEC 250.50

GENERAL NOTES

FOR THE PURPOSE OF CONSTRUCTION DRAWING, THE FOLLOWING DEFINITIONS SHALL APPLY:

CONTRACTOR - NEXLINK SUBCONTRACTOR - GENERAL CONTRACTOR (CONSTRUCTION) OWNER - AT&T MORILITY

- 2. PRIOR TO THE SUBMISSION OF BIDS, THE BIDDING SUBCONTRACTOR SHALL VISIT THE CELL SITE TO FAMILIARIZE WITH THE EXISTING CONDITIONS AND TO CONFIRM THAT THE WORK CAN BE ACCOMPLISHED AS SHOWN ON THE CONSTRUCTION DRAWINGS. ANY DISCREPANCY FOUND SHALL BE BROUGHT TO THE ATTENTION OF CONTRACTOR.
- 3. ALL MATERIALS FURNISHED AND INSTALLED SHALL BE IN STRICT ACCORDANCE WITH ALL APPLICABLE CODES, REGULATIONS, AND ORDINANCES. SUBCONTRACTOR SHALL ISSUE ALL APPROPRIATE NOTICES AND COMPLY WITH ALL LAWS, ORDINANCES, RULES, REGULATIONS, AND LAWFUL ORDERS OF ANY PUBLIC AUTHORITY REGARDING THE PERFORMANCE OF THE WORK, ALL WORK CARRIED OUT SHALL COMPLY WITH ALL APPLICABLE MUNICIPAL AND UTILITY COMPANY SPECIFICATIONS AND LOCAL JURISDICTIONAL CODES, ORDINANCES AND APPLICABLE REGULATIONS.
- DRAWINGS PROVIDED HERE ARE NOT TO BE SCALED AND ARE INTENDED TO SHOW OUTLINE ONLY.
- 5. UNLESS NOTED OTHERWISE, THE WORK SHALL INCLUDE FURNISHING MATERIALS, EQUIPMENT, APPURTENANCES, AND LABOR NECESSARY TO COMPLETE ALL INSTALLATIONS AS INDICATED ON THE DRAWINGS
- "KITTING LIST" SUPPLIED WITH THE BID PACKAGE IDENTIFIES ITEMS THAT WILL BE SUPPLIED BY CONTRACTOR ITEMS NOT INCLUDED IN THE BILL OF MATERIALS AND KITTING LIST SHALL BE SUPPLIED BY THE SUBCONTRACTOR
- THE SUBCONTRACTOR SHALL INSTALL ALL EQUIPMENT AND MATERIALS IN ACCORDANCE WITH MANUFACTURER'S RECOMMENDATIONS UNLESS SPECIFICALLY STATED OTHERWISE
- IF THE SPECIFIED EQUIPMENT CANNOT BE INSTALLED AS SHOWN ON THESE DRAWINGS, THE SUBCONTRACTOR SHALL PROPOSE AN ALTERNATIVE INSTALLATION SPACE FOR APPROVAL BY THE CONTRACTOR.
- SUBCONTRACTOR SHALL DETERMINE ACTUAL ROUTING OF CONDUIT, POWER AND T1 CABLES, GROUNDING CABLES AS SHOWN ON THE POWER, GROUNDING AND TELCO PLAN DRAWING. SUBCONTRACTOR SHALL UTILIZE EXISTING TRAYS AND/OR SHALL ADD NEW TRAYS AS NECESSARY, SUBCONTRACTOR SHALL CONFIRM THE ACTUAL ROUTING WITH THE CONTRACTOR
- 10. THE SUBCONTRACTOR SHALL PROTECT EXISTING IMPROVEMENTS, PAVEMENTS, CURBS, LANDSCAPING AND STRUCTURES. ANY DAMAGED PART SHALL BE REPAIRED AT SUBCONTRACTOR'S EXPENSE TO THE SATISFACTION OF
- SUBCONTRACTOR SHALL LEGALLY AND PROPERLY DISPOSE OF ALL SCRAP MATERIALS SUCH AS COAXIAL CABLES AND OTHER ITEMS REMOVED FROM THE EXISTING FACILITY. ANTENNAS REMOVED SHALL BE RETURNED TO THE OWNER'S DESIGNATED LOCATION
- 12. SUBCONTRACTOR SHALL LEAVE PREMISES IN CLEAN CONDITION.
- 13. ALL CONCRETE REPAIR WORK SHALL BE DONE IN ACCORDANCE WITH AMERICAN CONCRETE INSTITUTE (ACI) 301.
- 14. ANY NEW CONCRETE NEEDED FOR THE CONSTRUCTION SHALL BE AIR-ENTRAINED AND SHALL HAVE 4000 PSI STRENGTH AT 28 DAYS. ALL CONCRETE WORK SHALL BE DONE IN ACCORDANCE WITH ACI 318 CODE REQUIREMENTS.

15. ALL STRUCTURAL STEEL WORK SHALL BE DETAILED, FABRICATED AND ERECTED IN ACCORDANCE WITH AISC SPECIFICATIONS, ALL STRUCTURAL STEEL SHALL BE ASTM A36 (Fy = 36 ksi) UNLESS OTHERWISE NOTED. PIPES SHALL BE ASTM A53 TYPE E (Fy = 36 ksi). ALL STEEL EXPOSED TO WEATHER SHALL BE HOT DIPPED GALVANIZED. TOUCHUP ALL SCRATCHES AND OTHER MARKS IN THE FIELD AFTER STEEL IS ERECTED USING A COMPATIBLE ZINC RICH PAINT.

- 16. CONSTRUCTION SHALL COMPLY WITH UMTS SPECIFICATIONS AND "GENERAL CONSTRUCTION SERVICES FOR CONSTRUCTION OF AT&T MOBILITY
- 17. SUBCONTRACTOR SHALL VERIFY ALL EXISTING DIMENSIONS AND CONDITIONS PRIOR TO COMMENCING ANY WORK. ALL DIMENSIONS OF EXISTING CONSTRUCTION SHOWN ON THE DRAWINGS MUST BE VERIFIED. SUBCONTRACTOR SHALL NOTIFY THE CONTRACTOR OF ANY DISCREPANCIES PRIOR TO ORDERING MATERIAL OR PROCEEDING WITH CONSTRUCTION.
- 18. THE EXISTING CELL SITE IS IN FULL COMMERCIAL OPERATION. ANY CONSTRUCTION WORK BY SUBCONTRACTOR SHALL NOT DISRUPT THE EXISTING NORMAL OPERATION. ANY WORK ON EXISTING EQUIPMENT MUST BE COORDINATED WITH CONTRACTOR. ALSO, WORK SHOULD BE SCHEDULED FOR AN APPROPRIATE MAINTENANCE WINDOW USUALLY IN LOW TRAFFIC PERIODS
- 19. SINCE THE CELL SITE IS ACTIVE, ALL SAFETY PRECAUTIONS MUST BE TAKEN WHEN WORKING AROUND HIGH LEVELS OF ELECTROMAGNETIC RADIATION. EQUIPMENT SHOULD BE SHUTDOWN PRIOR TO PERFORMING ANY WORK THAT COULD EXPOSE THE WORKERS TO DANGER. PERSONAL REEXPOSURE MONITORS ARE ADVISED TO BE WORN TO ALERT OF ANY DANGEROUS EXPOSURE LEVELS.
- 20. APPLICABLE BUILDING CODES: SUBCONTRACTOR'S WORK SHALL COMPLY WITH ALL APPLICABLE NATIONAL STATE, AND LOCAL CODES AS ADOPTED BY THE LOCAL AUTHORITY HAVING JURISDICTION (AHJ) FOR THE LOCATION. THE EDITION OF THE AHJ ADOPTED CODES AND STANDARDS IN EFFECT ON THE DATE OF CONTRACT AWARD SHALL GOVERN THE DESIGN. BUILDING CODE: IBC 2009

ELECTRICAL CODE: REFER TO ELECTRICAL DRAWINGS LIGHTENING CODE: REFER TO ELECTRICAL DRAWINGS

SUBCONTRACTOR'S WORK SHALL COMPLY WITH THE LATEST EDITION OF THE FOLLOWING STANDARDS

> AMERICAN CONCRETE INSTITUTE (ACI) 318; BUILDING CODE REQUIREMENTS FOR STRUCTURAL CONCRETE:

AMERICAN INSTITUTE OF STEEL CONSTRUCTION (AISC)

MANUAL OF STEEL CONSTRUCTION, ASD, NINTH EDITION;

TELECOMMUNICATIONS INDUSTRY ASSOCIATION (TIA) 222-G, STRUCTURAL STANDARDS FOR STEEL

ANTENNA TOWER AND ANTENNA SUPPORTING STRUCTURES; REFER TO ELECTRICAL DRAWINGS FOR SPECIFIC ELECTRICAL STANDARDS

FOR ANY CONFLICTS BETWEEN SECTIONS OF LISTED CODES AND STANDARDS REGARDING MATERIAL, METHODS OF CONSTRUCTION, OR OTHER REQUIREMENTS, THE MOST RESTRICTIVE REQUIREMENT SHALL GOVERN WHERE THERE IS CONFLICT BETWEEN A GENERAL REQUIREMENT AND A SPECIFIC REQUIREMENT, THE SPECIFIC REQUIREMENT SHALL GOVERN.

1 02/23/12 ISSUED FOR PERMITTING

0 02/08/12 ISSUED FOR REVIEW

NO. DATE

SCALE: AS SHOWN

ABBREVIATIONS ABOVE GRADE LEVEL G.C. GENERAL CONTRACTOR RF RADIO FREQUENCY AWG MGB AMERICAN WIRE GAUGE MASTER GROUND BUS BCW BARE COPPER WIRE MIN MINIMUM TO BE DETERMINED BTS BASE TRANSCEIVER STATION PROPOSED NEW TBR TO BE REMOVED EXISTING EXISTING TO BE REMOVED N.T.S. NOT TO SCALE TBRR AND REPLACED

EQUIPMENT GROUND RINGHILL REPORT EGR

REVISIONS

DESIGNED BY: RP

BY COME AND

DRAWN BY: RP

AT&T

TYP

TYPICAL

GENERAL NOTES

(LTE) DRAWING NUMBER 5048:01 GN-1 THE STONAL ENGLISH



a UniTek GLOBAL SERVICES company

WINDSOR, CT 06095


800 MARSHALL PHELPS ROAD UNIT#: 2A


SITE NAME: PORTLAND HARBOR 284 DANFORTH STREET PORTLAND, ME 04102 CUMBERLAND COUNTY


SITE NUMBER: ME5048



550 COCHITUATE ROAD FRAMINGHAM, MA 01701

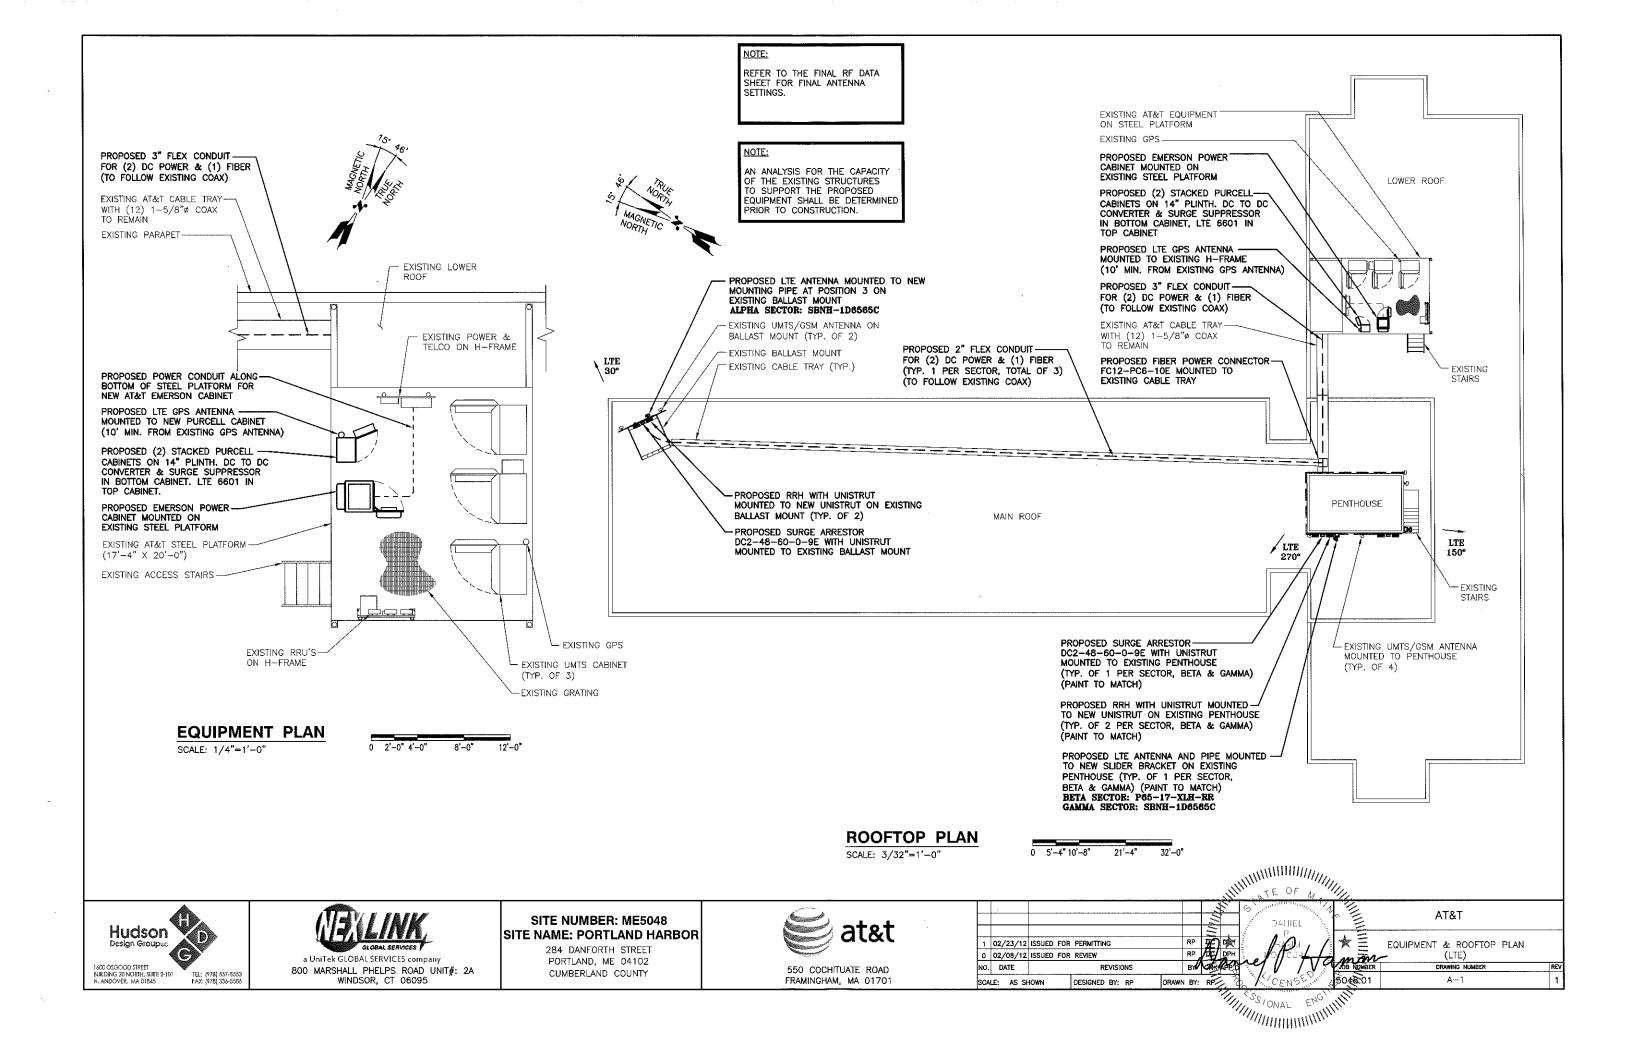


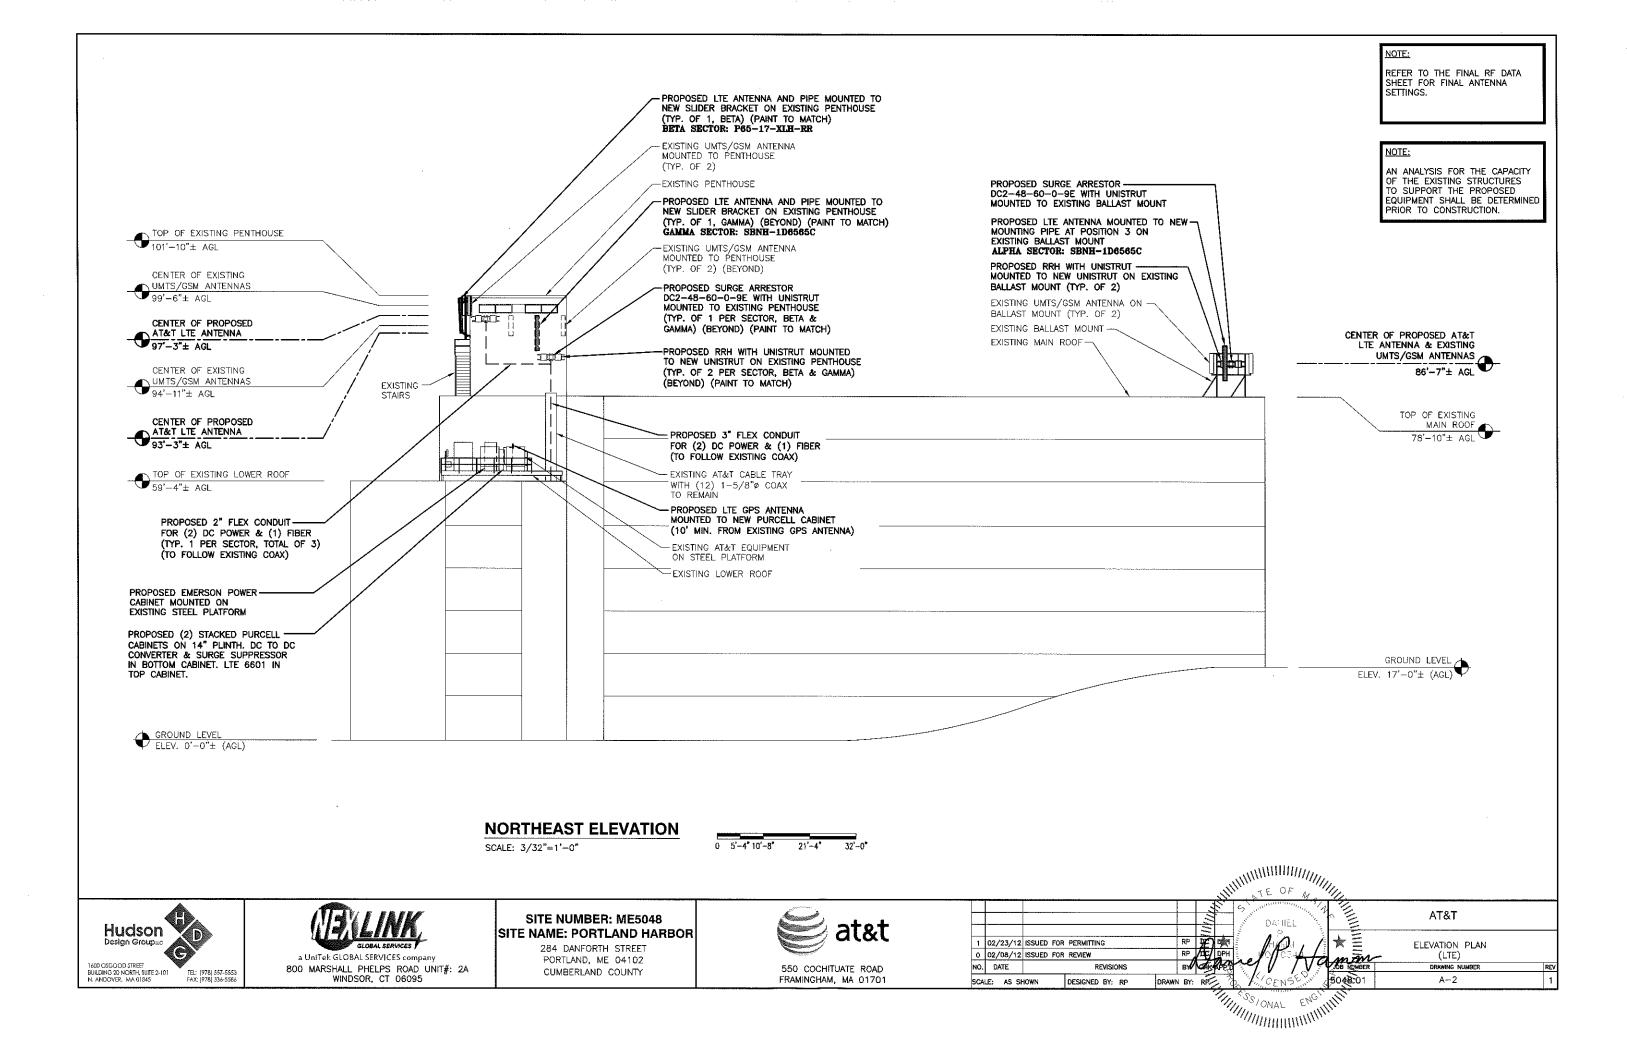

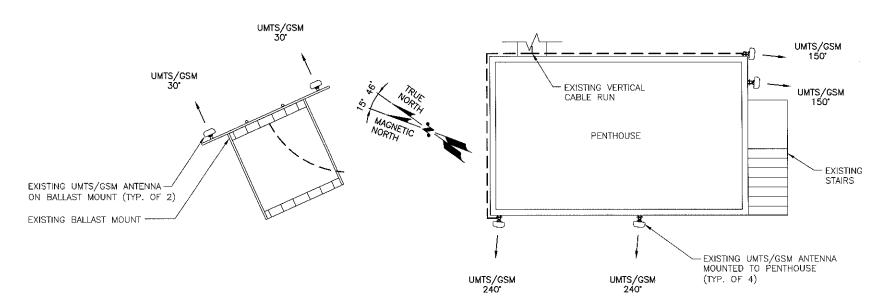

EXISTING UMTS/GSM ANTENNA PLAN

SCALE: N.T.S.

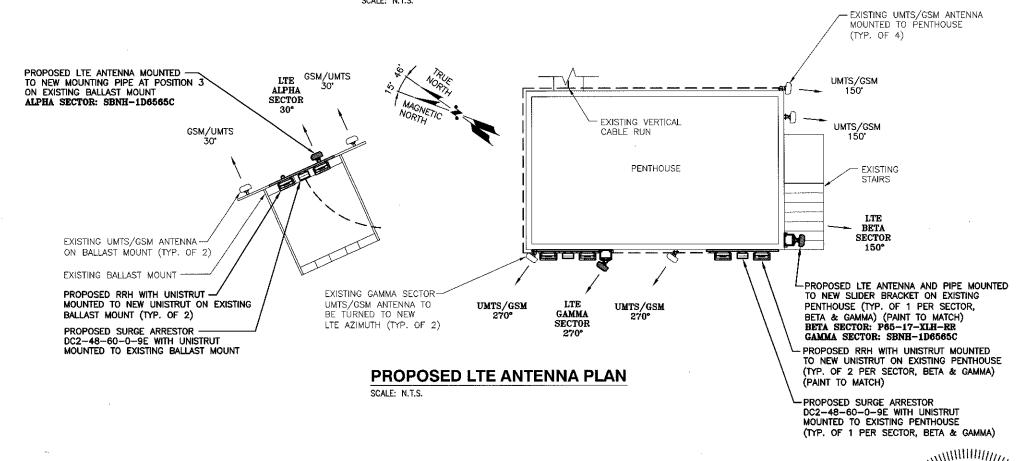





SITE NUMBER: ME5048 SITE NAME: PORTLAND HARBOR

284 DANFORTH STREET PORTLAND, ME 04102 CUMBERLAND COUNTY



550 COCHITUATE ROAD FRAMINGHAM, MA 01701

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NOTE:

REFER TO THE FINAL RF DATA SHEET FOR FINAL ANTENNA SETTINGS.

NOTE:


AN ANALYSIS FOR THE CAPACITY OF THE EXISTING STRUCTURES TO SUPPORT THE PROPOSED EQUIPMENT SHALL BE DETERMINED PRIOR TO CONSTRUCTION.

NOTE:

REFER TO THE FINAL RF DATA SHEET FOR FINAL ANTENNA SETTINGS.

NOTE


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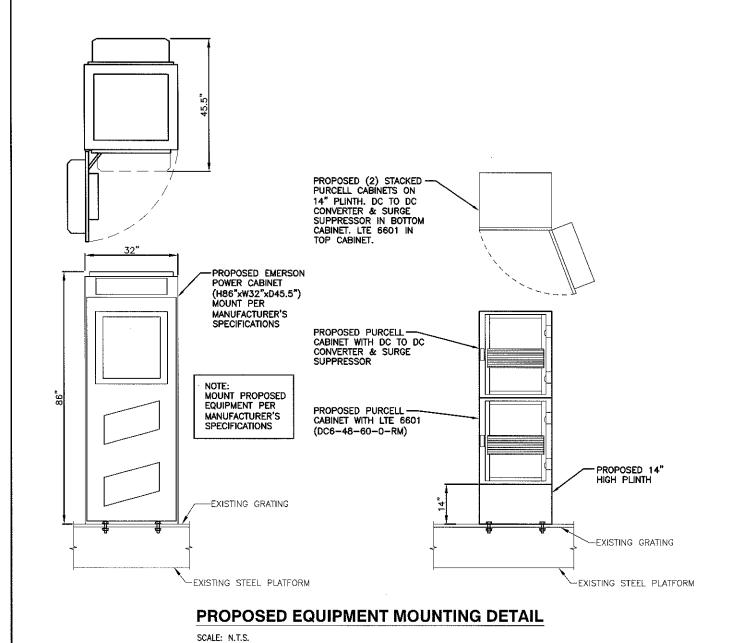


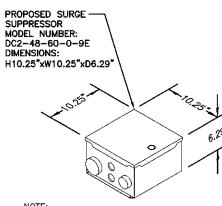MOUNT PER MANUFACTURE'S SPECIFICATIONS.

DC SURGE SUPPRESSOR DETAIL

SCALE: N.T.S.



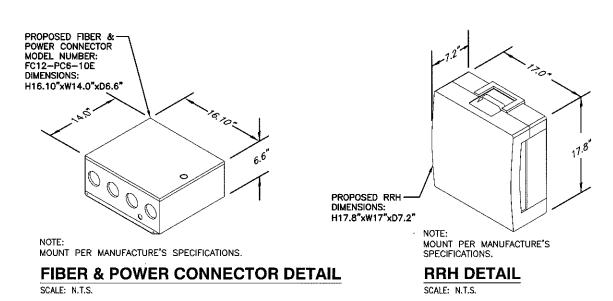

GLOBAL SERVICES

a UniTek GLOBAL SERVICES company

Hudson `

1600 OSGOOD STREET BUILDING 20 NORTH, SUITE 2-101 N. ANDOVER, MA 01845 a UniTek GLOBAL SERVICES Company
800 MARSHALL PHELPS ROAD UNIT#: 2A
WINDSOR, CT 06095


SITE NUMBER: ME5048 SITE NAME: PORTLAND HARBOR

284 DANFORTH STREET PORTLAND, ME 04102 CUMBERLAND COUNTY



550 COCHITUATE ROAD FRAMINGHAM, MA 01701

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1	02/23/12		R PERMITTING		RP RP		DPH	AP L	* =	DETAILS (LTE)	
NO			REVISIONS		BY	OF K	AF.	ref / TVG	JOB KOMBER	DRAWING NUMBER	REV
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							111	STONAL ENGLIN	IIII		

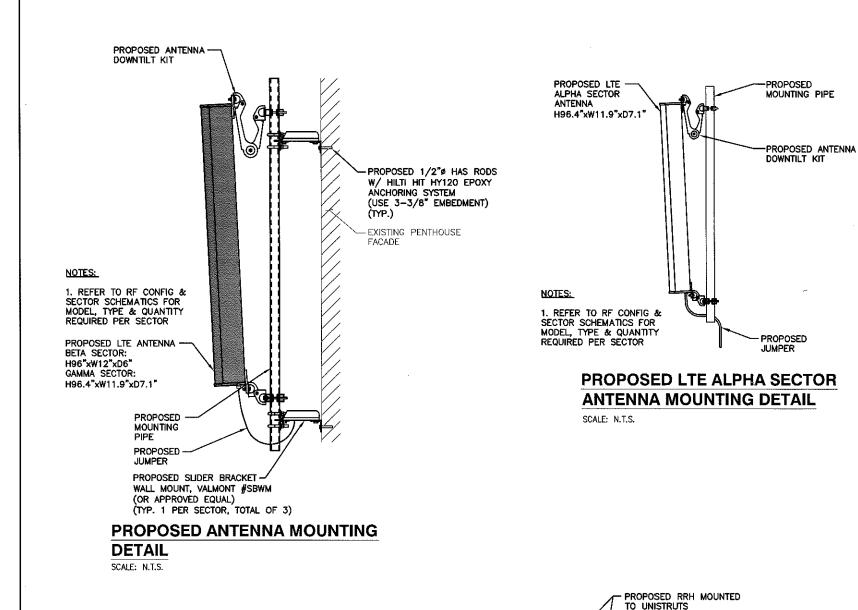

PROPOSED 2" FLEX CONDUIT FOR DC POWER & FIBER IN NEW SNAP-IN HANGERS & GROMMET ADAPTERS EXISTING COAX EXISTING UNISTRUT-

CABLE MOUNTING DETAIL


SCALE: N.T.S.

NOTE:


REFER TO THE FINAL RF DATA SHEET FOR FINAL ANTENNA

NOTE:

AN ANALYSIS FOR THE CAPACITY OF THE EXISTING STRUCTURES TO SUPPORT THE PROPOSED EQUIPMENT SHALL BE DETERMINED PRIOR TO CONSTRUCTION.

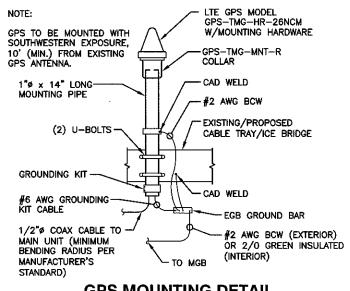



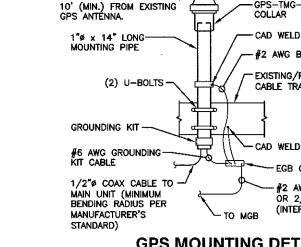

GPS MOUNTING DETAIL

TE OF .

Hudson 1400 OSGOOD STREET BUILDING 20 NORTH, SUITE 2-101 N. ANDOVER, MA 01845



SCALE: N.T.S.

PROPOSED SURGE ARRESTOR DC6-48-60-18-8F

MOUNTED TO UNISTRUTS

SITE NUMBER: ME5048 SITE NAME: PORTLAND HARBOR

PROPOSED P1000

(AS NECESSARY)

UNISTRUT

PROPOSED LTE (ALPHA & GAMMA SECTORS)

RRH AND SURGE ARRESTOR MOUNT DETAIL

284 DANFORTH STREET PORTLAND, ME 04102 CUMBERLAND COUNTY



(TYP. OF 2 PER SECTOR, TOTAL OF 6)

PROPOSED 1/2"ø HAS RODS W/ HILTI HIT HY120 **EPOXY ANCHORING**

EXISTING


WALL

PENTHOUSE

SYSTEM (USE 3-3/8" EMBEDMENT) (TYP.)


550 COCHITUATE ROAD FRAMINGHAM, MA 01701

								11/1	```	ATE OF M	1		
							11111	1/1/	-	Samuel DALIEL			AT&T
H	-		ISSUED FOR	PERMITTING REVIEW REVISIONS		RP RP BY	A	DPH	111111111111111111111111111111111111111	ellita		ZWV COMBER	DETAILS (LTE) DRAWING NUMBER RE
_	SCAL	E: AS SH	IOWN	DESIGNED BY: RP	DRAWN	BY:		-	<u></u>	- 14 - 11 - 12 - 12 - 12 - 12 - 12 - 12	04	<u>₹</u> 201	A-5
								11/	11/	NINIMINIMINIMINIMINIMINIMINIMINIMINIMIN	1/2		

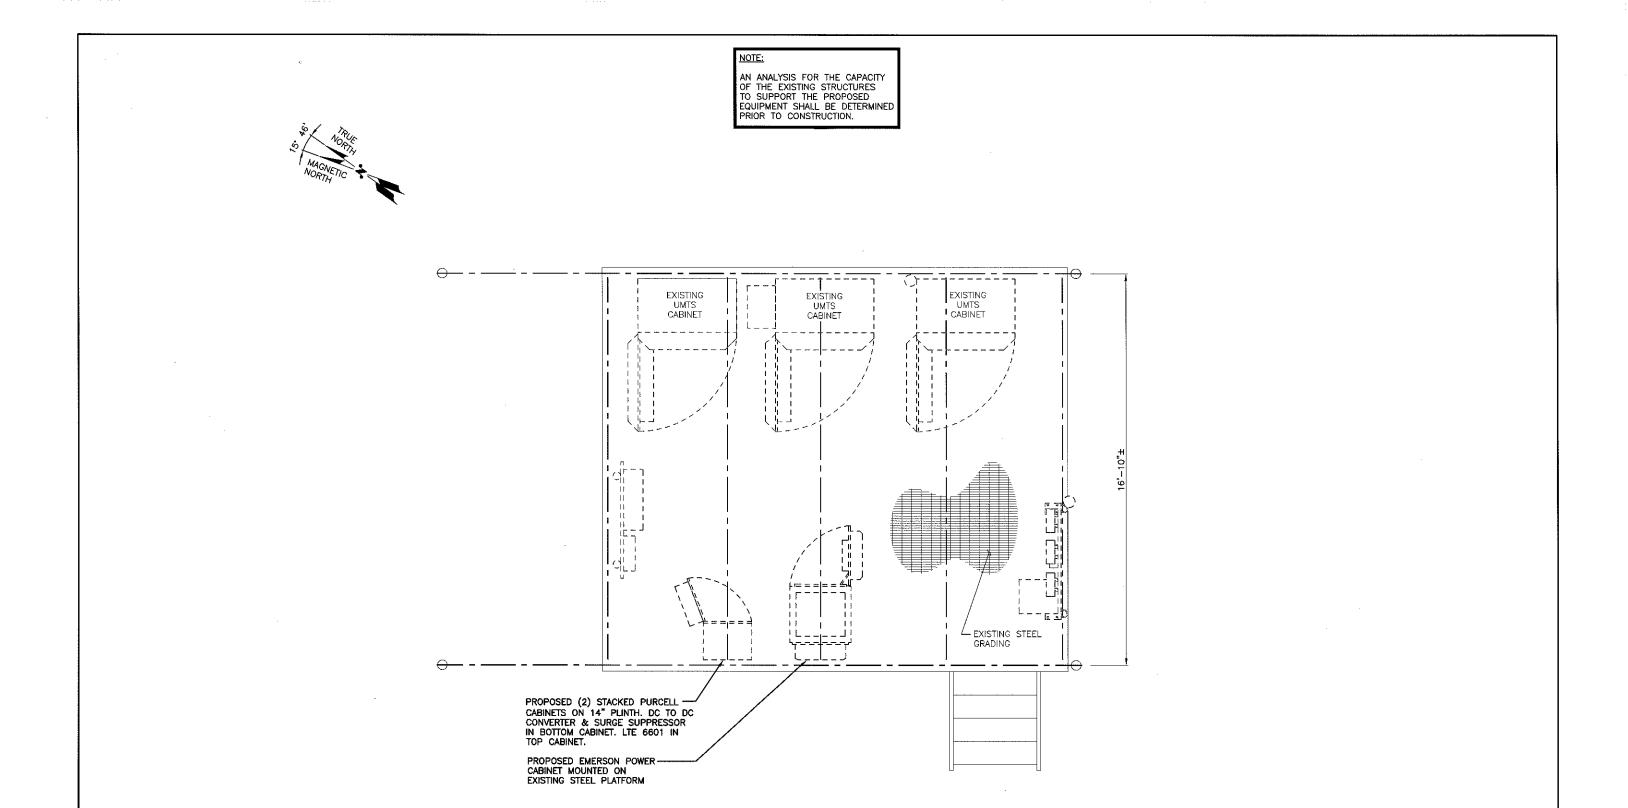

EXISTING PLATFORM FRAMING PLAN

SCALE: 1/2"=1'-0"

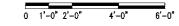





SITE NUMBER: ME5048 SITE NAME: PORTLAND HARBOR

284 DANFORTH STREET PORTLAND, ME 04102 CUMBERLAND COUNTY



550	COCHITU	JATE	ROAD
FRAM	INGHAM,	MA	01701

4'-0" 6'-0"				ili.	MINIMUM ATE OF MA	14/12		
				11/11/1/	DANIEL DANIEL		AT&T	
1 02/23/12 ISSUED FO 0 02/08/12 ISSUED FO			RP RP	DPH	IP 1	M AND MORES	PLATFORM PLAN (LTE)	
NO. DATE	REVISIONS	1	BY	OF KHE	reg / / V	JOB NUMBER	DRAWING NUMBER	ŘEV
SCALE: AS SHOWN	DESIGNED BY: RP	DRAWN	BY:		CENSE LINE	50€€701	S-1	1
				1//	WINNIN ENGLISH	IIIII		

