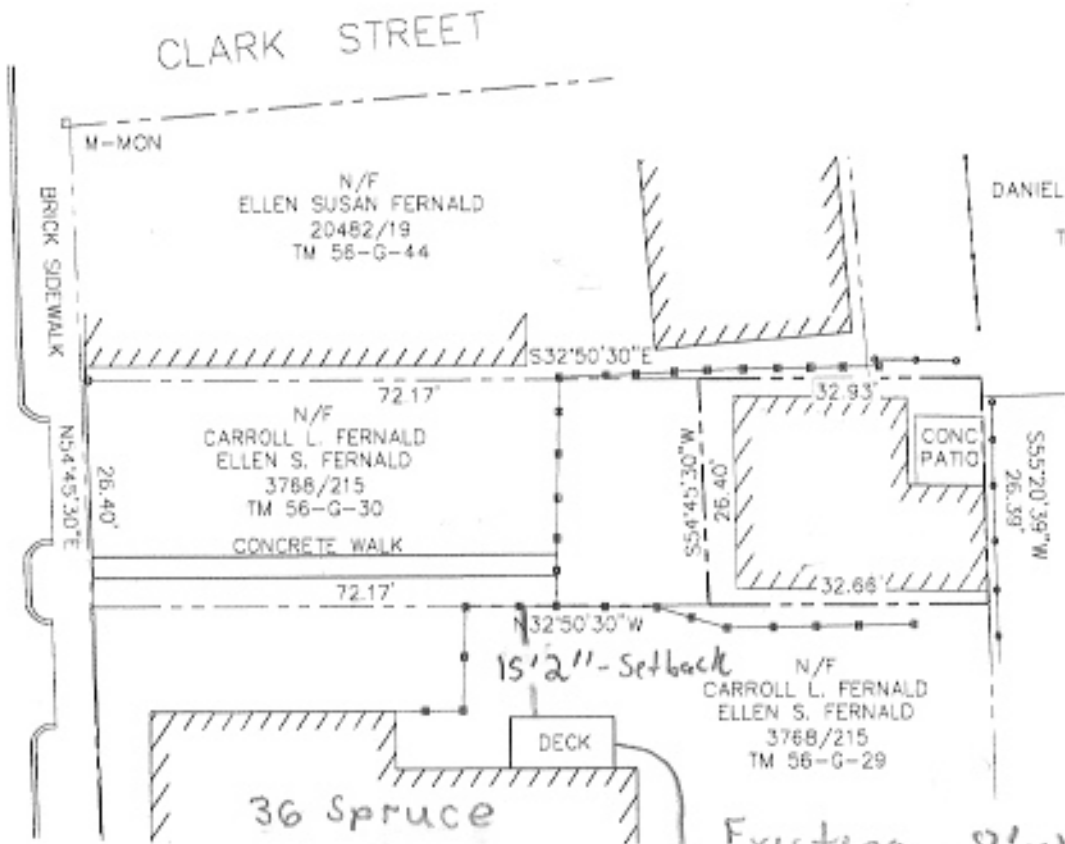




Reviewed for Code Compliance  
 Permitting and Inspections Department  
 Approved with Conditions  
 02/19/2019



CLARK STREET



**BOUNDARY PLAN**  
 SPRUCE STREET  
 PORTLAND, MAINE

**PLAN REFERENCE:**

1. PLAN OF PROPERTY IN PORTLAND, MAINE MADE FOR PORTLAND REMEDIAL AUTHORITY NDP PROJECT ME A-2 DISPOSITION PARCEL TO DATED JUNE 20, 1974 BY RE AND EC JORDAN

**NOTES:**

1. THE OWNERS OF RECORD ARE CARROLL L. FERNALD AND ELLEN S. FERNALD AS DESCRIBED IN A DEED RECORDED IN BOOK 161ST PAGE 177 IN THE CUMBERLAND COUNTY REGISTER OF DEEDS.
2. THE PARCEL IS SHOWN AS LOT 46 BLOCK G ON THE CITY OF PORTLAND'S ASSESSOR'S MAP 56.
3. BEARINGS ARE BASED ON PLAN REFERENCE 1.
4. SEE SURVEY BY EC JORDAN DATED APRIL 16, 1938 FOR MICHAEL T. CONNELLY.

**CERTIFICATION:**

I CERTIFY THAT THIS SURVEY WAS MADE IN ACCORDANCE WITH THE STANDARDS OF THE MAINE BOARD OF LICENSURE FOR PROFESSIONAL LAND SURVEYORS AND IS CORRECT TO THE BEST OF MY KNOWLEDGE, INFORMATION AND BELIEF.

WILLIAM C. SHAW, P.L.S. 2118

**PRELIMINARY**

FOR:

**TIM GEHARDT**  
 30 DOW STREET  
 PORTLAND, MAINE 04104  
 (CLIENT/OWNER)

SURVEY BY:

**SURVEY, INC.**  
 P.O. BOX 210  
 WINDHAM, ME 04062  
 (207) 892-2156  
 INFO@SURVEYINCORPORATED.COM

DWG: 603

C-K: 890

DATE: APRIL 20, 2018

JOB NO. 18038





# 36 Spruce St. Portland, Maine



LOCATION PLAN

## PROJECT DIRECTORY

### OWNER:

GEBHARDT

### DESIGN PROFESSIONAL:

MACLEOD STRUCTURAL ENGINEERS, PA  
90 BRIDGE STREET  
WESTBROOK, MAINE 04092  
TEL. 207-839-0980

### GENERAL CONTRACTOR:

TBD

### PROJECT DESCRIPTION:

- THIS PROJECT CONSISTS OF -
1. UPDATING/RENOVATING INTERIOR SPACES
  2. INSTALLING NEW ROOFING, SIDING
  3. THE FOOTPRINT AND VOLUME OF THE BUILDING IS UNCHANGED
  4. EXISTING COMPONENTS TO REMAIN EXCEPT AS NOTED HEREIN
  5. EXISTING STRUCTURAL ELEMENTS TO REMAIN EXCEPT AS NOTED HEREIN
  6. ALL NEW ELECTRICAL, PLUMBING & HEATING SYSTEMS THROUGHOUT

### Two Family Residence Code Review 36 Spruce Street Portland, Maine

#### CODE REVIEW: IRC2015 GH3

SECT 301 DESIGN CRITERIA  
Design Wind speed = 120mph, therefore design per IRC  
Design Snow, Pg= 60psf, therefore design per IRC  
Design Floor Live Load = 40 psf

#### SECT 302 FIRE RESISTANT CONSTRUCTION R302.1 Exterior Walls shall comply with Table R302.1 Not within 5ft. of property line.

R302.7 Under stair protection is required for accessible spaces below stairs  
R302.9 Wall and ceiling finishes shall meet flame spread <200 and smoke index <450.  
R302.10 Insulation materials including vapor barriers shall meet flame spread <25 and smoke index <450 except as otherwise provided in this section  
R302.11 Fireblocking is required at floors and ceilings, top and bottom of stair runs, and openings at vents, pipes, ducts, cables and wires with materials approved in this code  
R302.12 Draftstopping at floor/ceilings is not required for this project  
R302.13 Underside of Floors Shall be Protected Unless Joists are min. 2x10 per this section  
R303 LIGHT VENTILATION AND HEATING  
R303.1 Habitable rooms shall have glazing >8 % of floor area, with 4% operable  
R303.3 Bathrooms, min. glazing area of 3 sq. ft. with half operable  
R303.7 Stairways shall have artificial illumination per this section  
R303.8 Exterior Stairways shall have artificial illumination per this section  
R303.10 Heating shall be provided per the requirements of this code

R304 MINIMUM ROOM AREA requirements have been met in these plans  
R305 CEILING HEIGHT min. of 7ft has been met  
R306 SANITATION requirements have been met  
R307 TOILET, BATH AND SHOWER SPACES comply with this section  
R308 GLAZING shall comply with the requirements of this section  
R310 EMERGENCY ESCAPE is required from the basement and sleeping rooms - Complies.  
R311 MEANS OF EGRESS each unit in these plans has one egress in compliance with this section  
R311.6 Hallways are > 36 in. wide  
R311.7 Stairways, handrails, rise and run, nosings, headroom, etc are in compliance with this code refer to stairway sections and details within (these are existing)

R313 AUTOMATIC SPRINKLER SYSTEMS R313.2, new two family dwellings shall have an automatic sprinkler system complying with NFPA13D. NOTE: CITY OF PORTLAND CODE CH10 - SPRINKLER NOT REQUIRED FOR EXISTING ONE AND TWO FAMILY BUILDINGS

R314 SMOKE ALARMS shall be provided in each sleeping room, outside each separate sleeping area in the immediate vicinity, and on each additional level including attic and basement, and shall be interconnect per this code  
R315 CARBON MONOXIDE ALARMS shall be provided in the immediate vicinity outside sleeping areas

#### CHAPTER 6 WALL CONSTRUCTION 602.10.1 Braced Wall Panels Mixed wall types are used First Floor Walls are Existing

### GENERAL NOTES:

1. THIS PLAN IS DESIGNED TO COMPLY WITH MAINE BUILDING AND ENERGY CODE, 2015 IRC, AND 2015 IECC
2. ALL OTHER CODES SHALL BE THE RESPONSIBILITY OF THE OWNER/CONTRACTOR
3. ALL MECHANICAL/PLUMBING/ELECTRICAL DESIGN BY OTHERS
4. CONTRACTOR SHALL VERIFY ALL DIMENSIONS PRIOR TO BEGINNING WORK

### ENERGY CODE STANDARDS: ZONE 6

1. FENESTRATIONS -Windows u-0.35, shg-0.38  
-Doors u-0.25
2. ROOF -R49 (R30 at Sloping Ceiling Areas)
3. EXTERIOR WALLS -Fill Voids at Existing
4. BASEMENT CONC. WALLS (Exist to Remain)

### ENERGY CODE NOTES:

1. ALL JOINTS AND PENETRATIONS SHALL BE CAULKED, GASKETED, OR COVERED WITH MOISTURE VAPOR-PERMEABLE WRAPPING MATERIAL
2. COMPONENT R-VALUES & U-FACTORS SHALL BE LABELED AS CERTIFIED.
3. INSULATION SHALL BE INSTALLED ACCORDING TO MFRS. INSTRUCTIONS, AND IN A MANNER THAT ACHIEVES THE REQ'D R-VALUE
4. STAIR, ELEVATOR SHAFT VENTS, AND OTHER OUTDOOR INTAKE AND EXHAUST OPENINGS SHALL BE EQUIPPED WITH MOTORIZED DAMPERS.
5. RECESSED LIGHTING FIXTURES INSTALLED IN THE BUILDING ENVELOPE SHALL BE TRYPE IC RATED AS MEETING ASTM E263, AND SEALED OR CAULKED.

### CODE REVIEW NFPA 101

Chapter 24 One and Two Family Dwellings  
24.2 Means of Egress - One primary means of egress and one secondary means of escape is required from every sleeping room and every living area. This design meets this requirement  
24.2.5 Stairs - min. width =36in  
24.2.6 Hallways - min. width 36in  
24.2.7 Bulkheads - shall provide direct access to the basement, are exempt from requirements of 24.2.5.1  
24.3.4.1 Smoke alarms shall be provided in each sleeping room, outside each separate sleeping area in the immediate vicinity, and on each additional level including attic and basement, and shall be interconnect per this code  
24.3.5.2 Sprinkler system is required per NFPA 13D, CITY OF PORTLAND CODE CH10 - SPRINKLER NOT REQUIRED FOR EXISTING ONE AND TWO FAMILY BUILDINGS

### RESIDENTIAL SPECIFICATIONS:

#### FLOOR SYSTEM: EXISTING

EXTERIOR WALLS:  
2x Studs as Indicated (16"oc) Exist.  
Sheathing - Exist.  
Air Infiltration Wrap  
Siding/Finish as Indicated

INTERIOR WALLS:  
2x4 Studs @ 16"oc (exist. to remain)  
1/2" Gypboard as Indicated

ROOF SYSTEM:  
Rafters-Exist. to remain  
Sheathing - Existing  
15# Underlayment  
Ice & Water Shield at Eaves/Valleys  
235# Asphalt Shingles as Indicated

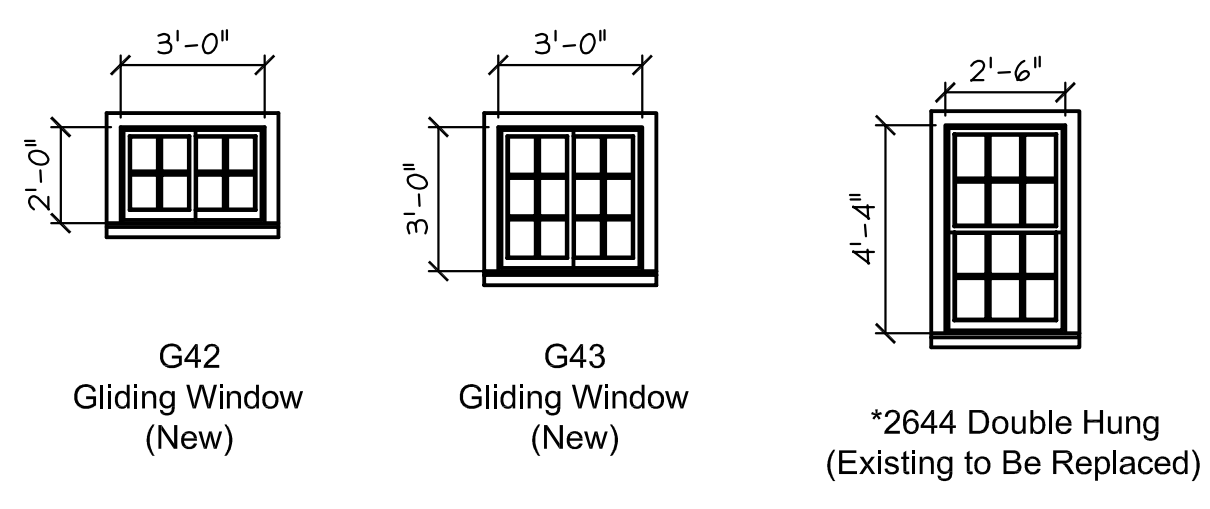
INSULATION:  
See Energy Code Notes Herein

VENTILATION:  
Soffit - 2"Contin. Strip  
Ridges - Contin. Shingle  
Circulation Vents Between Rafters/Trusses

BEAMS/HEADERS:  
(3)2x6 Max. 40' Span  
(3)2x10s Max 76' Span  
Min. 4" Bearing all Beams


INTERIOR FINISHES:  
1/2" Gypboard or As Indicated  
At Walls/Ceilings  
Flooring As Indicated  
Paint/Stain As Indicated

Note: Items not Indicated Shall be Per Contract




Note: Existing 1st & 2nd & 3rd Floor Windows, To Be Replaced With Similar.  
Size shown for Reference only.

### WINDOW SCHEDULE

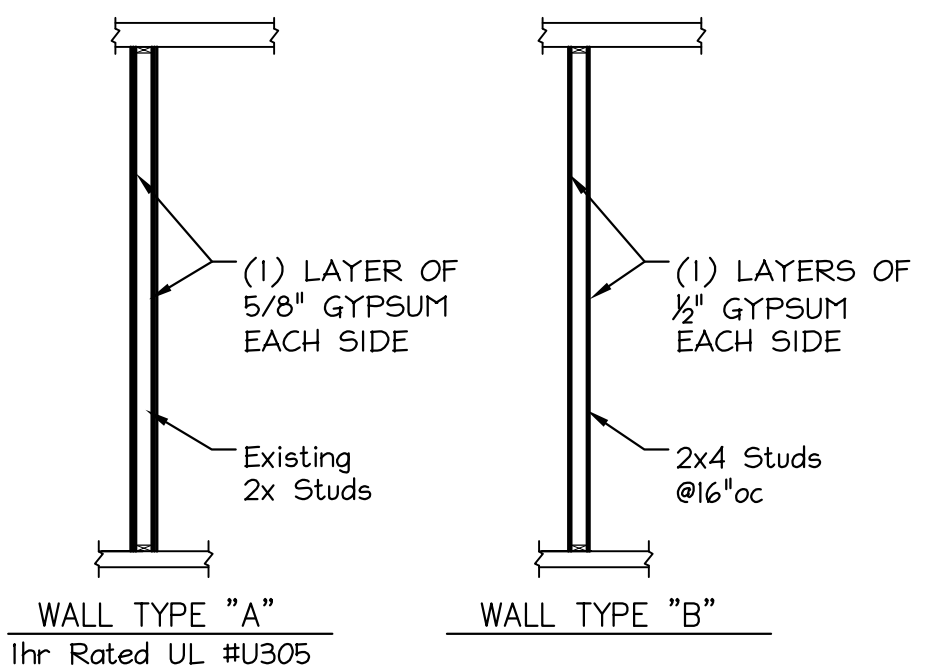

PARTITION TYPES

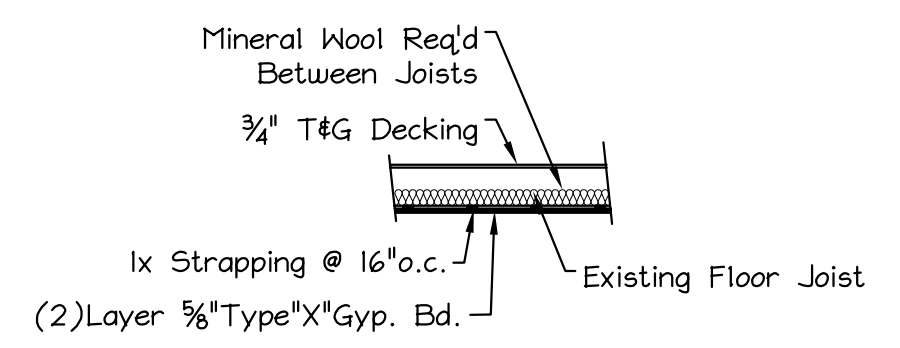

DETAIL - 1Hr. Rated Ceiling Assembly At First Floor Ceiling UL# L501

DRAWING LIST:

|      |                   |
|------|-------------------|
| A0.0 | COVER SHEET       |
| A-1  | FLOOR PLANS       |
| A-2  | ELEVATIONS        |
| S-1  | FRAMING PLANS     |
| S-2  | BUILDING SECTIONS |


ISSUED 02/19/2019

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Use of these drawings by others without written consent is prohibited.

**MACLEOD**  
STRUCTURAL ENGINEERS, PA  
90 BRIDGE STREET SUITE 239  
WESTBROOK, MAINE 04092 207-839-0980

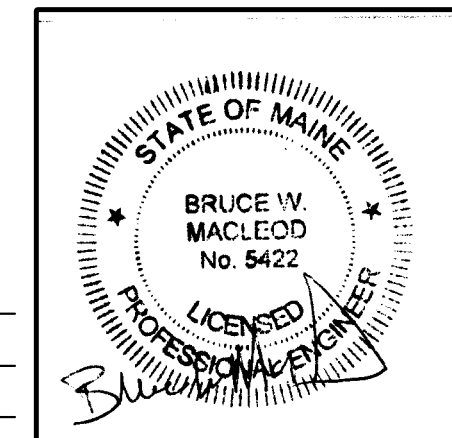
36 Spruce St. Renovations  
36 Spruce St.  
Portland, Maine



Per Review 1/24/19


TITLE: COVER SHEET

|                 |                    |                       |
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| SCALE: as noted | PROJ. NO: 2018-063 |                       |

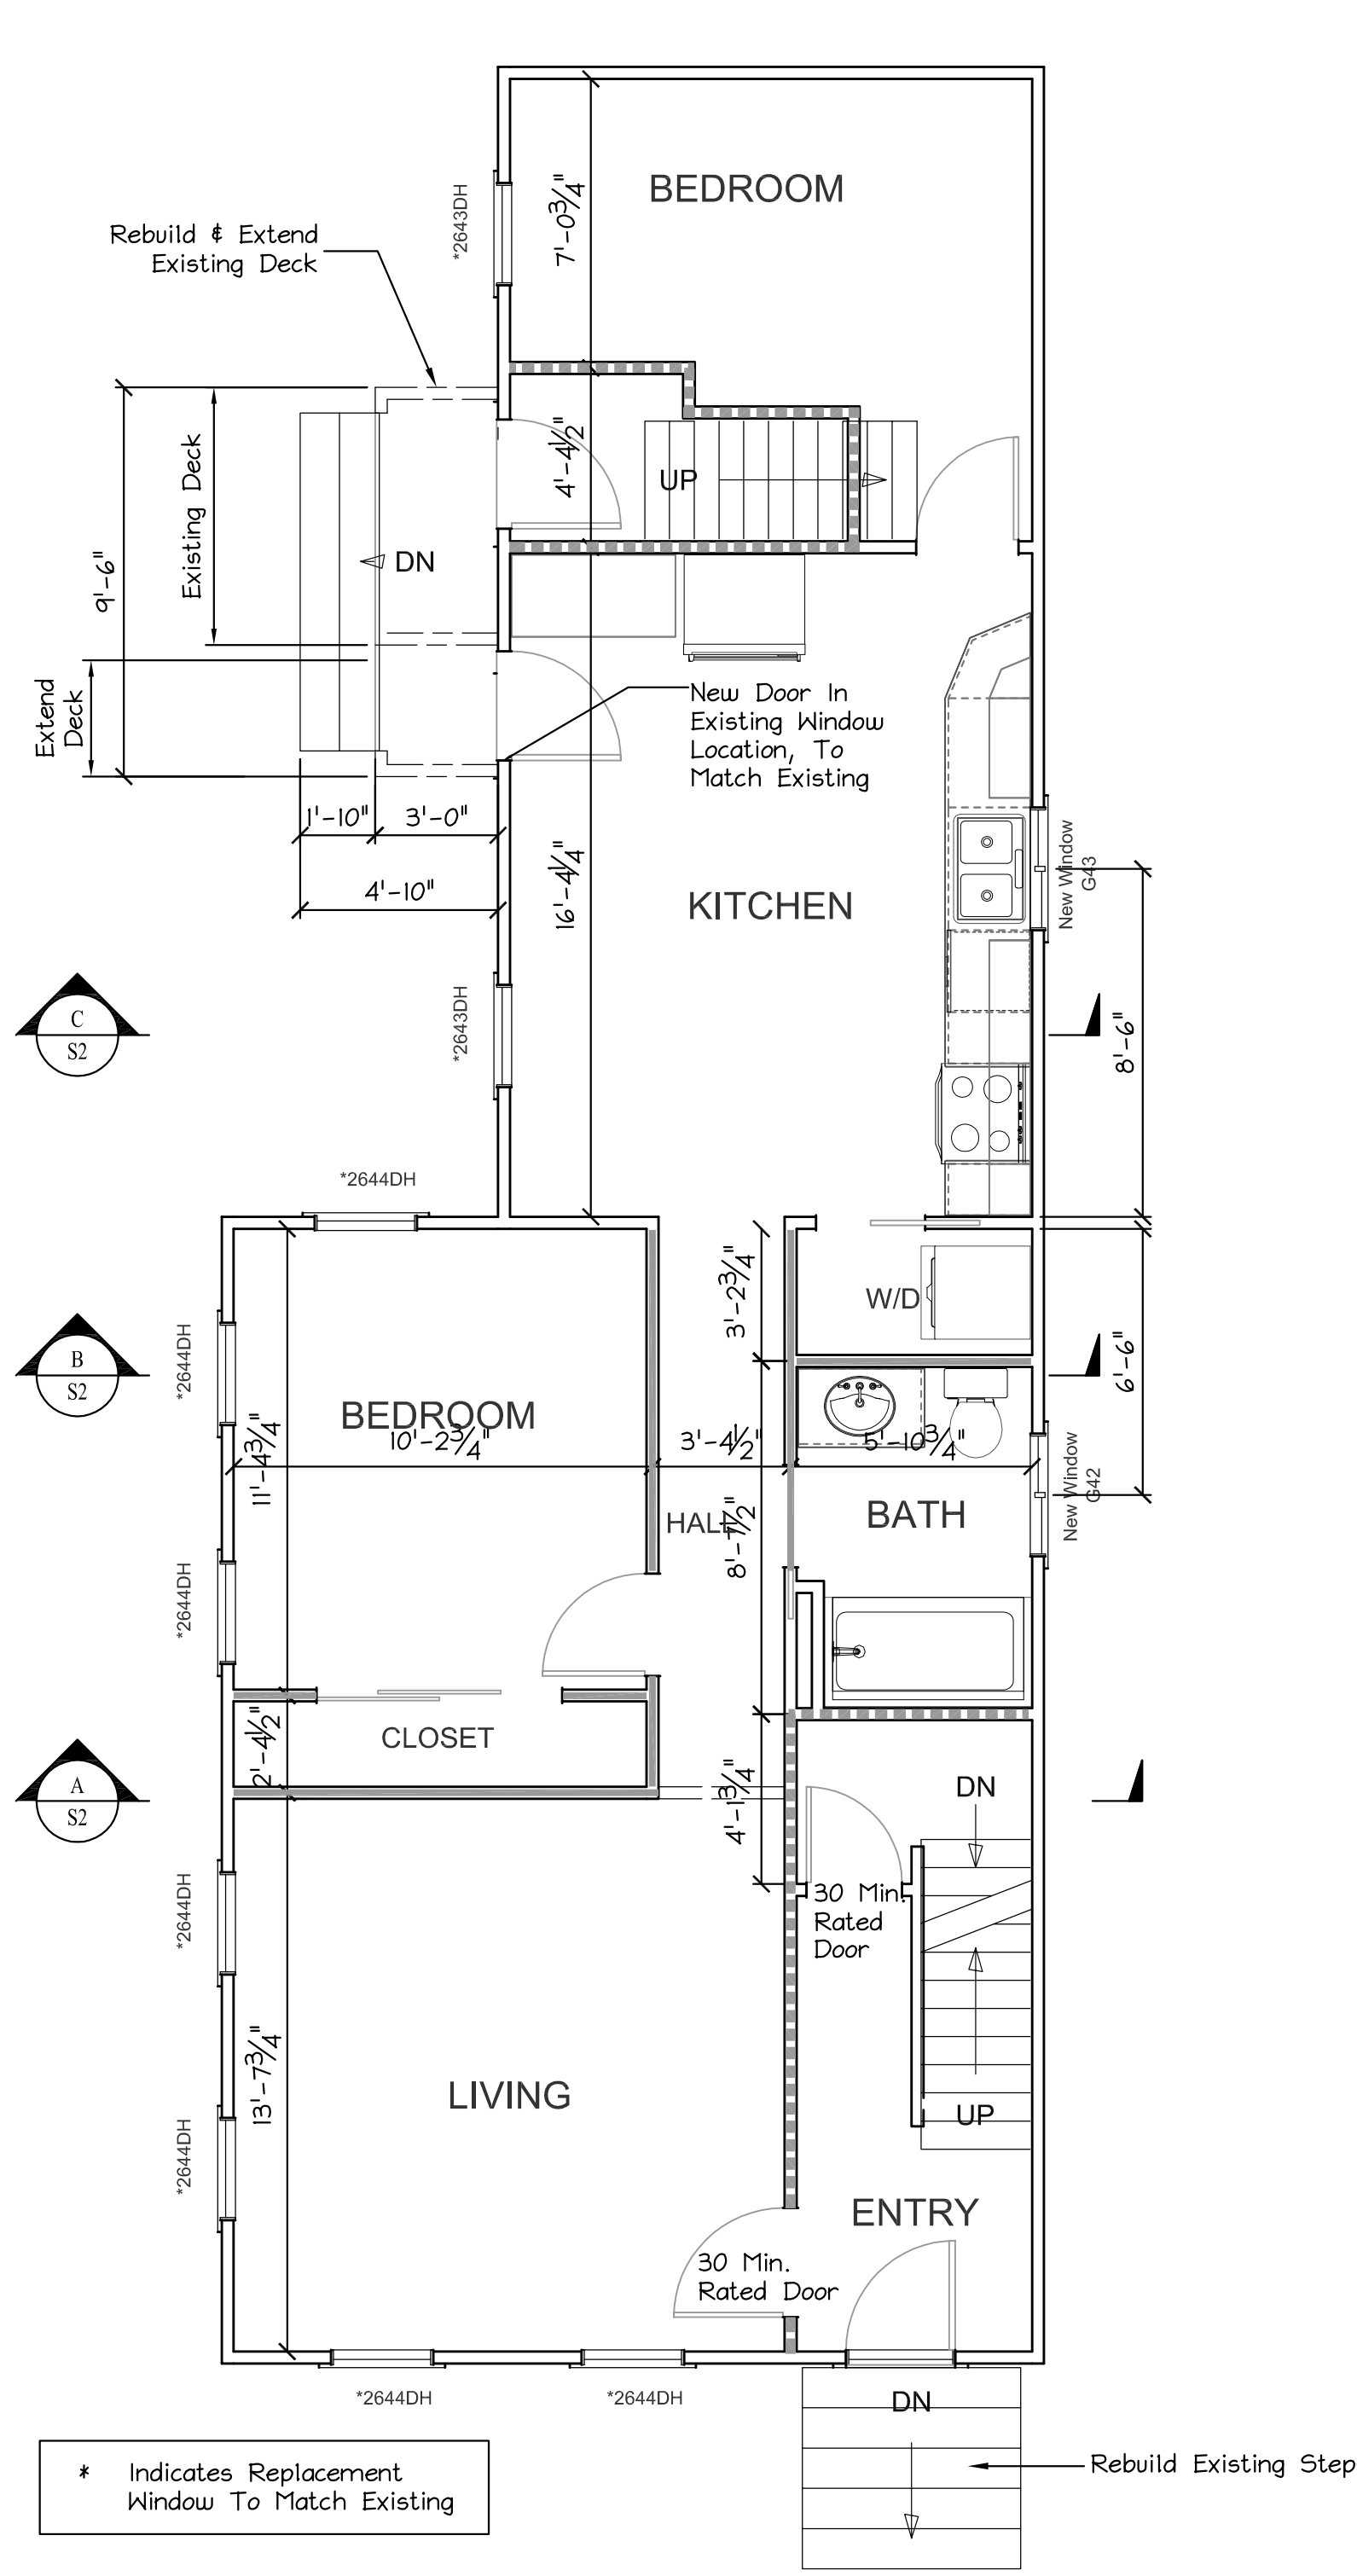


**FIRST FLOOR PLAN**  
Scale: 1/4" = 1'-0"

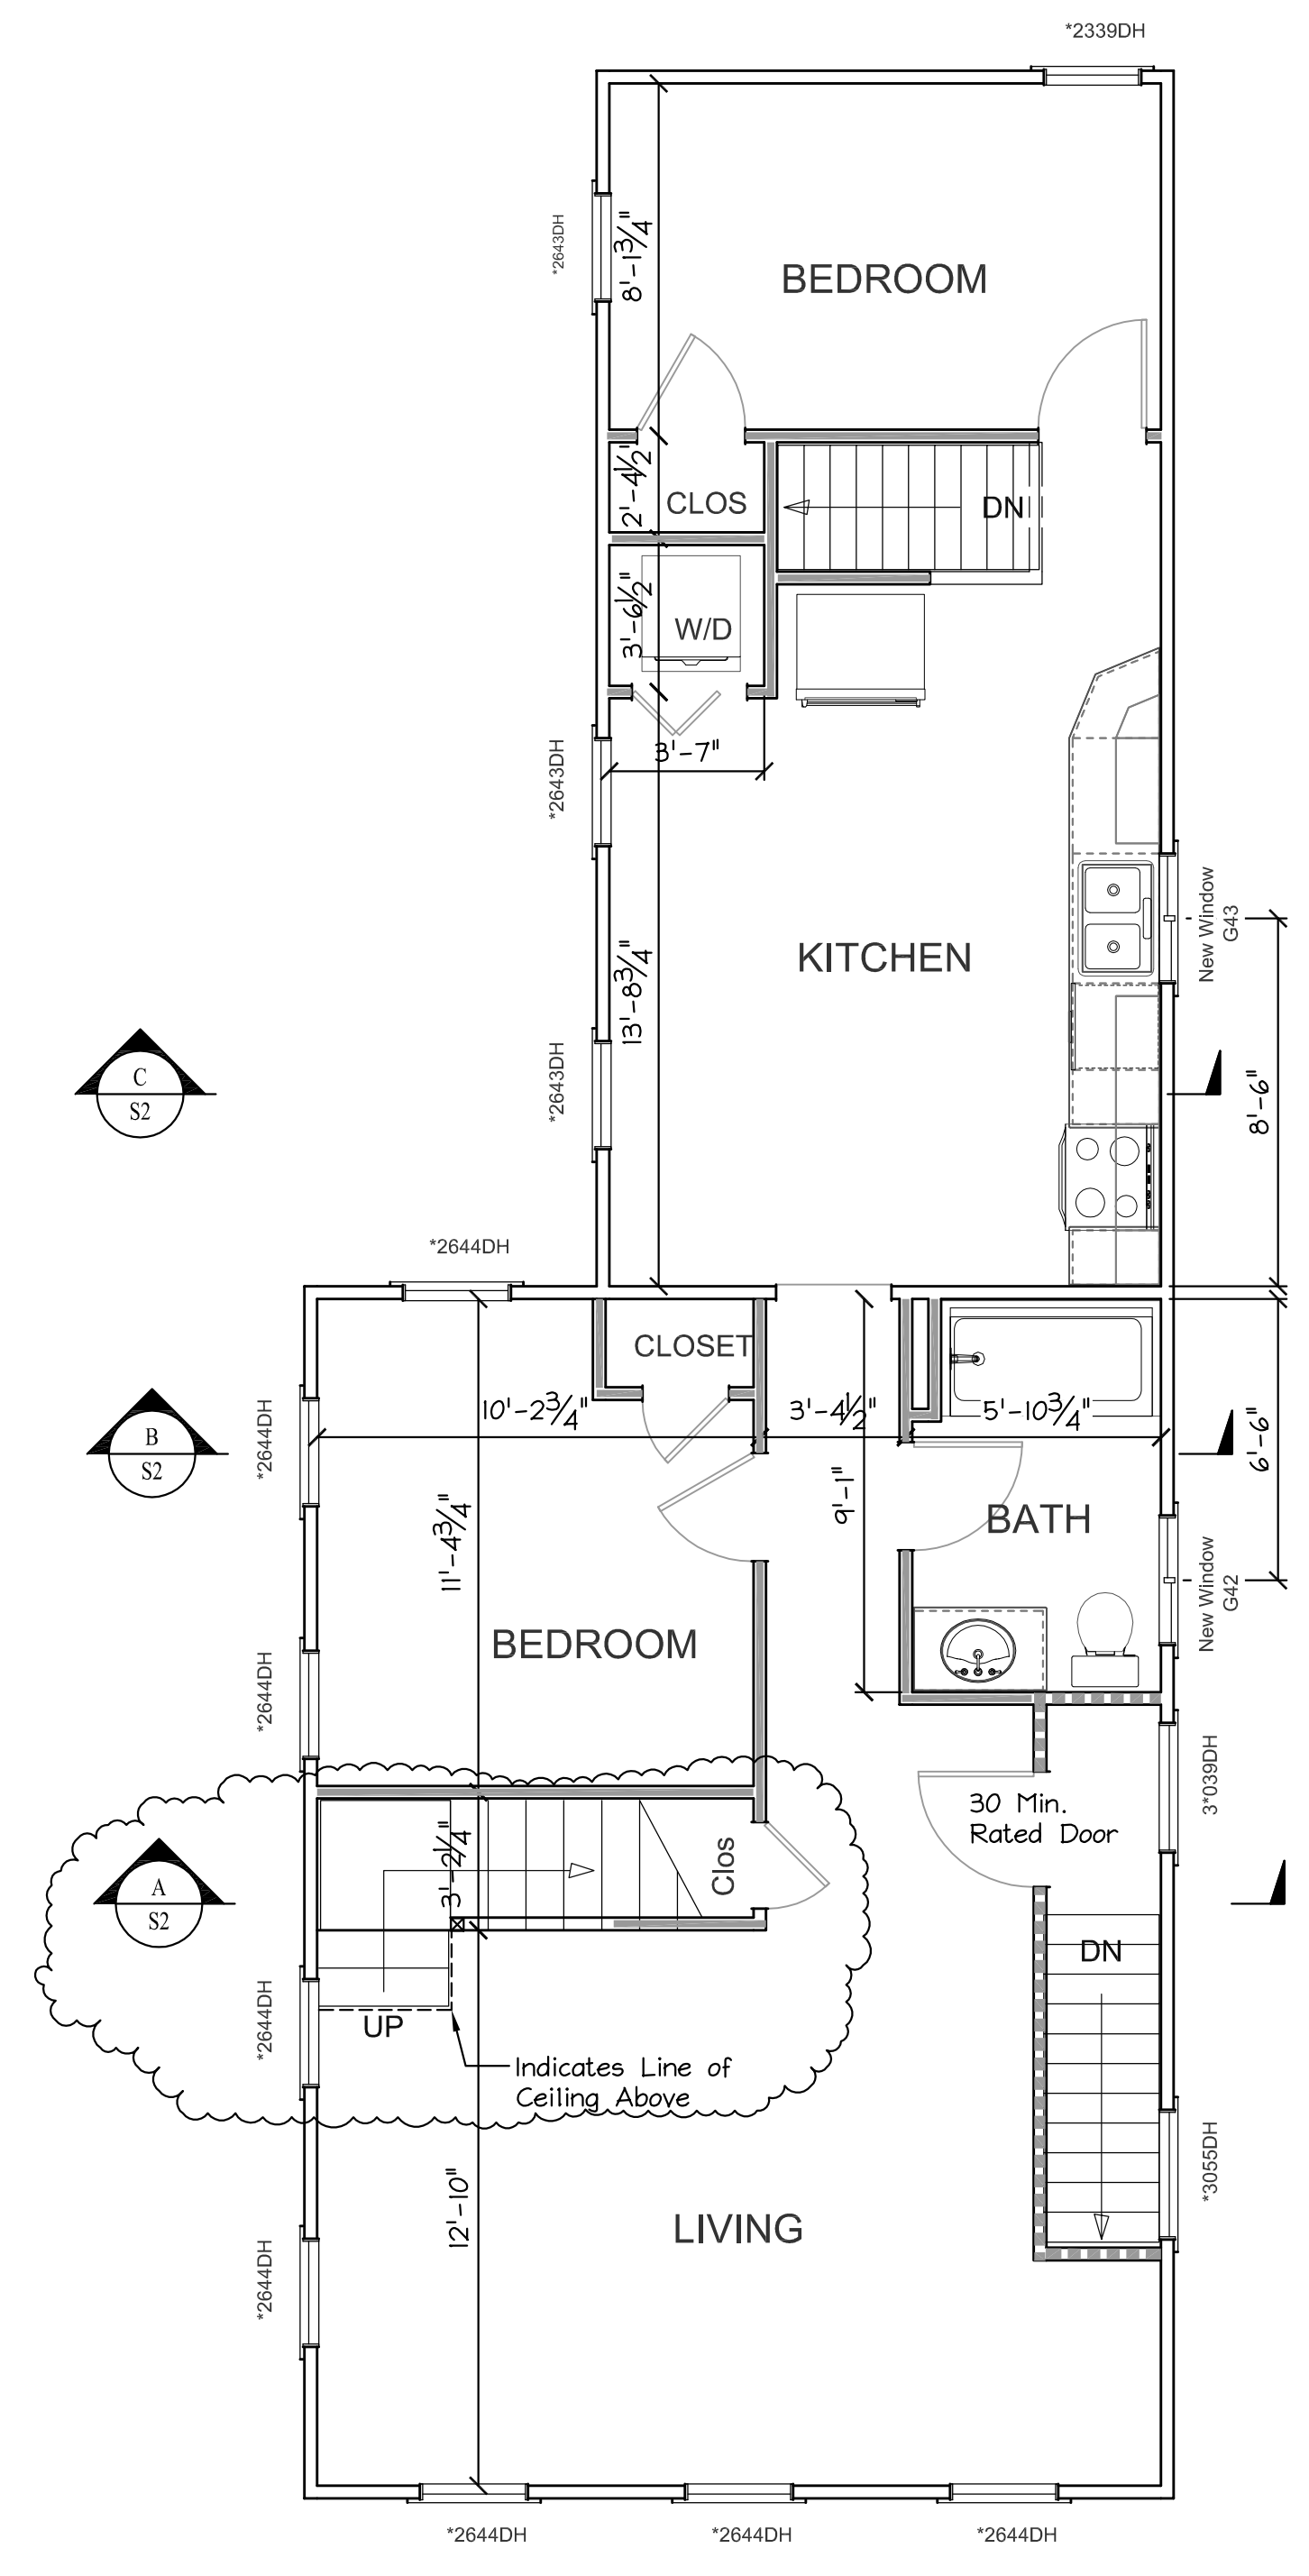- Existing Wall, Type A
- 1hr Rated UL#U305
- New Wall, Type B
- Existing Wall to Remain




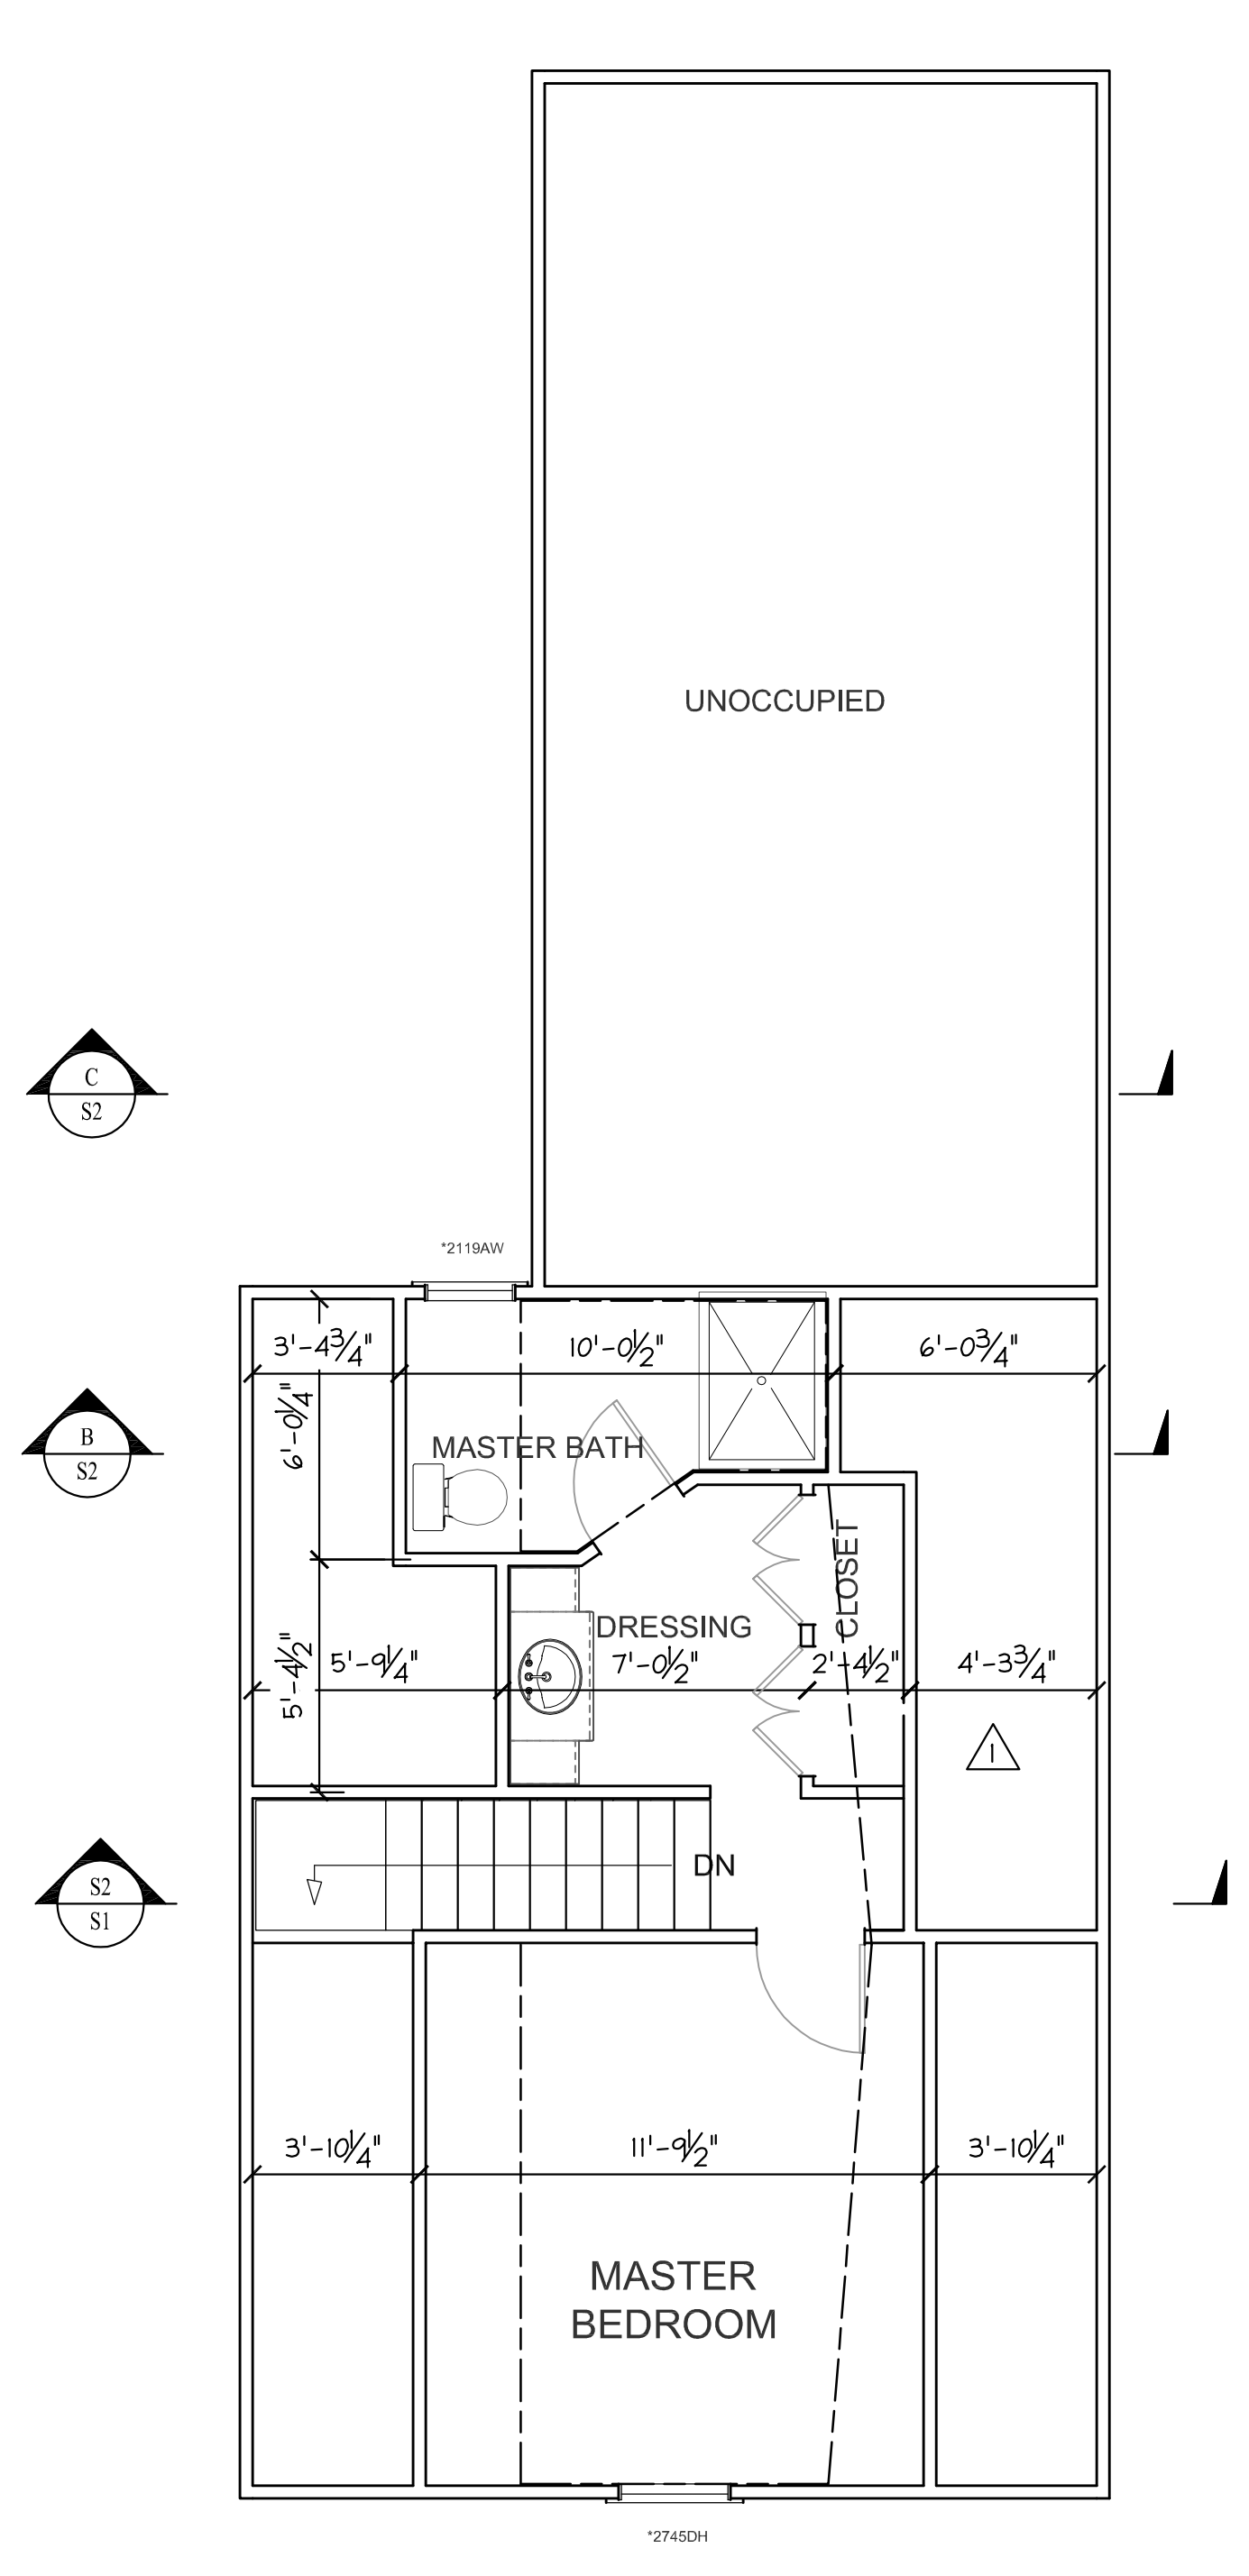**SECOND FLOOR PLAN**  
Scale: 1/4" = 1'-0"




**THIRD FLOOR PLAN**  
Scale: 1/4" = 1'-0"

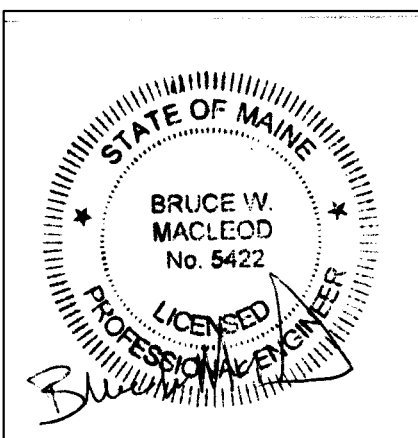Per Review 1/24/19



|  |                   |                     |
|--|-------------------|---------------------|
| MACLEOD<br>STRUCTURAL ENGINEERS, PA<br>80 Bridge Street Suite 232<br>Westbrook, Maine 04092 207.639.0980 |                   |                     |
| 36 Spruce St. Renovations<br>36 Spruce St.<br>Portland, Maine  |                   |                     |
| TITLE: FLOOR PLAN & SECTION  |                   |                     |
| DATE: 10.03.18   | DRAWN BY: BIM     | DRAWING NUMBER: A-1 |
| SCALE: as noted  | PROJ NO: 2018-063 |                     |

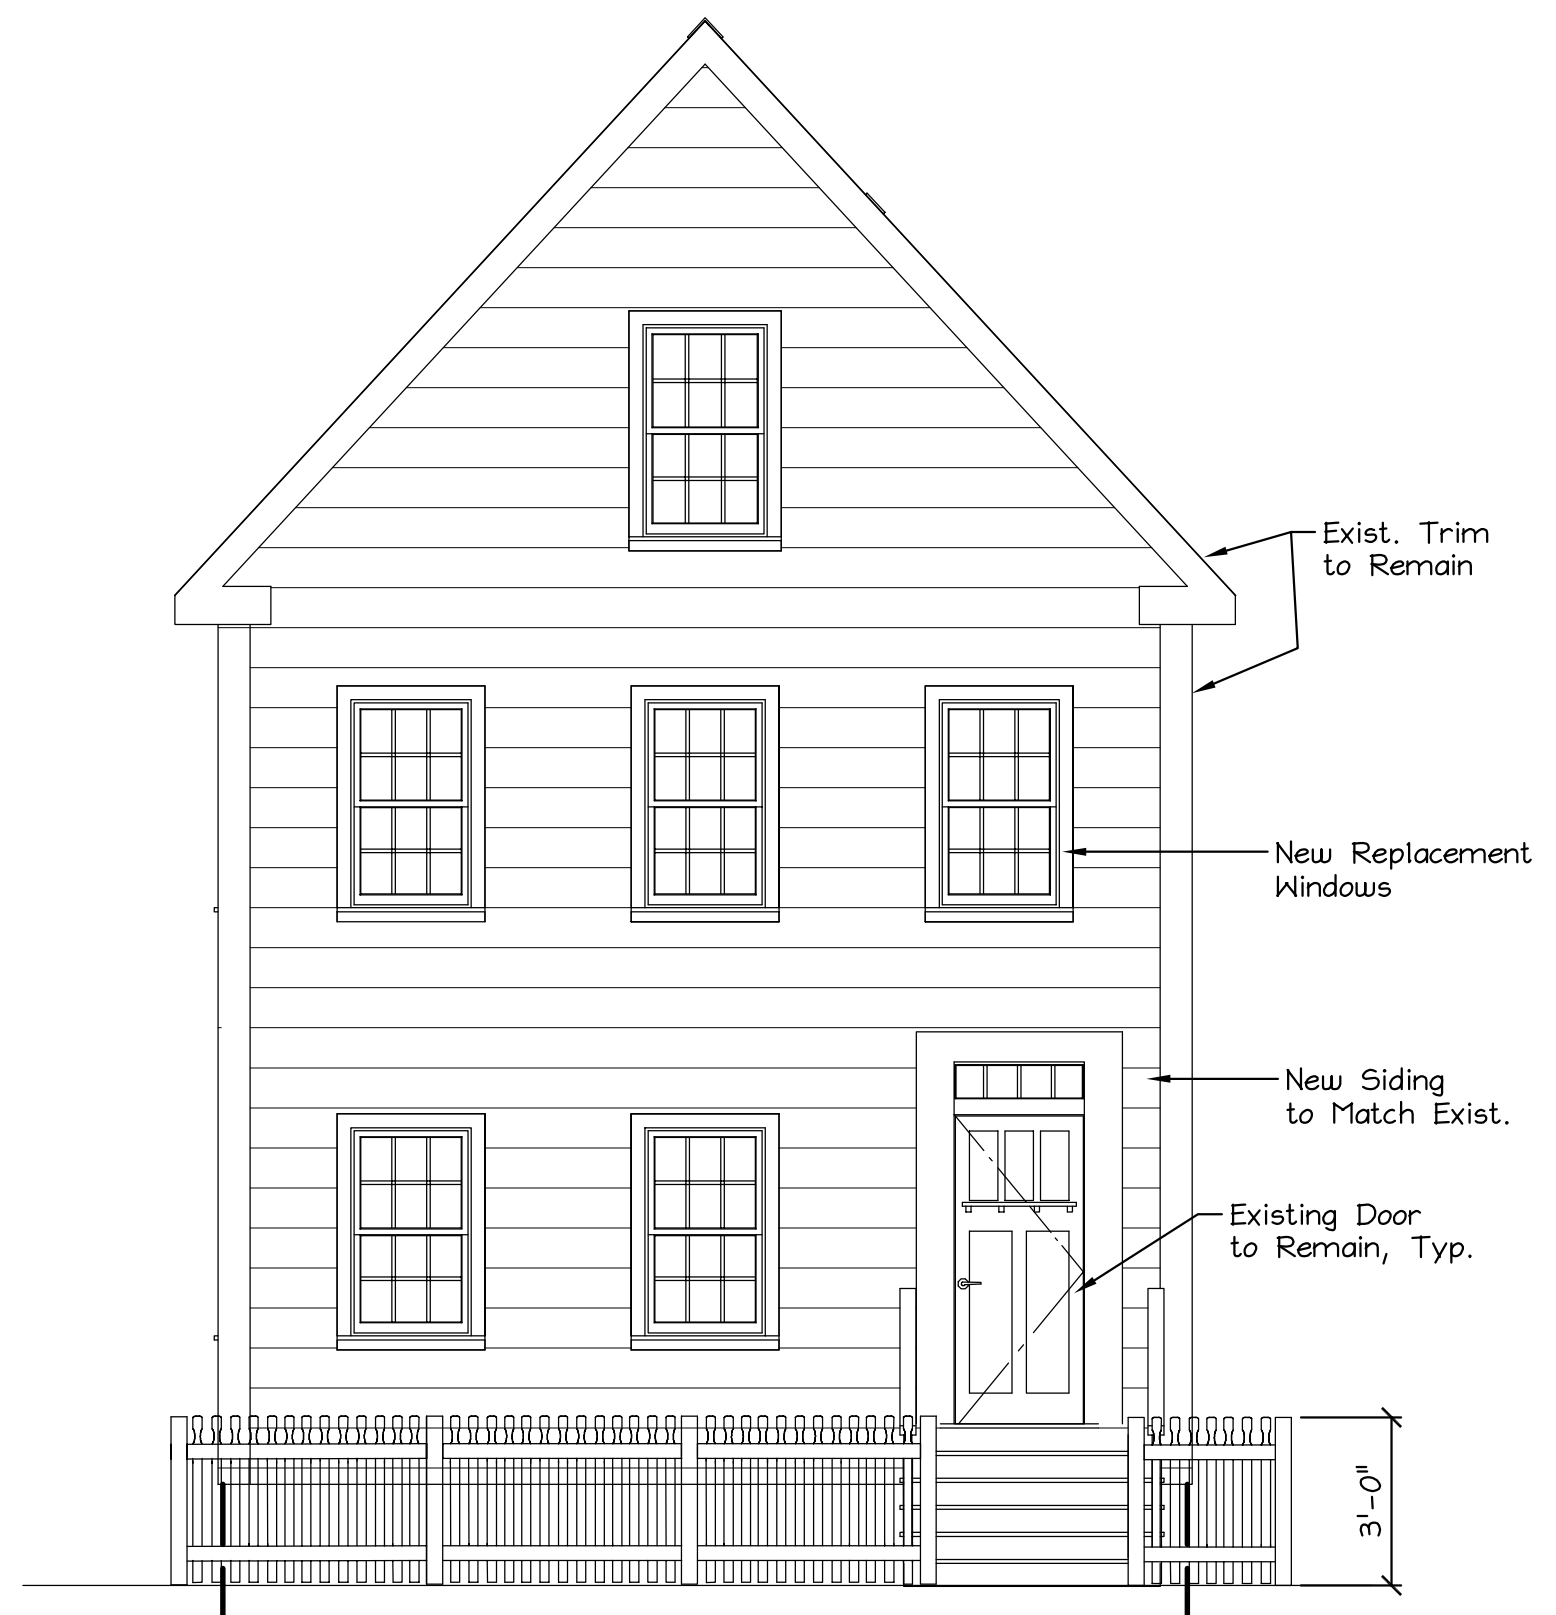
ISSUED 02/14/2019




FRONT (SPRUCE ST.) ELEVATION  
Scale: 1/4" = 1'-0"



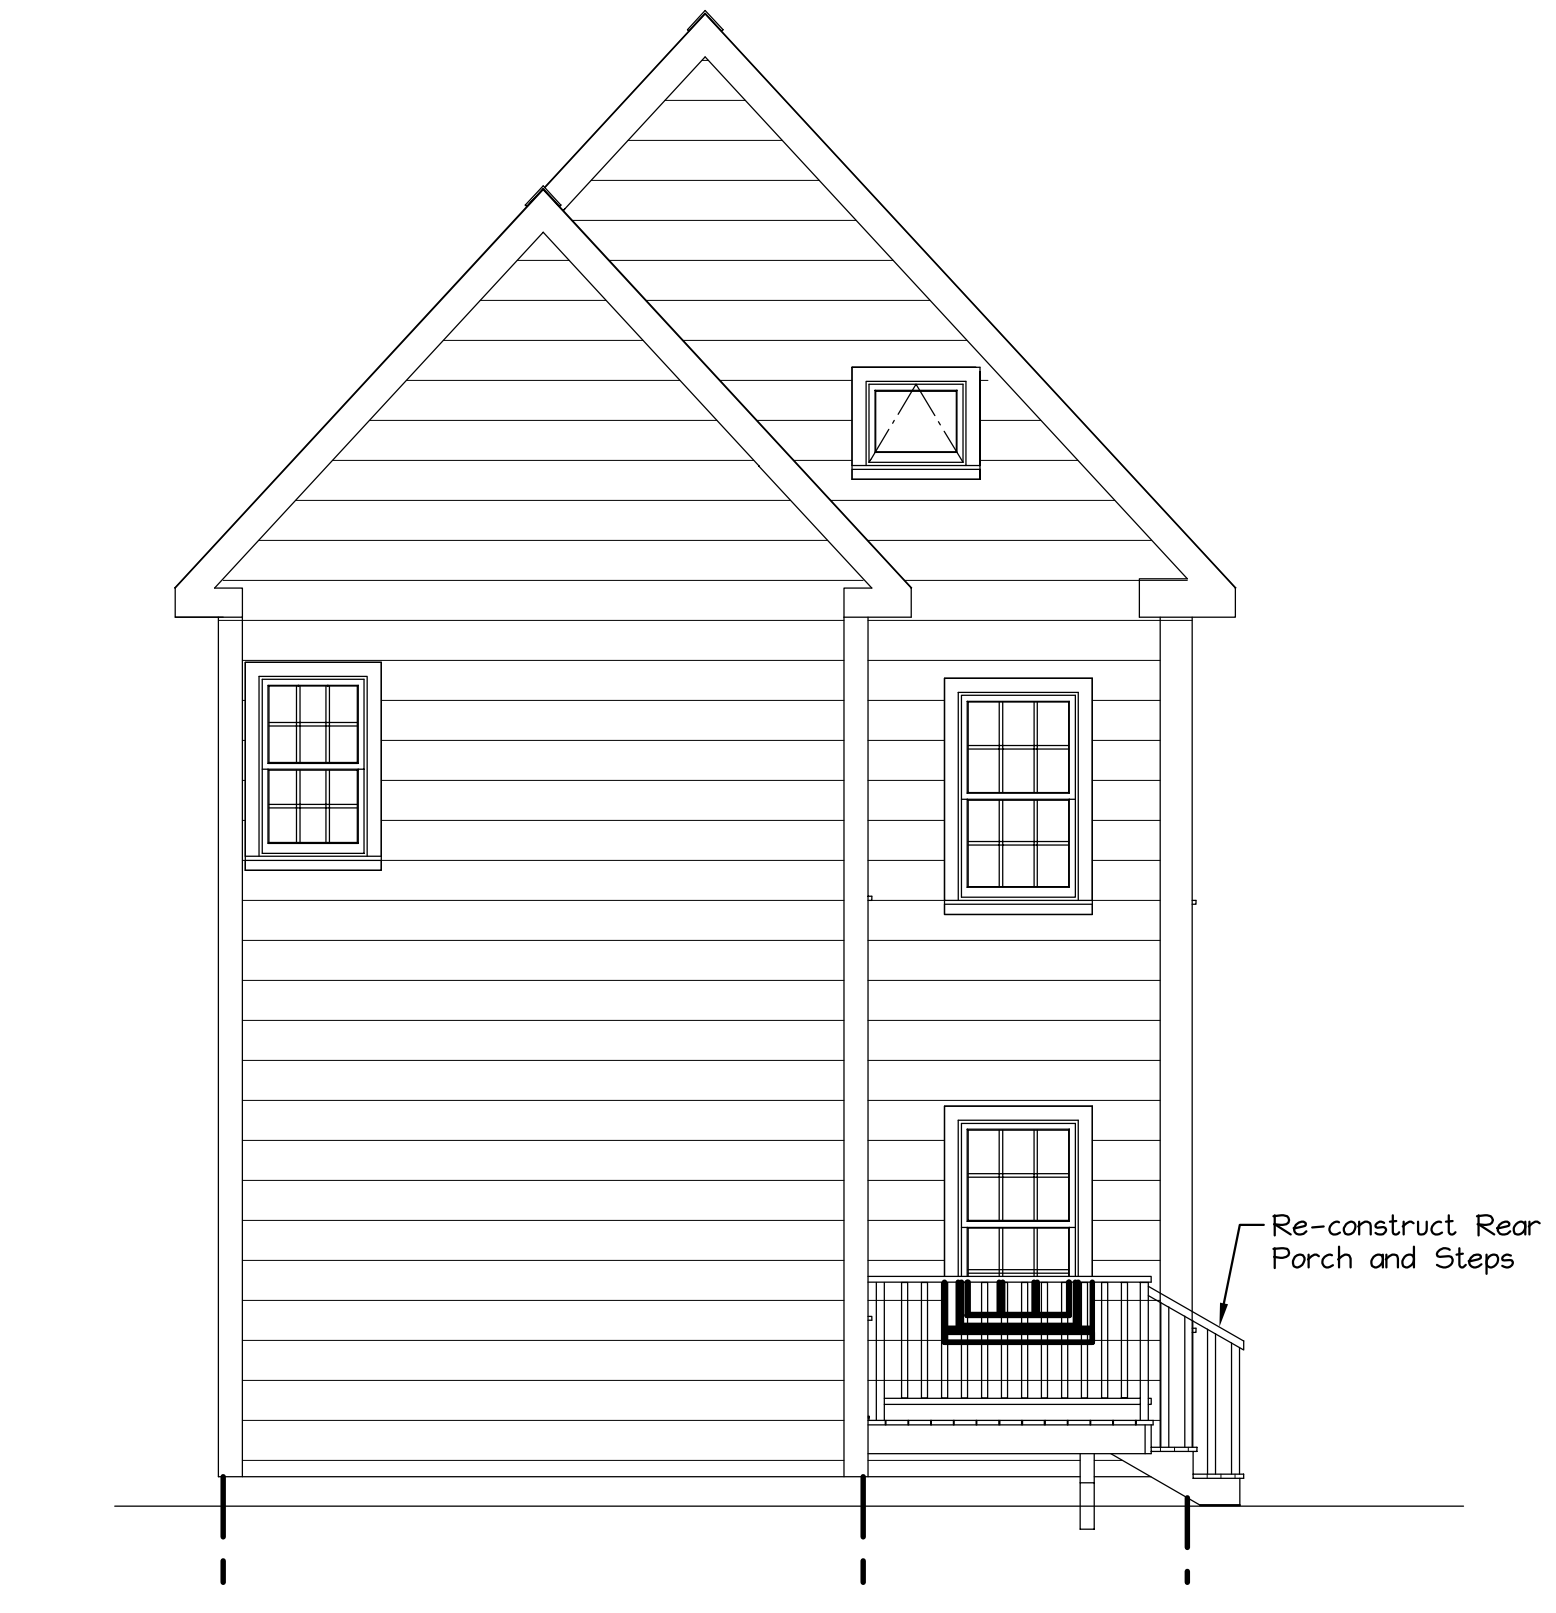LEFT SIDE ELEVATION  
Scale: 1/4" = 1'-0"




REAR ELEVATION  
Scale: 1/4" = 1'-0"

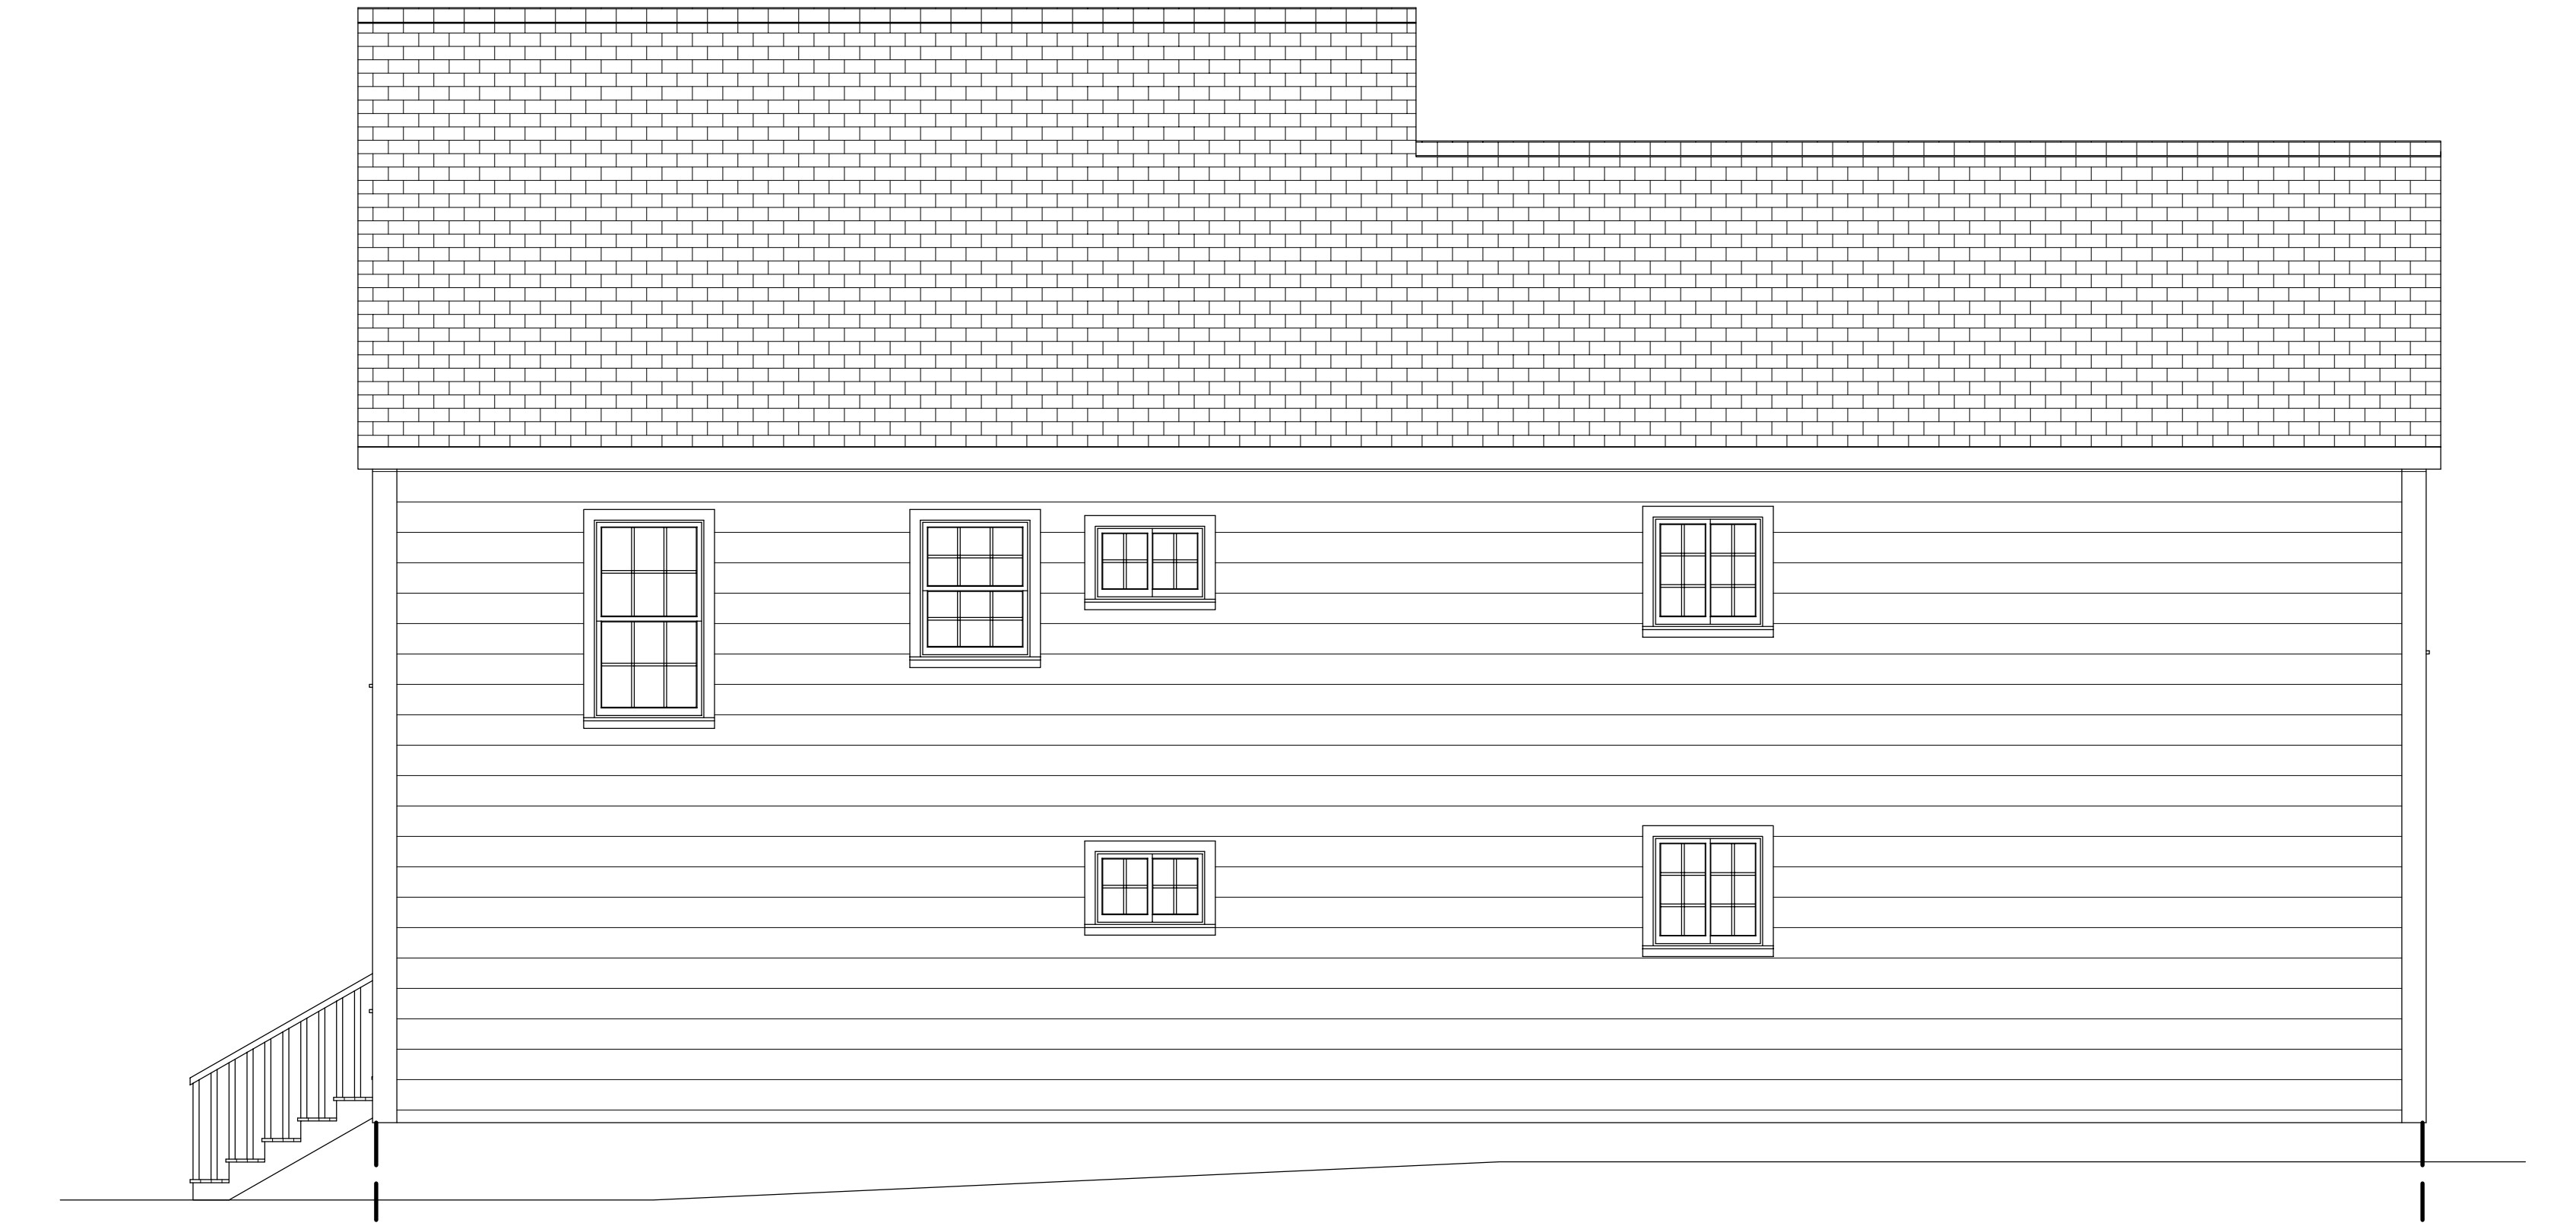


RIGHT SIDE ELEVATION  
Scale: 1/4" = 1'-0"

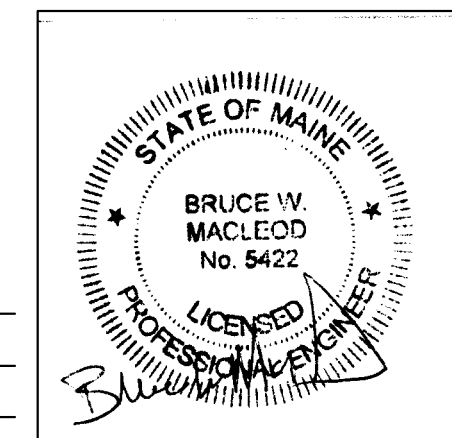ISSUED 01/24/2019




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| MACLEOD<br>STRUCTURAL ENGINEERS, PA<br>80 Bridge Street Suite 252<br>Westbrook, Maine 04092 207.639.0980 |                   |                 |
| 36 Spruce St. Renovations<br>36 Spruce St.<br>Portland, Maine  |                   |                 |
| TITLE: ELEVATIONS  |                   |                 |
| DATE: 10.03.18   | DRAWN BY: BIM     | DRAWING NUMBER: |
| SCALE: as noted  | PROJ NO: 2018-063 | A-2             |

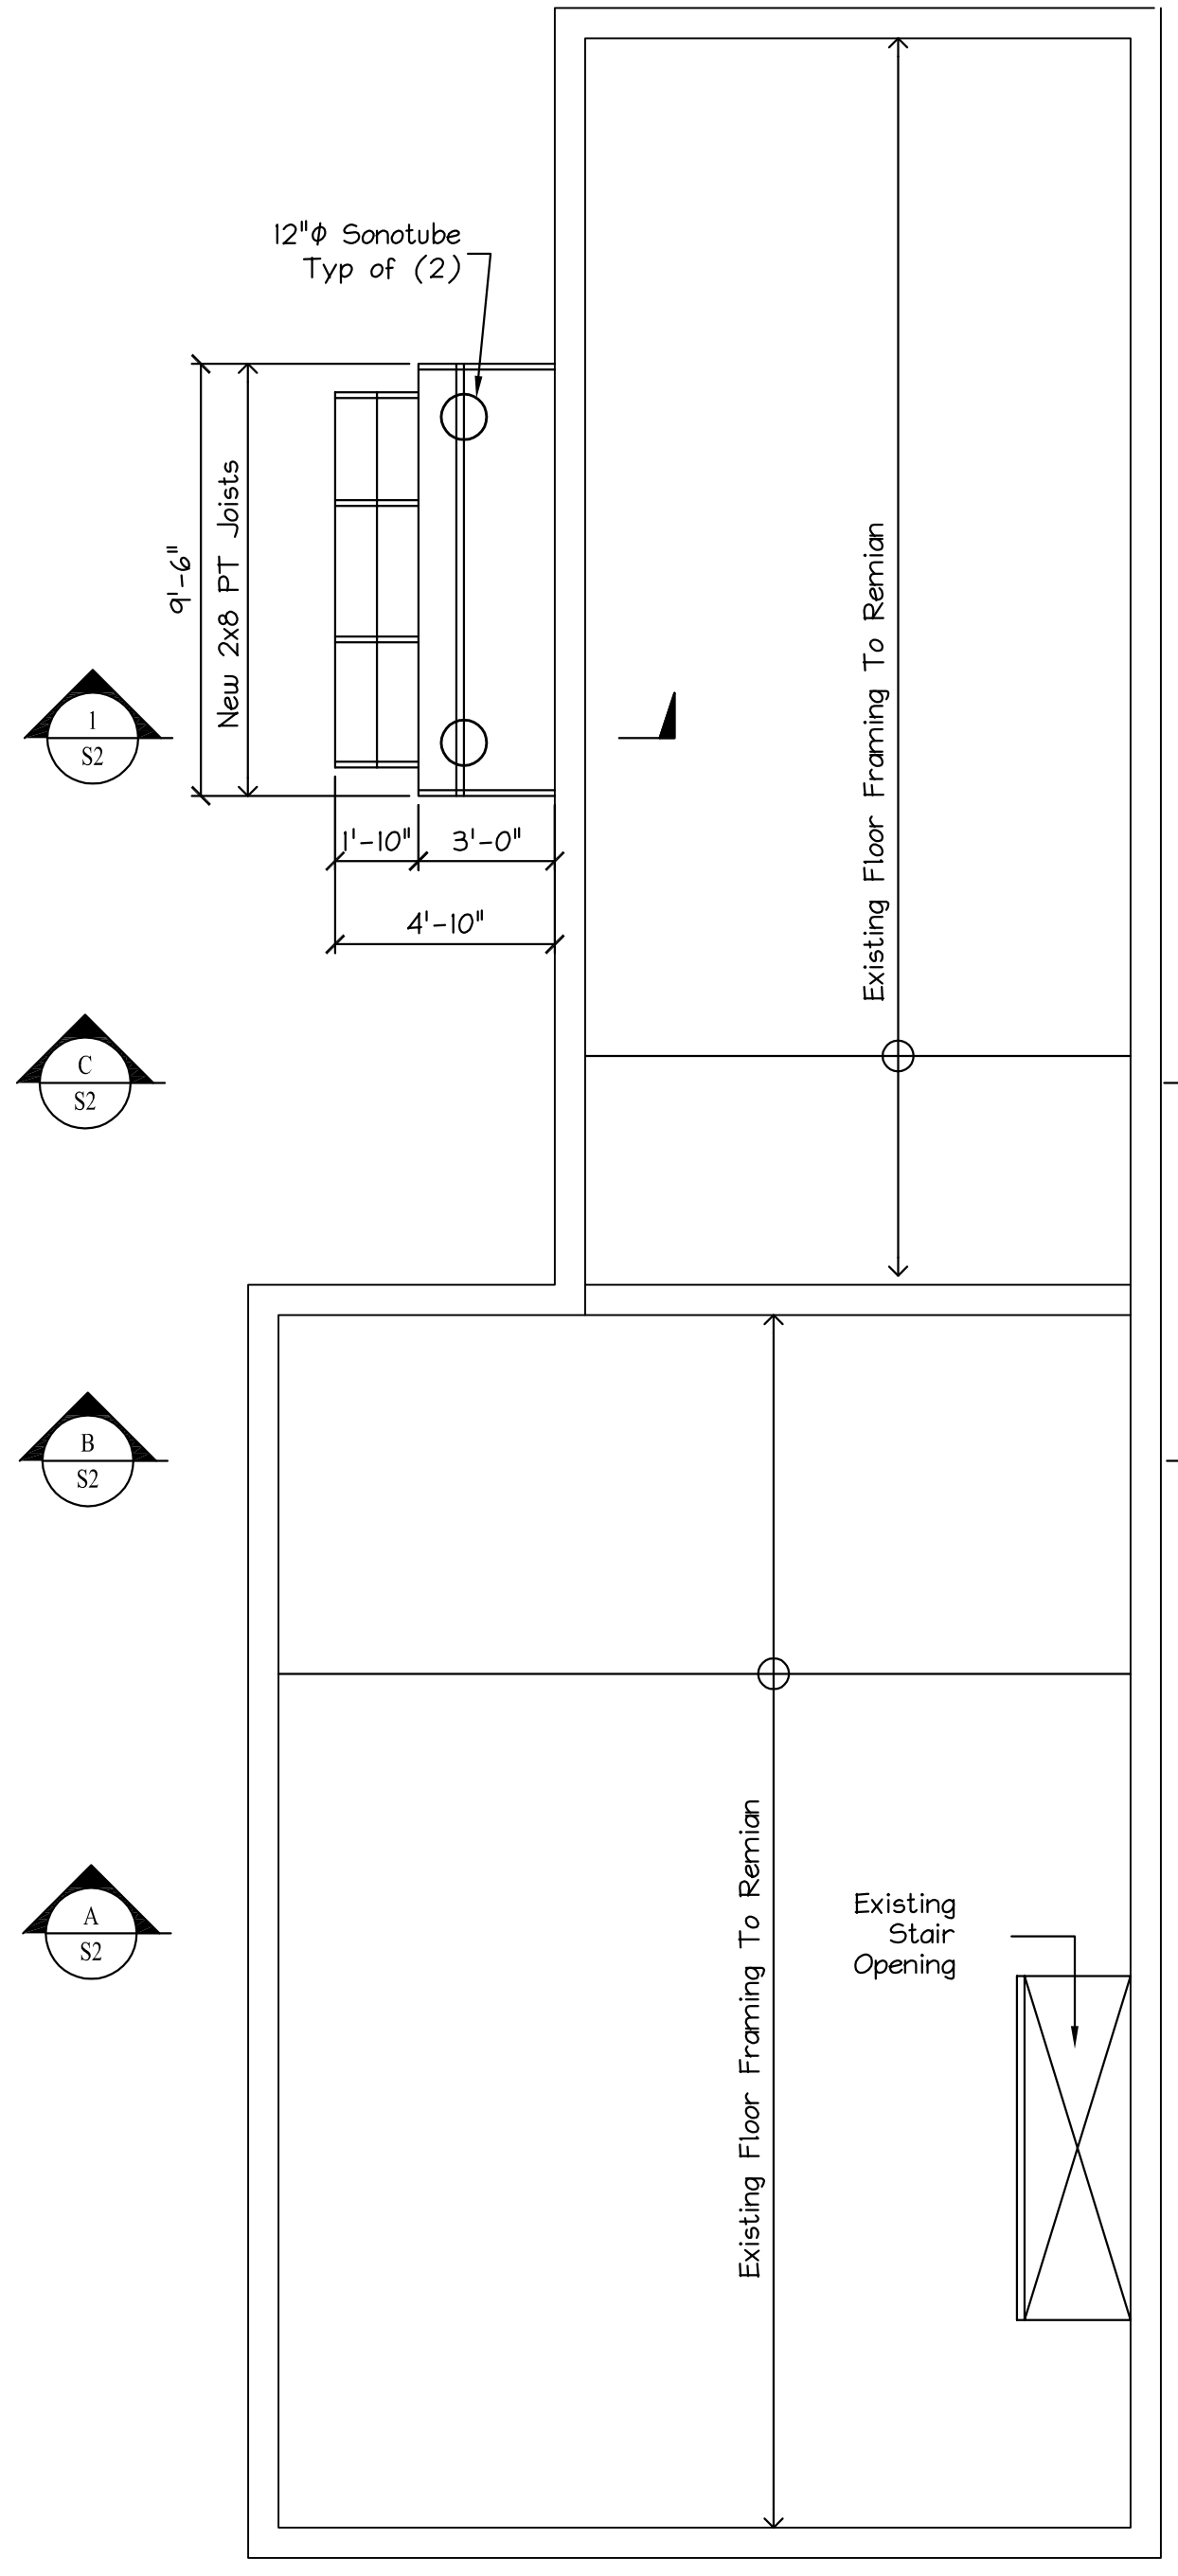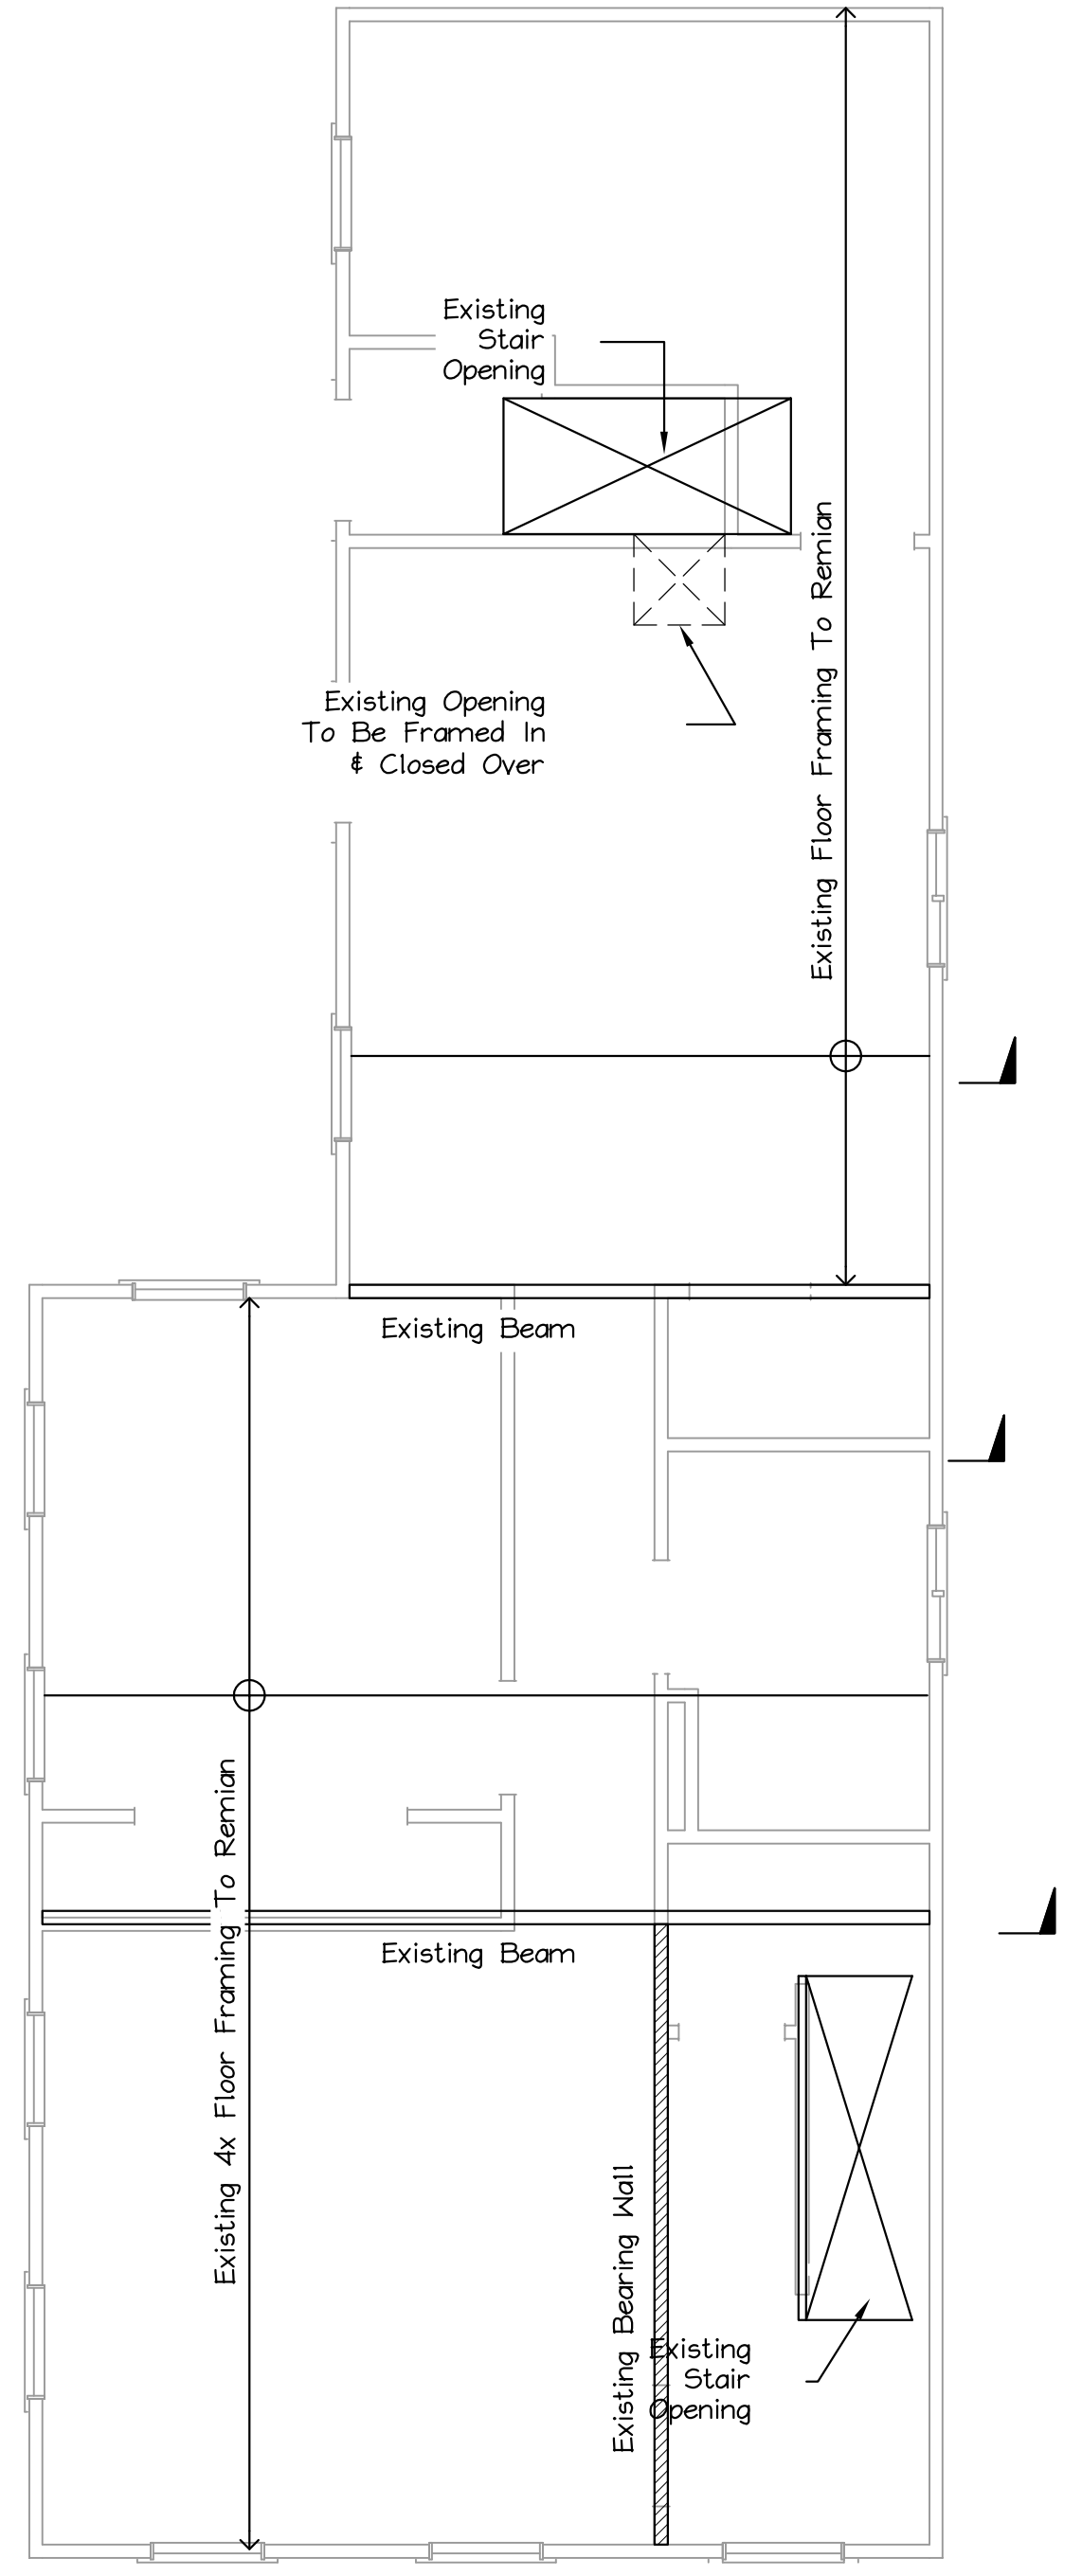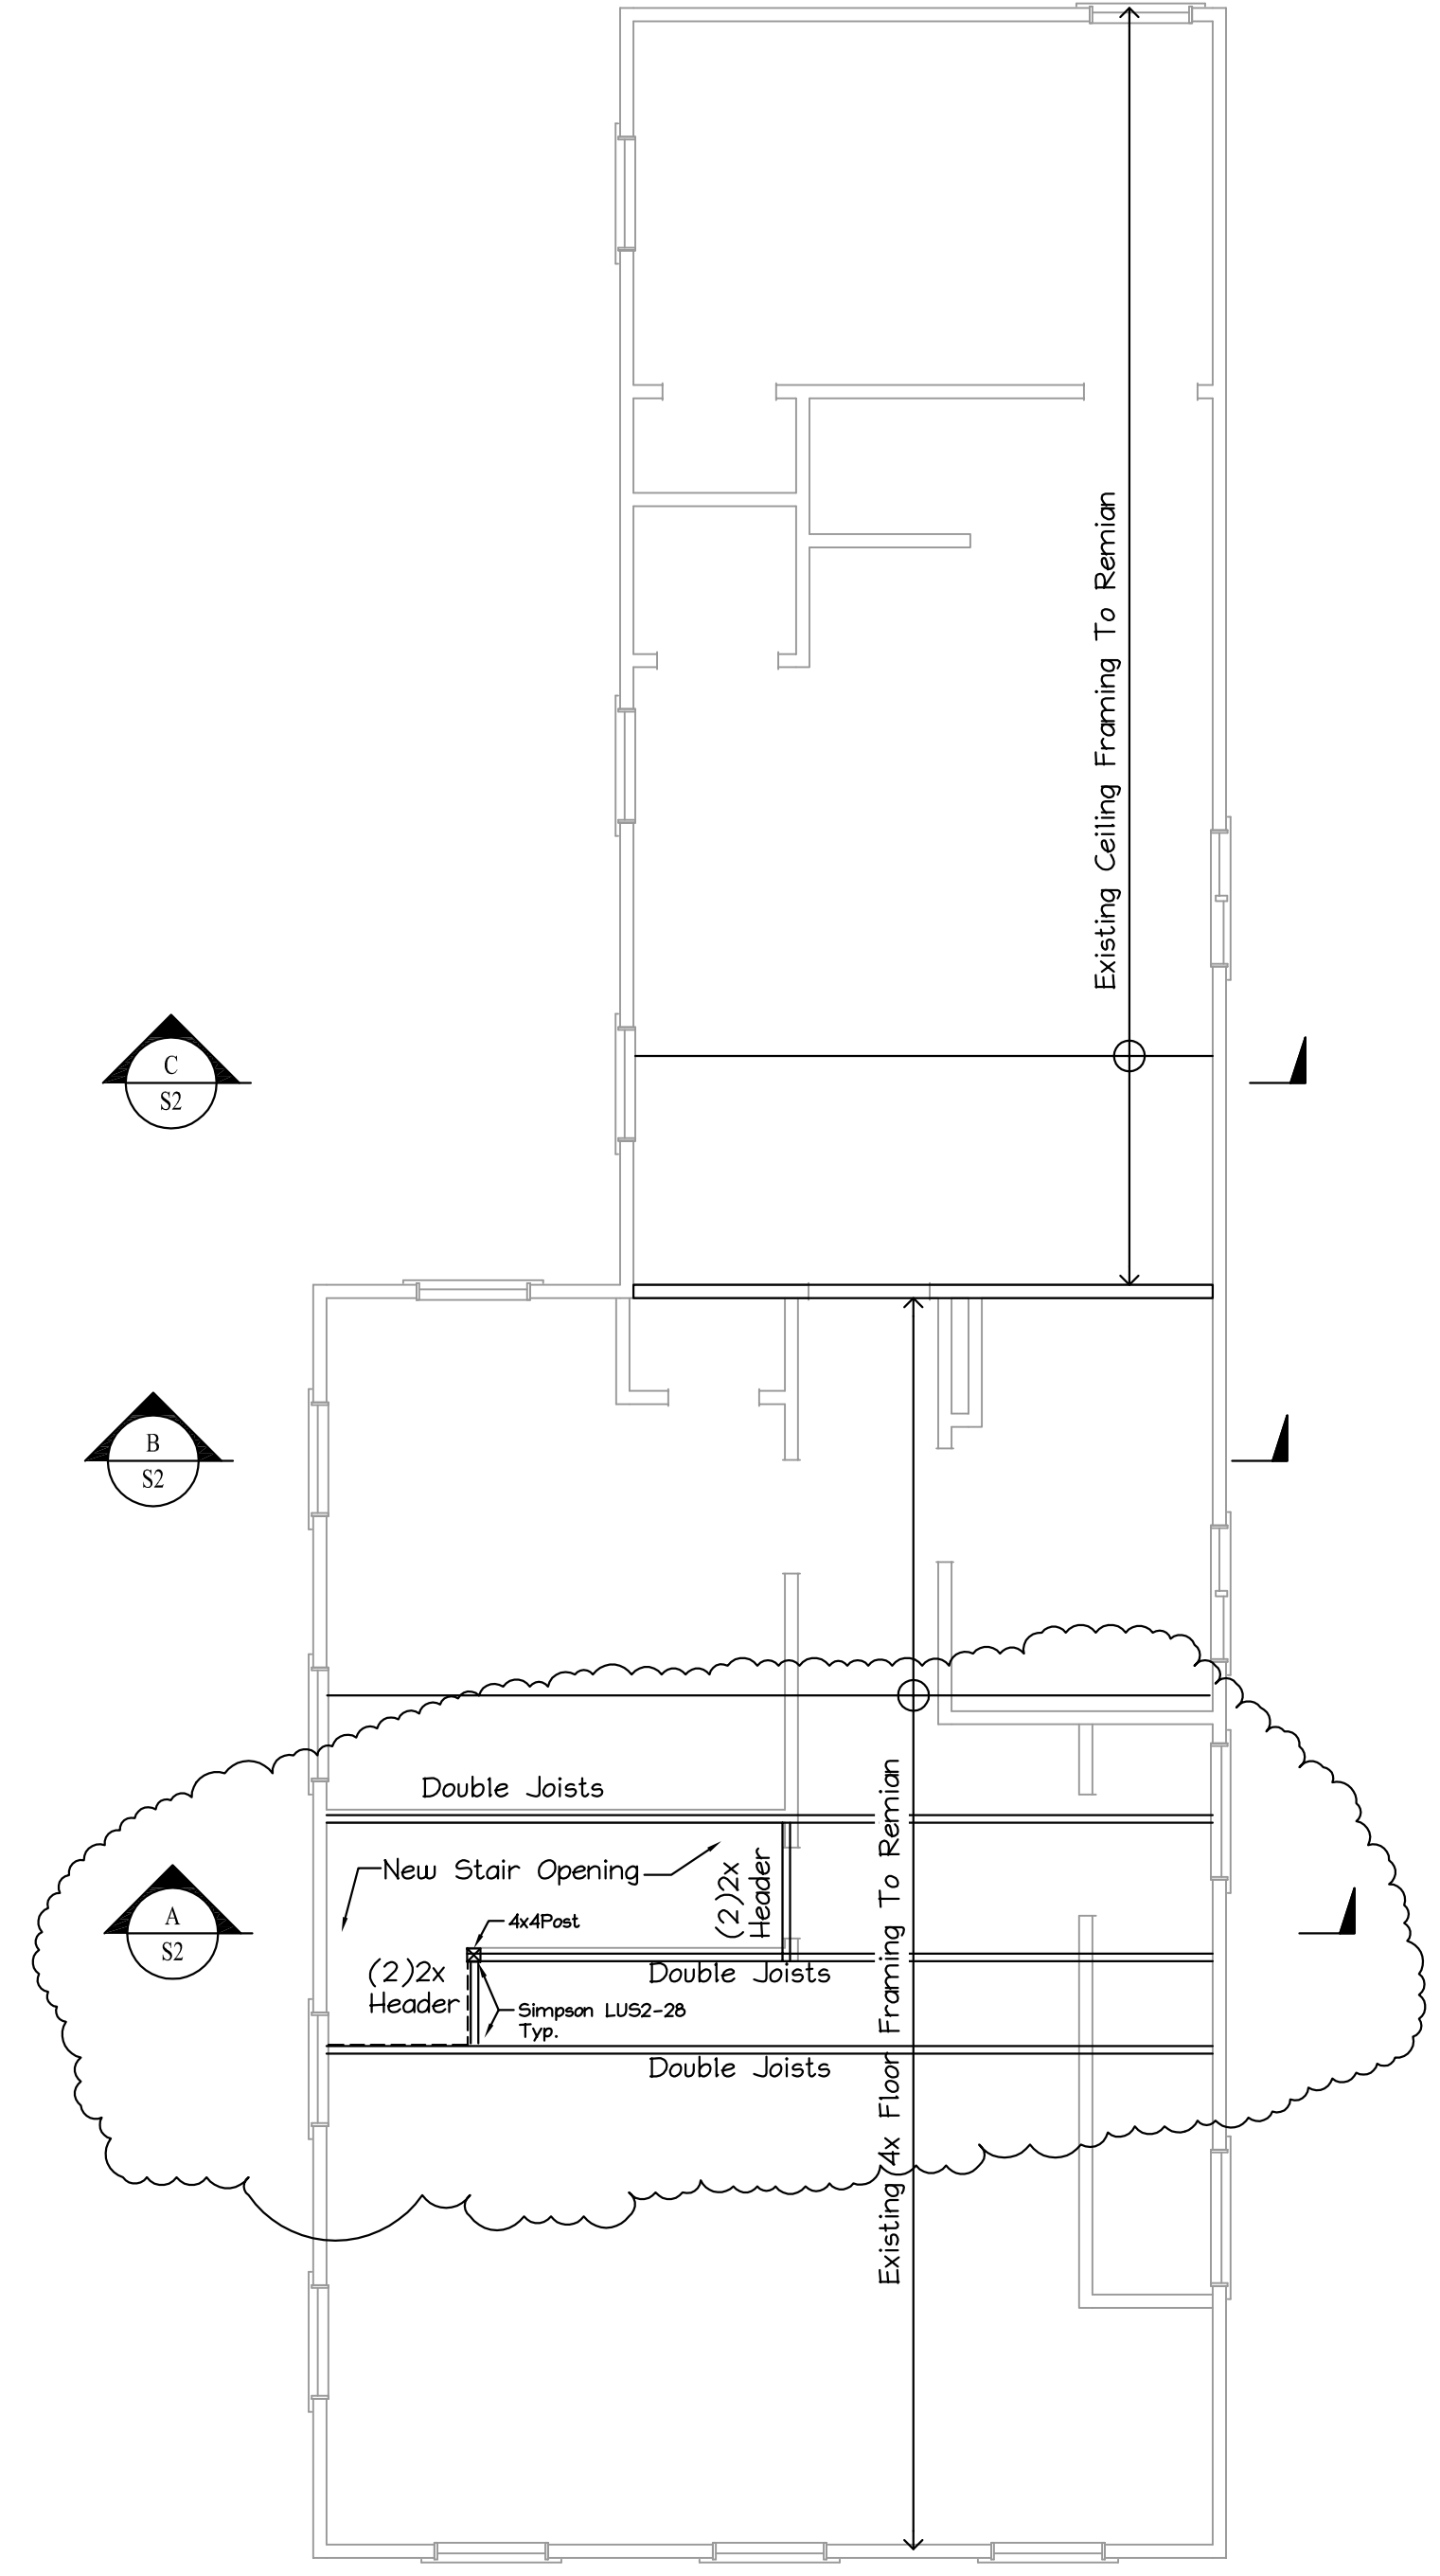
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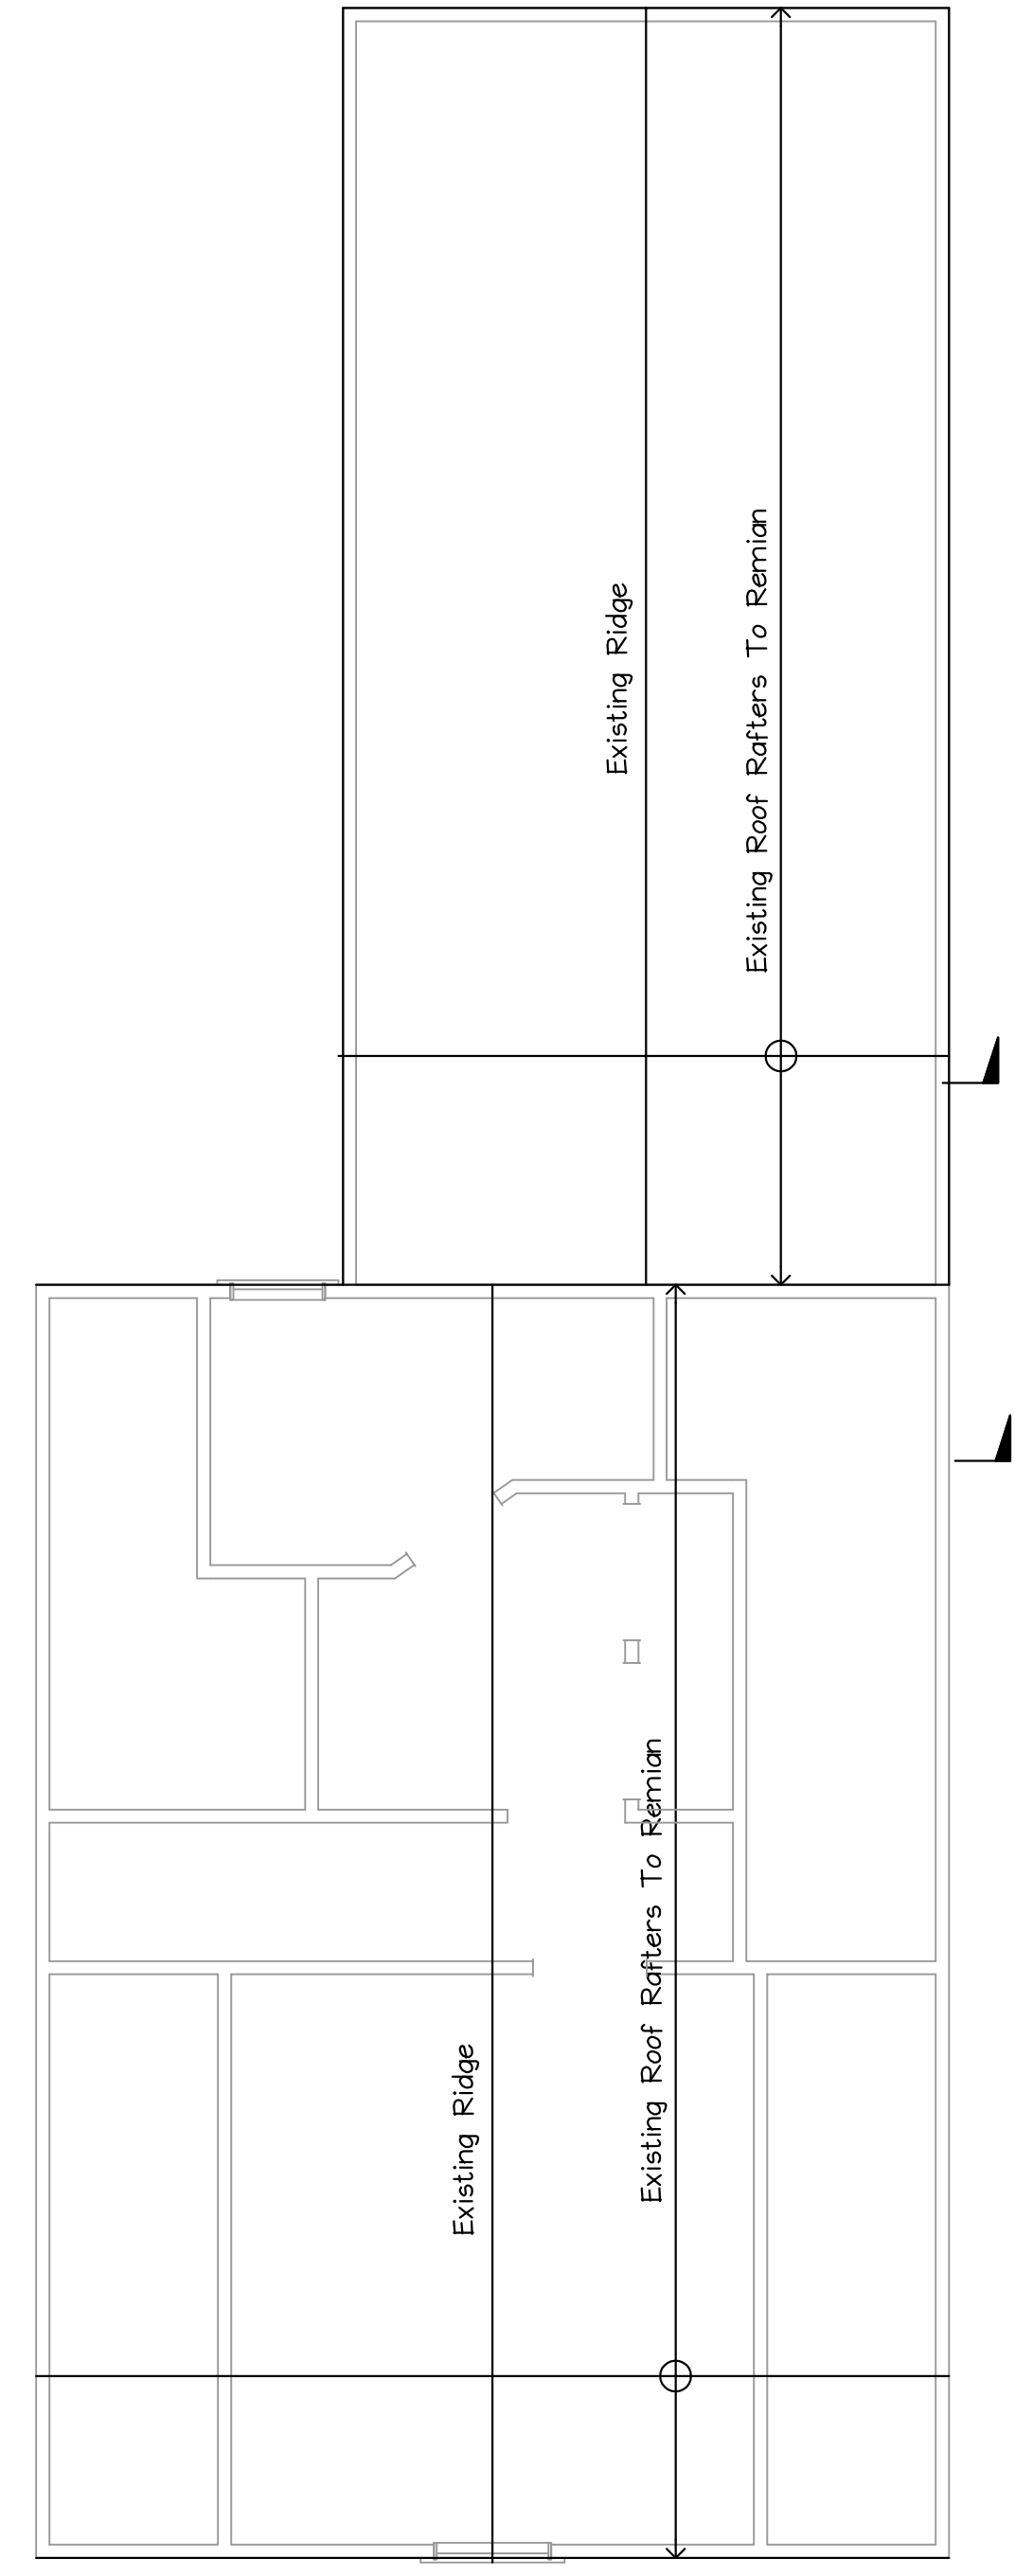
FIRST FLOOR FRAMING PLAN  
Scale: 1/4" = 1'-0"



SECOND FLOOR FRAMING PLAN  
Scale: 1/4" = 1'-0"

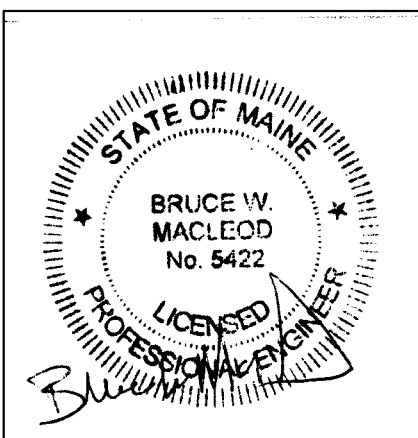


THIRD FLOOR FRAMING PLAN  
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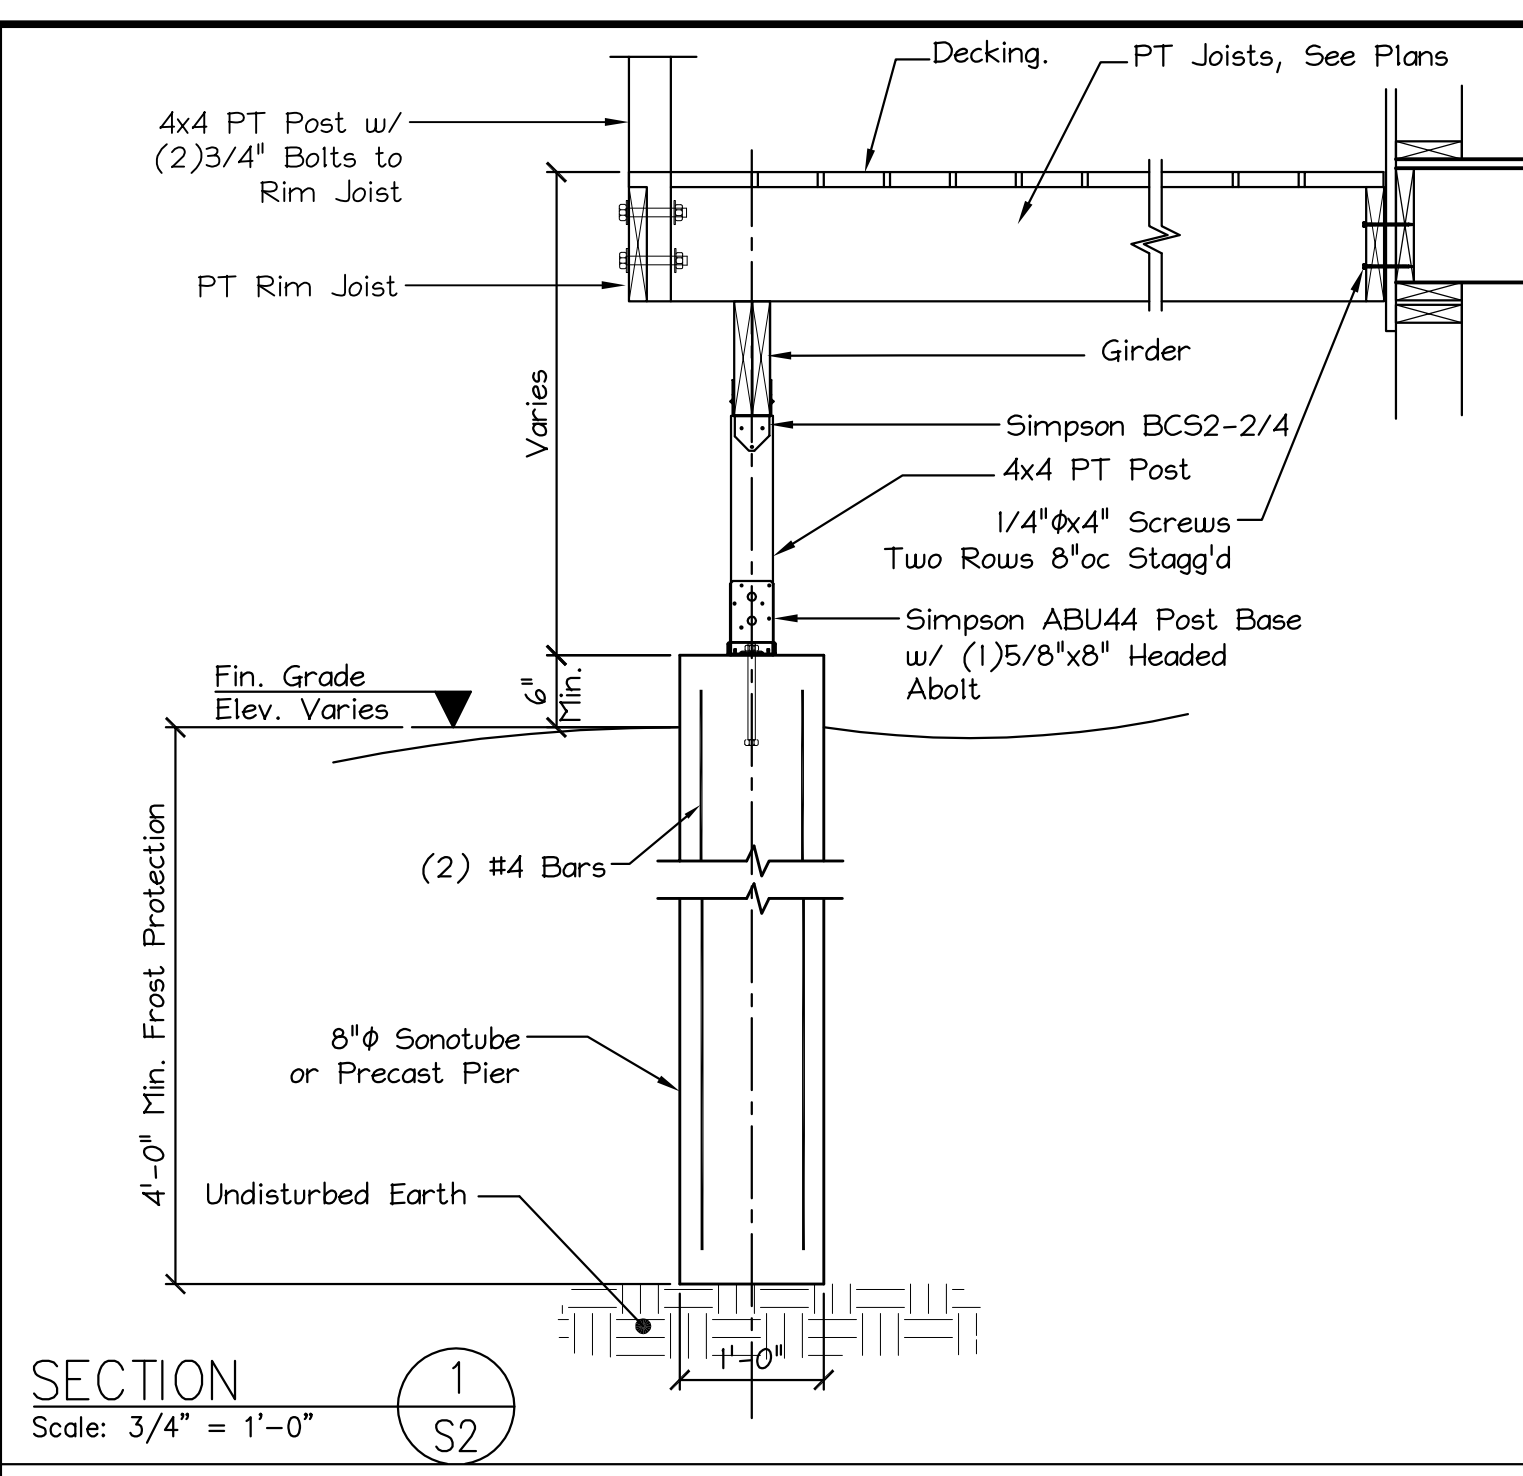
ROOF FRAMING PLAN  
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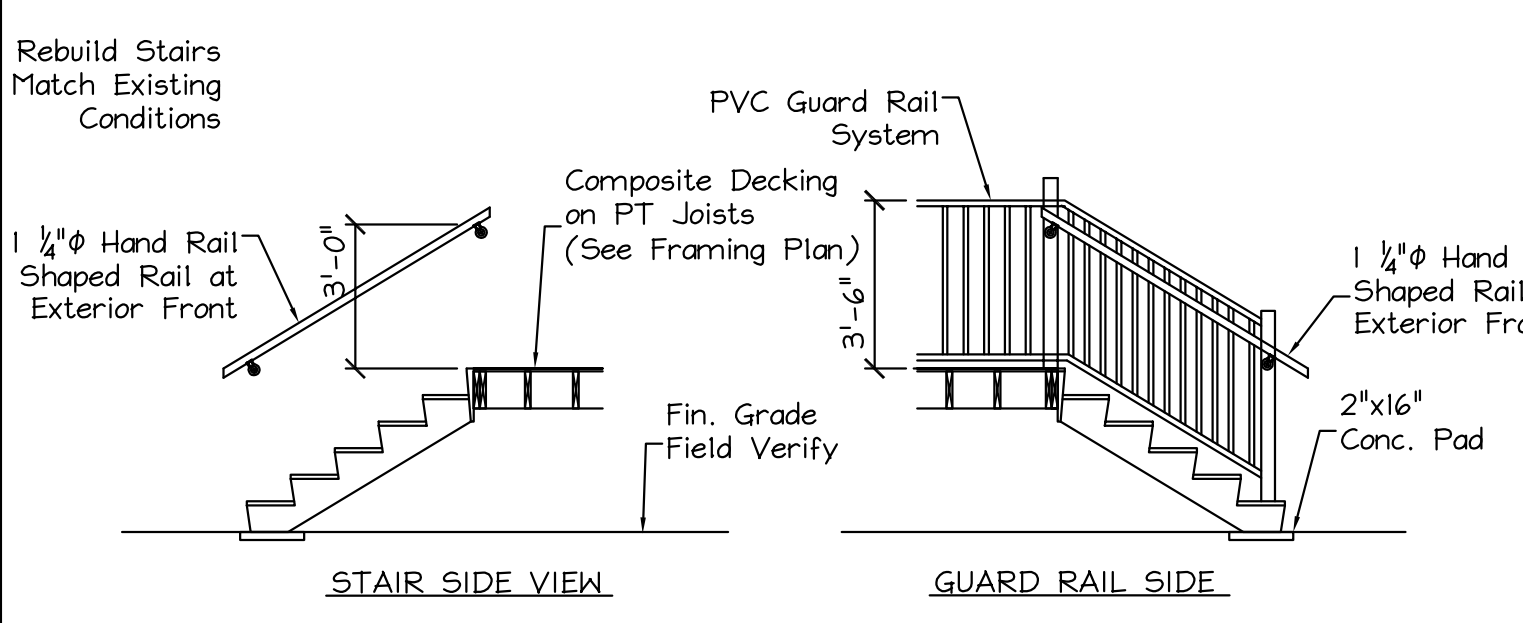


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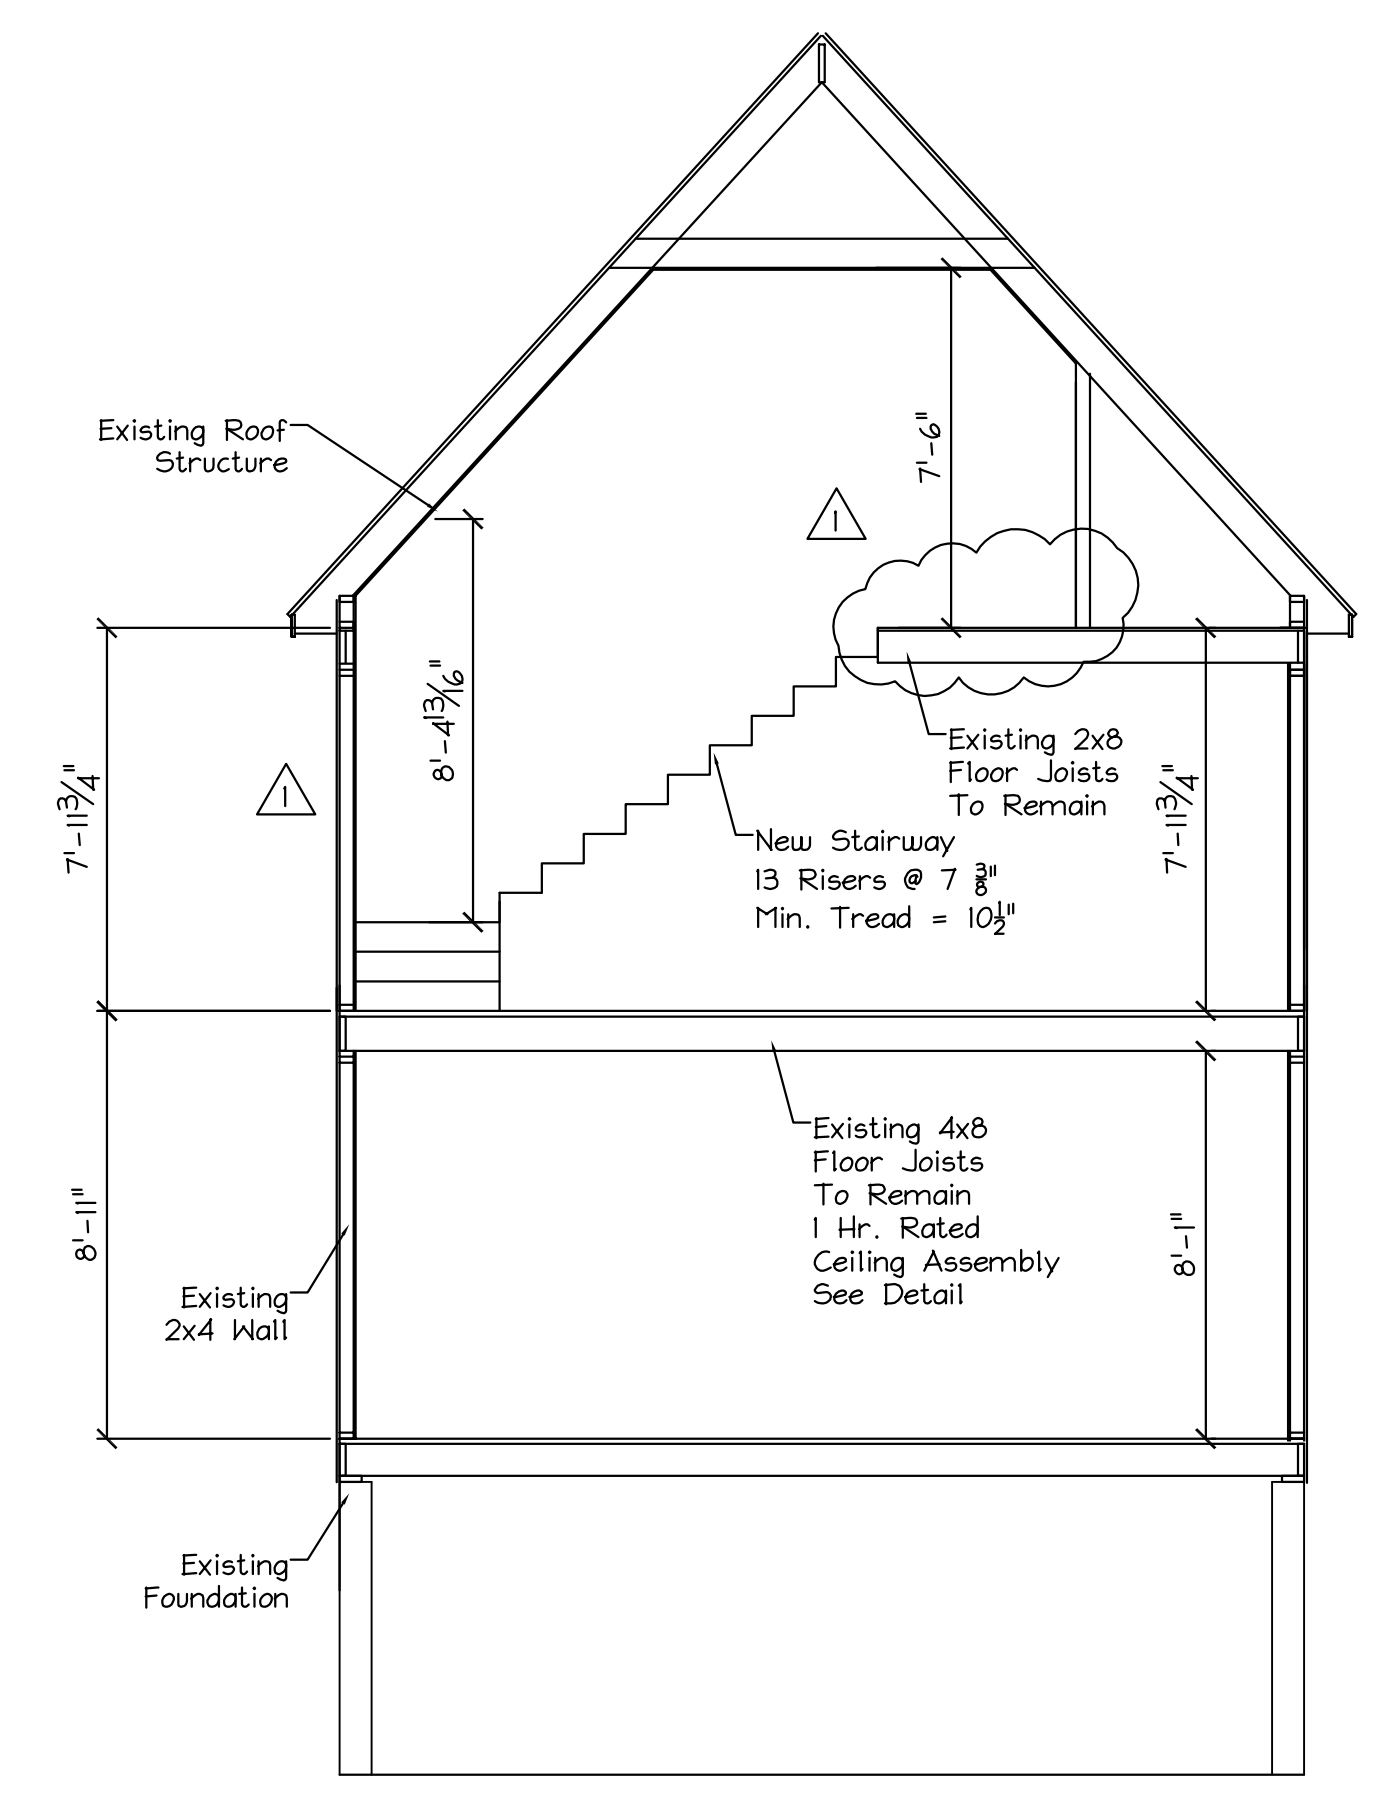
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| MACLEOD<br>STRUCTURAL ENGINEERS, PA<br>80 Bridge Street Suite 232<br>Westbrook, Maine 04092 207.639.0980 |                   |                     |
| 36 Spruce St.<br>Portland, Maine   |                   |                     |
| TITLE: FRAMING PLANS   |                   |                     |
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| SCALE: as noted  | PROJ NO: 2018-063 |                     |



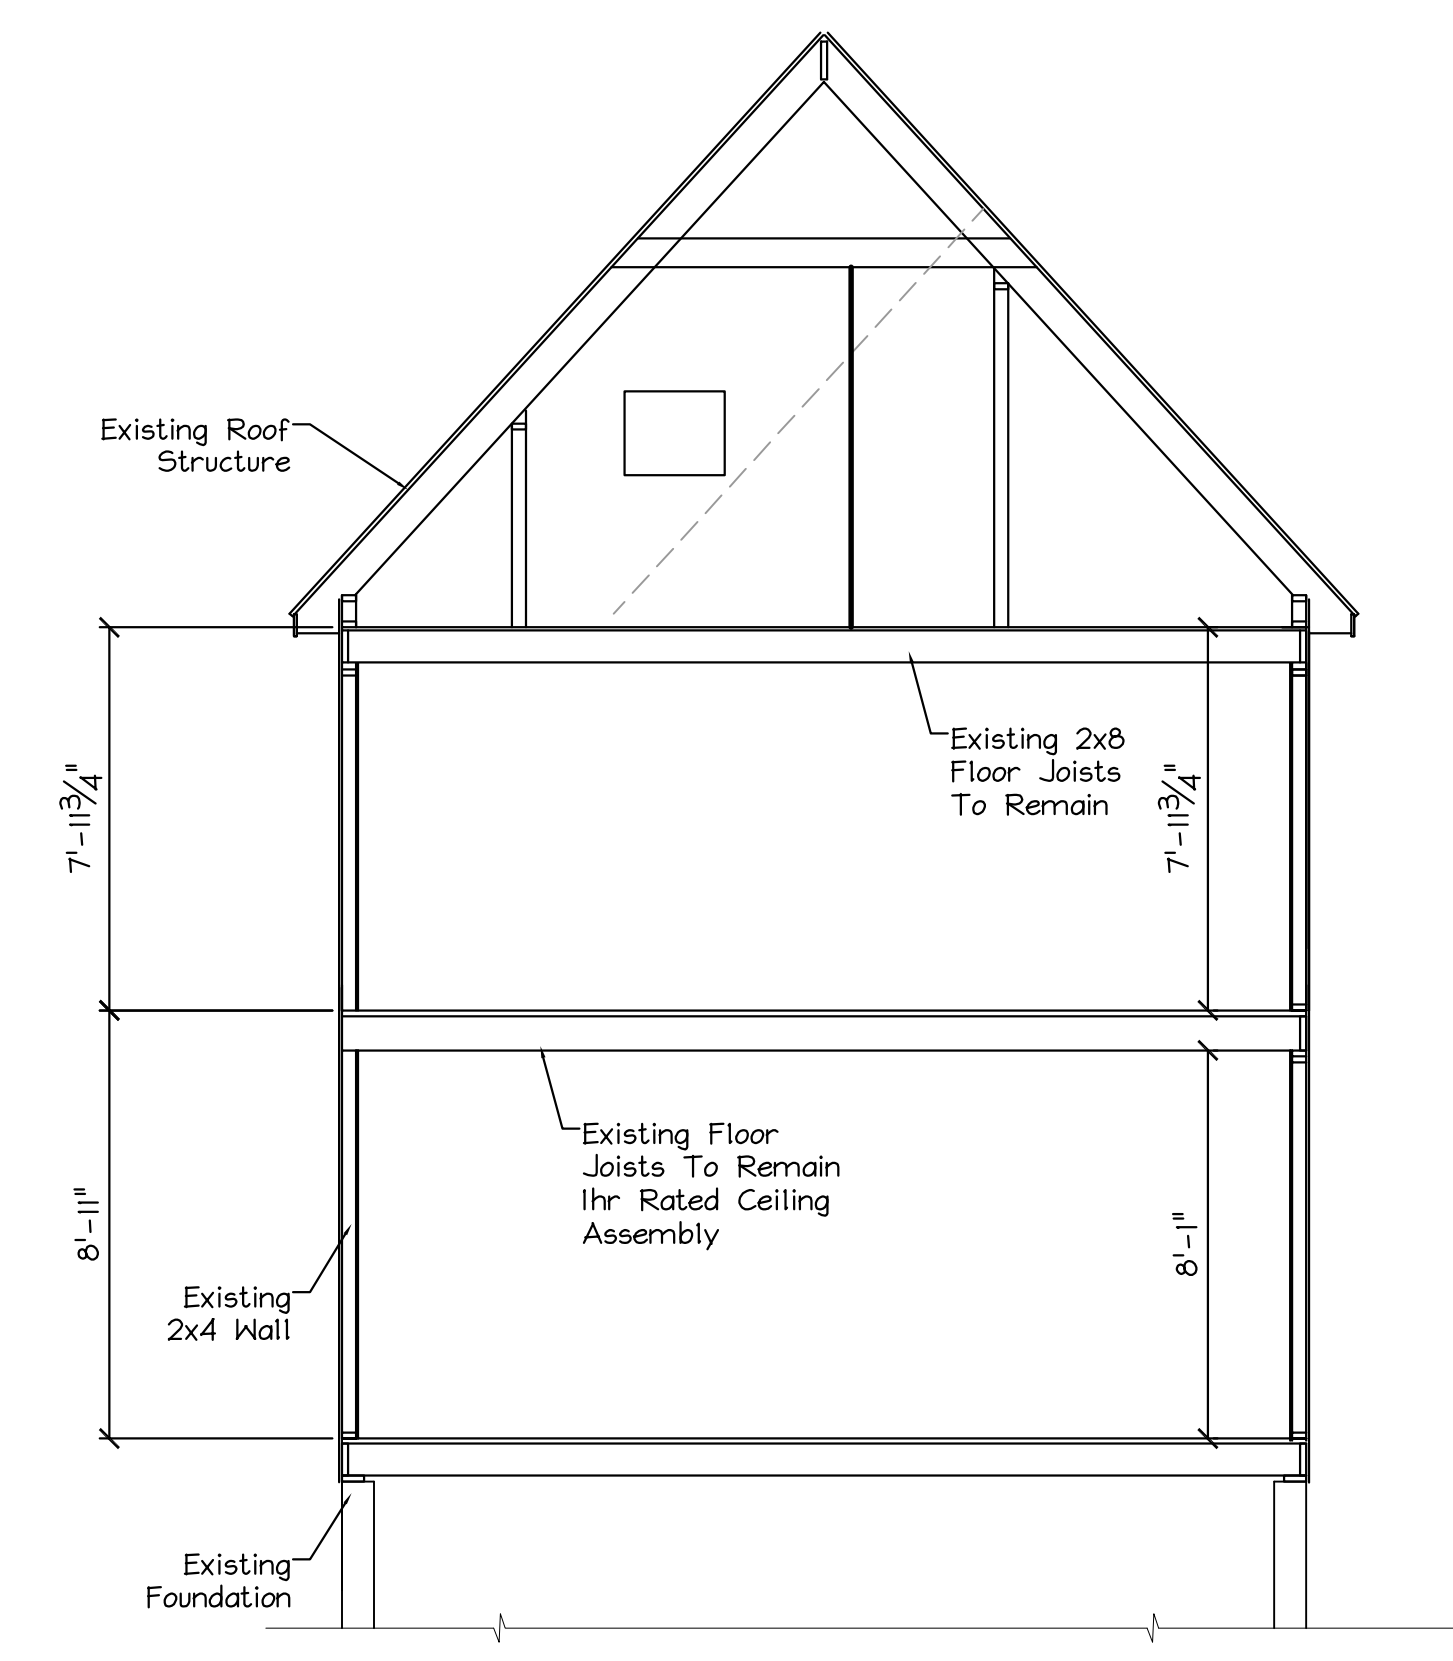
SECTION 1  
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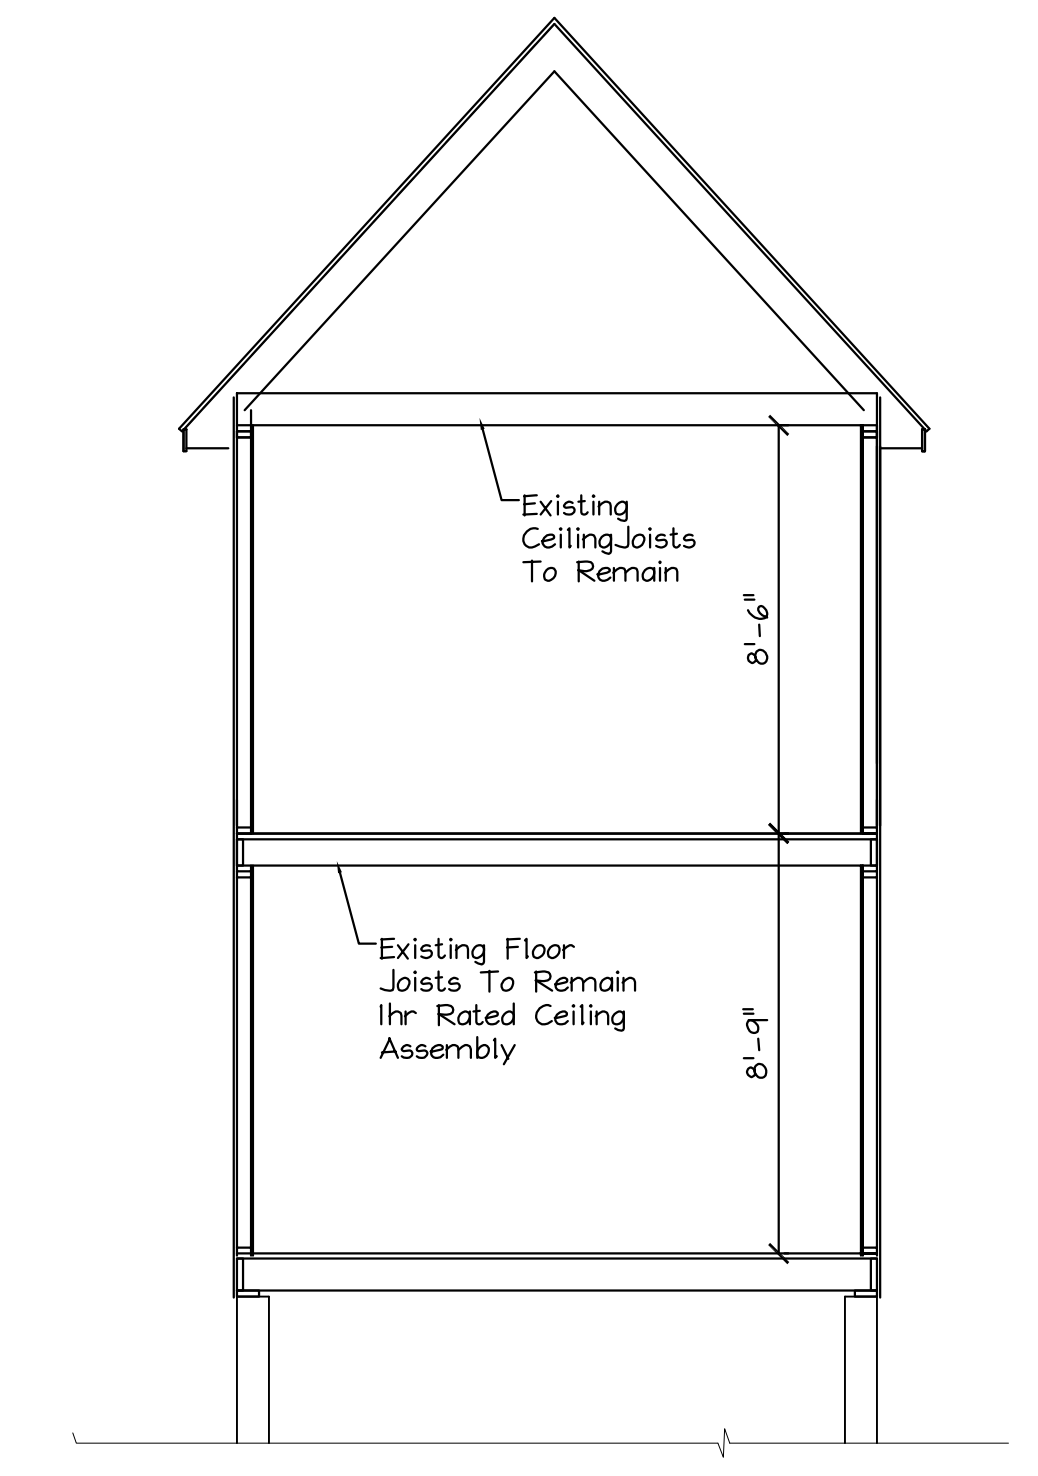
DETAIL 2 TYPICAL RAILING AND EXTERIOR STAIRS  
Scale: 1/4" = 1'-0" WHERE APPLICABLE




CROSS SECTION A  
Scale: 1/4" = 1'-0"



CROSS SECTION B  
Scale: 1/4" = 1'-0"



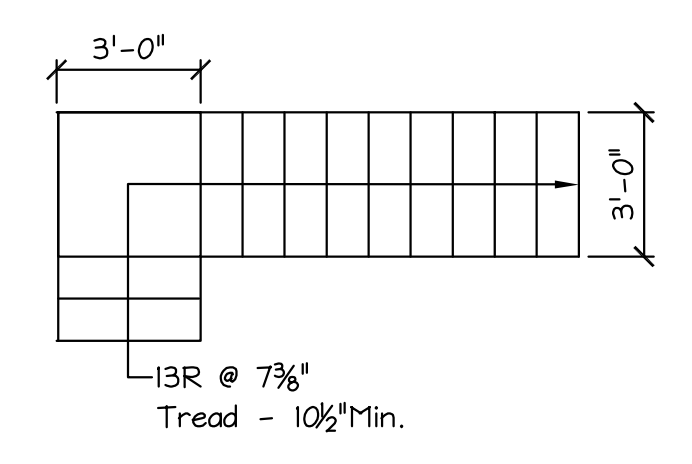
CROSS SECTION C  
Scale: 1/4" = 1'-0"



NEW STAIR PLAN  
Scale: 1/4" = 1'-0"
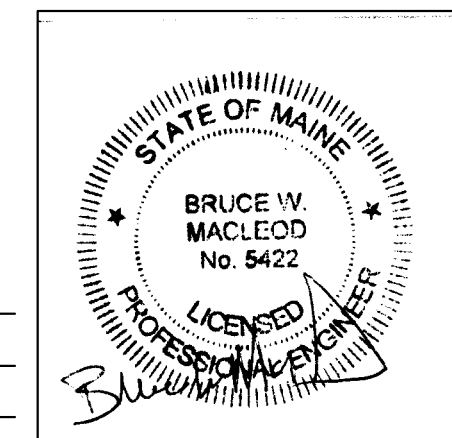
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|--|-------------------|---------------------|
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| 36 Spruce St.<br>Portland, Maine   |                   |                     |
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