

## PROJECT DIRECTORY

### **OWNER:**

GEBHARDT

## DESIGN PROFESSIONAL:

MACLEOD STRUCTURAL ENGINEERS, PA 90 BRIDGE STREET WESTBROOK, MAINE 04092 TEL. 207-839-0980

# GENERAL CONTRACTOR:

TBD

## PROJECT DESCRIPTION:

THIS PROJECT CONSISTS OF -I. UPDATING/RENOVATING INTERIOR SPACES 3. INSTALLING NEW ROOFING, SIDING 4. THE FOOTPRINT AND VOLUME OF THE BUILDING IS UNCHANGED 5. EXISTING COMPONENTS TO REMAIN EXCEPT AS NOTED HEREIN 6. EXISTING STRUCTURAL ELEMENTS TO REMAIN EXCEPT AS NOTED HEREIN 7. ALL NEW ELECTRICAL, PLUMBING \$ HEATING SYSTEMS THROUGHOUT

#### GENERAL NOTES:

- I. THIS PLAN IS DESIGNED TO COMPLY WITH MAINE BUILDING
- AND ENERGY CODE, 2015 IRC, AND 2015 IECC 2. ALL OTHER CODES SHALL BE THE RESPONSIBILITY OF THE OWNER/CONTRACTOR
- 3. ALL MECHANICAL/PLUMBING/ELEVATRICAL DESIGN BY OTHERS
- 4. CONTRACTOR SHALL VERIFY ALL DIMENSIONS PRIOR TO BEGINNING WORK

#### ENERGY CODE STANDARDS: ZONE 6

- FENESTRATIONS -Windows u-0.35, shq-0.38
- -Doors u-0.25 11
- -R49 (R30 at Sloping Ceiling Areas) ROOF EXTERIOR WALLS -Fill Voids at Existing
- 4. BASEMENT CONC. WALLS (Exist to Remain)

#### ENERGY CODE NOTES:

- I. ALL JOINTS AND PENETRATIONS SHALL BE CAULKED, GASKETED, OR COVERED WITH MOISTURE VAPOR-PERMEABLE WRAPPING MATERIAL
- 2. COMPONENT R-VALUES & U-FACTORS SHALL BE LABELED AS CERTIFIED.
- 3. INSULATION SHALL BE INSTALLED ACCORDING TO MFRS. INSTRUCTIONS, AND IN A MANNER THAT ACHIEVES THE REQ'D R-VALUE
- 4. STAIR, ELEVATOR SHAFT VENTS, AND OTHER OUTDOOR INTAKE AND EXHAUST OPENINGS SHALL BE EQUIPPED WITH MOTORIZED DAMPERS.
- 5. RECESSED LIGHTING FIXTURES INSTALLED IN THE BUILDING ENVELOPE SHALL BE TRYPE IC RATED AS MEETING ASTM E283, AND SEALED OR CAULKED.

#### CODE REVIEW NFPA 101

- Chapter 24 One and Two Family Dwellings
- 24.2 Means of Egress One primary means of egress and one secondary means of escape is required from every sleeping room and every living area. This design meets this requirement 24.2.5 Stairs - min. width =36in,
- 24.2.6 Hallways min. width 36in
- 24.2.7 Bulkheads shall provide direct access to the basement, are exempt from requirements of 24.2.5.1 24.3.4.1 Smoke alarms shall be provided in each sleeping room,
- outside each separate sleeping area in the immediate vicinity, and on each additional level including attic and basement, and shall be interconnect per this code 24.3.5.2 Sprinkler system is required per NFPA I3D (Verify w/ Local Ordinance

<u>Two Family Residence Code Review</u> 36 Spruce Street Portland, Maine

CODE REVIEM: IRC2015

SECT 301 DESIGN CRITERIA Design Wind speed = 120mph, therefore design per IRC Design Snow, Pg= 60psf, therefore design per IRC Design Floor Live Load = 40 psf

SECT 302 FIRE RESISTANT CONSTRUCTION R302.1 Exterior Walls shall comply with Table R302.1 Not within 5ft of property line. R302.7 Under stair protection is required for accessible spaces below stairs R302.9 Wall and ceiling finishes shall meet flame spread <200 and smoke index <450. R302.10 Insulation materials including vapor barriers shall meet flame spread <25 and smoke index <450 except as otherwise provided in this section R302.11 Fireblocking is required at floors and ceilings, top and bottom of stair runs, and openings at vents, pipes, ducts, cables and wires with materials approved in this code R302.12 Draftstoping at floor/ceilings is not required for this project R302.13 Underside of Floors Shall be Protected Unless Joists are min. 2x10 per this section R303 LIGHT VENTILAITION AND HEATING R303.1 Habitable rooms shall have glazing >8 % of floor area, with 4% openable R303.3 Bathrooms, min. glazing area of 3 sq, ft. with half openable R303.7 Stairways shall have artificial illumination per this section R303.8 Exterior Stairways shall have artificial illumination per this section R303.10 Heating shall be provided per the requirements of this code

R304 MINIMUM ROOM AREA requirements have been met in these plans R305 CEILING HEIGHT min. of 7ft has been met R306 SANITATION requirements have been met R307 TOILET, BATH AND SHOWER SPACES comply with this section R308 GLAZING shall comply with the requirements of this section R310 EMERGENCY ESCAPE is required from the basement and sleeping rooms - Complies. R311 MEANS OF EGRESS each unit in these plans has one egress in compliance with this section R311.6 Hallways are > 36 in. wide R311.7 Stairways, handrails, rise and run, nosings, headroom, etc are in compliance with this code refer to stairway sections and details within (these are existing) R313 AUTOMATIC SPRINKLER SYSTEMS R313.2, new two family dwellings shall have an automatic sprinkler system complying with NFPAI3D R314 SMOKE ALARMS shall be provided in each sleeping room, outside each separate sleeping area in the immediate vicinity, and on each additional level including attic and basement, and shall be interconnect per this code

CHAPTER 6 WALL CONSTRUCTION 602.10.1 Braced Wall Panels Mixed wall types are used First Floor Walls are Existing

#### RESIDENTIAL SPECIFICATIONS:

FLOOR SYSTEM: EXISTING EXTERIOR WALLS: 2x Studs as Indicated (16"oc) Exist. Sheathing - Exist. Air Infiltration Wrap Siding/Finish as Indicated

INTERIOR WALLS: 2x4 Studs @ 16"oc (exist. to remain) <sup>1</sup>/<sub>2</sub>" Gypboard as Indicated

ROOF SYSTEM: Rafters-Exist. to remain Sheathing - Existing 15# Underlayment Ice & Water Shield at Eaves/Valleys 235# Asphalt Shingles as Indicated


INSULATION: See Energy Code Notes Herein


VENTILATION: Soffit - 2"Contin. Strip Ridges - Contin. Shingle Circulation Vents Between Rafters/Trusses


BEAMS/HEADERS: (3)2x6 Max. 40" Span (3)2x10s Max 76" Span Min. 4" Bearing all Beams

INTERIOR FINISHES: <sup>1</sup>/<sub>2</sub> Gypboard or As Indicated At Walls/Ceilings Flooring As Indicated Paint/Stain As Indicated

Note: Items not Indicated Shall be Per Contract

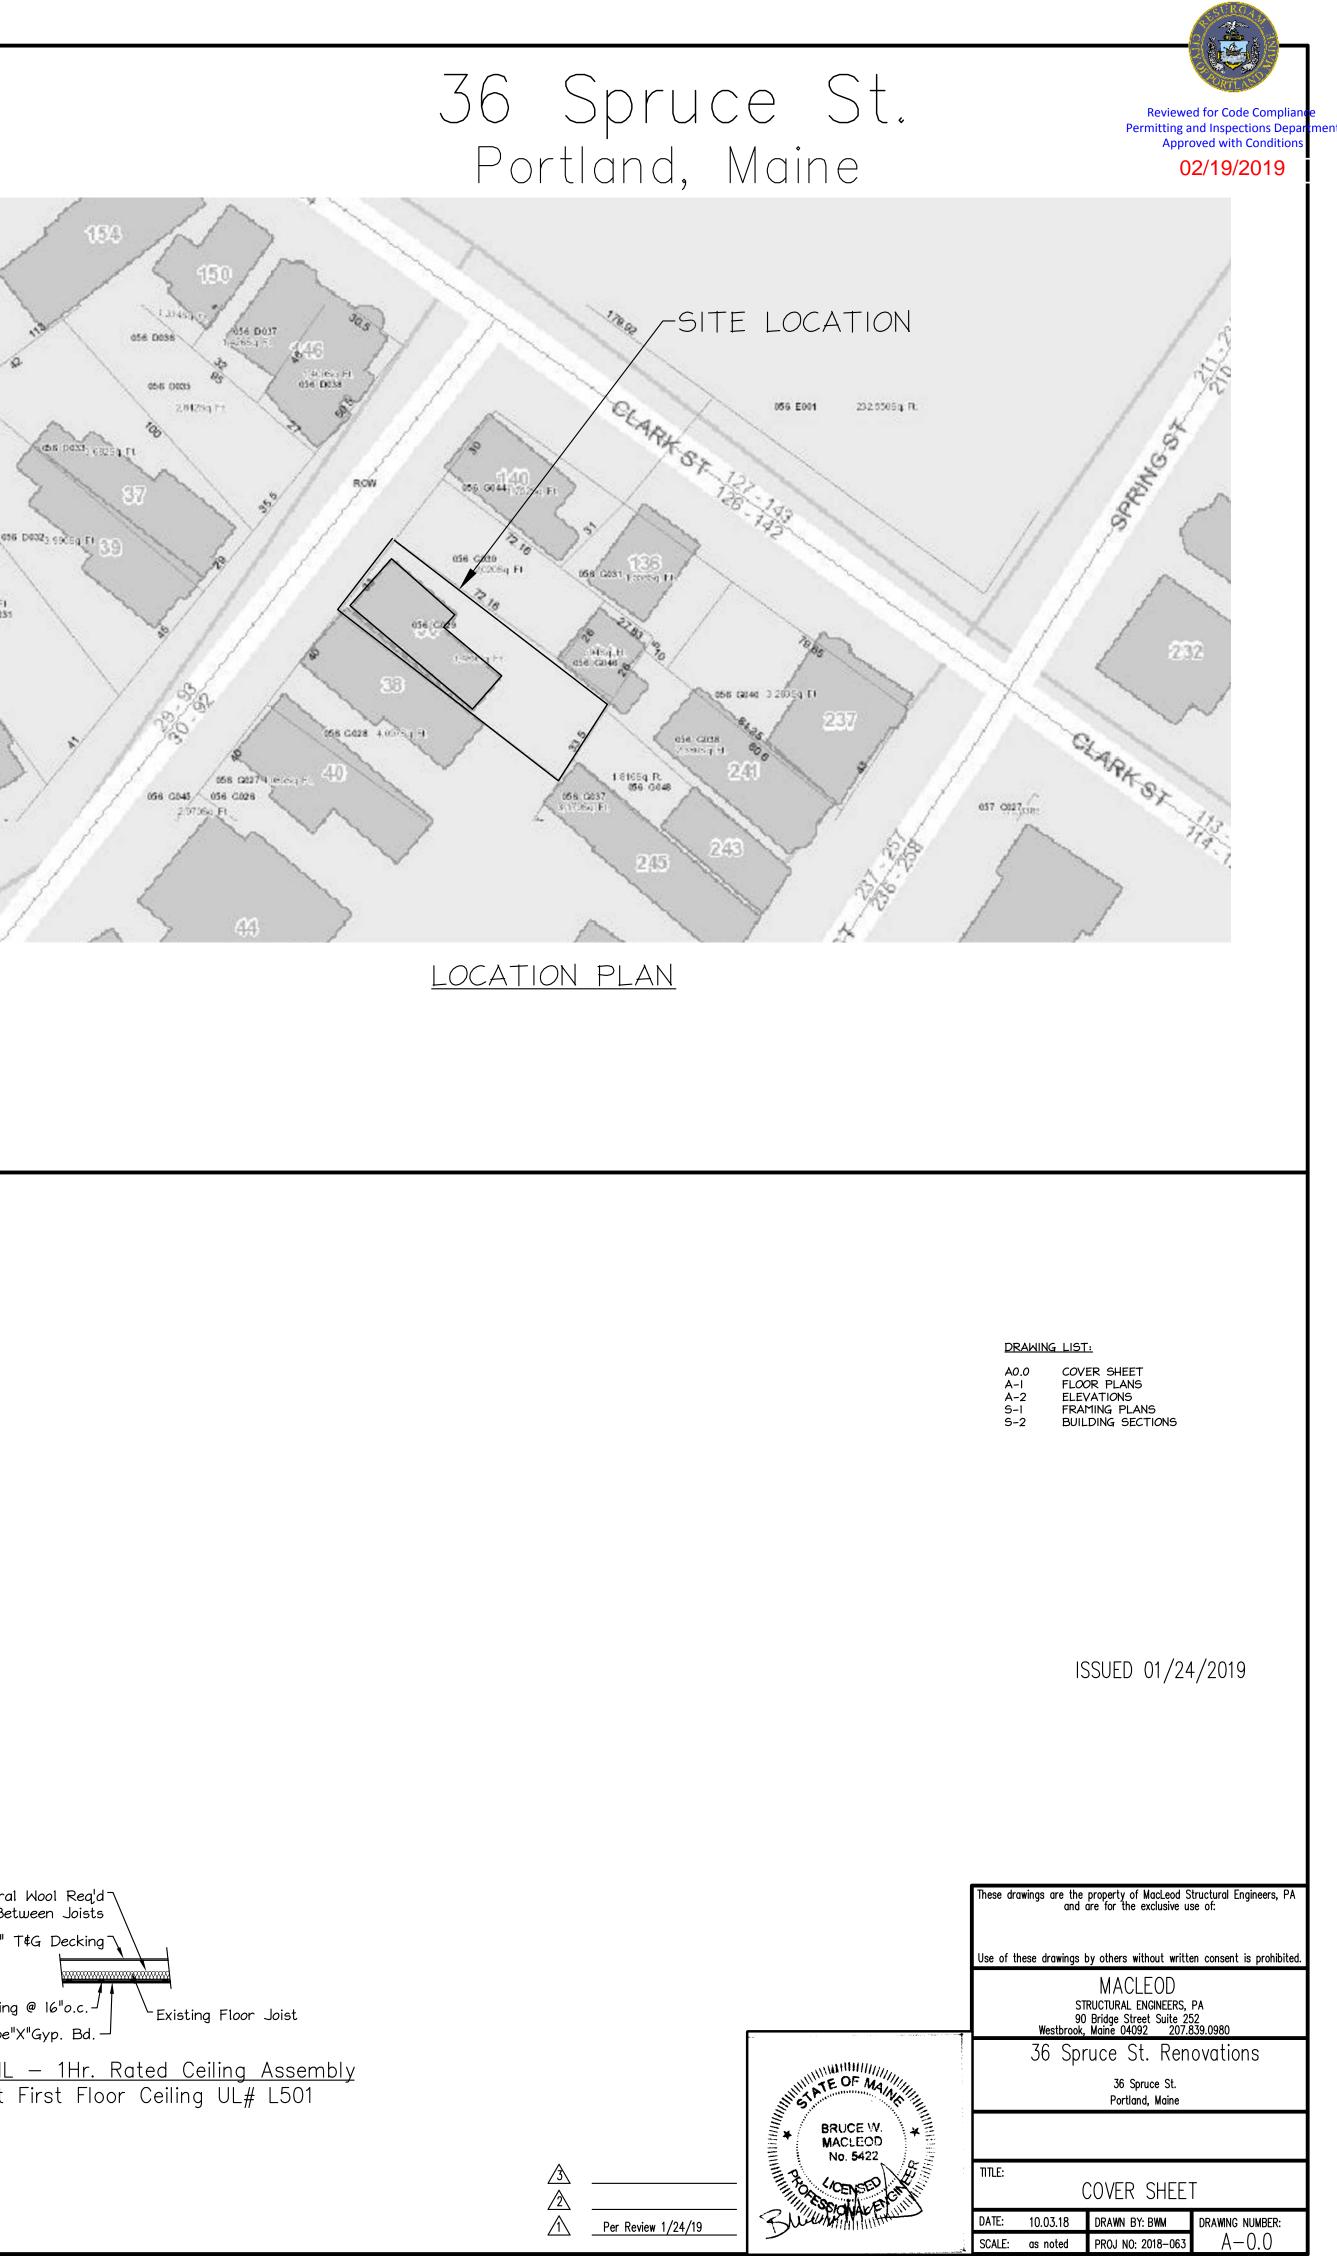


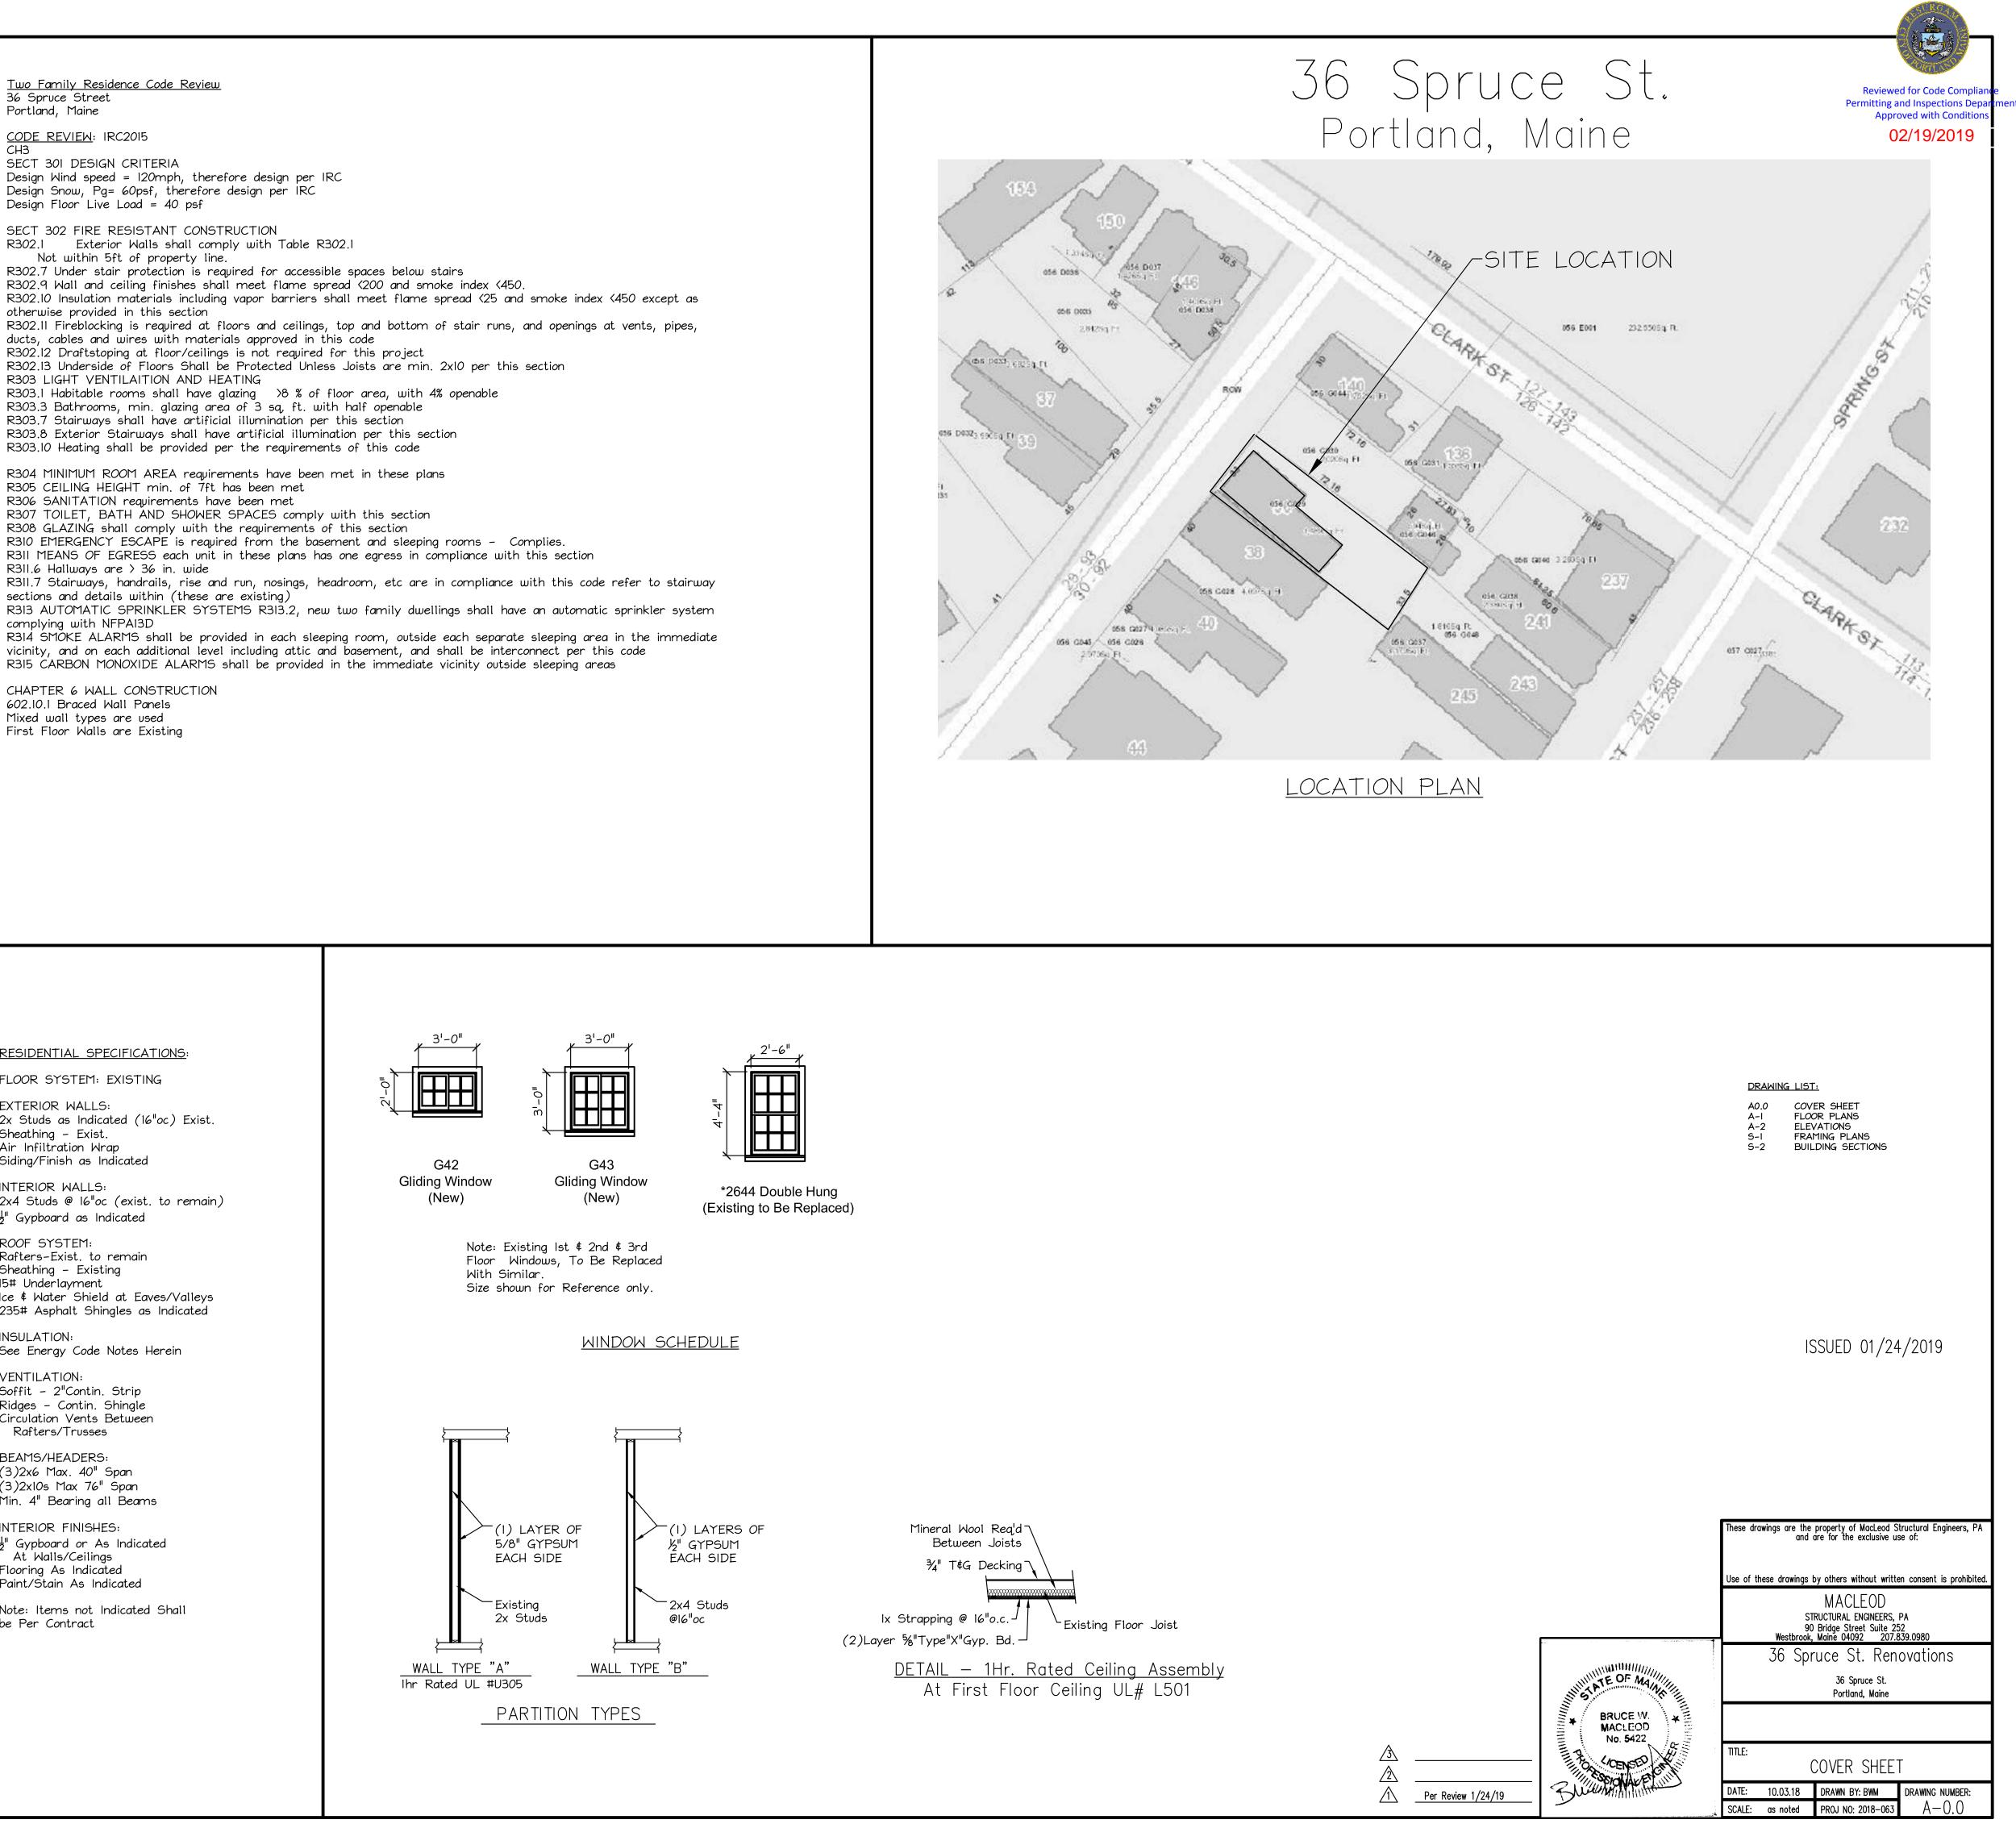

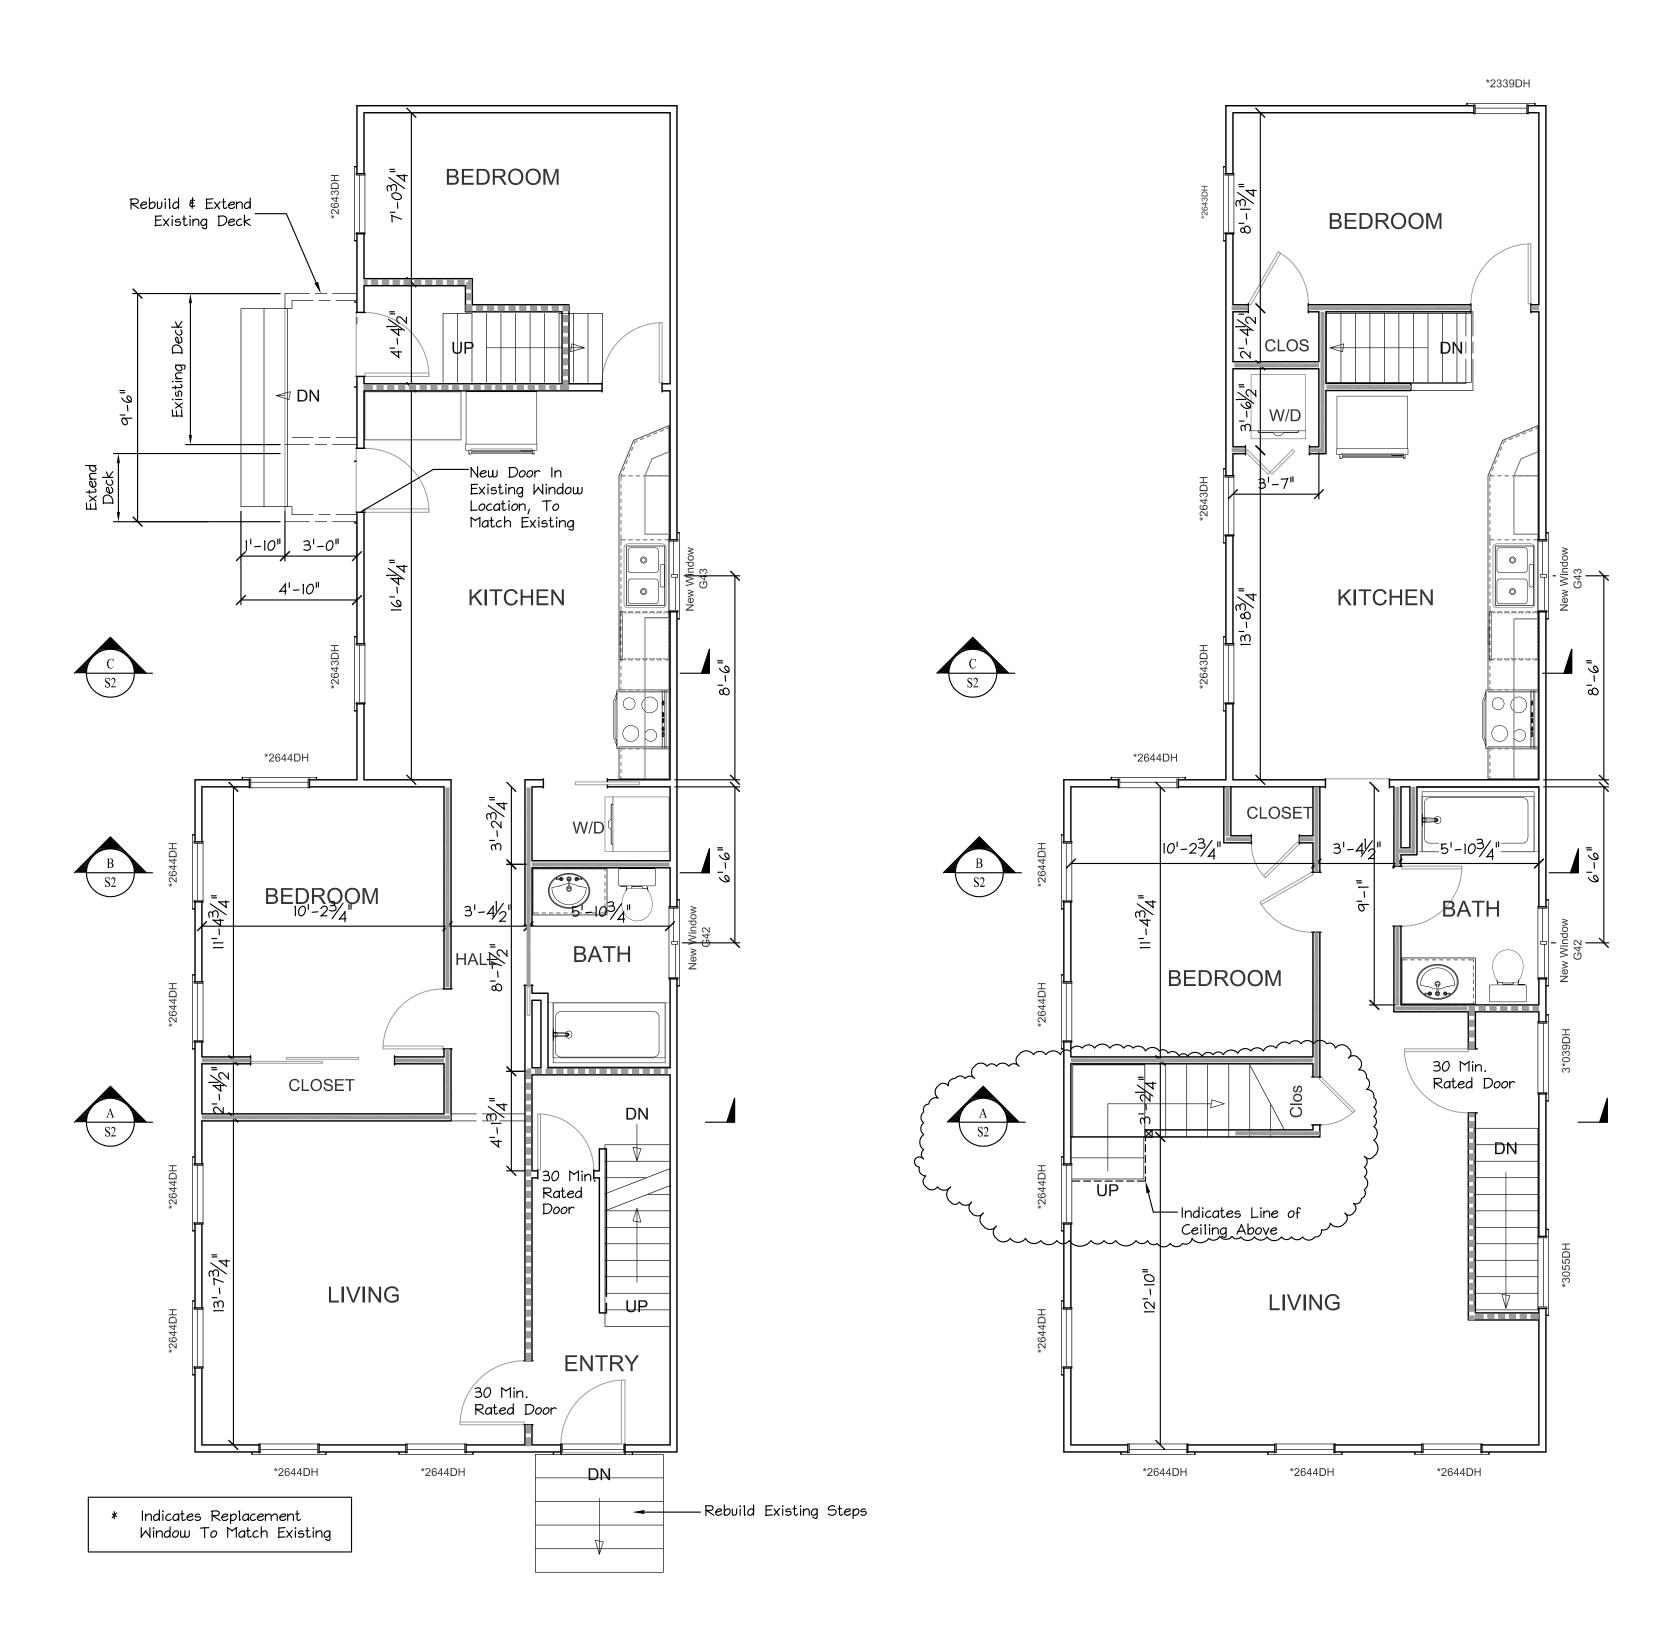

Existing Wall, Type A Ihr Rated UL#U305 New Wall, Type B Existing Wall to Remain

 $\frac{\text{FIRST FLOOR PLAN}}{\text{Scale: 1/4"} = 1'-0"}$ 

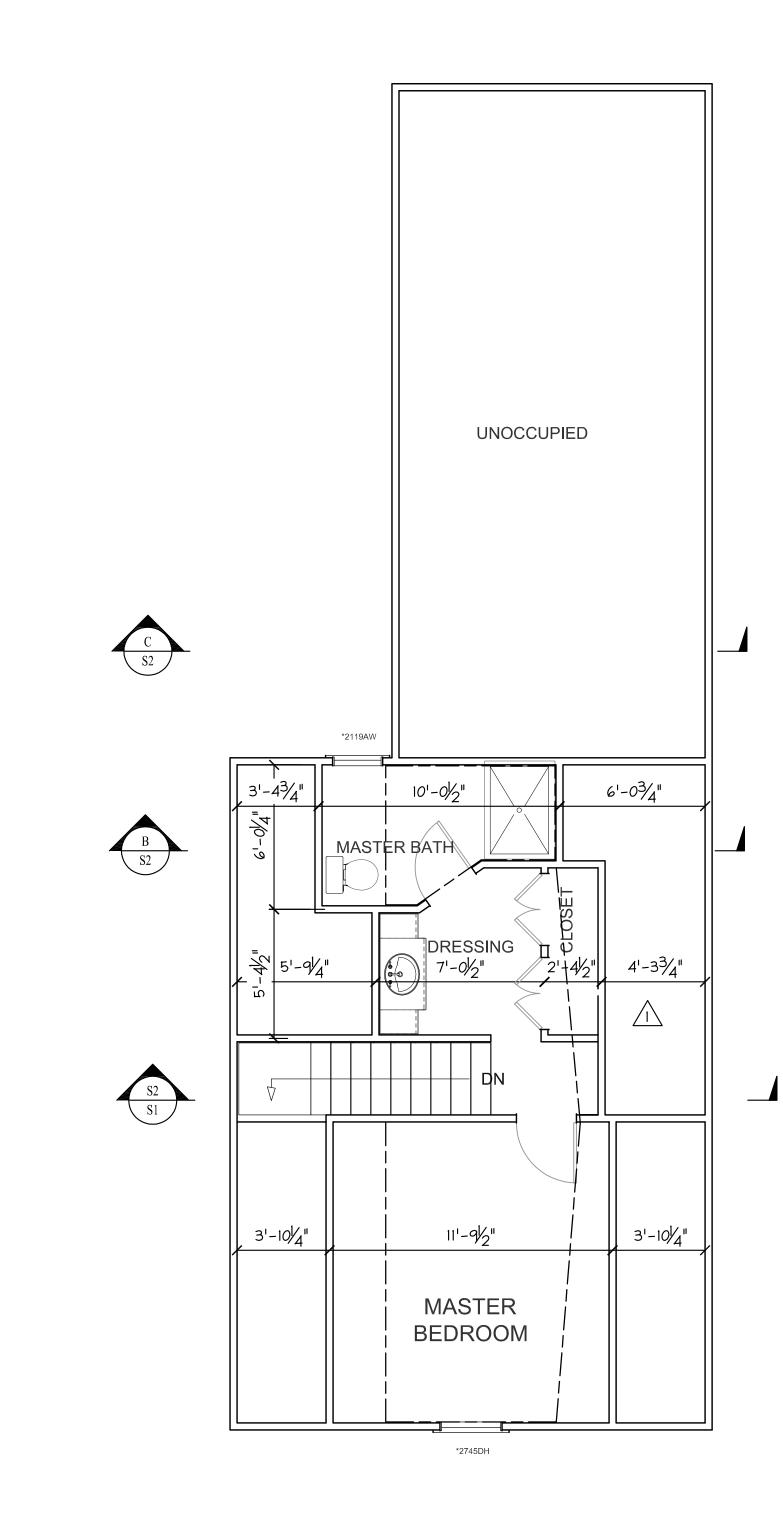


 $\frac{\text{SECOND FLOOR PLAN}}{\text{Scale: 1/4"} = 1'-0"}$ 

THIRD FLOOR PLAN Scale: 1/4" = 1'-0"



ISSUED 02/14/2019

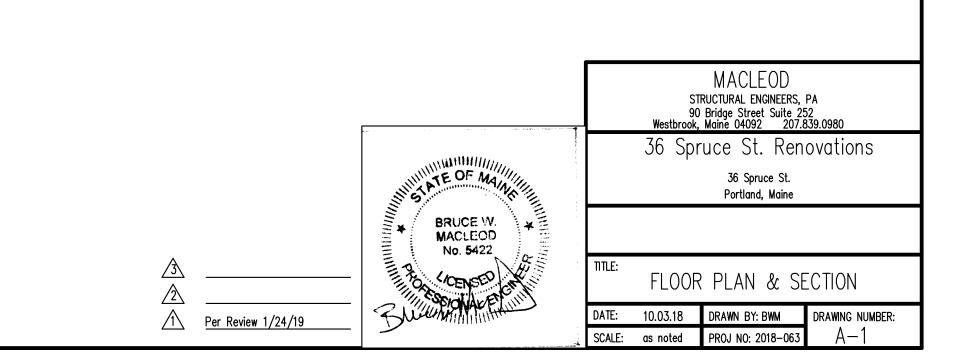



02/19/2019

Paint: Sherwin Williams Woodscapes White Solid

-New Replacement


Re-construct Front Steps: Painted White, Treads to be Stained wood, 6" Newel Posts w/ Pyramid Tops, Shaped Railings @ 36"ht Stairs and Landing to be


Fence Not

Shown for

Clarity


ISSUED 01/24/2019

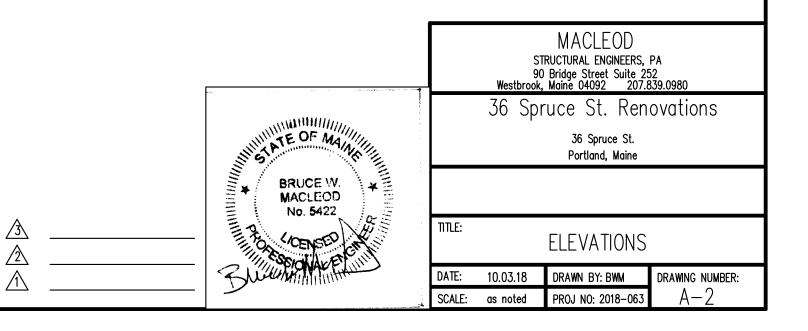

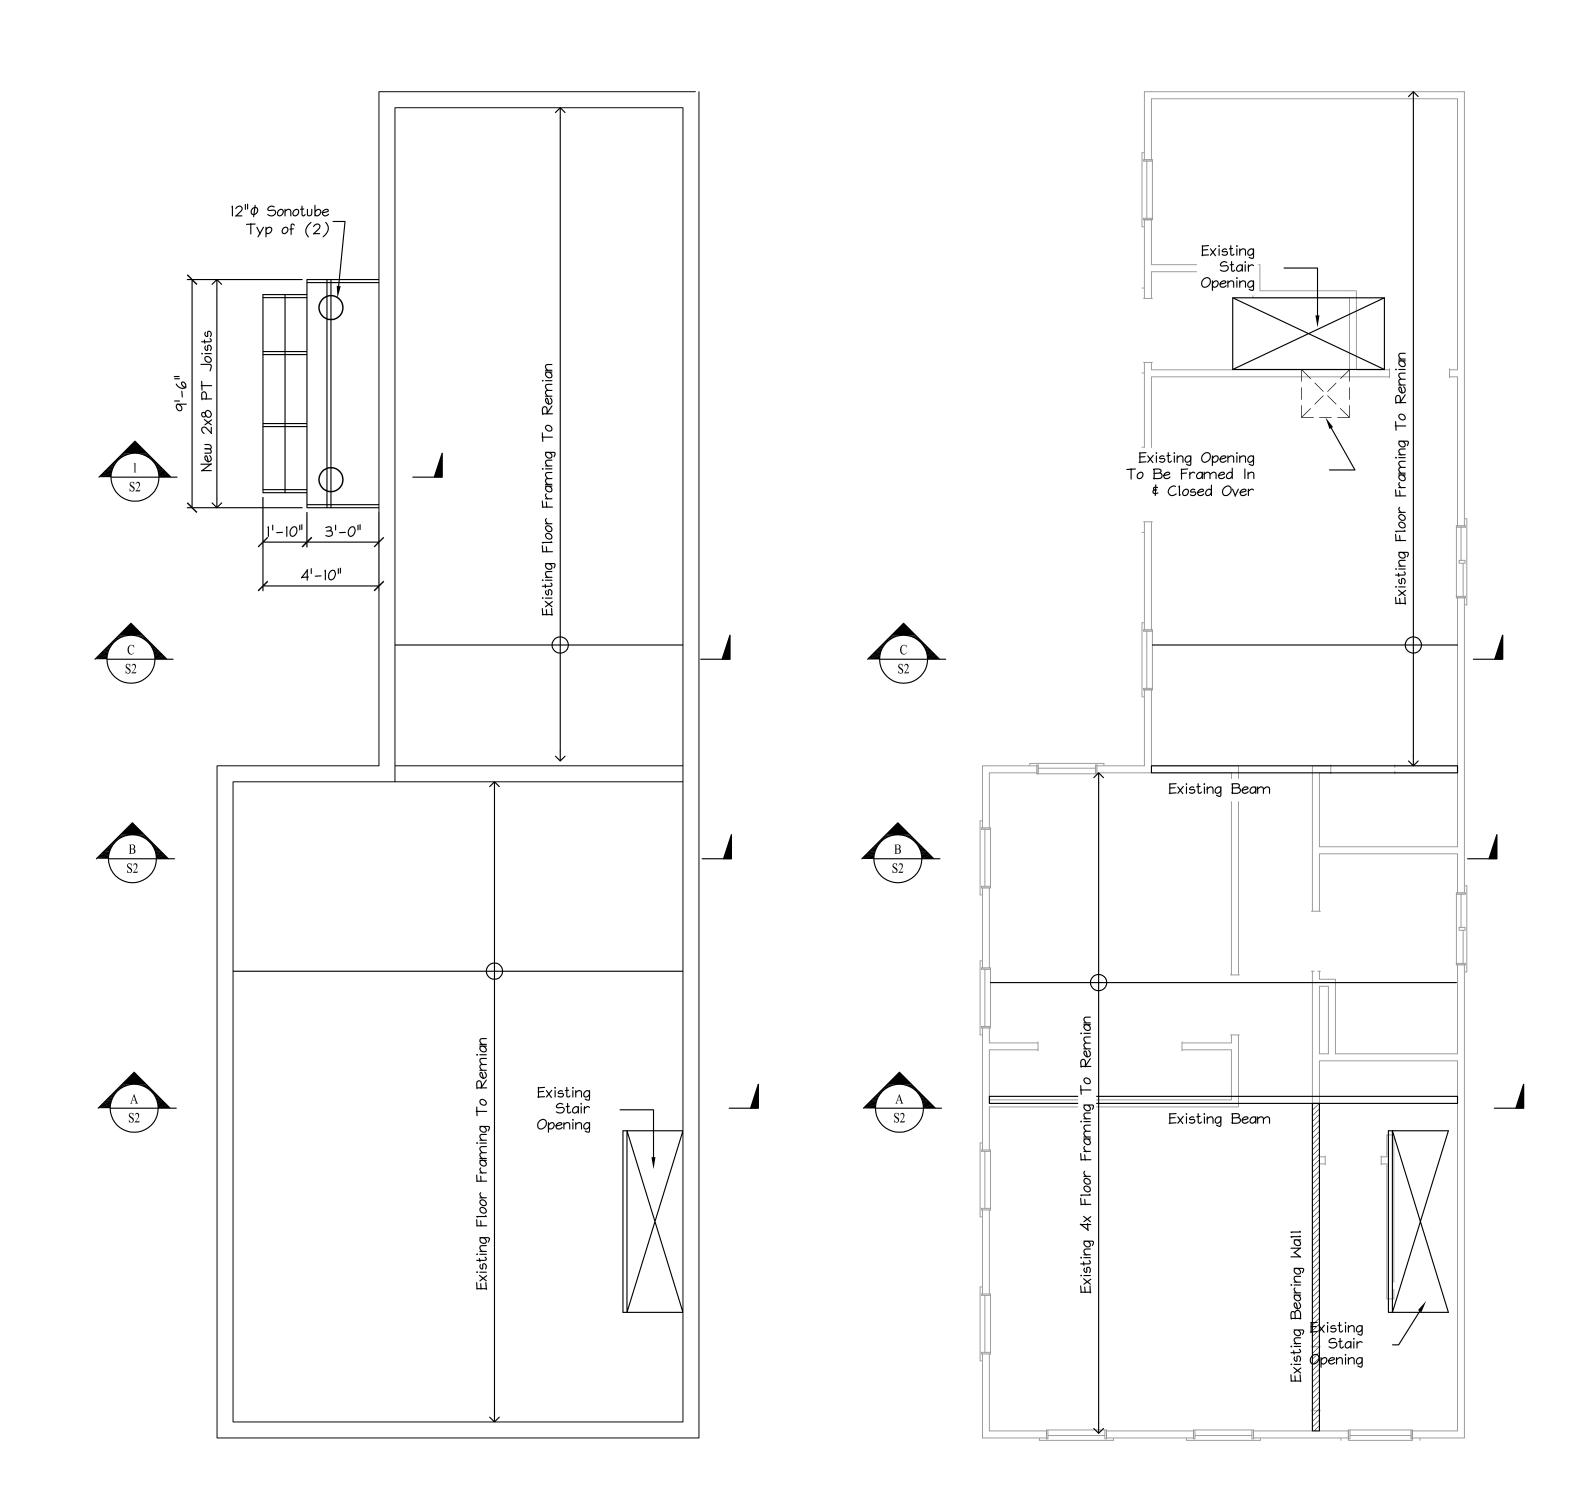


<u>FIRST FLOOR FRAMING PLAN</u> Scale: 1/4" = 1'-0"


<u>SECOND FLOOR FRAMING PLAN</u> Scale: 1/4" = 1'-0"

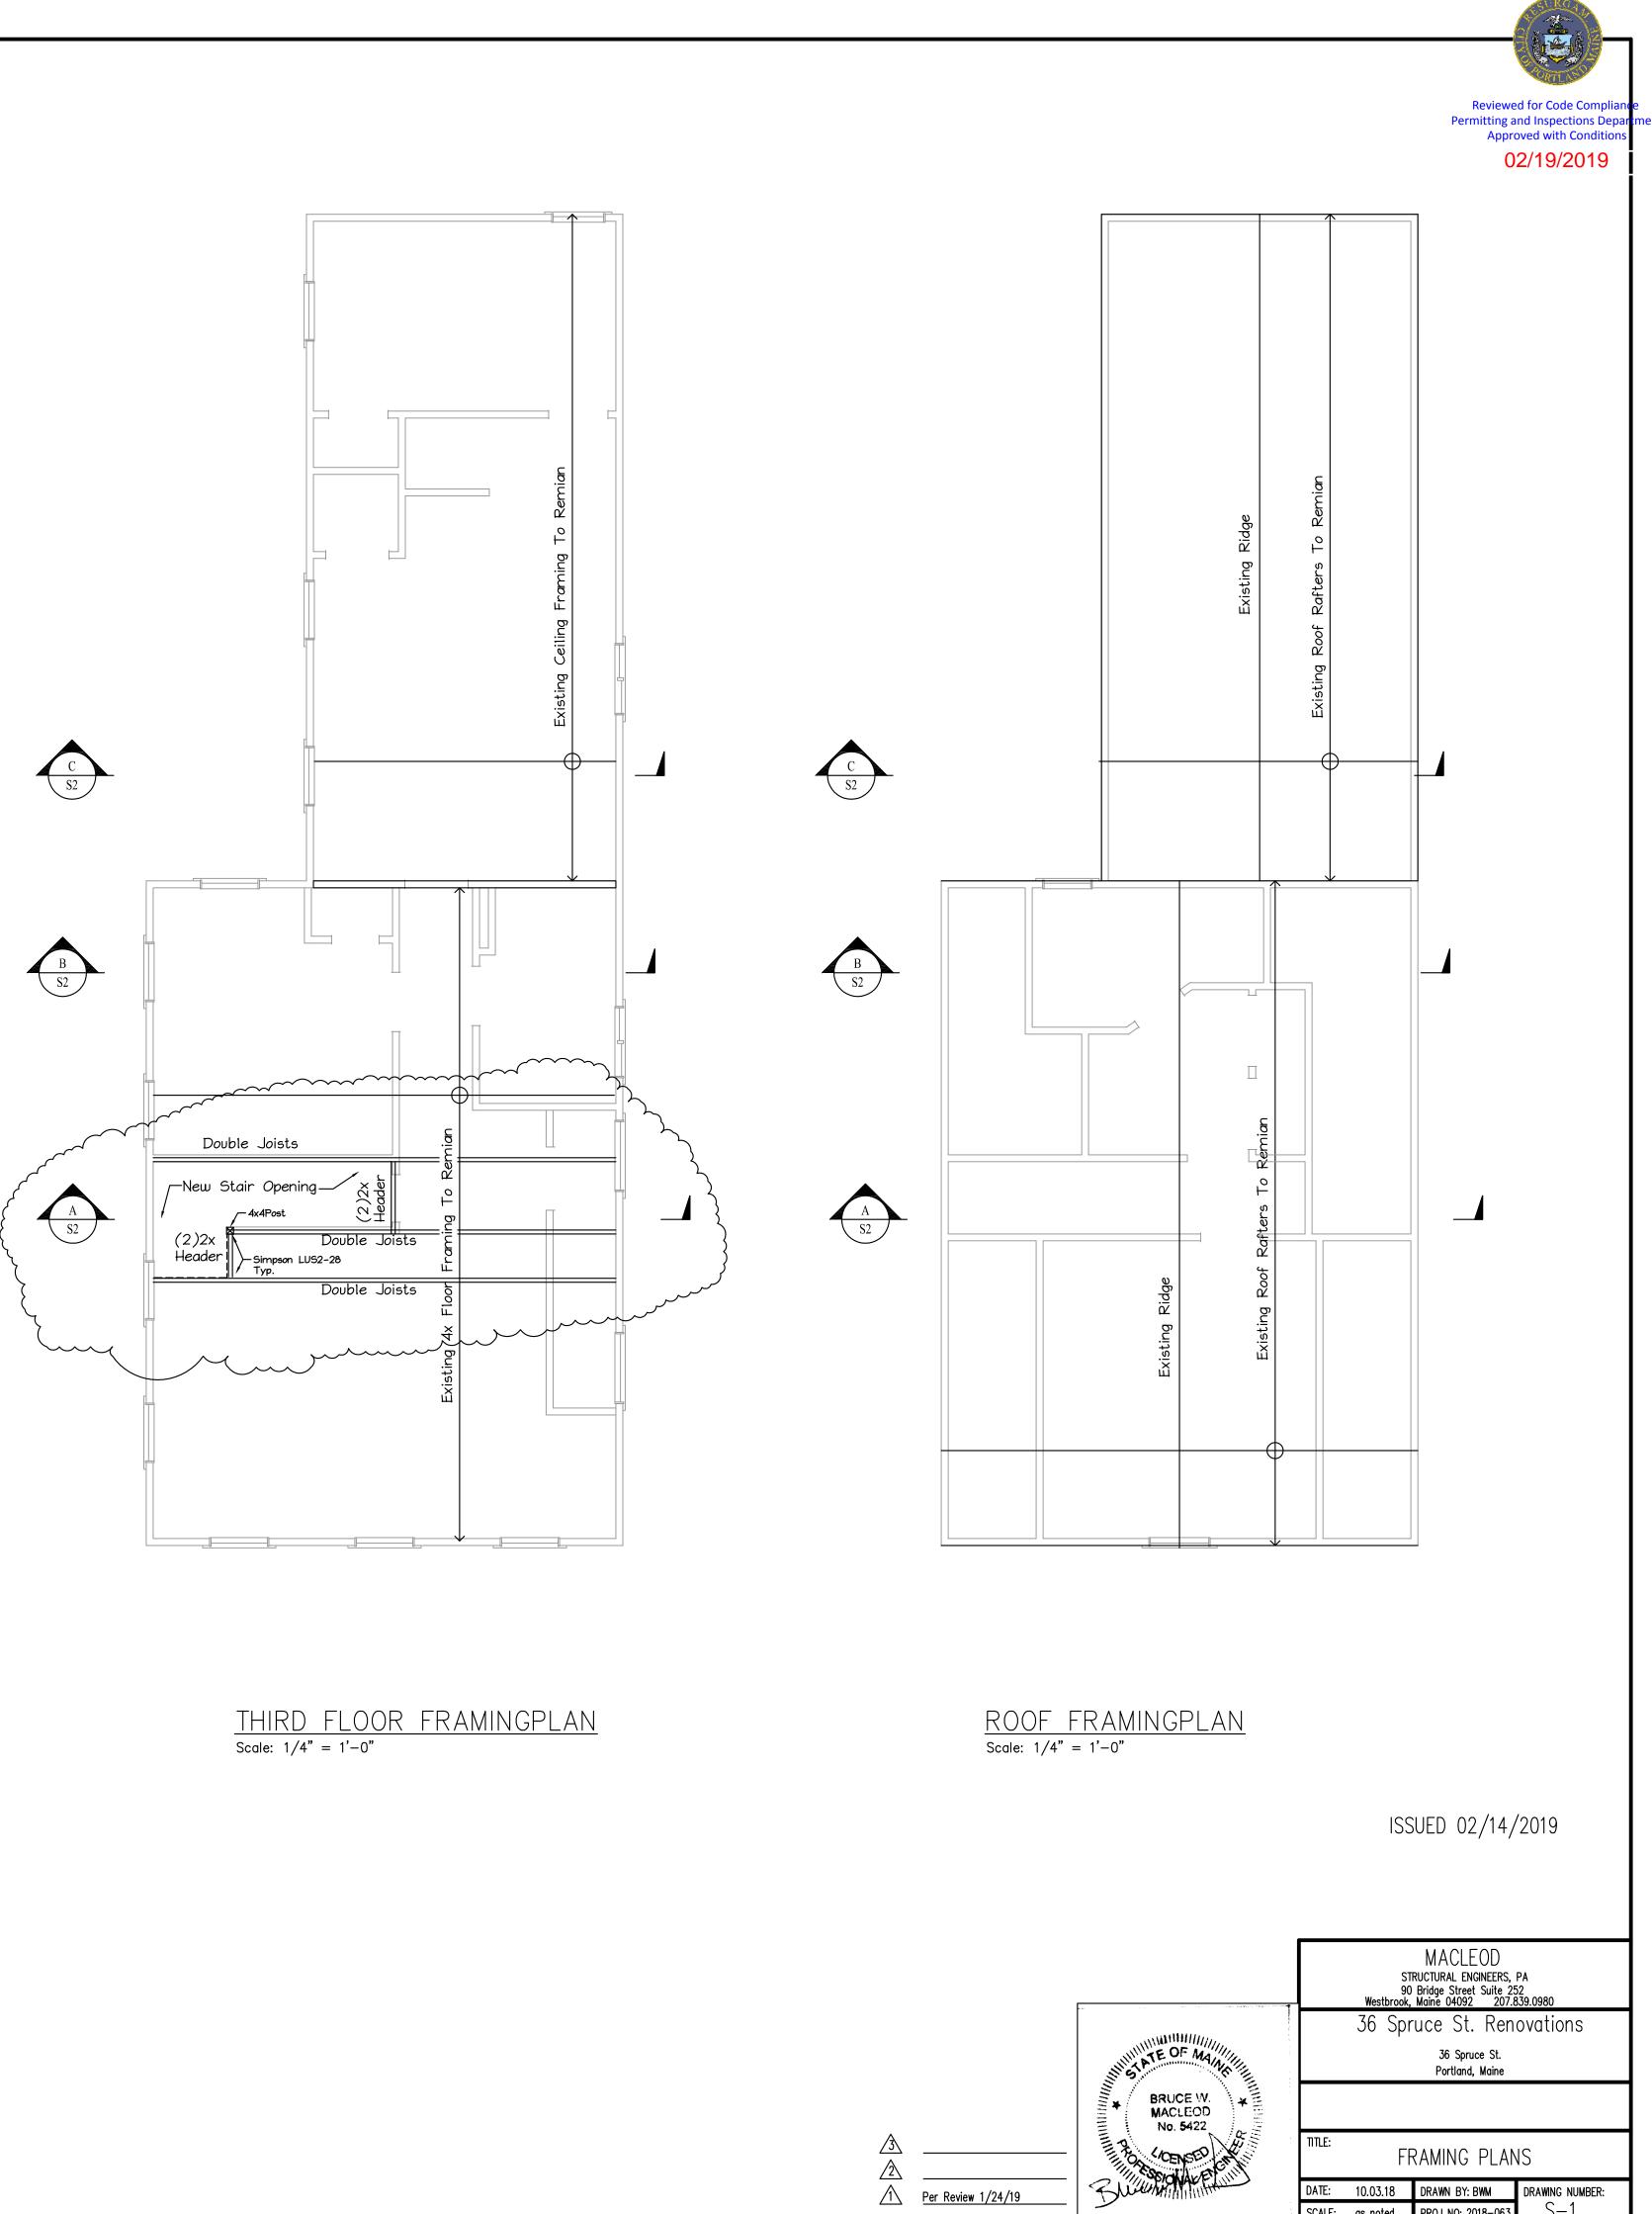

DATE: 10.03.18 DRAWN BY: BWM DRAWING NUMBER: SCALE: as noted PROJ NO: 2018-063 S-1

SCALE: as noted PROJ NO: 2018-063

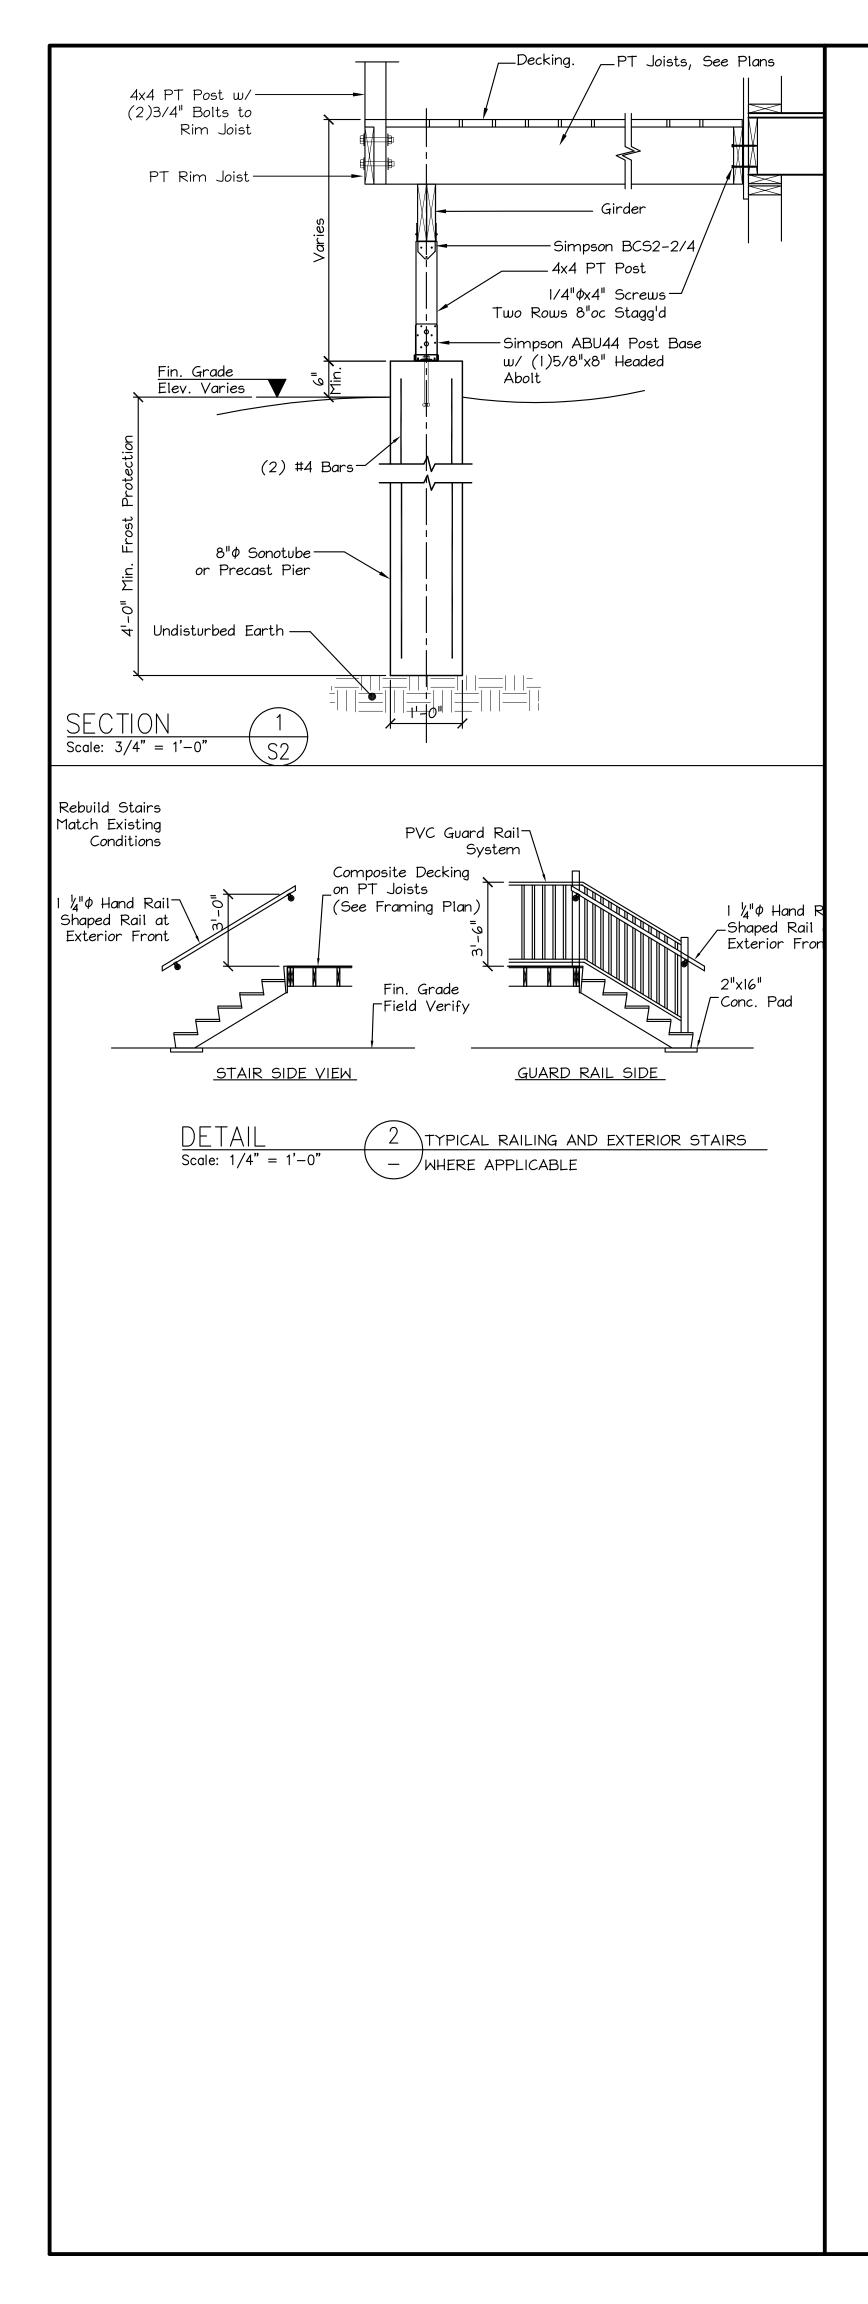


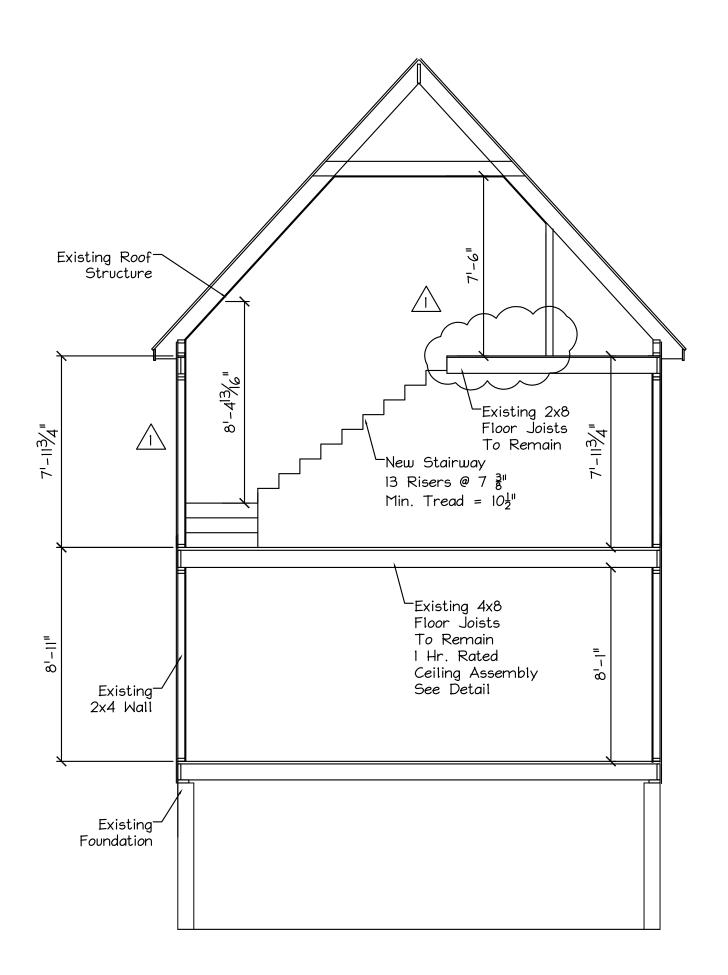



<u>CROSS SECTION A</u> Scale: 1/4" = 1'-0"

<u>CROSS SECTION B</u> Scale: 1/4" = 1'-0"

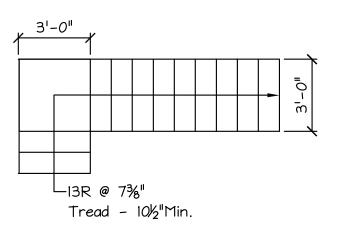

NEW STAIR PLAN Scale: 1/4" = 1'-0"

<u>CROSS SECTION C</u> Scale: 1/4" = 1'-0"

ISSUED 02/14/2019

