7-ELEVEN PORTLAND MAINE PYRO-CHEM UL 1254 GAS ISLAND FIRE SUPPRESSION SYSTEM INSTALLATION

PROJECT
7-ELEVEN #32531

OWNER
7-ELEVEN INC.
1722 ROUTH STREET
DALLAS, TX 75221





P.O. BOX 187
GARDINER, ME 04345-0187

SALES: 1.800.649.9881 SERVICE: 1.800.649.9881

WEBSITE: www.interstatefire.com



TABLE OF CONTENTS				
SHEET NO.	TITLE			
01	COVER SHEET			
02	MECHANICAL DETAIL			
03	ELECTRICAL PLAN			
04	PANEL PROGRAMMING			

NOTES: 1. THIS INSTALLATION SHALL BE MADE IN STRICT ACCORDANCE WITH THE DRAWINGS, SPECIFICATIONS AND APPLICABLE NATIONAL FIRE PROTECTION ASSOCIATION STANDARDS. ALL EQUIPMENT AND DEVICES USED SHALL BE LISTED IN THE UL FIRE EQUIPMENT DIRECTORY.

2. DESIGN AND INSTALLATION OF THE DRY CHEMICAL GAS ISLAND FIRE SUPPRESSION SYSTEM WILL BE IN STRICT ACCORDANCE WITH THE FOLLOWING GUIDELINES AND REGULATORY AGENCIES:

2.1. NFPA 17 STANDARD FOR DRY CHEMICAL FIRE EXTINGUISHING SYSTEMS, 2009 EDITION 2.2. NFPA 72 NATIONAL FIRE ALARM AND SIGNALING CODE, 2010 EDITION

2.3. NFPA 70 NATIONAL ELECTRIC CODES, 2008 EDITION

2.4. AMERICANS WITH DISABILITIES ACT, TITLE 24, LATEST EDITION 2.5. THE LOCAL AUTHORITY HAVING JURISDICTION

System Information:

PYRO-CHEM ATTENDANT II UL 1254

DRY CHEMICAL FIRE SUPPRESSION

SYSTEM PROTECTING A SELF-SERVICE

GASOLINE FUELING FACILITY

Owner/Site:

7-ELEVEN, INC.
7-ELEVEN #32531
704 CONGRESS STREET
PORTLAND, ME 04103

P.O. BOX 1005

NORTH CONWAY, NH 03860

PYRO-CHEM GAS ISLAND FIRE SUPPRESSION SYSTEM
COVER SHEET

Proj. no.:

CAD File: 7, 11Congregory dwg.

ii 12/08/2014


P.O. BOX 1005
NORTH CONWAY, NH 03860

Project Lead: J. MOONEY

CAD File: 7-11CongrPort.dwg
Drawn By: M. STEWARD
Created on: 12/08/2014
Designed by: M. STEWARD
Checked by: T. MOONEY
Approved by: T. MOONEY
Project Lead: J. MOONEY

Scale: SCALE AS NOTED

SHEET:

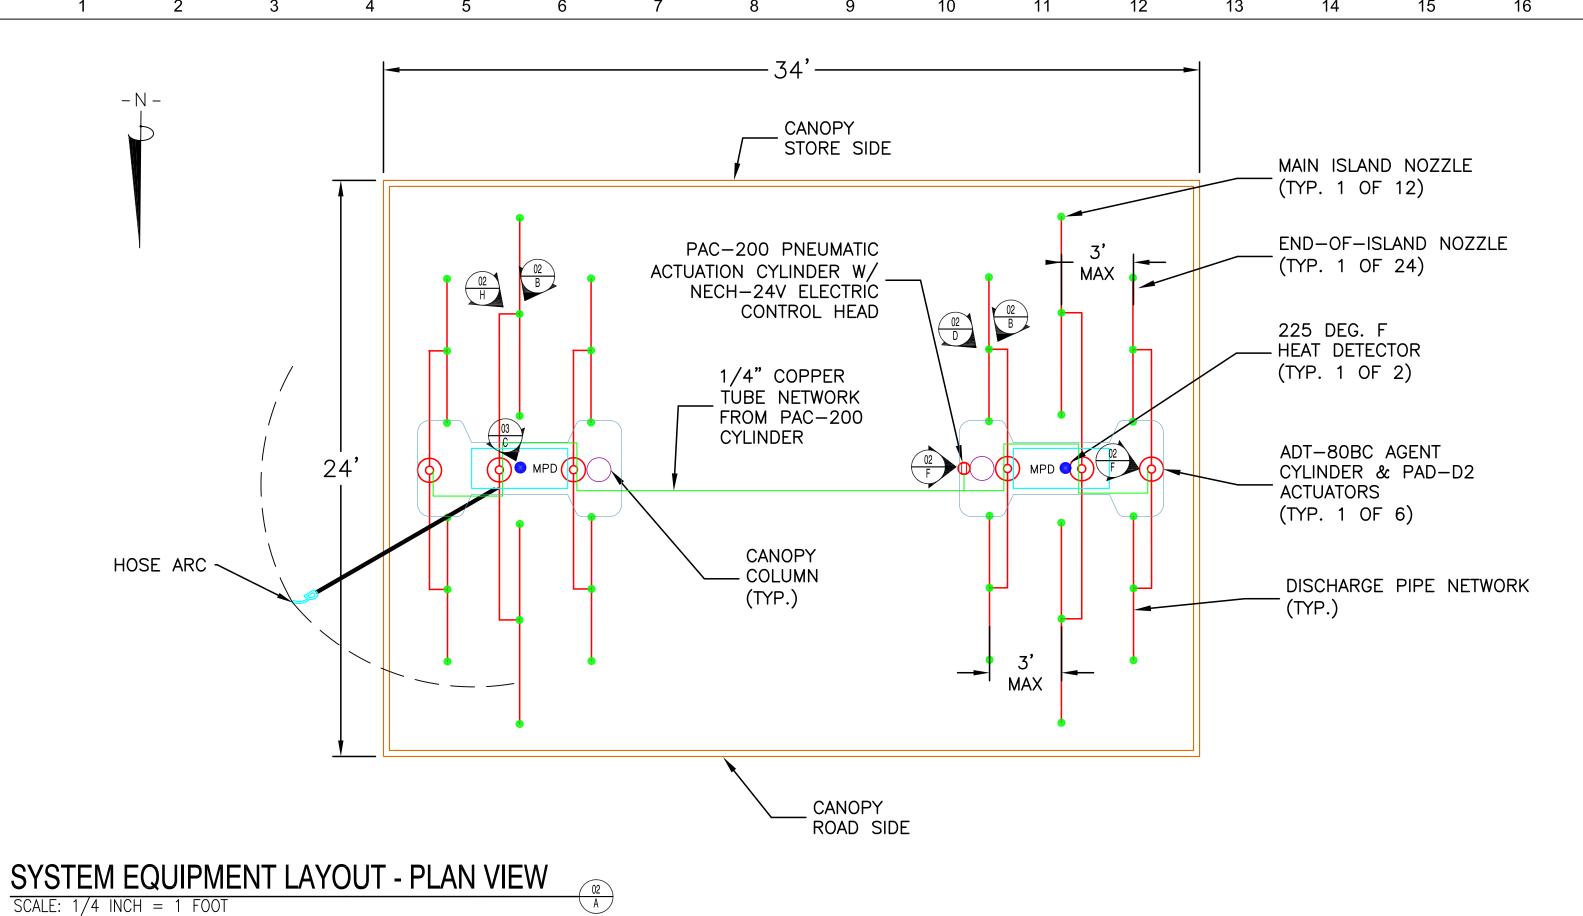

SYSTEM PIPING NOTES

- 1. THE ADT-80BC MUST ALWAYS USE TWO (2) NOZZLE CLUSTERS (6 NOZZLES).
- 2. THE MAXIMUM VERTICAL RISE OF SYSTEM PIPING ABOVE THE OUTLET CYLINDER IS 7 FEET.
- 3. THE NUMBER OF ELBOWS MUST BE EQUAL ON BOTH DISCHARGE LINES.
- 4. THE LENGTH OF THE SHORTEST SIDE OF THE PIPING CANNOT EXCEED 2/3 THE LENGTH OF THE LONGEST SIDE. THE LONGEST SIDE OF PIPE CANNOT EXCEED 18 FEET.


ATD-80BC PIPE LIMITATIONS						
SECTION	MAXIMUM LENGTH	MAXIMUM ELBOWS	TEES ALLOWED	PIPE DIAMETER		
CYLINDER TO NOZZLE CLUSTER (EACH SIDE)	18'	5	0	1"		

GENERAL INFORMATION

- 1. THE AREA OF PROTECTION SHALL INCLUDE THE AREA WITHIN THE ARC SCRIBED BY THE NOZZLE END OF THE HOSE ON EACH VEHICLE FUEL DISPENSER
- 2. SYSTEM ACTIVATION SHALL CAUSE ALL VEHICLE FUEL DISPENSERS TO SHUT DOWN SIMULTANEOUSLY.
- 3. THERMAL DETECTORS SHALL BE INSTALLED ON FIFTEEN (15) FOOT CENTERS ALONG A SINGLE LINE SYMMETRICALLY OVER THE CENTER OF THE PUMP ISLAND THAT IS BEING PROTECTED.
- 4. A MANUAL RELEASE STATION SHALL BE INSTALLED IN A CONSPICUOUS AND ACCESSIBLE LOCATION AWAY FROM THE VEHICLE FUEL DISPENSERS AND PROTECTED AREA.

ACTUATION LINE NOTES


- 1. ALL AGENT SUPPLY CYLINDERS SHALL BE PNEUMATICALLY OPERATED BY A SUPPLY OF NITROGEN CONTAINED IN A PNEUMATIC ACTUATING CYLINDER (PAC). THE PAC SHALL BE ACTIVATED BY A NECH ELECTRIC CONTROL HEAD CONTROLLED BY AN AUTOPULSE Z-10 FIRE SYSTEM CONTROL PANEL. THE PAC SHALL BE CONNECTED TO A NETWORK OF PNEUMATIC TUBING GOING FROM IT TO PNEUMATIC ACTUATION DEVICES (PAD) INSTALLED ON EACH AGENT SUPPLY CYLINDER.
- 2. PNEUMATIC TUBING USED FOR REMOTE CYLINDER ACTUATION SHALL HAVE AN OUTSIDE DIAMETER OF 1/4 INCH WITH A MINIMUM WALL THICKNESS OF 1/32". THIS IS COMMONLY KNOWN AS REFRIDGERATION—TYPE COPPER TUBING.
- $^{
 m I}$ 3. ALL TUBING FITTINGS SHALL BE OF THE 1/4 INCH, 45 DEGREE FLARE—TYPE CONFORMING TO SAE J513C.
- 4. COMPRESSION TYPE FITTINGS ARE UNACCEPTABLE.

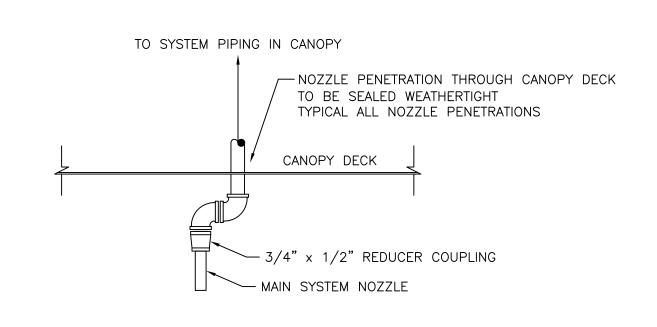


22

23


NOZZLE INSTALLATION DETAIL SCALE: NOT TO SCALE

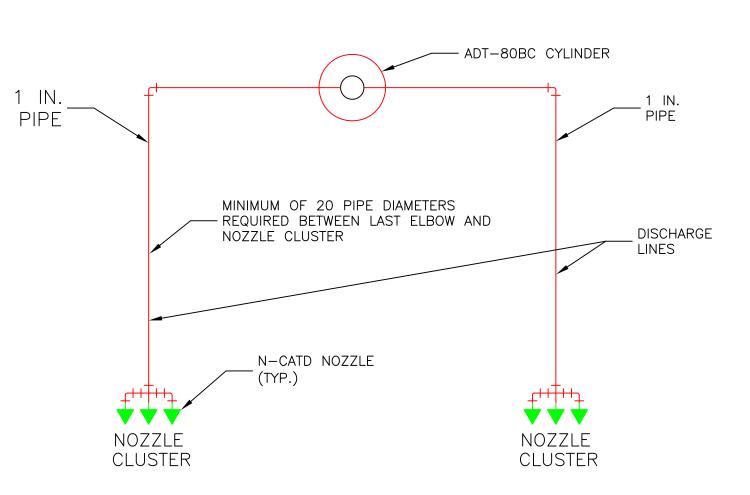



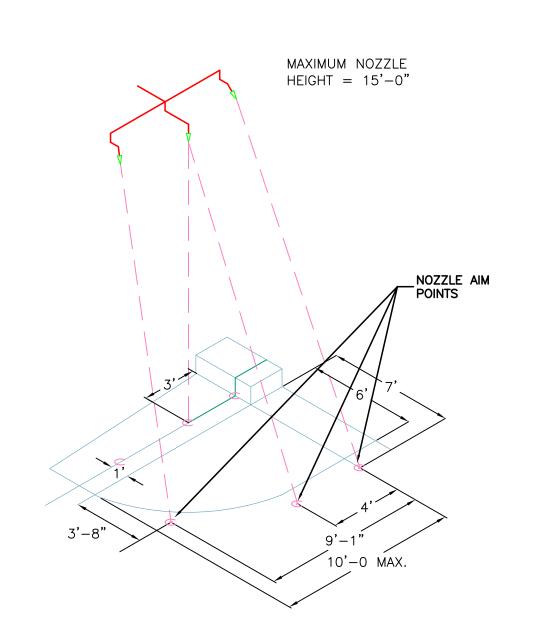




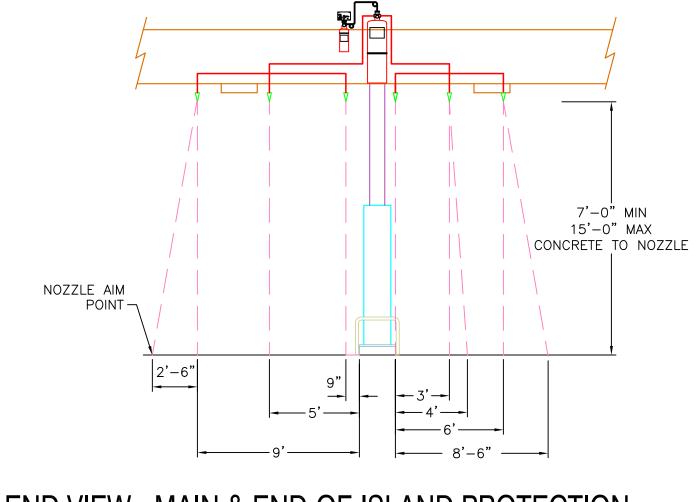


28


29

END VIEW - MAIN & END-OF-ISLAND PROTECTION SCALE: NOT TO SCALE

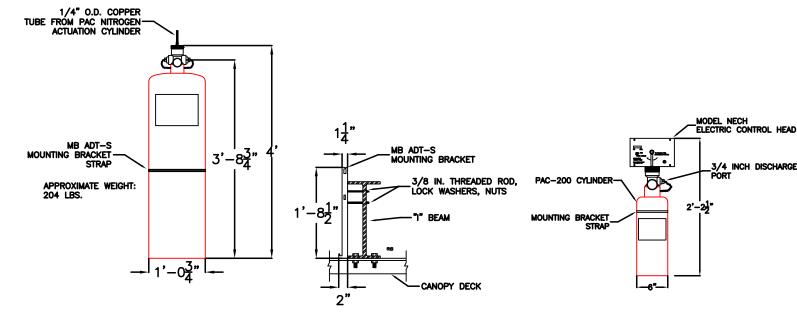

ADT-80BC CYLINDER, BRACKET AND PAC 200 DETAIL

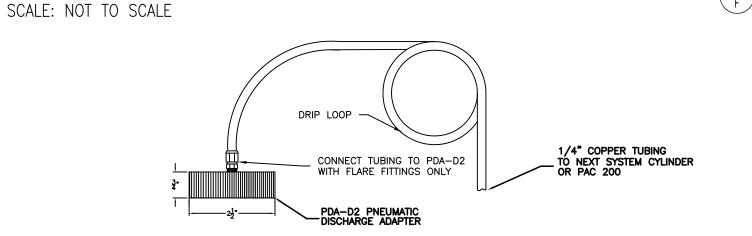

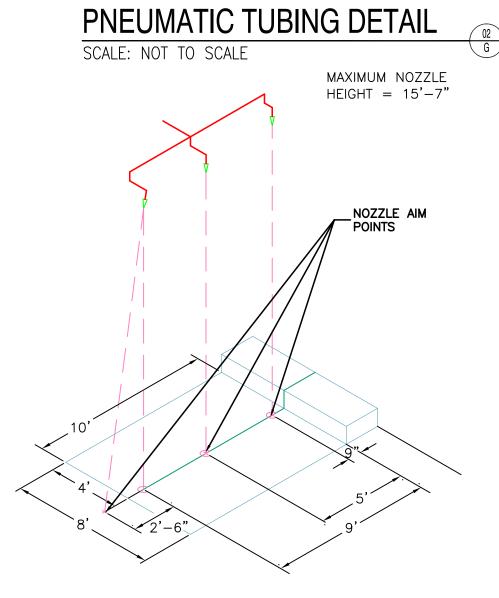

MAXIMUM NOZZLE HEIGHT:

MAIN ISLAND NOZZLES: 15'-7" FROM
CONCRETE PAD TO TIP OF NOZZLE

END OF ISLAND NOZZLES: 15' FROM
CONCRETE PAD TO TIP OF NOZZLE

O = RELATIVE NOZZLE LOCATION
+ = NOZZLE AIM POINT
DRY CHEMICAL CYLINDERS TO BE
MOUNTED ON TOP OF CANOPY DECK
TO STRUCTURAL MEMBERS
(CYLINDERS ARE NOT TO BE
SUPPORTED BY CANOPY DECKING).

33



MAIN ISLAND NOZZLE AIM POINTS

Project Lead: J. MOONEY

Scale: AS NOTED

NOTES:

PYRO-CHEM BILL OF MATERIALS

QTY PART NO. DESCRIPTION

12 | 550061

6 | 551146

36 | 551509

2 | 13976

1 | 551206

6 550829

550690

430525

430687

417692

NUMBER OF

SYSTEMS REQ'D

1) ATD 80

SYSTEM

NUMBER OF

HEAT DETECTORS

REQ'D

1 430529

Q

551166

80 Lb. BC. Cyl. (ADT-80-SBC)

RPS-E2 Remote Pull Station, Electrical

T-3W Three-Way Tee

ADT II Nozzle w\Cap

Cvl. Bracket - MB ATD-S

Elec. Heat Detector - 225°

4-PT Auxiliary Relay Module

NUMBER OF

NOZZLES REQ'D

36 PER

SYSTEM

2 @ 225° 1

PER ISLAND

INCLUDES MAIN AND END OF ISLAND PROTECTION

TOTAL: 36

NECH-24V Electric Control Head

PAC-200 Pneumatic Actuation Cyl.

Pneumatic Discharge Adaptor PDA-D2

Coil Supervision Module (Release Circuit)

AUTOPULSE Z-10 Control System, Red, 120/240 VAC

Battery Pack, 7 AH, 24 VDC (2-12 VDC Batteries)

SITE SPECIFIC

SYSTEM COMPONENT TABLE

NUMBER OF

CYLS. REQ'D

6 PER

SYSTEM

TOTAL: 6

TOTAL HEAT

REQ'D

DETECTORS

THE INFORMATION AND GRAPHIC DEPICTIONS ON THIS SHEET ARE DERIVED FROM INFORMATION OBTAINED IN A PUBLICATION TITLED "THE ATTENDANT II GASOLINE STATION FIRE SUPPRESSION SYSTEM — MODEL ATD-35/80sBC TECHNICAL MANUAL" PYRO-CHEM PART NUMBER: PN551227(1) REVISED MAY 28, 2004

CYLINDER

SIZE & QTY.

ATD-35BC=00

ATD-80BC=6

2 @ 225°

TOTAL: 6 ATD-80BC

IF ADDITIONAL TECHNICAL ASSISTANCE IS NEEDED CONTACT PYRO-CHEM, INC. 1 STANTON STREET, MARINETTE, WI 54143-2542 USA. TELEPHONE NUMBER: 1-715-732-3465 TECHNICAL ASSISTANCE.

System Information:

PYRO-CHEM ATTENDANT II UL 1254

DRY CHEMICAL FIRE SUPPRESSION

SYSTEM PROTECTING A SELF-SERVICE

GASOLINE FUELING FACILITY

Owner/Site:

7-ELEVEN, INC.
7-ELEVEN #32531
704 CONGRESS STREET
PORTLAND, ME 04103

Interstate FIRE PROTECTION

P.O. BOX 1005 NORTH CONWAY, NH 03860

P.O. BOX 187 GARDINER, ME 04345

PYRO-CHEM GAS ISLAND FIRE SUPPRESSION SYSTEM MECHANICAL DETAIL Revisions: Date: |

Proj. no.:

CAD File: 7-11CongrPort.dwg


Drawn By: M. STEWARD

Created on: 12/08/2014

Designed by: M. STEWARD

Checked by: T. MOONEY

Approved by: T. MOONEY

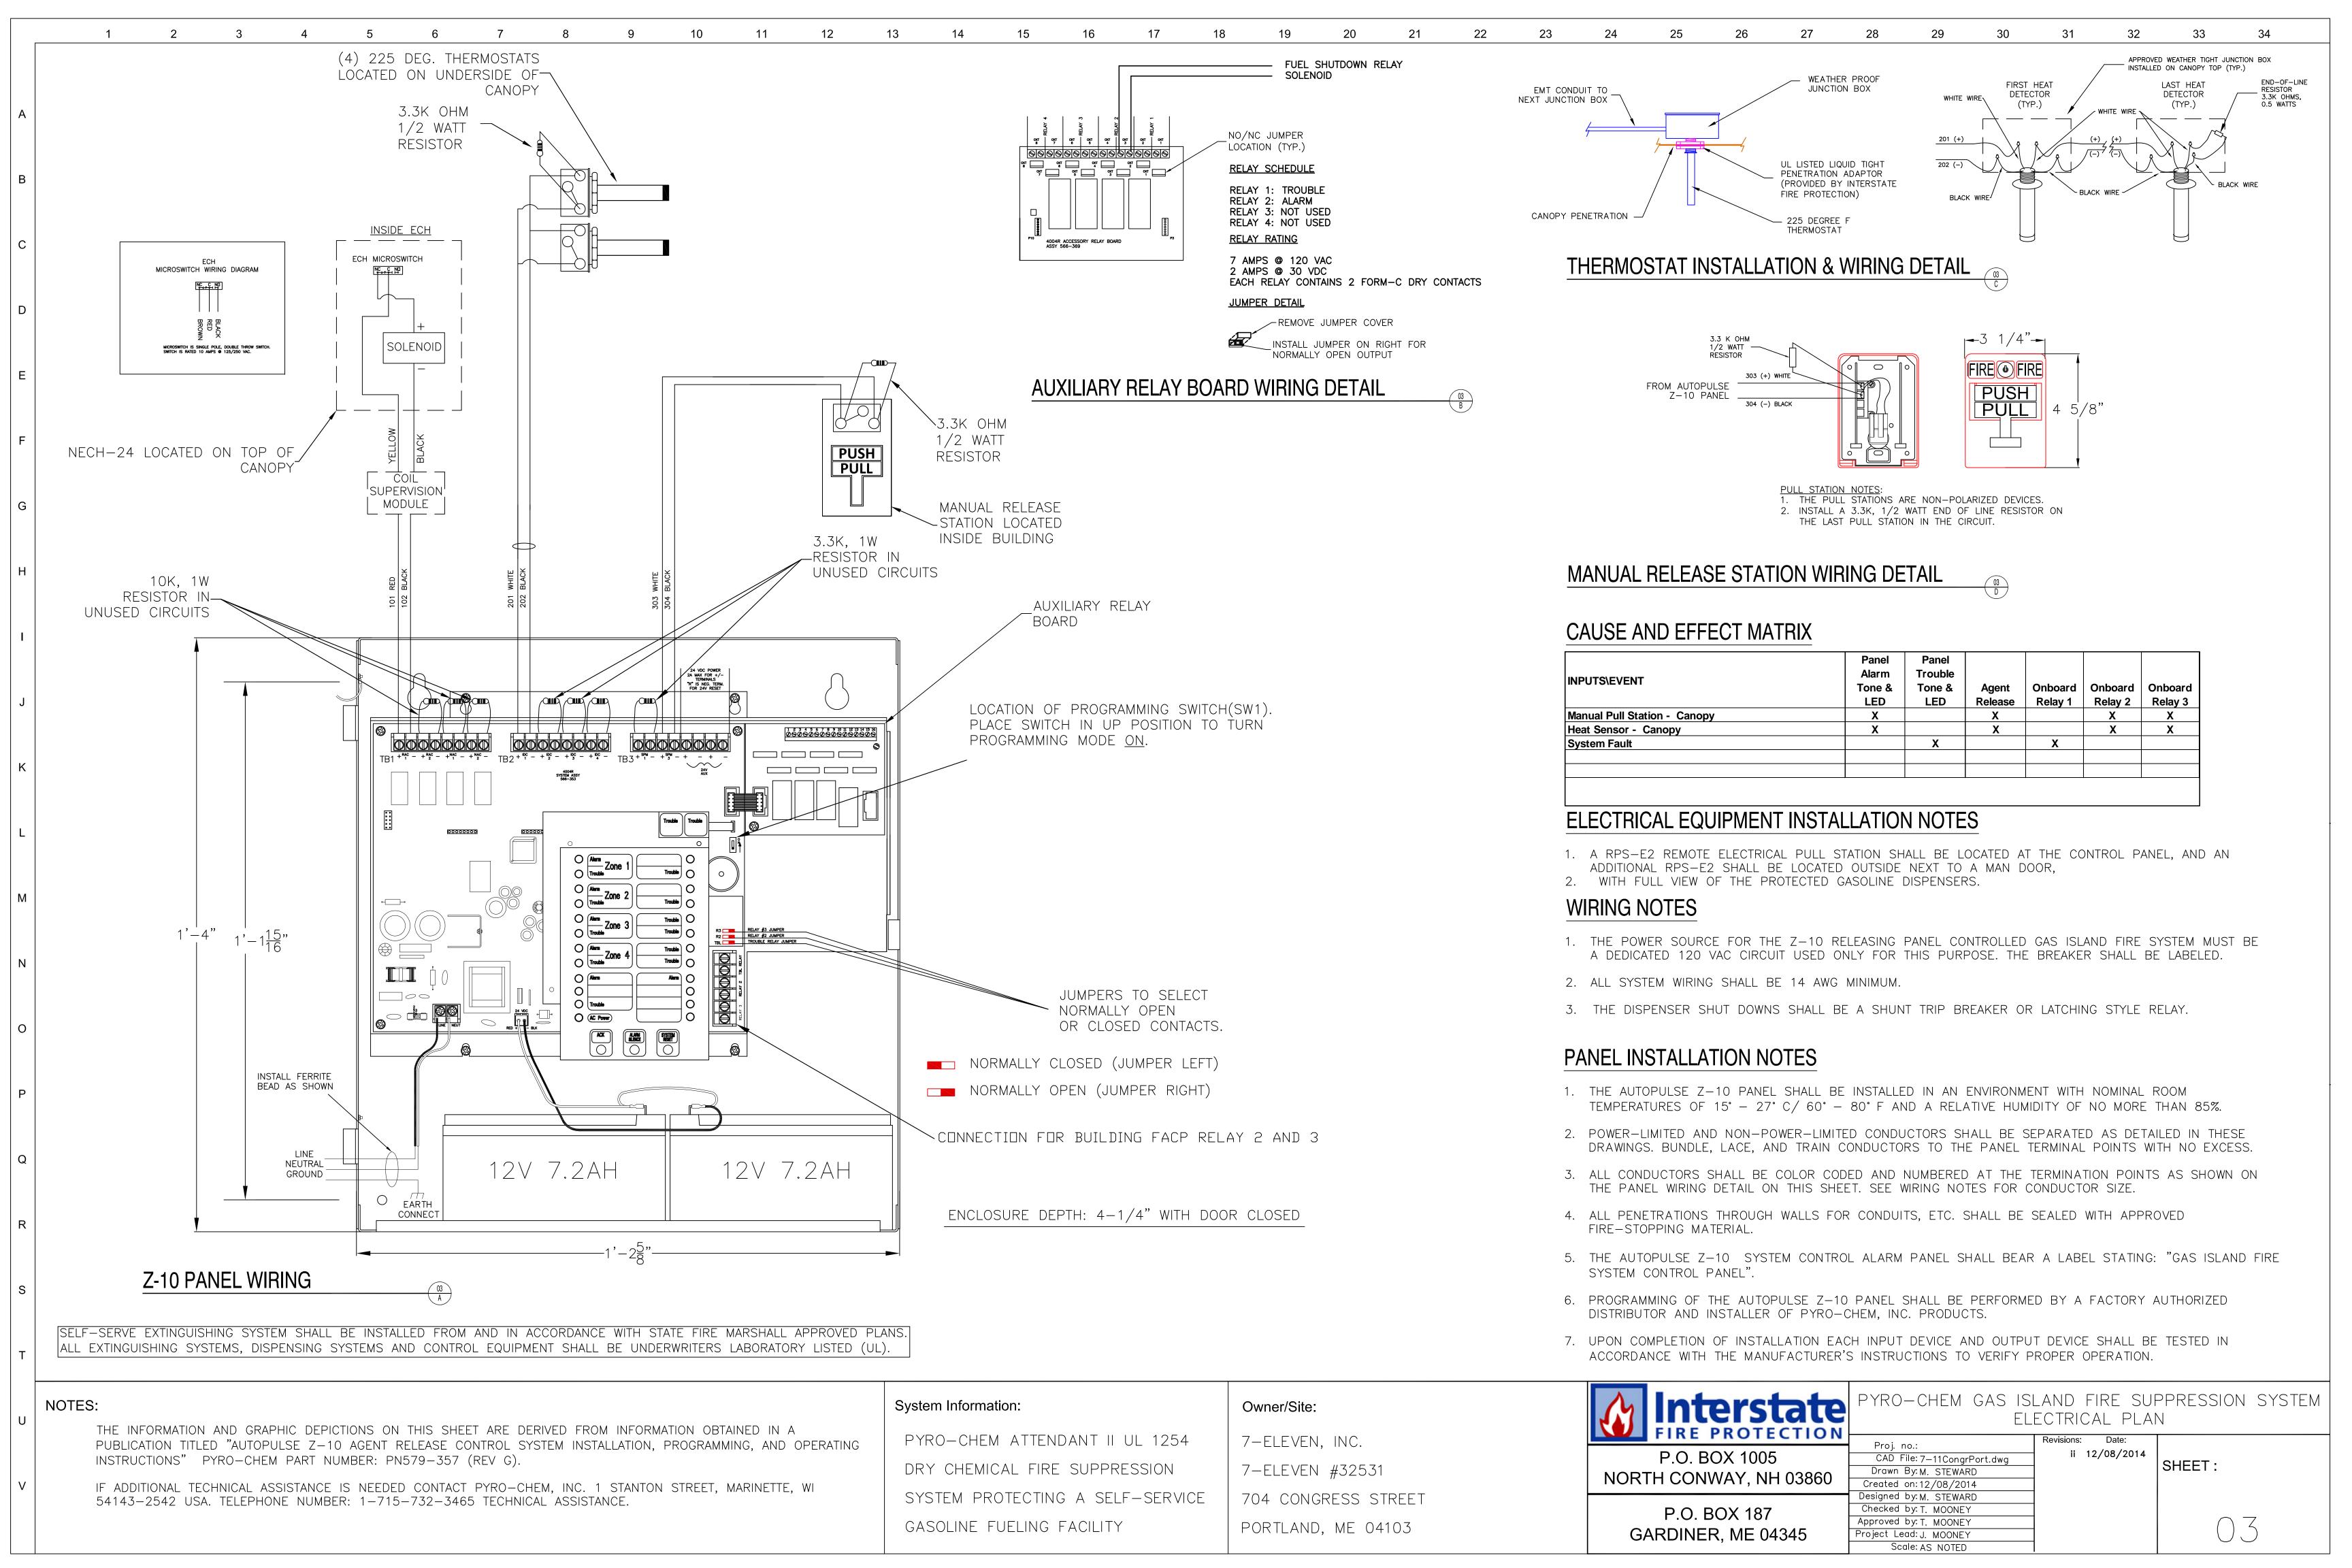



12

15

10

D = DEFAULT

В

С

D

G

0

Q

Z-10 PANEL PROGRAMMING OPTIONS



FRONT PANEL PROGRAMMING NOTES

- 1. OPEN THE CABINET DOOR, REMOVE THE PLASTIC PCB COVER, AND SET THE PROGRAM SWITCH (SW1) TO THE ON POSITION. THIS PLACES THE PANEL IN PROGRAMMING MODE. WHEN YOU DO THIS, THE TONE—ALERT SOUNDS AND THE TROUBLE LED FLASHES. PRESSING ACKNOWLEDGE SILENCES THE TONE—ALERT AND CHANGES THE LED TO STEADY ON.
- 2. THE AUTOPULSE Z-10 PANEL USES THE LEDS ON THE FRONT OF THE PANEL TO REPRESENT THE AVAILABLE PROGRAMMING OPTIONS. THE LEFT COLUMN OF LEDS REPRESENT WHICH GENERAL PROGRAMMING OPTION IS SELECTED AND THE RIGHT COLUMN
- REPRESENTS CONTEXT—SENSITIVE CHOICES FOR THE SELECTED PROGRAMMING OPTION.
 3. THE SYSTEM RESET KEY ALLOWS YOU TO MOVE DOWN THROUGH THE CHOICES AND THE ACK KEY IS USED TO ACCEPT A
- SELECTION AND MOVE TO THE NEXT PROGRAMMING STEP. (THE ALARM SILENCE KEY HAS NO PROGRAMMING FUNCTION.)
 4. WHEN PANEL PROGRAMMING IS FINISHED, SET THE PROGRAMMING SWITCH TO THE OFF POSITION. THIS AUTOMATICALLY SAVES
- CHANGES TO THE AUTOPULSE Z-10'S PROGRAMMING AND PLACES THE PANEL IN THE ALARM MODE.

SELF-SERVE EXTINGUISHING SYSTEM SHALL BE INSTALLED FROM AND IN ACCORDANCE WITH STATE FIRE MARSHALL APPROVED PLANS. ALL EXTINGUISHING SYSTEMS, DISPENSING SYSTEMS AND CONTROL EQUIPMENT SHALL BE UNDERWRITERS LABORATORY LISTED (UL).

NOTES:

THE INFORMATION AND GRAPHIC DEPICTIONS ON THIS SHEET ARE DERIVED FROM INFORMATION OBTAINED IN A PUBLICATION TITLED "AUTOPULSE Z-10 AGENT RELEASE CONTROL SYSTEM INSTALLATION, PROGRAMMING, AND OPERATING INSTRUCTIONS" PYRO-CHEM PART NUMBER: PN579-357 (REV G).

IF ADDITIONAL TECHNICAL ASSISTANCE IS NEEDED CONTACT PYRO—CHEM, INC. 1 STANTON STREET, MARINETTE, WI 54143—2542 USA. TELEPHONE NUMBER: 1—715—732—3465 TECHNICAL ASSISTANCE.

System Information:

PYRO-CHEM ATTENDANT II UL 1254

DRY CHEMICAL FIRE SUPPRESSION

SYSTEM PROTECTING A SELF-SERVICE

GASOLINE FUELING FACILITY

Owner/Site:

7-ELEVEN, INC.
7-ELEVEN #32531
704 CONGRESS STREET
PORTLAND, ME 04103

20

21

22

23

24

25

26

27

28

29

33

Interstate FIRE PROTECTION

P.O. BOX 187

GARDINER, ME 04345

PYRO—CHEM GAS ISLAND FIRE SUPPRESSION SYSTEM PANEL PROGRAMMING

Proj. no.:

CAD File: 7-11C

CAD File: 7-11C

Drawn By: M. STE

Created on: 12/08

Designed by: M. STE

CAD File: 7—11CongrPort.dwg
Drawn By: M. STEWARD
Created on: 12/08/2014
Designed by: M. STEWARD
Checked by: T. MOONEY
Approved by: T. MOONEY
Project Lead: J. MOONEY

Scale: AS NOTED

Revisions: Date:
ii 12/08/2014
SHEET:

04