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**SUBMITTALS**

| REV. | DATE     | DESCRIPTION         | BY  |
|------|----------|---------------------|-----|
| 5    | 10/11/17 | CONSTRUCTION PERIOD | CJC |
| 4    | 09/26/17 | CONSTRUCTION PERIOD | CJC |
| 3    | 09/27/17 | CONSTRUCTION PERIOD | CJC |
| 2    | 09/07/17 | CONSTRUCTION PERIOD | CJC |
| 1    | 08/24/17 | ISSUED FOR PERMIT   | JMT |

SITE NUMBER:  
 4DNZ285D  
 SITE NAME:  
 ME285/HOLT HALL  
 SITE ADDRESS:  
 784 CONGRESS STREET  
 PORTLAND, ME 04102

SHEET TITLE  
 ROOF PLAN

SHEET NUMBER  
 A-1

**COAX CHART**



| EXISTING CONFIGURATION        | PROPOSED CONFIGURATION | FINAL CONFIGURATION  |
|-------------------------------|------------------------|----------------------|
| ALPHA<br>(2) 3/4" COAX CABLES | (2) 3/4" COAX CABLES   | (4) 3/4" COAX CABLES |
| BETA<br>(2) 3/4" COAX CABLES  | (2) 3/4" COAX CABLES   | (4) 3/4" COAX CABLES |
| GAMMA<br>(2) 3/4" COAX CABLES | (2) 3/4" COAX CABLES   | (4) 3/4" COAX CABLES |

EXIST. (3) TRN TRMS (TO REMAIN)  
 EXIST. ANTENNA BALLAST FRAME (TO REMAIN)  
 EXIST. (3) AP1760WY-160WY PANE ANTENNAS (TO REMAIN)  
 3 PROP. (2) RRU BALLAST FRAMES, NEXT TO EXIST. EQUIPMENT CABINETS

PROP. (6) 3/4" COAX CABLES TO PROP. COAX CABLE TRAY (SEE CHART ABOVE)  
 EXIST. F-MISCLE EQUIPMENT CABINET AT EXIST. ROOF CURB

EXIST. (2) WYNTNS WITHIN EXIST. TRAY

RRU NOTE  
 CONFIRM FINAL NUMBER OF RRUS FOR RES 3518 WITH FINAL RF DATA SHEET. (IF REQUIRED)

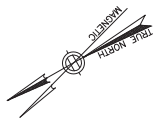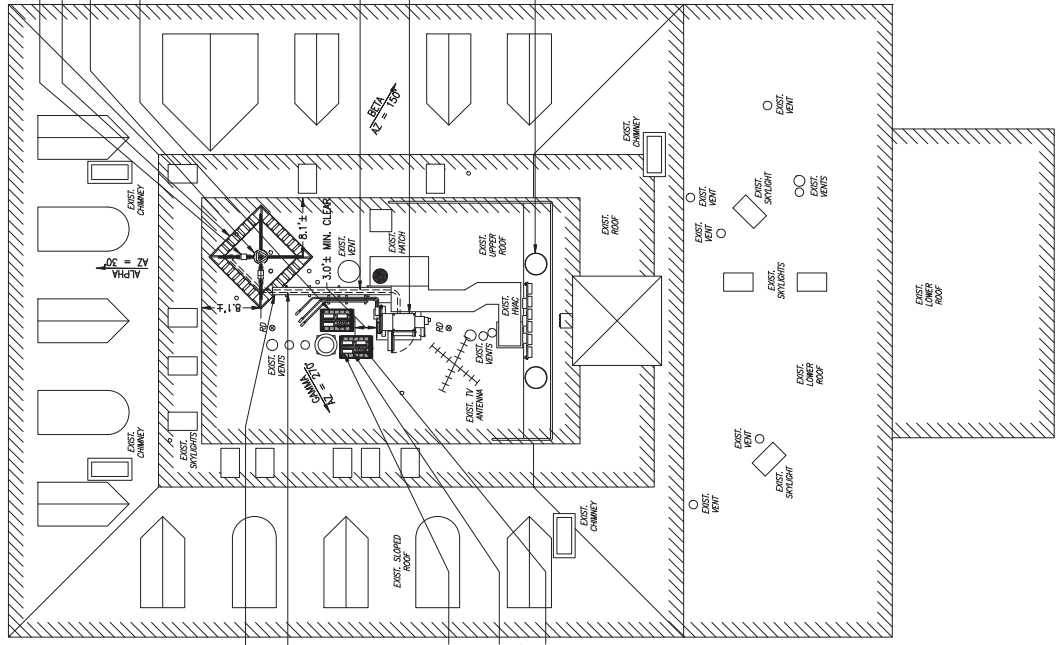

EXIST. ROOF TOP CABLE TRAY  
 EXIST. (6) 3/4" COAX CABLES & (2) COAX CABLES (TO REMAIN)



EXIST. (6) BRU22 UNITS (3) TO BE RELOCATED TO PROP. RRU BALLAST FRAMES BY EQUIPMENT CABINETS (AS SHOWN TO BE REMOVED)

INSTALL (3) RRU11 B4 UNITS TO PROP. RRU BALLAST FRAMES BY EQUIPMENT CABINETS

INSTALL (6) DIPLEXERS TO PROP. RRU BALLAST FRAMES BY EQUIPMENT CABINETS

**ROOF PLAN**  
 SCALE: 1/8" = 1'-0"  
 0 4' 8' 16' 24'

**PARTIAL ROOF PLAN**  
 SCALE: 3/4" = 1'-0"  
 0 6' 12' 24' 36'