

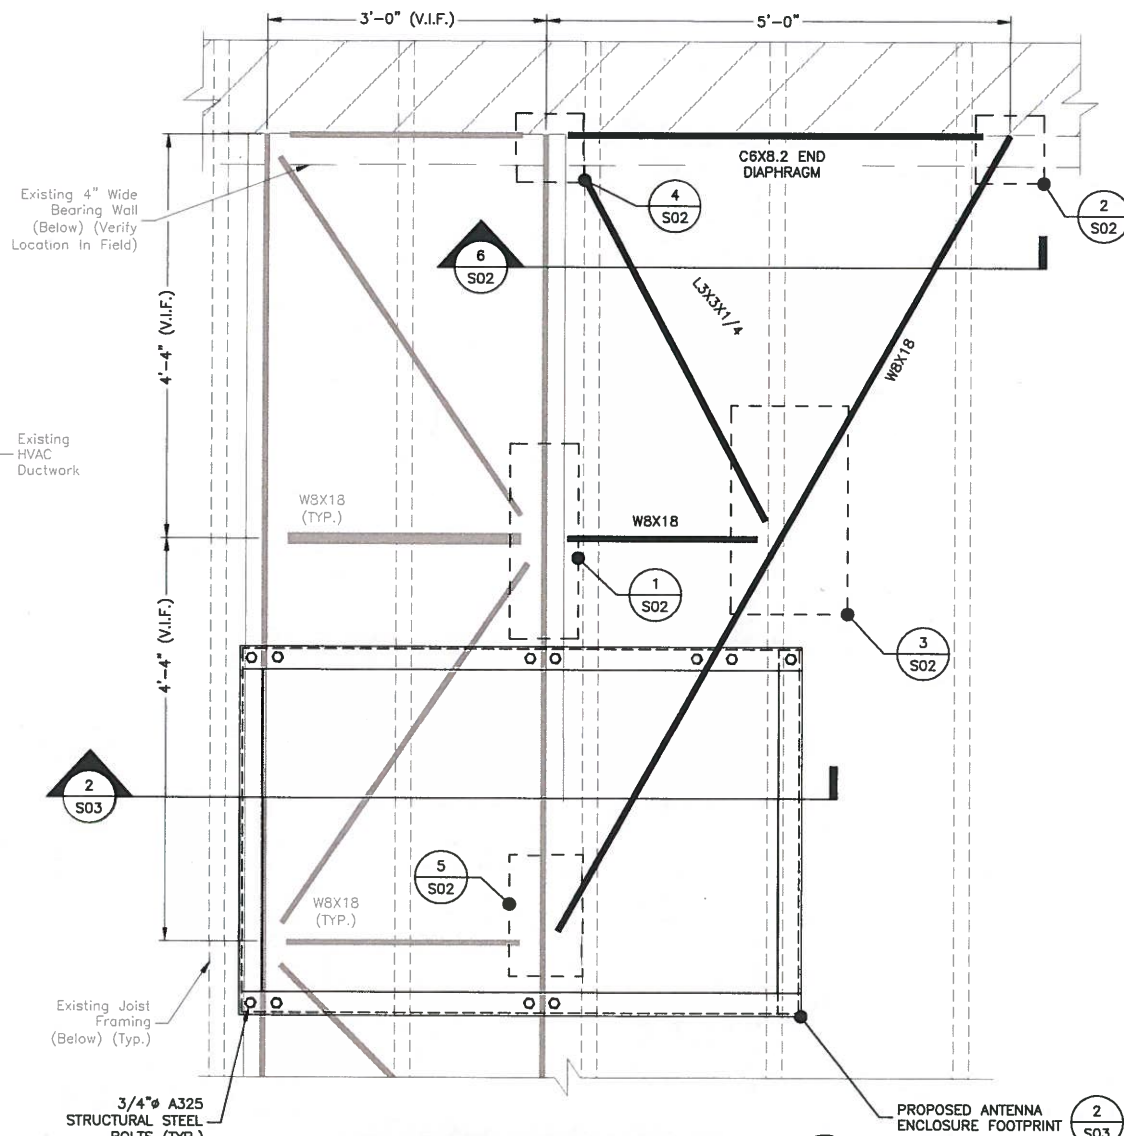


STEEL FRAME PLAN
 SCALE: 3/16"=1' FOR 11'x17"
 3/8"=1' FOR 22'x34"

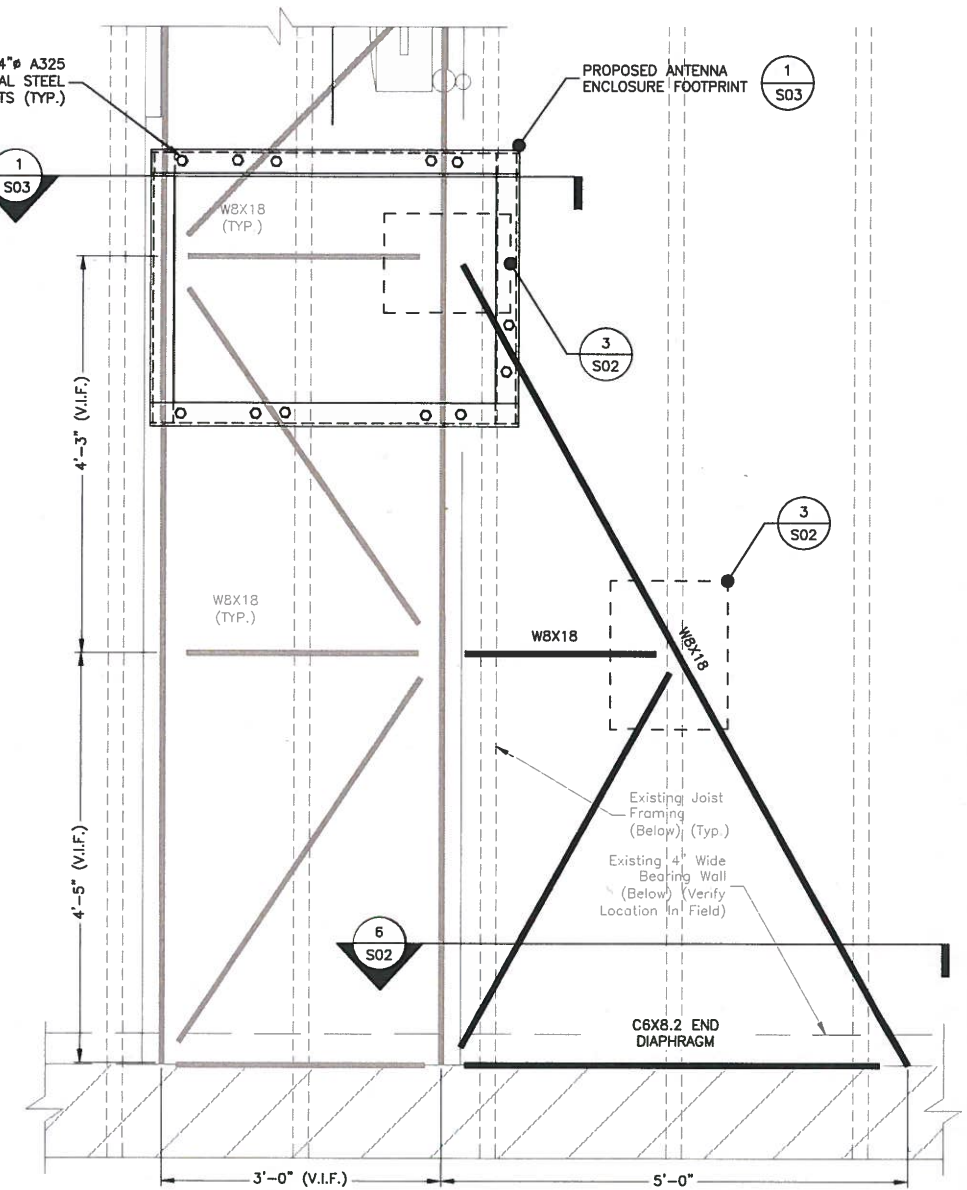

STEEL REINFORCEMENT PLAN - I

SCALE: 1/2"=1' FOR 11'x17"
 1"=1' FOR 22'x34"

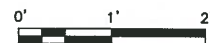

STEEL REINFORCEMENT PLAN - II

SCALE: 1/2"=1' FOR 11'x17"
 1"=1' FOR 22'x34"



NOTES:

- SOME EXISTING AND PROPOSED INFORMATION NOT SHOWN FOR CLARITY.
- ANTENNA AND MOUNTING FRAME TO BE INSTALLED ACCORDING TO STRUCTURAL ANALYSIS ISSUED BY DEWBERRY ENGINEERS INC., DATED 05-16-16.
- PROPOSED MOUNTING CURB TO BE FLASHED AND WEATHERPROOFED. ALL ROOF WORK SHALL ADHERE TO EXISTING ROOF WARRANTIES AND BE COMPLETED BY LL APPROVED ROOFER.
- CONTRACTOR SHALL VERIFY DIMENSIONS OF PROPOSED FEATURES PRIOR TO FABRICATION AND CONSTRUCTION.

Dewberry
 Dewberry Engineers Inc.
 280 SUMMER ST.
 10TH FLOOR
 BOSTON, MA 02210
 PHONE: 617.895.3400
 FAX: 617.895.3310


SAI
 27 NORTHWESTERN DRIVE
 SALEM, NH 03079

HOLT HALL
 SITE NO. ME5091 LTE 3C/4C
 794 CONGRESS STREET
 PORTLAND, ME 04102

at&t
 Mobility
 550 COCHITUATE ROAD
 SUITES 13 & 14
 FRAMINGHAM, MA 01701

NO.	DATE	REVISIONS	BY	CHK	APP'D
2	05/20/16	ISSUED FOR CONSTRUCTION	CDH	DAS	BBR
1	05/17/16	ISSUED FOR REVIEW	CDH	DAS	BBR
0	03/25/16	ISSUED FOR REVIEW	SK	CDH	BBR

SCALE: AS SHOWN DESIGNED BY: CDH DRAWN BY: JG

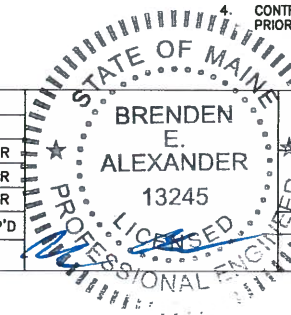

AT&T MOBILITY
 FRAMINGHAM, MA 01701

STEEL FRAMING PLANS

DEWBERRY NO.	DRAWING NUMBER	REV
50019239/50066401	S01	2