
LIGHT FIXTURE SCHEDULE							
TYPE	DESCRIPTION	MFR.	LAMPS	MOUNTING	NOTES		
А	2x4 SPECIFICATION GRADE RECESSED TROFFER W/PATTERN A12 ACRYLIC LENS. 120V/277V	COLUMBIA 4PS SERIES	3-F32T8 3500K	CEILING RECESSED	UTILIZE ALL EXISTING TYPE A FIXTURES AND PROVIDE 6 ADDITIONAL FIXTURES.		
В	2x4 PARABOLIC TROFFER W/SEMI-SPECULAR REFLECTOR. 18 CELL, 3" DEEP LOUVER. 120V/277V	EXISTING TO BE RELOCATED	3-F32T8 3500K	CEILING RECESSED			
С	2x2 SPECIFICATION GRADE RECESSED TROFFER W/PATTERN A12 ACRYLIC LENS. 120V/277V	EXISTING TO BE RELOCATED	2-F31UT8 3500K	CEILING RECESSED			

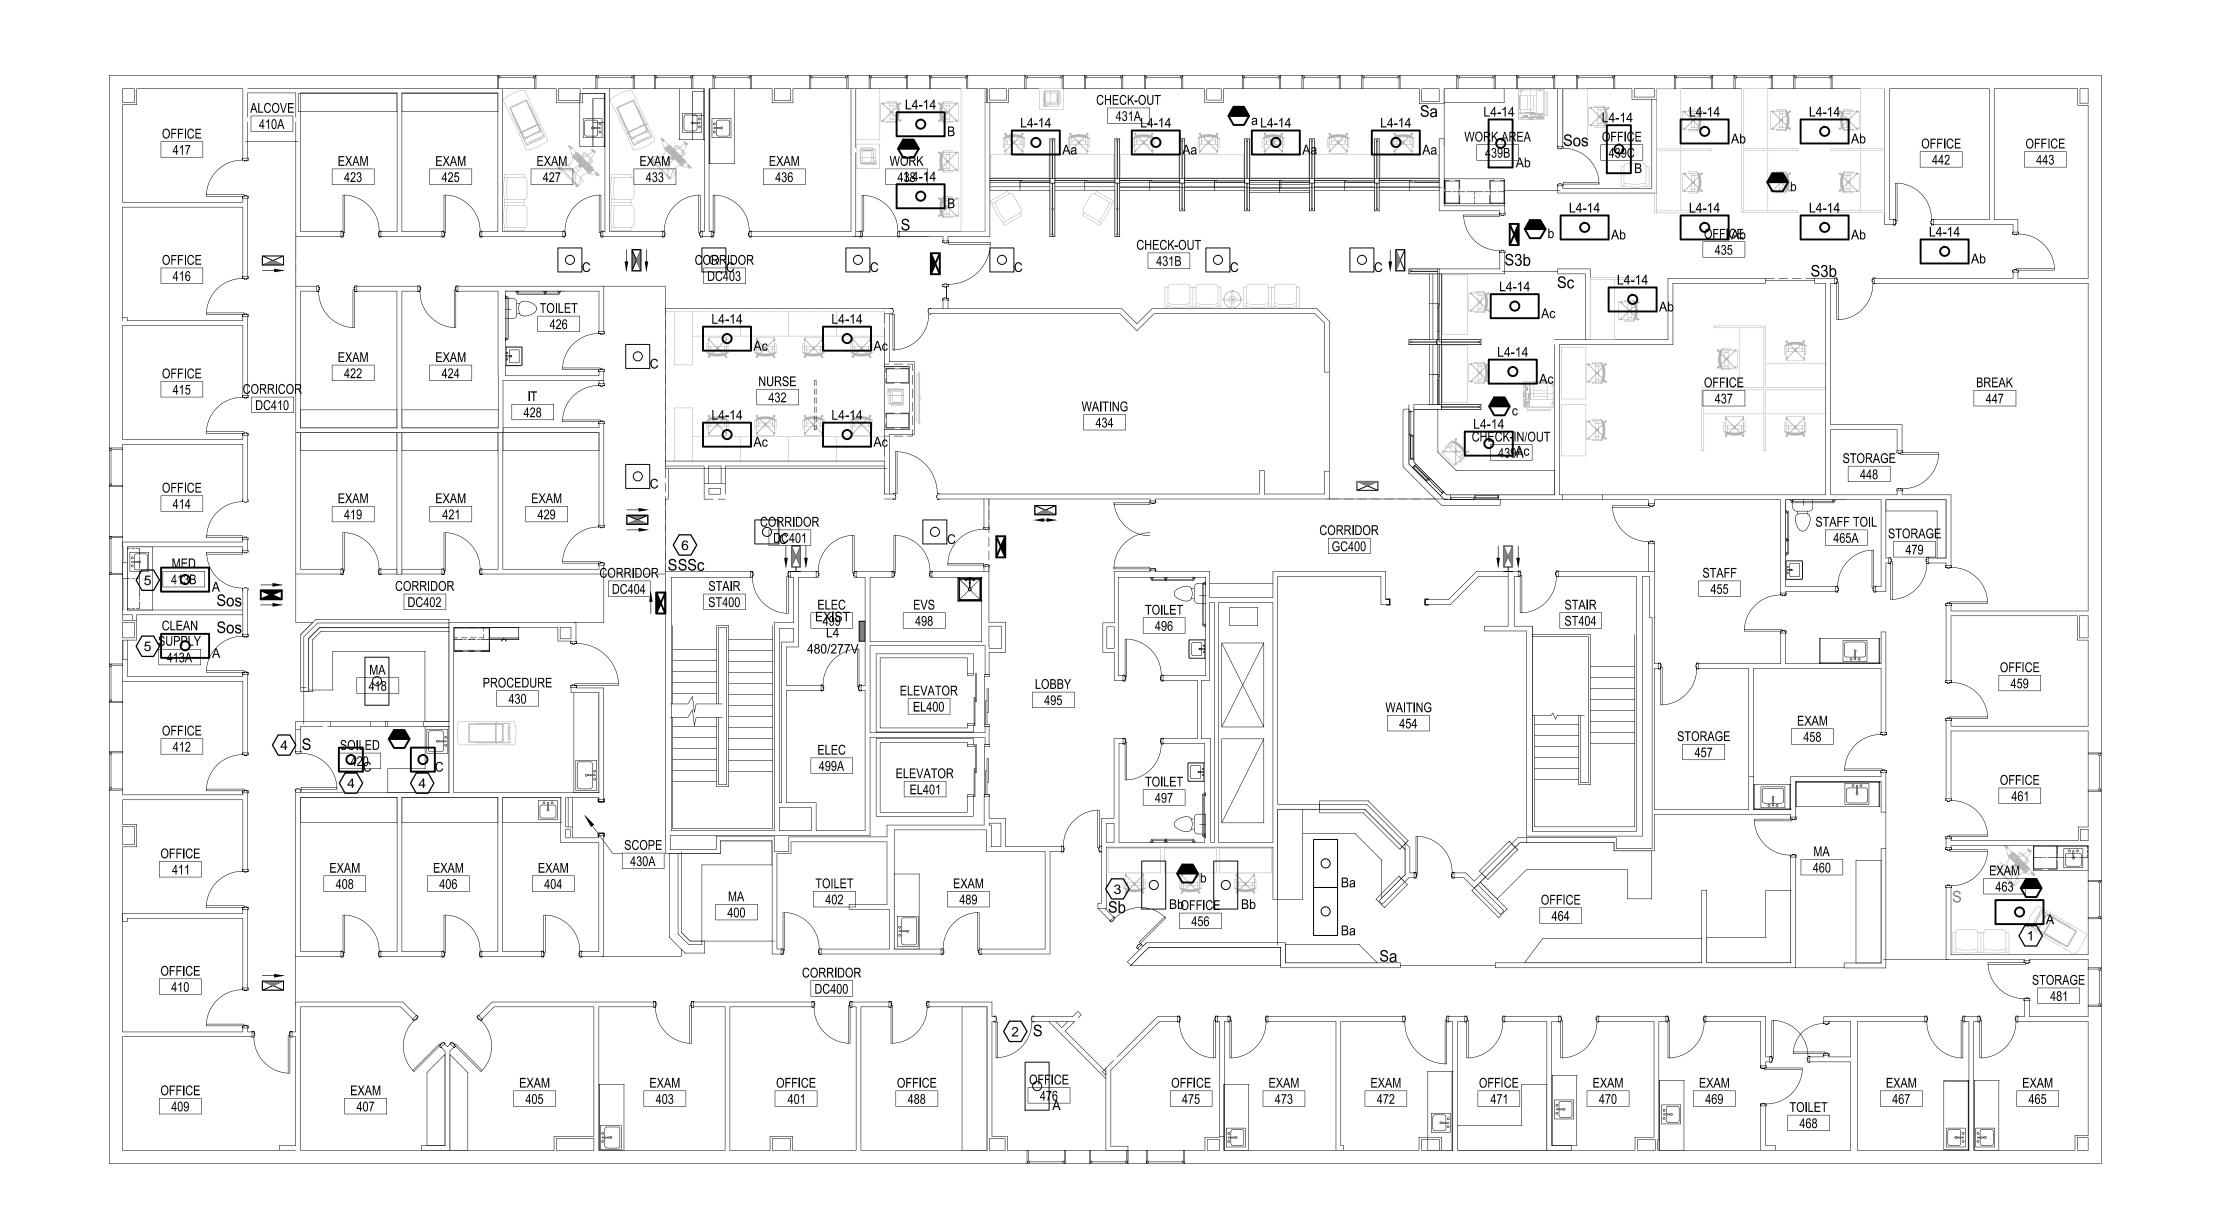

NOTES:

1. SEE E-001 FOR THE LEGEND AND GENERAL NOTES.


KEYED NOTES:

- EXISTING PARABOLIC FIXTURE TO BE REMOVED AND REPLACED WITH NEW LENSED TROFFER.
 RECONNECT EXISTING BRANCH CIRCUIT AND SWITCH TO NEW LIGHT FIXTURE. INSTALL NEW OCCUPANCY SENSOR WIRED IN SERIES WITH EXISTING LINE SIDE WIRING TO LIGHT SWITCH.
- RELOCATE EXISTING LIGHT SWITCH FROM CURRENT LOCATION SHOWN ON ED101 AND EXTEND EXISTING WIRING AS REQUIRED TO NEW SWITCH LOCATION. PROVIDE NEW OCCUPANCY SENSOR FOR CONTROL OF LIGHT.
- PROVIDE NEW SWITCH AND OCCUPANCY SENSOR TO CONTROL EXISTING LIGHTS. MODIFY EXISTING WIRING AS REQUIRED.
- RELOCATE EXISTING LIGHTS AND SWITCH FROM CURRENT LOCATION SHOWN ON ED101 AND EXTEND EXISTING WIRING AS REQUIRED TO REFEED LIGHTS. PROVIDE NEW OCCUPANCY SENSOR FOR CONTROL OF LIGHT.
- PROVIDE NEW LIGHTS AND OCCUPANCY SENSOR SWITCHES AND UTILIZE EXISTING BRANCH CIRCUIT THAT FED LIGHT SHOWN TO BE REMOVED ON ED101 TO FEED NEW LIGHTS.
- RELOCATE CORRIDOR LIGHT SWITCHES FROM CURRENT LOCATION SHOWN ON ED101 AND EXTEND EXISTING WIRING AS REQUIRED TO ACCOMMODATE NEW SWITCH LOCATION.

0	ISSUED FOR CONSTRUCTION	4-25-17
RFV	DESCRIPTION	DATE

ISSUED FOR CONSTRUCTION 4-25-17

CURRENT ISSUE STATUS:

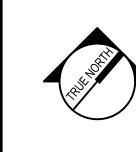

PROJECT NORTH:

SMRT Architects and Engineers 144 Fore Street Portland, Maine 04104 1.877.700.7678 www.smrtinc.com



MAINE MEDICAL PARTNERS
SURGICAL CARE RENOVATIONS

PORTLAND, MAINE

LEVEL 4 LIGHTING PLAN

SHEET TITLE: 0 1/8" 1/2"

SMRT FILE:

SCALE: AS NOTED

PROJECT MANAGER: DJV PROJECT NO:

A/E OF RECORD: DJT

JOB CAPTAIN: CAH

DRAWN BY: CDS

HOSSING:

L101

EL101-17027 SHEET No.

LEVEL 4 - LIGHTING PLAN

1/8" = 1' - 0"

A1