


#### FIRE ALARM NOTES:


- REFER TO ELECTRICAL DRAWINGS FOR EXACT QUANTITIES OF FIRE ALARM DEVICES. ELECTRICAL CONTRACTOR SHALL PROGRAM, TEST AND CERTIFY FIRE ALARM FA2.
- FIRE ALARM SYSTEM AND INSTALLATION SHALL COMPLY WITH APPLICABLE REGULATIONS OF NFPA #72, LIFE-SAFETY CODE #101, NATIONAL ELECTRIC CODE AND LOCAL FIRE DEPARTMENT.

SYSTEM UPON COMPLETION WORK.

- FIRE ALARM WIRING TERMINATIONS SHALL BE MADE ON TERMINAL BLOCKS, NO SPLICES WILL BE ALLOWED.
- ELECTRICAL CONTRACTOR SHALL FIELD CONFORM THAT ENOUGH BATTERY CAPACITY EXISTS FOR THE FIRE ALARM SYSTEM TO OPERATE FOR 60 HOURS IN NON-ALARM CONDITION AND CAPABLE OF OPERATING IN ALARM FOR 15 MINUTES AT THE END OF THE 60 HOUR PERIOD. PROVIDE BATTERY AMP-HOUR CALCULATIONS, RISERS AND WIRING SCHEMATICS WITH SUBMISSION.
- SYSTEM MANUFACTURER SHALL PROVIDE INSTALLATION WIRING DIAGRAM OF THE FIRE ALARM SYSTEM, AND VERIFICATION CERTIFICATE OF SYSTEM OPERATING PRIOR TO FINAL ACCEPTANCE.
- FA7. ALL FIELD WIRING AND EQUIPMENT SHALL BE AS REQUIRED PER MANUFACTURERS WIRING DIAGRAMS.
- ALL FIRE ALARM WIRING SHALL BE CLASS A (OUTGOING AND RETURNING CIRCUITS SHALL NOT BE PHYSICALLY INSTALLED IN THE SAME RACEWAY), FAULT ISOLATOR MODULES SHALL BE INSTALLED IN THE FACP. ALSO, FAULT ISOLATOR MODULES WILL BE PROVIDED FOR EVERY 18 ADDRESSABLE FIRE ALARM DEVICES.
- CEILING MOUNTED SMOKE DETECTORS SHALL NOT BE LOCATED CLOSER THAN 3 FT. FROM AIR SUPPLY FROM AIR SUPPLY DIFFUSERS.
- PROVIDE A REMOTE TEST STATION FOR ALL DUCT MOUNTED SMOKE DETECTORS.

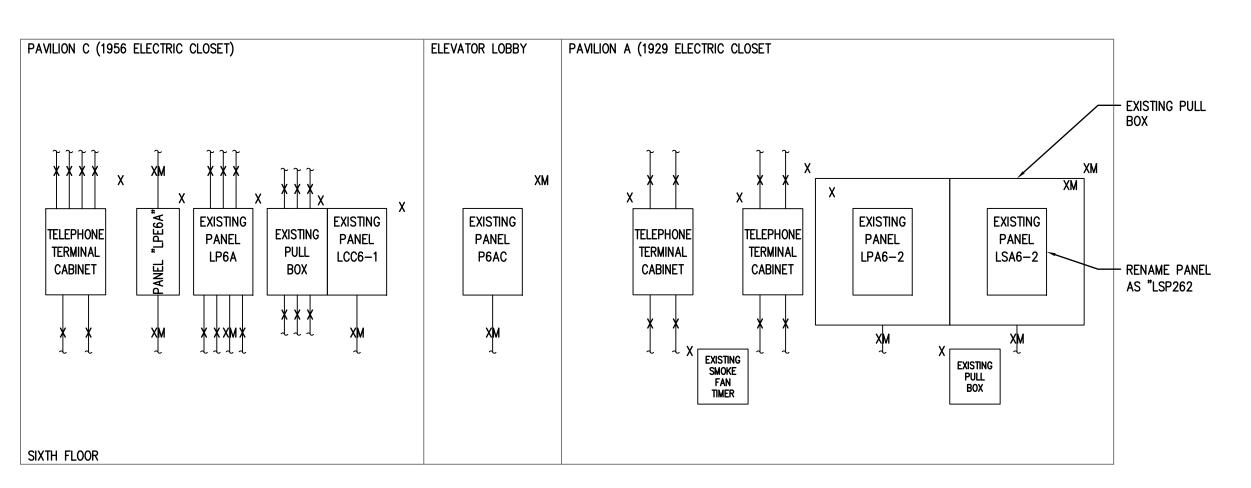

# 2 EXISTING PARTIAL POWER RISER DIAGRAM SCALE: NOT TO SCALE

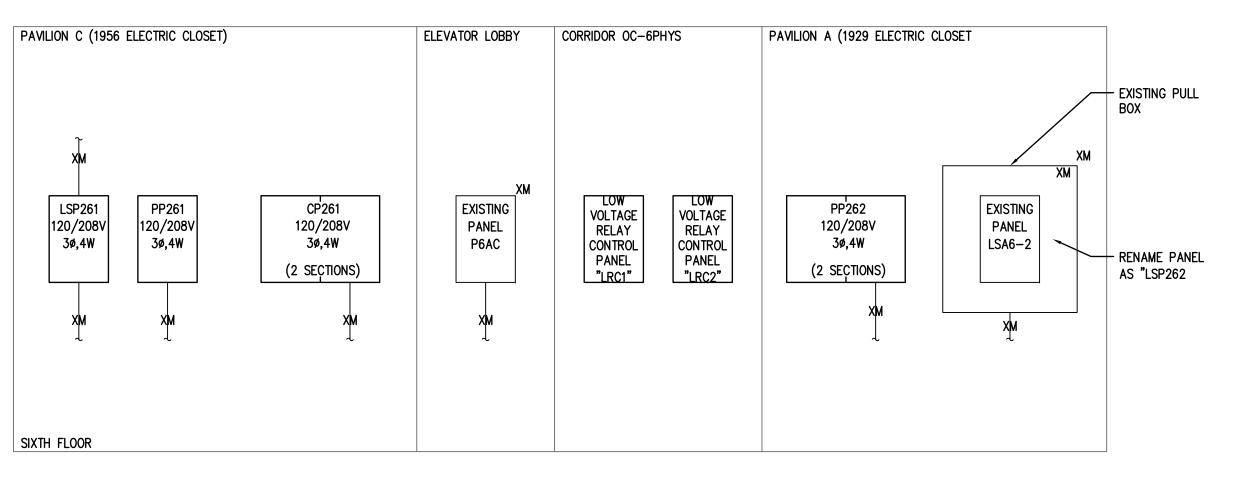

PROPOSED PARTIAL POWER RISER DIAGRAM

SCALE: NOT TO SCALE

### Morris Switzer **Environments for Health**

One Dana Street Portland, ME 04101


t 207.773.8841

f 207.773.8840

morrisswitzer.com

Williston, Vermont Boston, Massachusetts Portland, Maine


© 2009 MorrisSwitzer

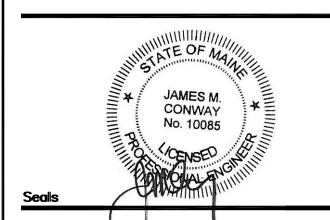


# structural engineers, inc.

75 York Street Portland, ME 04101-4701

Tel 207-879-1838 Fax 207-879-1822 info@beckerstructural.com www.beckerstructural.com

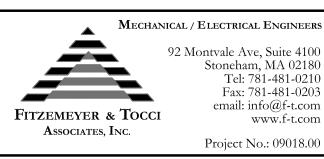

#### Consultant

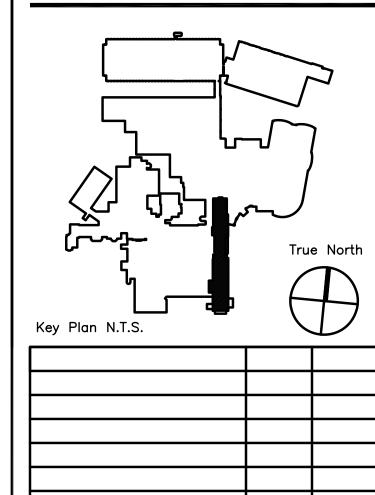



Date

ADDENDUM#1

Revision

## MAINE MEDICAL CENTER

PAVILION 6 RENOVATIONS

MorrisSwitzer Project Number	28034
Date	11/19/09
Scale	NOT TO SCALE
Sheet Title and Number	

SIXTH FLOOR PAVILIONS "A" & "C" ELECTRICAL

> **DETAILS** 3E3.0

RISER DIAGRAM AND

