



3 BASEMENT PHASING PLAN
3/32" = 1'-0"

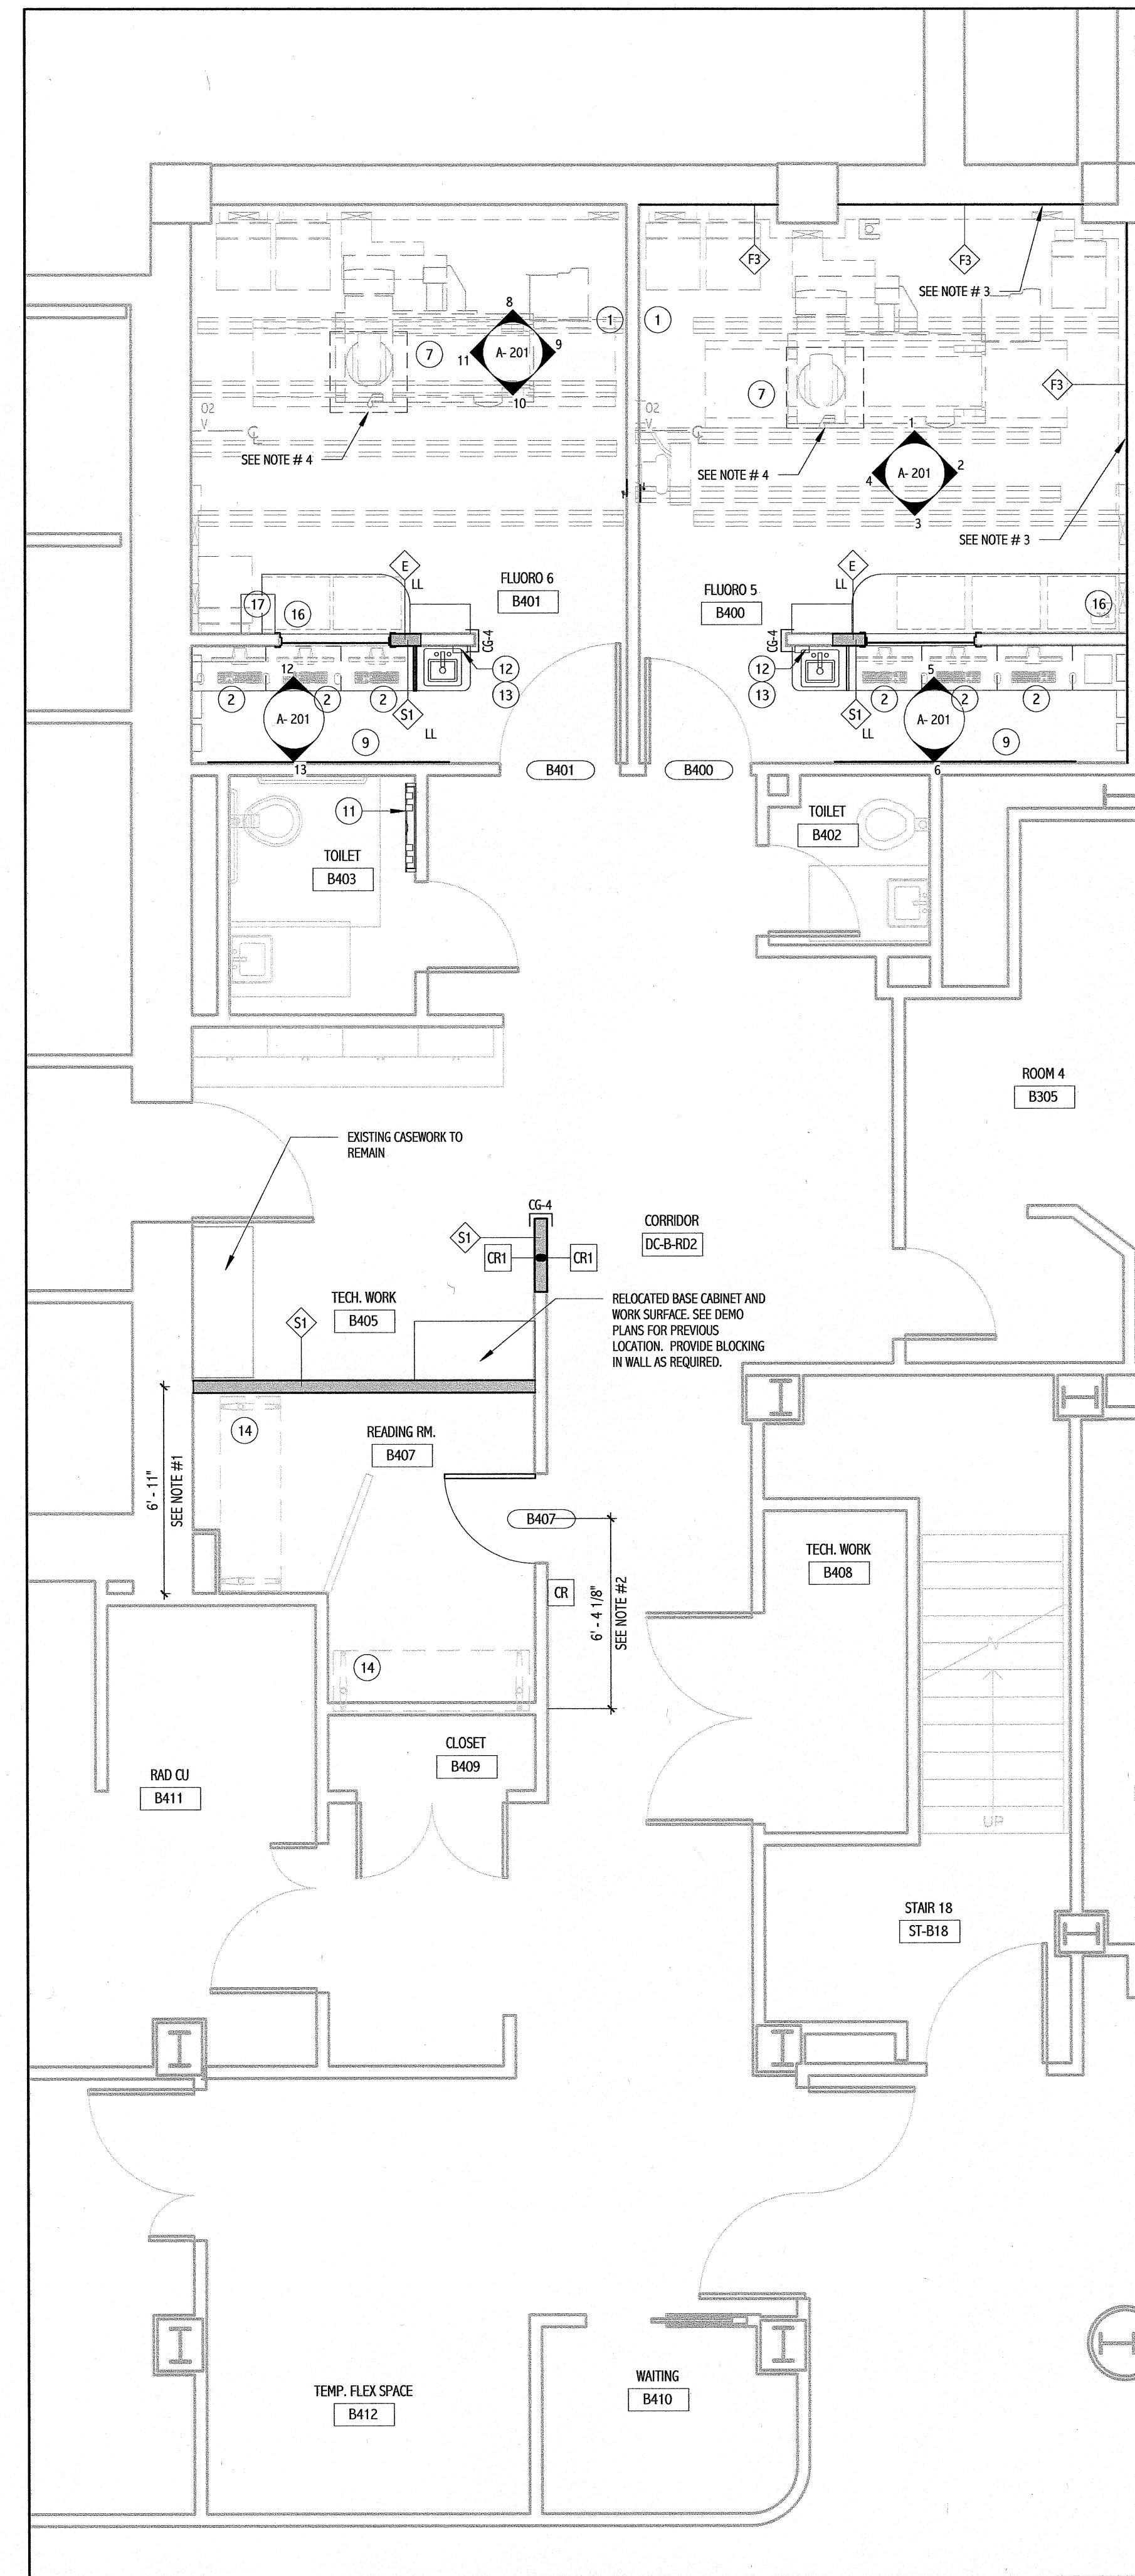

1 FLUORO - FLOOR PLAN
1/4" = 1'-0"

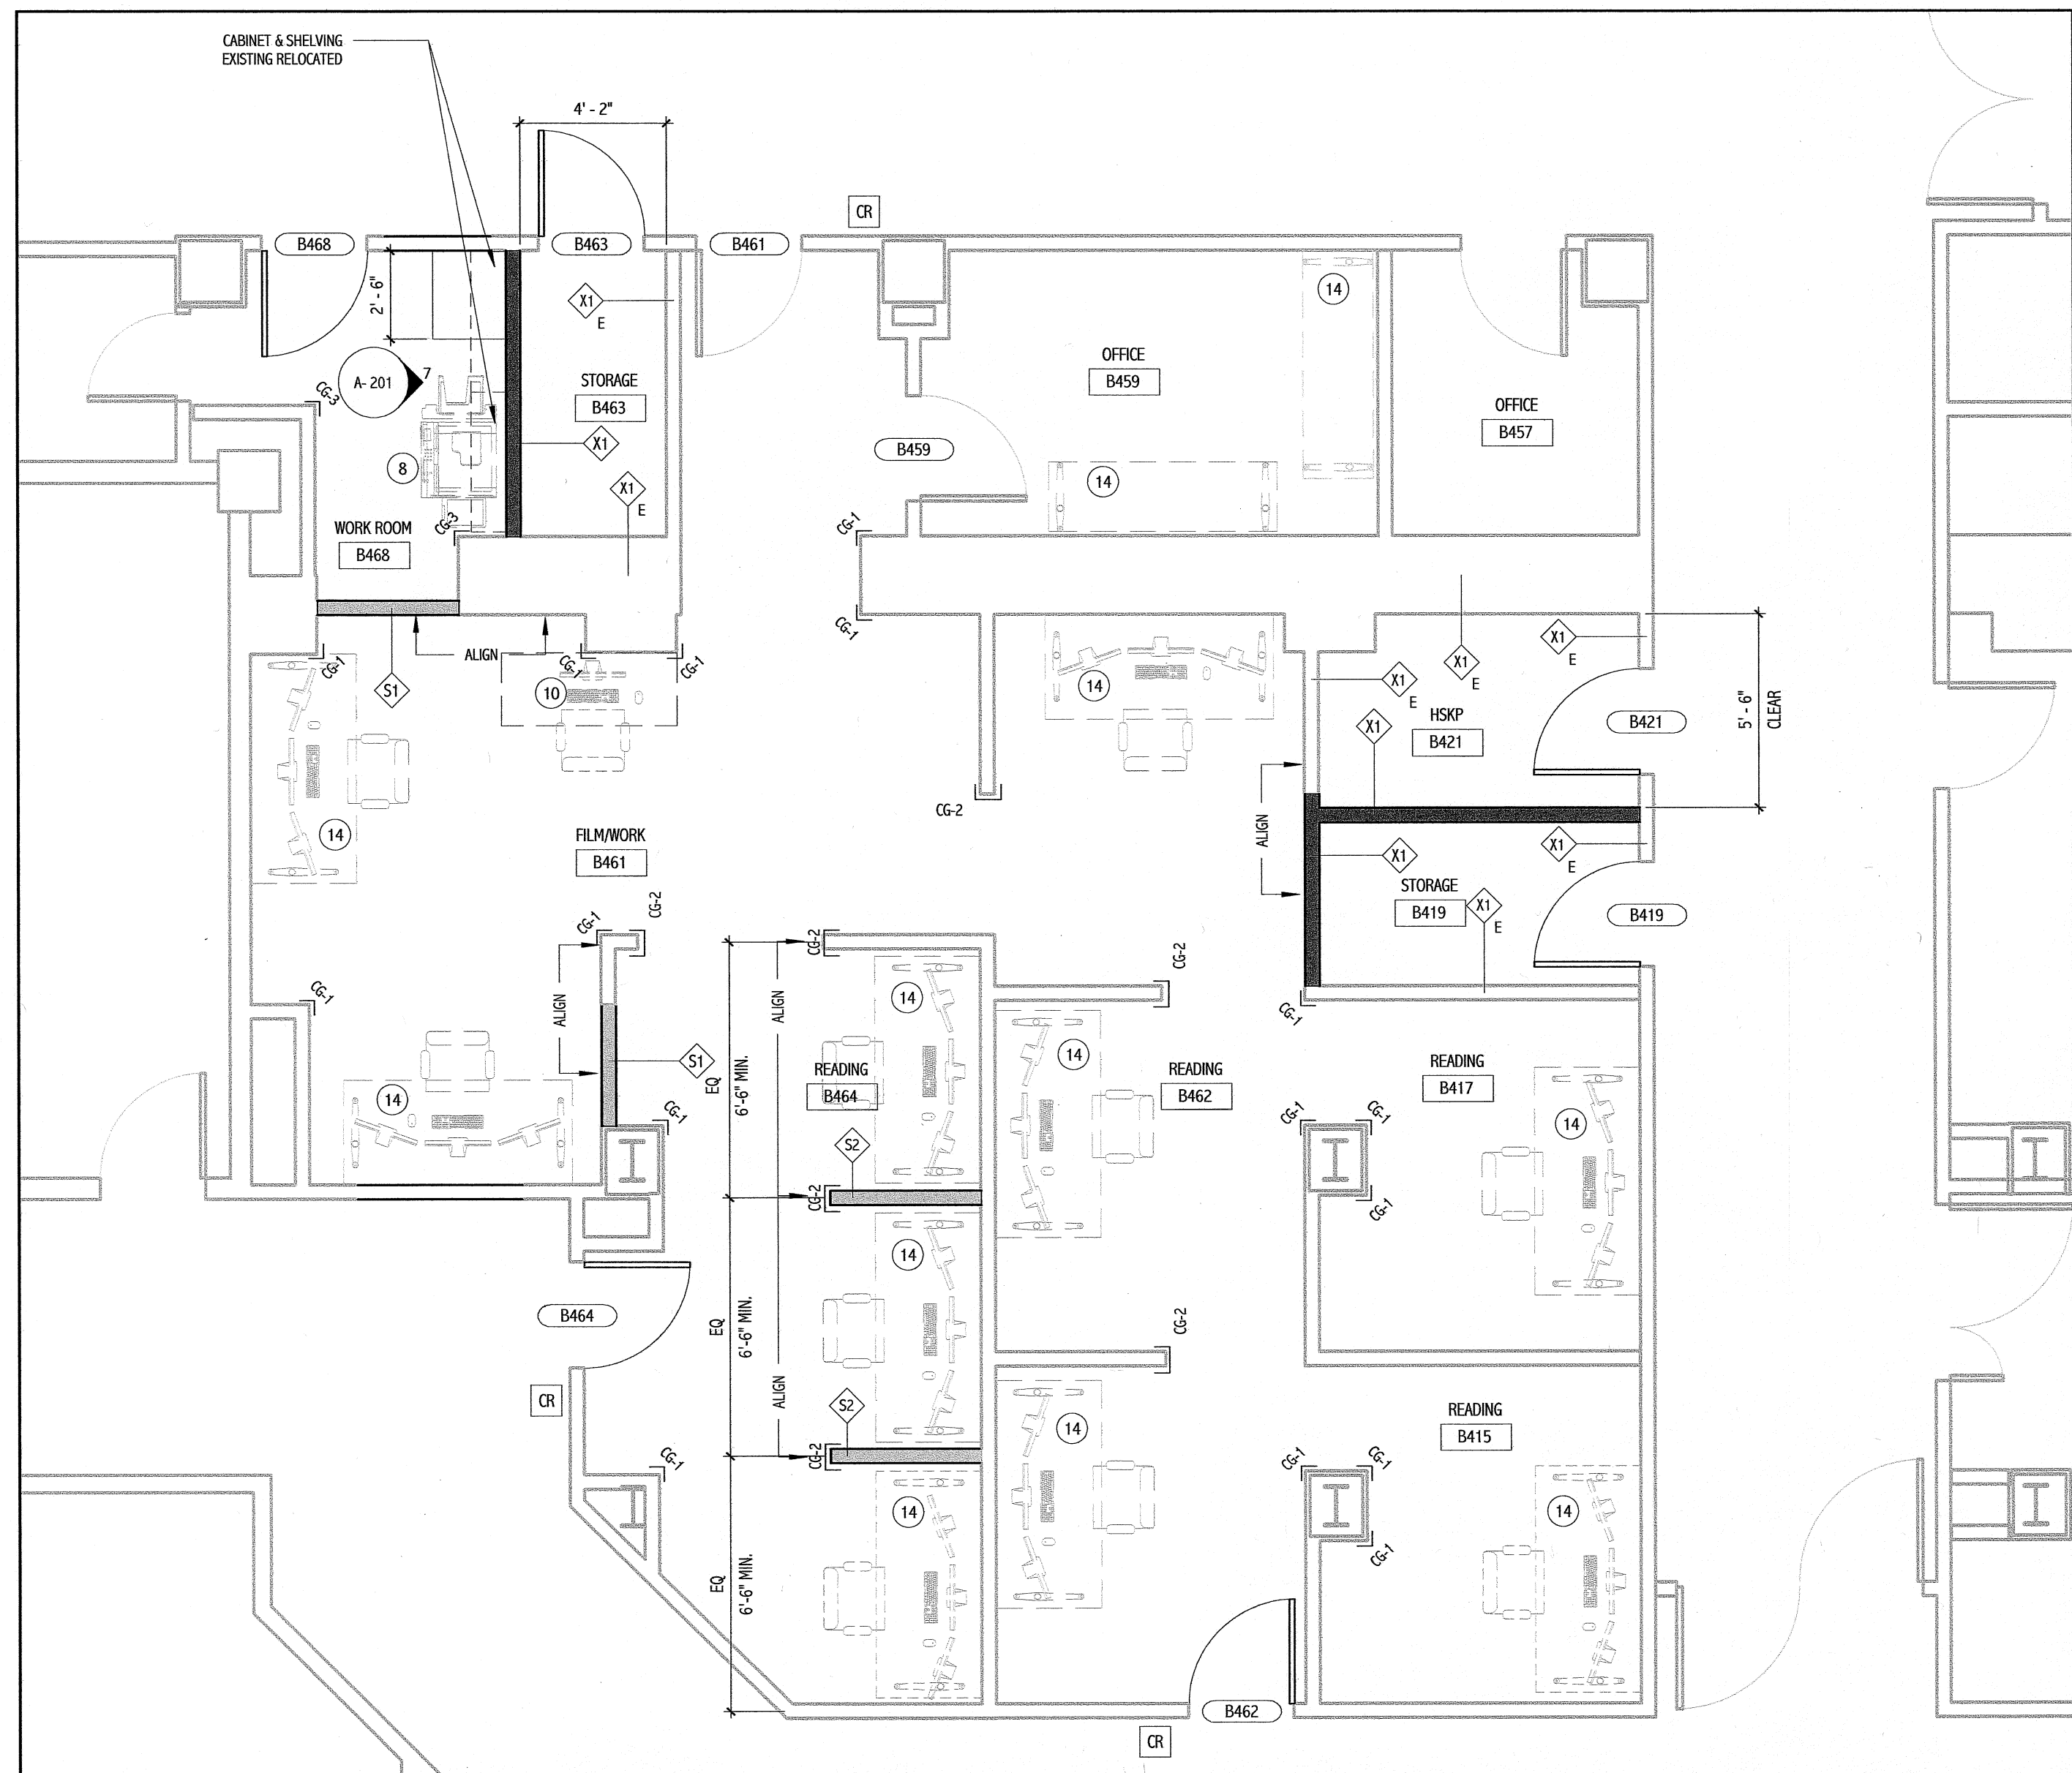

2 FLUORO - READING ROOM FLOOR PLAN
1/4" = 1'-0"

GENERAL NOTES:

- SEE SHEET G-001 FOR LEGEND, ABBREVIATIONS AND GENERAL NOTES.
- FURNITURE/EQUIPMENT DASHED IN BY OTHERS IS INDICATED FOR COORDINATION. PROVIDE BLOCKING FOR ALL MOUNTED CASEWORK, FURNITURE, EQUIPMENT AND ANY OTHER NIC ITEMS.
- ALL OWNER PROVIDED KEYBOARD TRAYS AND CPU HOLDERS INSTALLED BY OTHERS.
- REFER TO FINISH SCHEDULES FOR WALL PROTECTION LOCATIONS.
- EXISTING INTERIOR PARTITIONS TO REMAIN EXCEPT WHERE WORK REQUIRES CUTTING, PATCHING AND FINISHING OF WALL TO ACCOMMODATE UTILITY LOCATION.
- WHERE CONSTRUCTION AFFECTS EXISTING LEAD SHIELDING, REPAIR SHIELDING TO PROVIDE THE EQUIVALENT OF 1/16" LEAD.

KEYED NOTES:

- COORDINATE WALL LOCATION WITH EXISTING RADIOLOGY READING STATION AND EXISTING BUILT-IN CASEWORK.
- VERIFY LOCATION OF MED GAS SHUT-OFF VALVE AND ASSOCIATED PIPING PRIOR TO WALL DEMO AND DOOR INSTALLATION. NOTIFY ARCHITECT IF PROPOSED DOOR LOCATION INTERFERES WITH EXISTING MED GAS PIPING.
- CONTRACTOR SHALL CARRY AN ALLOWANCE FOR TREATING WALLS WITH WATERPROOFING SYSTEM, TO BE VERIFIED DURING DEMOLITION PHASE.
- TABLE MOUNTING PLATE NOTES:**
A) TABLE MOUNTING PLATE (PROVIDED BY MANUFACTURER) WILL BE RECESSED INTO THE EXISTING SLAB-ON-GRADE, SO THAT TOP OF PLATE (0.781" THICKNESS) IS LEVEL WITH ADJACENT SLAB SURFACE. PROVIDE FINISHED SURFACE UNDER THE TABLE PLATE THAT IS LEVEL TO WITHIN 1/16" OVER A LENGTH OF 39". SELF-LEVELING NON-METALLIC PORTLAND CEMENT BASED GROUTS MAY BE USED (MIN COMPRESSIVE STRENGTH OF 10,000 PSI).
B) CONNECT TABLE MOUNTING PLATE TO SLAB WITH (6) 3/4" DIAMETER ASTM A36 THREADED RODS EPOXY SET TO THE SLAB WITH HITI HIT-HY 150; PROVIDE A 3" MINIMUM CONCRETE EMBEDMENT. OBTAIN AND FOLLOW MANUFACTURER'S INSTALLATION DIRECTIONS AND REQUIREMENTS.

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STATE OF MAINE
8.24.10

PROJECT NORTH
↑
HUMAN SCALE

Bramhall Radiology
FLUORO RENOVATIONS
PORTLAND, ME

ISSUED FOR CONSTRUCTION 8.24.10

NO.	DATE	DESCRIPTION
0	8.24.10	ISSUED FOR CONSTRUCTION
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GRAPHIC SCALE:
0" 1"

SCALE: As indicated
PROJECT MANAGER: DIV
DRAWN BY: ART
DATE OF RECORD: DIV
PROJECT NO.: 09022-02
DATE: 8.24.10
SHEET TITLE: BASEMENT FLOOR PLAN

SHEET No. A-101