


1. F&I TWO (2) 4-PAIR UTP PLENUM-RATED BLUE CAT6A CABLE AND TERMINATED ON AN 8P8C ORTRONICS

2. TERMINATE ALL EMERGENCY TELEPHONE ON CAT-6A PATCH PANEL WITH T-568A PINNING.

3. ORTRONICS PART# OR-40800017 WITH COVER. (MOUNTING TO BE COORDINATED)

DATA FOR CAR CHARGER "FACEPLATE" DETAIL

SCALE: N.T.S.

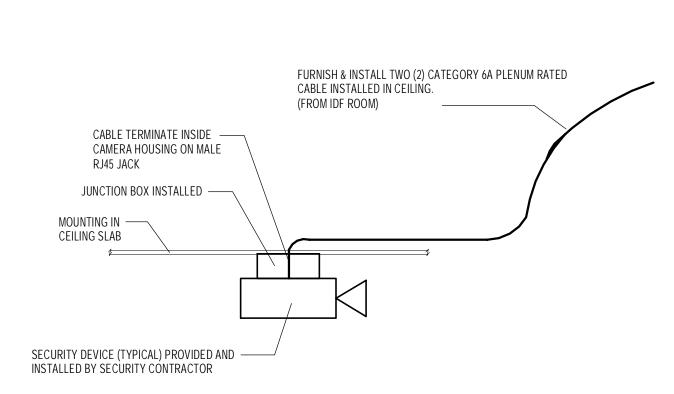

ORTRONICS TRACJACK BLUE 2. TERMINATE ALL WALL-PHONE ON CAT-6A PATCH PANEL WITH T-568A PINNING. 3. STAINLESS STEEL FACEPLATE TO BE PROVIDED WITH WALL PHONE MOUNTING STUDS. 4. PROVIDE PRINTED LABELS. HANDWRITTEN LABELS ARE UNACCEPTABLE.

6 WALL TELEPHONE "FACEPLATE" DETAIL
SCALE: N.T.S.

4. PROVIDE PRINTED LABELS. HANDWRITTEN LABELS ARE UNACCEPTABLE.

2 - PORT OUTLETS

3 TYPICAL SECURITY OUTLET DETAIL SCALE: N.T.S.

BROWN

1 2 3 4 5 6 7 8

CONDUCTOR

PAIR 1 (T)

PAIR 1 (R)

PAIR 2 (T)

PAIR 2 (R)

PAIR 3 (T)

PAIR 3 (R)

PAIR 4 (T)


PAIR 4 (R)

IDENTIFICATION


| CAT-6A UTP PATCH PANEL CAT-6A UTP PATCH PANEL CAT-6A UTP PATCH PANEL CAT-6A UTP PATCH PANEL PNL-1 DODOOO DO DOO DO DOO DO DOO DO DOO DO DO | / |
|---|---|
| PATCH PANEL LABELING NUMBER & CONSECUTIVE NUMBERING FROM TOP TO BOTTOM OF EACH RACK (TYPICAL) TOP VIEW PATCH PANEL LABELING NUMBER & CONSECUTIVE NUMBERING FROM TOP TO BOTTOM OF EACH RACK (TYPICAL) PNL-2 1 2 3 4 5 6 7 8 9 10 11 12 TOP VIEW NOTES: | |
| 1 HITHER ALL CHIPPORT DEVICES DROWDED WITH DATCH DANGES | |

- 1. UTILIZE ALL SUPPORT DEVICES PROVIDED WITH PATCH PANELS. 2. UTILIZE VELCO TIE WRAPS TO SECURE WIRING TO SUPPORT BAR. PLASTIC CABLE TIES WILL NOT BE ACCEPTED. 3. INSTALL WHITE NUMBERED ICONS AS SHOWN ON PATCH PANEL. NUMBERED ICONS
- COINCIDE WITH ICONS ON FACEPLATES. 4. NEW PATCH PANELS SHALL BE CATEGORY 6A WITH 8-PORT MODULES. 5. 'A' JACKS SHALL HAVE BLUE DATA ICONS & 'B' JACKS SHALL HAVE BLUE DATA ICONS AT
- JACK / PORT "FACEPLATE" STATION AND ON THE TELECOM ROOM PATCH PANEL

| / | | PATCH PANEL LABELLING & SUPPORT DETAIL SCALE: N.T.S. |
|---|---|--|
| (| 5 | SCALE: N.T.S. |

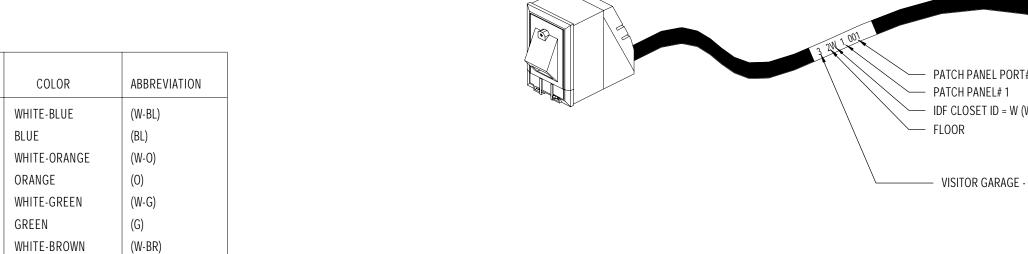

- ENDS. HANDWRITTEN LABELS SHALL BE CONSIDERED UNACCEPTABLE.
- EXTEND TO WITHIN 1/2" OF TERMINATION POINT.
- 3. JACKS AND OTHER TERMINATION DEVICES SHALL BE INSTALLED INCLUSIVE OF ALL HARDWARE INCLUDING, BUT NOT LIMITED TO DUST CAPS, ICONS, ETC..

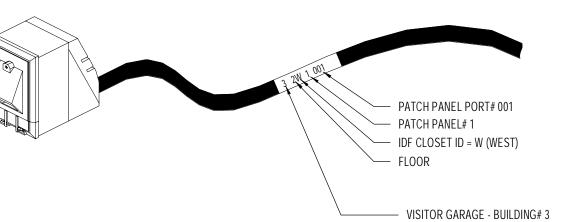

- 1. PROVIDE COMPUTER GENERATED LABEL 6 INCHES FROM TERMINATION AT BOTH
- 2. MAINTAIN PAIR TWIST UP TO FINAL TERMINATION POINT. CABLE JACKET SHALL

PERKINS

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CONSULTANTS

CIVIL/ LANDSCAPE ARCHITECT Sebago Technics 75 John Roberts Road, Suite 1A, South Portland ME 04106

STRUCTURAL ENG/ BUILDING ENVELOPE CONSULTANT Simpson Gumpertz & Heger Inc. 41 Seyon Street, Building 1, Suite 500, Waltham MA 02453 MEPFP ENGINEER/ CODE AKF Group LLC

99 Bedford Street, 2nd Floor, Boston MA 02111 CONSTRUCTION MANAGER **Turner Construction**


ELEVATOR CONSULTANT VDA (Van Deusen & Associates) 101 Summer Street, 4th Floor, Boston MA

2 Seaport Lane, Suite 200, Boston MA 02210

COST ESTIMATOR D. G. Jones International 3 Baldwin Green Common, Suite 202, Woburn MA 01801

PROJECT TITLE

Visitor Garage **Expansion** 22 Bramhall Street Portland ME 04102

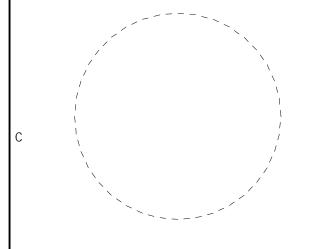

KEY PLANS

PROJECT KEY PLAN

OVERALL KEY PLAN 1 - NOT USED 2 - CONGRESS STREET 3 - VISITOR GARAGE 4 - EAST TOWER 5 - CENTRAL UTILITY PLANT 6 - BEAN BUILDING 7 - RICHARDS BUILDING

CONSTRUCTION DOCUMENT SET SEPTEMBER 29, 2017

PERMIT SET DESIGN DEVELOPMENT 08.25.17 Checked

COMMUNICATIONS **DETAILS**

SHEET NUMBER

T00-11

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