

ROOM FINISH SCHEDULE

ROOM NUMBER	ROOM NAME	FLOOR	BASE	WALLS				CEILING		ROOM NUMBER	REMARKS
				NORTH	SOUTH	EAST	WEST	MATERIAL	HEIGHT		
B320	STAFF BREAK	RUB-1+2	RB-1	PTD-1	PTD-5	PTD-1+5	PTD-1	ACT-2	8'-0"	B320	
B321	OFFICE	RUB-1	RB-1	PTD-1	PTD-1	PTD-1	PTD-1	ACT-2	8'-0"	B321	
B322	STAFF TOILET	SV-1	RB-1	PTD-1	PTD-1	PTD-1	PTD-3	ACT-2	8'-0"	B322	
B323	UNUSED	SC	-	-	-	-	-	EXISTING	EXISTING	B323	
B324	INJECTION	RUB-1	FC	PTD-1	PTD-1/WP*	PTD-1/WP*	PTD-1	ACT-2	8'-0"	B324	*WP-1 TO 5'-0" AFF
B325	READING	CPT-1	RB-1	PTD-6	PTD-6	PTD-6	PTD-6	ACT-1	8'-0"	B325	
B325a	READING	CPT-1	RB-1	PTD-6	PTD-6	PTD-6	PTD-6	ACT-1	8'-0"	B325a	
B327	EUS ROOM	EXISTING	EXISTING	EXISTING	EXISTING	EXISTING	EXISTING	EXISTING	EXISTING	B327	
B328	HOT LAB	RUB-1	FC	PTD-1	PTD-1/WP*	PTD-1/WP*	PTD-1/WP*	ACT-2	8'-0"	B328	*WP-1 TO 5'-0" AFF
B328a	STORAGE	RUB-1	FC	PTD-1	PTD-1	PTD-1	PTD-1	ACT-2	8'-0"	B328a	
B330	MECHANICAL	EXISTING	EXISTING	EXISTING	EXISTING	EXISTING	EXISTING	EXISTING	EXISTING	B330	
B331	CAMERA #3	EXISTING	EXISTING	EXISTING	EXISTING	EXISTING	EXISTING	EXISTING	EXISTING	B331	
B332	CONTROL	RUB-1	RB-1	-	PTD-4	PTD-4	PTD-4	ACT-2	8'-0"	B332	
B333	TOILET	SV-1	RB-1	PTD-3	PTD-1	PTD-1	PTD-1	ACT-2	8'-0"	B333	
B334	SPECT/CT #2	RUB-1-3	RB-1	PTD-1+3	PTD-1	PTD-3/WP*	PTD-1	ACT-2	9'-0"	B334	*WP-1 TO 5'-0" AFF
B335	POWER CONDITIONER	EXISTING	RB-1	PTD-1	PTD-1	PTD-1	PTD-1	ACT-2	8'-0"	B335	
B337	CAMERA #1	EXISTING	EXISTING	EXISTING	EXISTING	EXISTING	EXISTING	EXISTING	EXISTING	B337	
B338	STORAGE	EXISTING	RB-1	PTD-1	PTD-1	PTD-1	PTD-1	ACT-2	EXISTING	B338	
B339	TREADMILL ROOM	EXISTING	EXISTING	EXISTING	EXISTING	EXISTING	EXISTING	EXISTING	EXISTING	B339	
B340	SOILED	EXISTING	EXISTING	EXISTING	EXISTING	EXISTING	EXISTING	EXISTING	EXISTING	B340	
GC-B22	CORRIDOR	EXISTING	EXISTING	EXISTING	EXISTING	EXISTING	EXISTING	EXISTING	EXISTING	GC-B22	
GC-B29	CORRIDOR	EXISTING	EXISTING	EXISTING	EXISTING	EXISTING	EXISTING	EXISTING	EXISTING	GC-B29	
DC-B-NM1	CORRIDOR	RUB-1-3	RB-1	PTD-4	PTD-1	PTD-4	PTD-1	ACT-2	8'-0"	DC-B-NM1	
DC-B-NM2	CORRIDOR	RUB-1-3	RB-1	PTD-1	PTD-1	PTD-1	PTD-1	ACT-2	8'-0"	DC-B-NM2	
ST-B17	STAIR	EXISTING	EXISTING	EXISTING	EXISTING	EXISTING	EXISTING	EXISTING	EXISTING	ST-B17	

FINISH ABBREVIATIONS:

ACT	ACOUSTICAL CEILING TILE	RCP	REFLECTED CEILING PLAN
CC	CUBICLE CURTAIN	RUB	RUBBER SHEET FLOORING
CG	CORNER GUARD	SC	SEALED CONCRETE
CPT	CARPET	SSM	SOLID SURFACE MATERIAL
EXIST	EXISTING TO REMAIN	SV	SHEET VINYL FLOORING
EXP	EXPOSED STRUCTURE	VCT	VINYL COMPOSITION TILE
FC	FLASH COVE	WD	WOOD
GWB	GYP/SUM WALLBOARD		
PLAM	PLASTIC LAMINATE		
PTD	PAINTED		
WP	WALL PROTECTION		
RB	RUBBER BASE		

FINISH LEGEND:

ACOUSTICAL CEILING TILE
 ACT-1 USG, FROST CLIMAPLUS #414, 24x24x3/4", INTEGRAL COLOR: BLACK 205, SUSPENSION SYSTEM: 15/16" DONN DX/DXL, COLOR: FLAT BLACK 205 (NONFERROUS ATTACHMENT COMPONENTS REQUIRED), USG, MARS CLIMAPLUS #B6985, 24x24x3/4", COLOR: WHITE, SUSPENSION SYSTEM: 15/16" DX/DXL, ALUMINUM HANGER WIRES AND ALUMINUM AX GRID, COLOR: WHITE

CARPET
 CPT-1 TANDUS FLOORING, 24x24-INCH TILE, ANTRON 6,6 LEGACY NYLON, 03310 MERISTEM, COLOR: 13218 CATKIN, TO BE INSTALLED MONOLITHICALLY.

CORNER GUARD
 CG-1 C/S ACROVYN 90-DEGREE, SM SERIES, 2-INCH WING APPLIED, COLOR: MISSION WHITE.

CUBICLE CURTAIN
 *PROVIDE CURTAIN TRACK SYSTEM BY 'ON THE RIGHT TRACK.'
 CC-1 STANDARD TEXTILE CO., INC., 100% POLYESTER, PASSES NFPA 701, RAILROADED (STRIPES TO RUN VERTICALLY), LUCKY STRIPE (01), COLOR: SANDOLLAR.

PAINT - REFERENCE MAINE MEDICAL CENTER'S SHERWIN WILLIAMS CUSTOM MANUAL COLOR PALETTE, UNLESS NOTED OTHERWISE
 PTD-1 (FIELD) ANTIQUE WHITE.
 PTD-2 (DOOR/WINDOW TRIM) MEDIUM TAUPE.
 PTD-3 (ACCENT) SOUVENIER.
 PTD-4 (ACCENT) BLUE DOOR.
 PTD-5 (ACCENT) CHEMAYO SAGE.
 PTD-6 (READING ROOMS ONLY) TO MATCH ICI COLOR; DARK SECRET (162).

PLASTIC LAMINATE
 PLAM-1 (VERTICAL CASEWORK SURFACES) PIONITE, HONEY MAPLE, WM951 SUEDE.

RUBBER BASE
 RB-1 JOHNSONITE, TRADITIONAL WALL BASE, 4-INCH HEIGHT, USE MANUFACTURER'S LONGEST AVAILABLE COIL LENGTH, COLOR: FAWN (80).

RUBBER SHEET FLOORING
 *USE TWO-PART ADHESIVE SYSTEM RECOMMENDED BY MANUFACTURER FOR RESISTANCE TO HEAVY, ROLLING LOADS.
 RUB-1: NORA, NORAPLAN ENVIRONCARE, 3.0MM SHEET, HEAT-WELDED SEAMS, COLOR: SILVER CROWN (2784).
 RUB-2: NORA, NORAPLAN ENVIRONCARE, 3.0MM SHEET, HEAT-WELDED SEAMS, COLOR: DRIFTWOOD (2787).
 RUB-3: NORA, NORAPLAN ENVIRONCARE, 3.0MM SHEET, HEAT-WELDED SEAMS, COLOR: EVENING BLOOM (2942).

SHEET VINYL FLOORING
 SV-1: MANNINGTON COMMERCIAL, ASSURANCE II, HEAT-WELDED SEAMS, COLOR: PUTTY (16307).

SOLID SURFACE MATERIAL
 SSM-1: CORIAN, DOESKIN.

GENERAL FINISH NOTES:

- SEE MANUFACTURER'S SPECIFICATIONS FOR ADDITIONAL INFORMATION REGARDING FINISH MATERIALS.
- MATERIALS IN FINISH LEGEND ARE FROM MAINE MEDICAL CENTER'S FINISH STANDARDS. SUBSTITUTIONS WILL NOT BE ACCEPTED.
- DOOR AND WINDOW FRAMES TO BE PTD-2.
- REFER TO RCP FOR SOFFIT HEIGHTS. ALL SOFFITS TO BE PTD TO MATCH ADJACENT WALL COLOR, U.N.O.
- ALL GYP. CEILINGS TO BE PTD-1 UNLESS NOTED OTHERWISE.
- ALL EXPOSED STRUCTURE TO BE PAINTED, UNLESS NOTED OTHERWISE.
- REFER TO INTERIOR ELEVATION SHEETS FOR ADDITIONAL INFORMATION REGARDING ACCESSORIES AND EQUIPMENT.
- ALL AREAS DISTURBED DURING CONSTRUCTION SHALL BE PATCHED TO MATCH EXISTING FINISHES.
- CORNER GUARD (CG) HEIGHT TO EXTEND FROM TOP OF BASE TO TOP OF DOOR FRAME (7'-2", TYPICAL).
- ALL WALLS TO BE PTD-1, UNLESS NOTED OTHERWISE.
- SEE FINISH PLAN (AF101) FOR ADDITIONAL INFORMATION REGARDING LOCATION OF FINISHES, INCLUDING CLARIFICATION OF PAINTED ACCENT WALLS.
- CONTRACTOR TO PERFORM ALKALINITY AND ADHESION TESTS (ASTM F 1869 & 2170) RECOMMENDED BY FLOORING MANUFACTURER FOR EACH TYPE OF FLOORING. PROCEED WITH INSTALLATION ONLY AFTER SUBSTRATES PASS TESTING. VERIFY RESULTS WITH FLOORING MANUFACTURER. CONTRACTOR TO CARRY ALLOWANCE FOR TOPICAL TREATMENT IF REQUIRED, KOESTER OR EQUAL.

FINISH LEGEND CON'T:

WALL PROTECTION
 WP-1: C/S ACROVYN, PEBLETTE TEXTURE, .060" THICKNESS, PROVIDE HORIZONTAL AND VERTICAL TRIM ACCESSORIES AS REQUIRED FOR COMPLETE INSTALLATION, COLOR: MISSION WHITE.

VINYL COMPOSITION TILE
 VCT-1: ARMSTRONG, STANDARD EXCELON, IMPERIAL TEXTURE, 12x12-INCH TILE, COLOR: TBD.

WOOD (DOORS)
 WD-1: MATCH EXISTING WOOD SPECIES, CUT AND FINISH

DOOR SCHEDULE

DOOR NUMBER	DOOR				GLAZING	FRAME				HWS	FIRE RATING (MIN.)	DOOR NUMBER	NOTES
	SIZE	MATERIAL	ELEVATION			MATERIAL	ELEVATION	HEAD	JAMB				
B320	3'-0"x7'-0"	WD	NG	TEMP	HM	1	A1/AE601	A3/AE601		1		B320	
B321	3'-3"x7'-0"	WD	NG	TEMP	HM	1	A1/AE601	A3/AE601		1		B321	
B322	3'-0"x7'-0"	WD	F	*	HM	1	A1/AE601	A3/AE601		4		B322	
B323	EXISTING									3		B323	
B324	3'-8"x7'-0"	WD	NG	TEMP	HM	1	A1/AE601	A3/AE601		5		B324	BADGE ACCESS
B325a	3'-0"x7'-0"	WD	F	*	HM	1	A1/AE601	A3/AE601		1		B325a	
B325b	3'-0"x7'-0"	WD	F	*	HM	1	A1/AE601	A3/AE601		1		B325b	
B325c	3'-0"x7'-0"	WD	F	*	HM	1	A1/AE601	A3/AE601		1		B325c	
B328	3'-0"x7'-0"	WD	NG	TEMP	HM	1	A1/AE601	A3/AE601		5		B328	1/16" LEAD LINENED, BADGE ACCESS
B328a	3'-0"x7'-0"	WD	NG	TEMP	HM	1	A1/AE601	A3/AE601		3		B328a	
B327	EXISTING											B327	
B333	3'-8"x7'-0"	WD	F	*	HM	1	A1/AE601	A3/AE601		4		B333	
B335	3'-0"x7'-0"	WD	F	*	HM	1	A1/AE601	A3/AE601		3		B335	
B334	(1)1'-6", (1) 3'-8"x7'-0"	WD	F	*	HM	1	A1/AE601	A3/AE601		6		B334	1/16" LEAD LINENED
B338	3'-0"x7'-0"	WD	F	*	HM	1	A1/AE601	A3/AE601		3		B338	

GENERAL DOOR NOTES:

- SEE TITLE SHEET G001 FOR STANDARD ABBREVIATIONS.
- ALL SWINGING DOORS TO BE 1-3/4" THICK (U.N.O.).
- ALL DOORS SHALL BE 3/4" UNDERCUT (TYPICAL) EXCEPT WHEN THERE IS A BOTTOM FRAME OR SILL THRESHOLD OR SPECIFICALLY NOTED OTHERWISE.
- ALL DOORS WITH BOTTOM FRAMES OR SILL THRESHOLDS SHALL HAVE MANUFACTURER'S RECOMMENDED STANDARD UNDERCUT.
- GLAZING NOTED ON DOOR SCHEDULE IS FOR THE DOOR AND SIDELIGHTS IN THE FRAME (TYPICAL).
- REFER TO FLOOR PLAN FOR NOTES ON EXISTING DOORS.
- WOOD DOORS SPECIES/FINISH TO MATCH EXISTING.
- HARDWARE FINISH TO MATCH EXISTING.
- DOOR HARDWARE TO MATCH EXISTING. REUSE HARDWARE WHERE POSSIBLE.

KEYED NOTES:


- EXISTING DOOR, FRAME, AND HARDWARE REINSTALLED AT NEW LOCATION

DOOR ABBREVIATIONS:

AL/ALUM	ALUMINUM	S/S	STAINLESS STEEL
HM	HOLLOW METAL	STL	STEEL
LAM	LAMINATED	TEMP	TEMPERED GLASS
INS	INSULATED	WIRE	WIRE GLASS
WD	WOOD	R/E	RE-USE EXISTING

HARDWARE SETS:

- HWS 1: (OFFICE) EACH LEAF TO HAVE:** HINGES, LOCKSET(OFFICE FUNCTION), WALL STOP, PROVIDE ACOUSTICAL GASKETING ALL SIDES
- HWS 2: (PASSAGE FUNCTION): EACH LEAF TO HAVE:** HINGES, LOCKSET(PASSAGE FUNCTION), CLOSER
- HWS 3: (STOREROOM) EACH LEAF TO HAVE:** HINGES, LOCKSET(STORAGE FUNCTION, CLOSER, KICKPLATE, WALL STOP, PROVIDE FLUSH BOLT AT DOOR HEAD OF INACTIVE LEAF.
- HWS 4: (PRIVACY) PRIVACY LOCKSET, HINGES, WALL STOP, SILENCERS**
- HWS 5: (BADGE ACCESS) HINGES, LOCKSET, WALL STOP, BADGE ACCESS BY OWNER**
- HWS 6: (CLINICAL SPACE) HINGES, LOCKSET, WALL STOP**

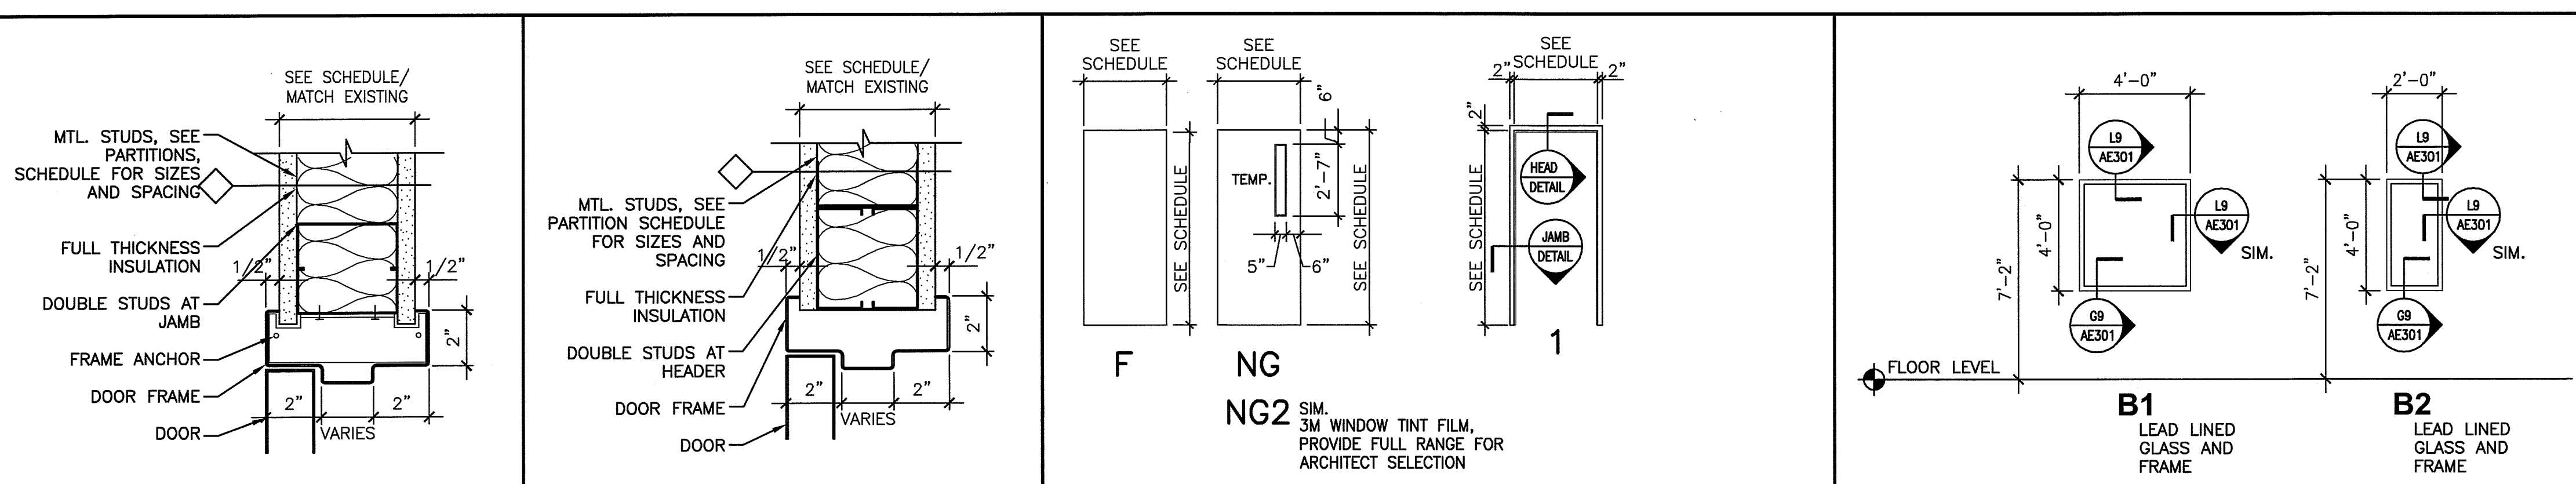

A1	DOOR HEAD	A3	DOOR JAMB	A5	DOOR AND FRAME ELEVATIONS	A9	BORROWED LITE ELEVATIONS
3'-1'-0"	*	3'-1'-0"	*	1/4"=1'-0"	*	1/4"=1'-0"	*

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 NUCLEAR MEDICINE RENOVATIONS
 PORTLAND, MAINE

ISSUED FOR CONSTRUCTION
 3-13-14

NO.	ISSUED FOR CONSTRUCTION	DATE
0		3-13-14

GRAPHIC SCALE:
 0" 1"

SCALE: 1/4"=1'-0"

PROJECT MANAGER: DJV
 JC/DRAWN BY: MDR
 A/E OF RECORD: DJV
 CAD FILE: AE601-13128
 PROJECT NO: 13128
 DATE: 3-13-14
 SHEET TITLE: SCHEDULES

SHEET No.
AE601
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