

MAINE MEDICAL CENTER

MRI #1 REPLACEMENT AND READING ROOM RENOVATIONS

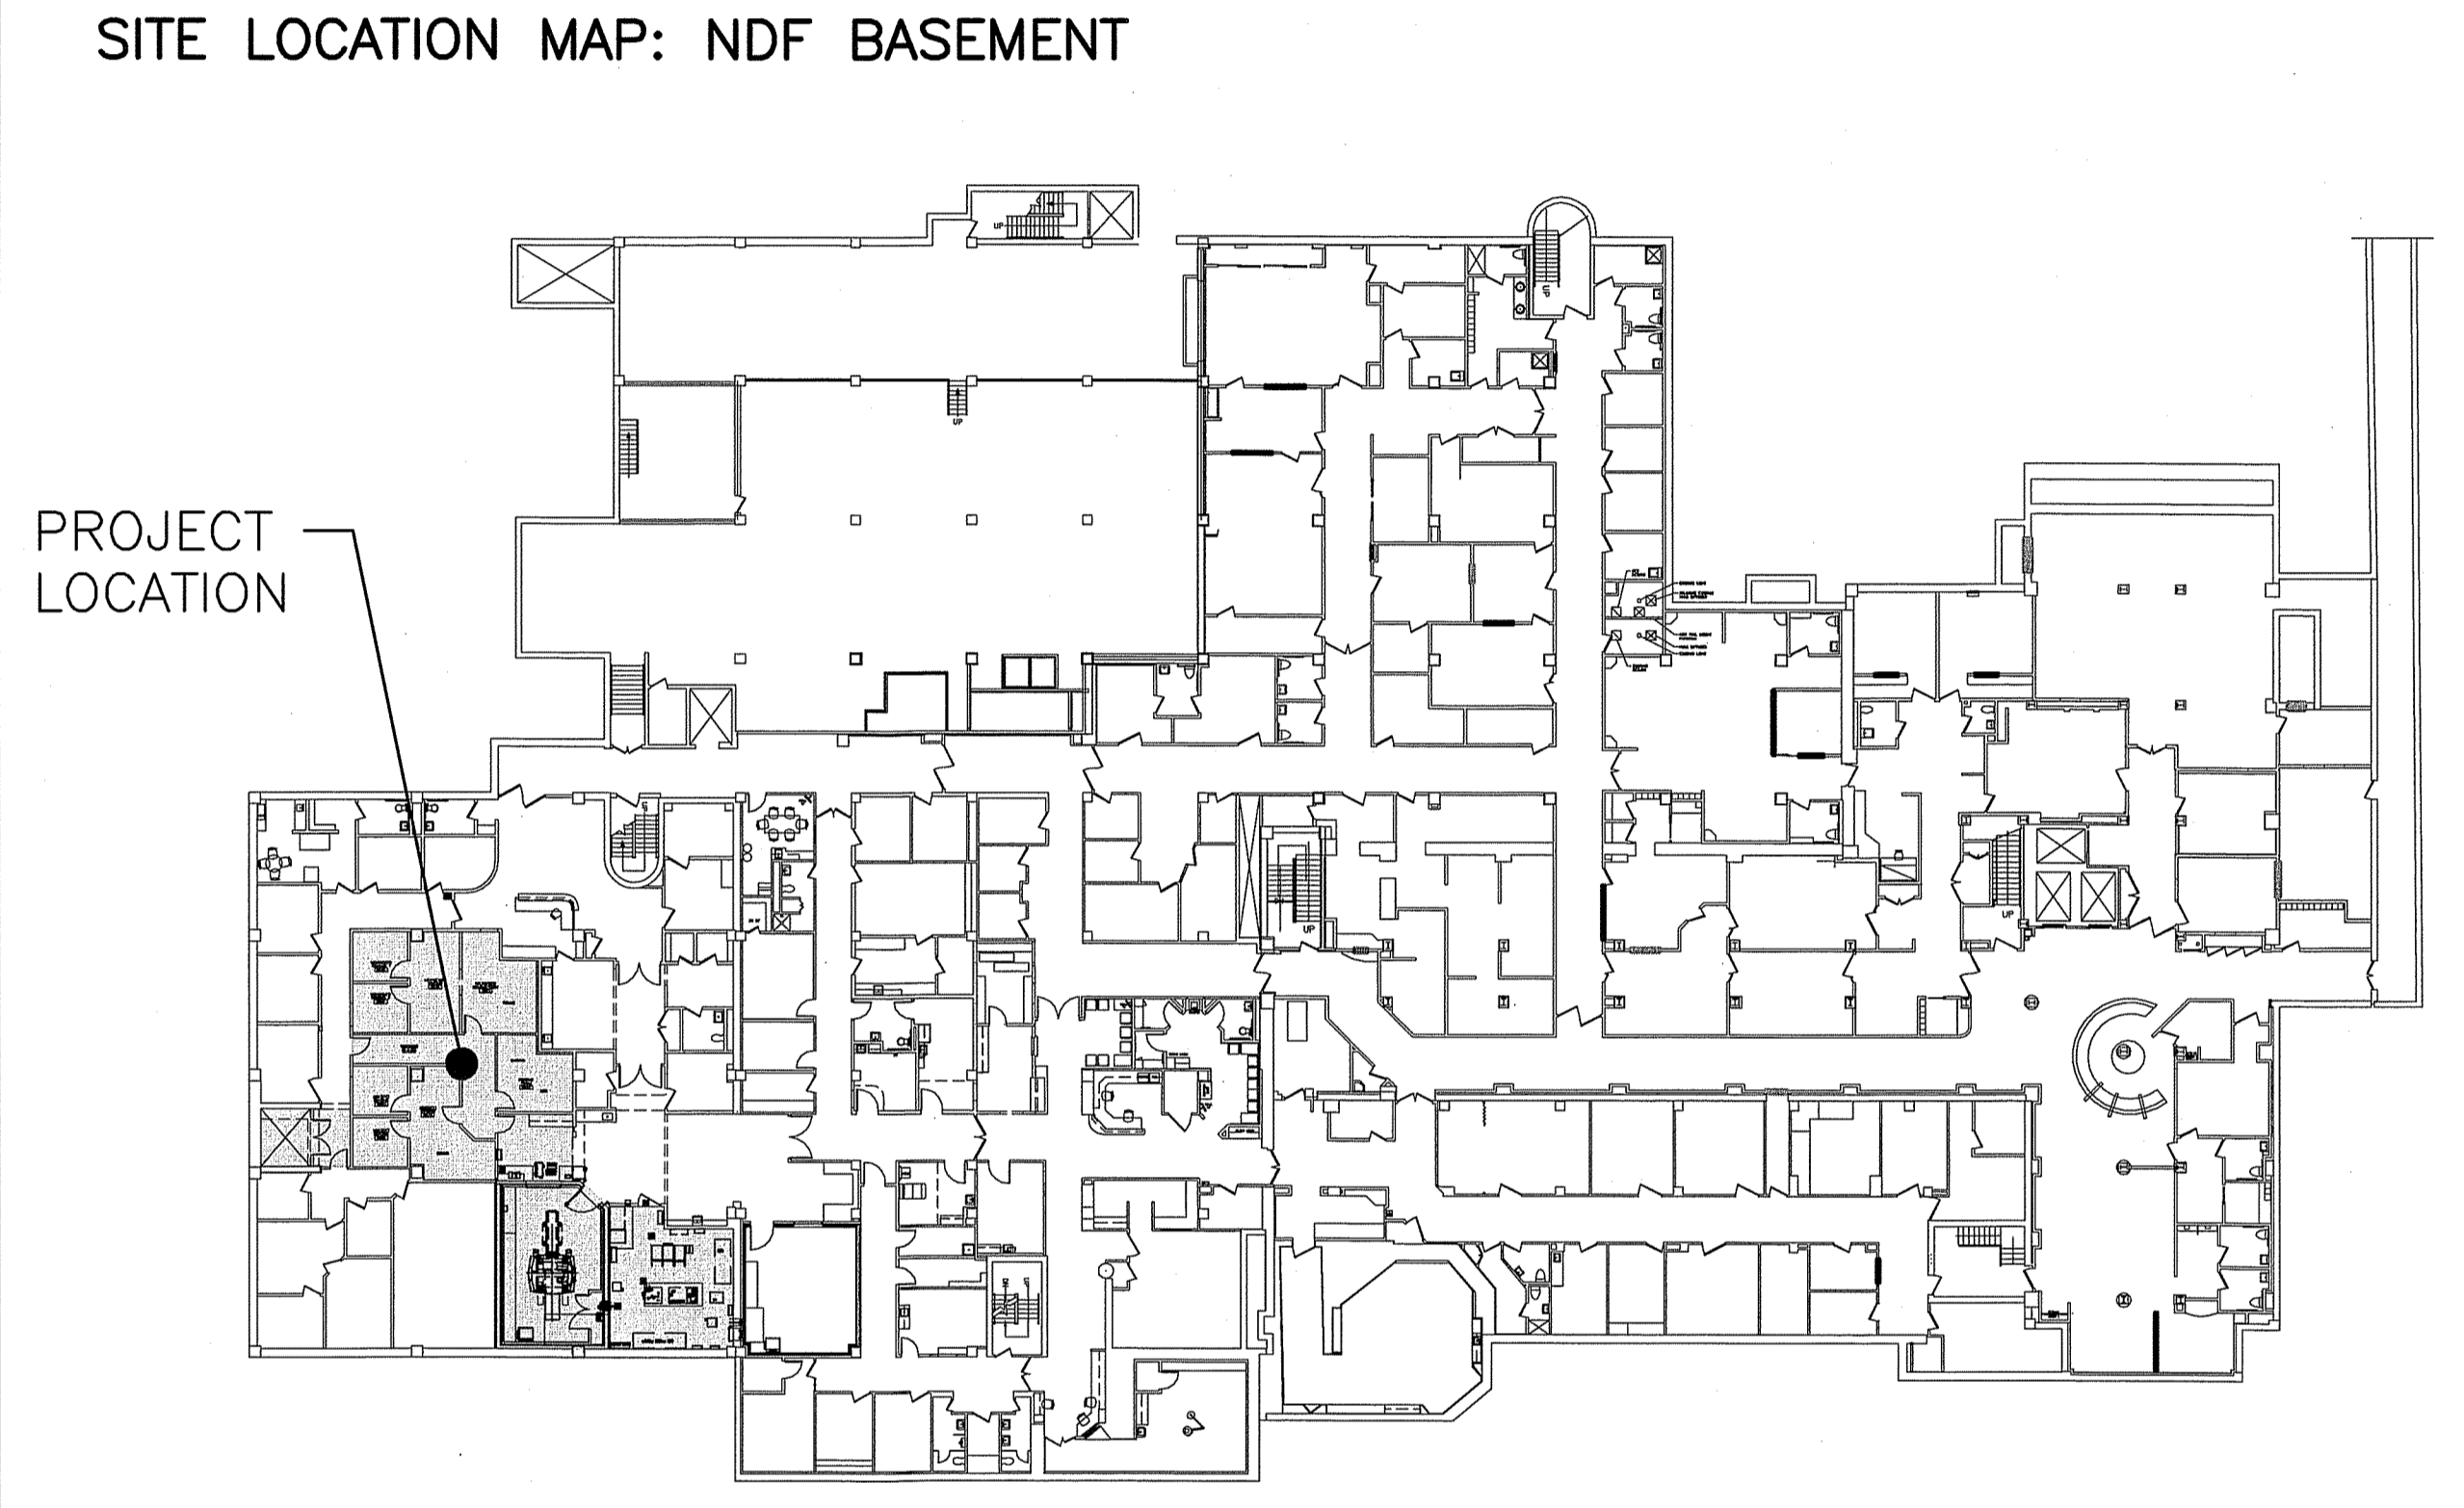
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ARCHITECTURE
ENGINEERING
PLANNING
INTERIOR DESIGN
COMMISSIONING

SMART

A/C	AIR CONDITIONING	ACPLAS	ACOUSTICAL PLASTER	ACT	ACOUSTIC CEILING TILE	AFF	ABOVE FINISHED FLOOR ACCESS PANEL	AP	ACCESS PANEL				
BCE	BOTTOM CHORD EXTENSION BOARD	BD	BOARD	BLP	BORROWED LIGHT PANEL	BO	BOTTOM OF FOOTING	BOF	BOTTOM OF FOOTING	BOS	BOTTOM OF STEEL		
BS	BOTH SIDES	BSE	BSBRICK SHELF ELEVATION	C	CHANNEL	CB	CATCH BASIN; CHALKBOARD	CFM	CUBIC FEET PER MINUTE	CJ	CONTROL JOINT; CONSTRUCTION JOINT		
CLG	CEILING	CMU	CONCRETE MASONRY UNIT	CT	CERAMIC TILE	CUH	CABINET UNIT HEATER	DF	DRINKING FOUNTAIN	DR	DISPLAY RAIL	DW	DISHWASHER
EF	EXHAUST FAN; EACH FACE	EJ	EXPANSION JOINT	EPDM	ETHYLENE PROPYLENE DIENE MONOMER	EW	ELECTRIC WATER COOLER	EWC	ELECTRIC WATER COOLER	FB	FLAT BAR		
FBO	FURNISHED BY OTHERS	FCO	FLOOR CLEAN-OUT	FD	FLOOR DRAIN	FE	FIRE EXTINGUISHER	FF	FINISHED FLOOR; FAR FACE	FO	FRAMED OPENING	FS	FAR SIDE
GB	GRAB BAR	GC	GENERAL CONTRACTOR	GDT	GYP-SUM DROP-IN TILE	GWB	GYP-SUM WALL BOARD	H	HORIZONTAL	HC	HANDICAPPED; HOLLOW CORE		
HM	HOLLOW METAL	HRU	HEAT RECOVERY UNIT	HT	HEIGHT	H&V	HEATING AND VENTILATING	HVAC	HEATING, VENTILATING AND AIR CONDITIONING	IF	INSIDE FACE		
IJ	ISOLATION JOINT	INV	INVERT	JS	JOIST SUBSTITUTE	L	ANGLE	LLH	LONG LEG HORIZONTAL	LLV	LONG LEG VERTICAL		
LP	LIGHTING PANEL; LIQUIFIED PROPANE	MB	MARKER BOARD	MDO	MEDIUM DENSITY OVERLAY	MO	MASONRY OPENING	MR	MOISTURE-RESISTANT	MUA	MAKE-UP AIR		
N	NOSING	NIC	NOT IN CONTRACT	NS	NEAR SIDE	NTS	NOT TO SCALE	OC	ON CENTER	OF	OUTSIDE FACE		
OH	OVERHEAD	PA	PUBLIC ADDRESS	PAF	POWDER-ACTUATED FASTENER	PLAM	PLATE	PLAM	PLASTIC LAMINATE	PLF	POUNDS PER LINEAR FOOT		
PP	POWER PANEL	PSF	POUNDS PER SQUARE FOOT	PSI	POUNDS PER SQUARE INCH	PT	PRESSURE-TREATED	PVC	POLYVINYL CHLORIDE	PWP	PLASCORE WALL PANEL		
R	RISER; RADIUS	RB	RESILIENT BASE	RD	ROOF DRAIN	RO	ROUGH OPENING	RR	RUB-RAIL	ACT	SUSPENDED ACOUSTIC TILE CEILING		
SBO	SUPPLIED BY OWNER	IBC	INSTALLED BY CONTRACTOR	SC	SOLID CORE	SCHD	SCHEDULE	SF	SQUARE FOOT; SUPPLY FAN	SK	SHEAR KEY		
SN	SANITARY NAPKIN (DISPENSER)	SP	SPACES	SS	STAINLESS STEEL	T	TREAD	TB	TACKBOARD	T&B	TOP AND BOTTOM		
TBM	TEMPORARY BENCHMARK	TCE	TOP CHORD EXTENSION	TJ	TIE JOIST	TO	TOP OF	TOC	TOP OF CONCRETE	TOM	TOP OF MASONRY		
TOW	TOP OF WALL	TOS	TOP OF STEEL; TOP OF SLAB	TOW	TOP OF WALL	TP	TOILET PAPER (DISPENSER)	TS	TILE	UH	UNIT HEATER		
UNO	UNLESS NOTED OTHERWISE	V	VENT PIPE; VERTICAL	VB	VAPOR BARRIER	VCT	VINYL COMPOSITION TILE	VP	VISION PANEL	VTR	VENT THROUGH THE ROOF		
W	WITH	WC	WATER CLOSET	WF	WIDE FLANGE	WH	WATER HEATER	W/O	WITHOUT	WP	WALL PROTECTION		
WS	WEB STIFFENER	WWF	WELODED WIRE FABRIC										



DRAWING LIST

GENERAL

G1001 COVER SHEET
G1002 PARTITION TYPES AND TYPICAL MOUNTING HEIGHTS

ARCHITECTURAL

A-100 PARTIAL FACILITY AND CODE COMPLIANCE PLAN
AD100 DEMOLITION FLOOR PLAN
AE100 FLOOR PLAN
AE110 REFLECTED CEILING PLAN
AE120 ROOF PLAN AND PARTIAL SITE PLAN
AE210 INTERIOR ELEVATIONS
AE301 SECTIONS AND DETAILS
AE500 CASEWORK DETAILS AND MISC. DETAILS
AE600 SCHEDULES

STRUCTURAL

S-101 PART PLANS, DETAILS, AND NOTES

ELECTRICAL

E-001 LEGEND AND GENERAL NOTES
E-002 SPECIFICATIONS
ED100 ELECTRICAL DEMOLITION PLAN
ED120 ROOF AND MECHANICAL ROOM DEMOLITION PLAN
E-100 STANDARD POWER PLAN
EP100 POWER PLAN
EP120 ROOF AND MECHANICAL ROOM POWER PLAN
EP401 ENLARGED POWER PLAN
EL100 LIGHTING PLAN
EY100 SYSTEMS PLAN

MECHANICAL

M-001 MECHANICAL LEGEND AND ABBREVIATIONS
M-002 MECHANICAL SPECIFICATIONS
MD100 MECHANICAL DUCTWORK DEMOLITION PLAN
MD101 MECHANICAL PIPING DEMOLITION PLAN
MH100 HVAC DUCTWORK PLAN
MP100 HVAC PIPING PLAN
M-401 MECHANICAL PART PLANS
M-501 MECHANICAL DETAILS
M-601 MECHANICAL SCHEDULES
M-651 PROCESS CHILLED WATER SCHEMATIC
M-652 CONTROL SYSTEM SCHEMATICS AND SEQUENCE OF OPERATIONS

PLUMBING

P-001 PLUMBING LEGEND, ABBREVIATIONS AND SCHEDULE
P-002 PLUMBING SPECIFICATIONS
P-003 PLUMBING SPECIFICATIONS
PD100 PLUMBING DEMOLITION PLAN
PL100 PLUMBING PLAN

GE MRI SITE PLANNING(FOR REFERENCE ONLY)

C1 SITE READINESS
A1 EQUIPMENT LAYOUT
S1 STRUCTURAL LAYOUT
S2 STRUCTURAL DETAILS
E1 ELECTRICAL LAYOUT
E2 ELECTRICAL SPECIFICATIONS
E3 ELECTRICAL DETAILS
E4 ELECTRICAL DETAILS
M1 MECHANICAL LAYOUT
D1 EQUIPMENT DETAILS
D2 EQUIPMENT DETAILS
D3 EQUIPMENT DETAILS

PROJECT NORTH

LICENSED ARCHITECT
DEREK J. VEILLEUX
No. 3185
STATE OF MAINE
9.20.13

MAINE MEDICAL CENTER
MRI #1 AND READING ROOM RENOVATION
PORTLAND, MAINE

ISSUED FOR CONSTRUCTION
9-20-13

CURRENT ISSUE STATUS:

DATE	DESCRIPTION	REV
9-20-13	ISSUED FOR CONSTRUCTION	0

GRAPHIC SCALE:
0" 1"

SCALE: 1/4"=1'-0"

PROJECT MANAGER: DJV
JC/DRAWN BY: MDR
A/E OF RECORD: DJV
CAD FILE: G1001-12118
PROJECT NO: 12118
DATE: 9-20-13

SHEET TITLE:
COVER SHEET

SHEET No.
G1001
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