

ROOM FINISH SCHEDULE

ROOM NUMBER	ROOM NAME	FLOOR	BASE	WALLS				CEILING		ROOM NUMBER	REMARKS
				NORTH	SOUTH	EAST	WEST	MATERIAL	HEIGHT		
B559	NEURO(RES) READING/CONF	CPT-1	RB-1	PTD-4	PTD-4	PTD-4	PTD-4	ACT-1	8'-0"	B559	
B574	EQUIPMENT ROOM	EXIST	EXIST	EXIST	EXIST	EXIST	EXIST	EXIST	EXIST	B574	
B576	MRI ROOM 1	RUB-1	RB-1	PTD-1	PTD-1	PTD-1	PTD-3	ACT-2	9'-6"	B576	
B576A	MRI CLOSET	RUB-1	RB-1	PTD-1	PTD-1	EXIST	EXIST	EXIST	EXIST	B576A	
B577	MRI CONTROL	RUB-1	RB-1	PTD-3	PTD-3	PTD-3	PTD-3	ACT-1	8'-0"	B577	
B578	READING ROOM	CPT-1	RB-1	PTD-4	PTD-4	PTD-4	PTD-4	ACT-1	8'-0"	B578	
B579	MSK(RES) READING	CPT-1	RB-1	PTD-4	PTD-4	PTD-4	PTD-4	ACT-1	8'-0"	B579	
B580	MSK(ATT) READING	CPT-1	RB-1	PTD-4	PTD-4	PTD-4	PTD-4	ACT-1	8'-0"	B580	
B581	MSK(ATT) READING	CPT-1	RB-1	PTD-4	PTD-4	PTD-4	PTD-4	ACT-1	8'-0"	B581	
B589	NEURO(RES) READING	CPT-1	RB-1	PTD-4	PTD-4	PTD-4	PTD-4	ACT-1	8'-0"	B589	
B591	NEURO(ATT) READING	CPT-1	RB-1	PTD-4	PTD-4	PTD-4	PTD-4	ACT-1	8'-0"	B591	
B594	NEURO(ATT) READING	CPT-1	RB-1	PTD-4	PTD-4	PTD-4	PTD-4	ACT-1	8'-0"	B594	
DC-B-MRI3	CORRIDOR	EXIST	EXIST	EXIST	EXIST	*PTD	EXIST	EXIST	EXIST	DC-B-MRI3	*PAINT TO MATCH EXISTING
DC-B-MRI3A	CORRIDOR	EXIST	EXIST	*PTD	EXIST	EXIST	EXIST	EXIST	EXIST	DC-B-MRI3A	*PAINT TO MATCH EXISTING
DC-B-MRI2	CORRIDOR	EXIST	EXIST	EXIST	*PTD	EXIST	EXIST	EXIST	EXIST	DC-B-MRI2	*PAINT TO MATCH EXISTING
DC-B-MRI5	CORRIDOR	CPT-1	RB-1	PTD-1	PTD-1	PTD-1	PTD-1	ACT-2	8'-0"	DC-B-MRI5	

FINISH LEGEND:

ACOUSTICAL CEILING TILE
 ACT-1 USG, FROST CLIMAPLUS #414, 24x24x3/4", INTEGRAL COLOR: BLACK 205, SUSPENSION SYSTEM: 15/16" DONN DX/DXL, COLOR: FLAT BLACK 205 (NONFERROUS ATTACHMENT COMPONENTS REQUIRED), USG, MARS CLIMAPLUS #86985, 24x24x3/4", COLOR: WHITE, SUSPENSION SYSTEM: 15/16" DX/DXL, ALUMINUM HANGER WIRES AND ALUMINUM AX GRID, COLOR: WHITE

CARPET (6-FT ROLL)
 CPT-1 TANDUS FLOORING, POWERBOND WITH CUSHION BACKING, ANTRON 6,6 LEGACY NYLON, 03310 MERISTEM, COLOR: 13218 CATKIN

CORNER GUARD
 CG-1 C/S ACROVYN 90-DEGREE, SM SERIES, 2-INCH WING APPLIED, COLOR: 108 BLACK

CUBICLE CURTAIN
 CC-1 STANDARD TEXTILE CO., INC., 100% AVORA FR POLYESTER, 07 TWIGGIE, COLOR: UMBER OAK

PAINT - REFERENCE MAINE MEDICAL CENTER'S SHERWIN WILLIAMS CUSTOM MANUAL COLOR PALETTE, UNLESS NOTED OTHERWISE
 PTD-1 (FIELD) ANTIQUE WHITE
 PTD-2 (DOOR/WINDOW TRIM) MEDIUM TAUPE #1
 PTD-3 (ACCENT) SOUVENIR
 PTD-4 (BLACK) ICI PAINTS, #1673 DARK SECRET, FLAT

PLASTIC LAMINATE
 PLAM-1 (VERTICAL CASEWORK SURFACES) PIONITE, HONEY MAPLE, WM951 SUEDE, GRAIN TO RUN VERTICAL (COUNTERTOP/BACKSPLASH SURFACES) PIONITE, KALE FIBER AV661 SUEDE

RUBBER BASE
 RB-1 JOHNSONITE, TRADITIONAL WALL BASE, 4-INCH HEIGHT, COLOR: 80-FAWN

RUBBER SHEET FLOORING
 RUB-1 NORA SYSTEMS, INC., NORAPLAN ENVIRONCARE, 3.0MM SHEET, HEAT-WELD SEAMS, COLOR: 2784 SILVER CROWN

WOOD (DOORS)
 WD-1 MATCH EXISTING WOOD SPECIES, CUT AND FINISH

GENERAL FINISH NOTES:

- SEE SPECIFICATIONS FOR ADDITIONAL INFORMATION REGARDING FINISH MATERIALS.
- MATERIALS IN FINISH LEGEND ARE FROM MAINE MEDICAL CENTER'S FINISH STANDARDS. SUBSTITUTIONS WILL NOT BE ACCEPTED.
- DOOR AND WINDOW FRAMES TO BE PTD-2.
- REFER TO RCP FOR SOFFIT HEIGHTS. ALL SOFFITS TO BE PTD TO MATCH ADJACENT WALL COLOR, U.N.O.
- ALL GYP. CEILINGS TO BE PTD-1 UNLESS NOTED OTHERWISE.
- ALL EXPOSED STRUCTURE TO BE PAINTED, UNLESS NOTED OTHERWISE.
- REFER TO INTERIOR ELEVATION SHEETS FOR ADDITIONAL INFORMATION REGARDING ACCESSORIES AND EQUIPMENT.
- ALL AREAS DISTURBED DURING CONSTRUCTION SHALL BE PATCHED TO MATCH EXISTING FINISHES.
- CONTRACTOR TO PERFORM ALKALINITY AND ADHESION TESTS (ASTM F 1869 & 2170) RECOMMENDED BY FLOORING MANUFACTURER FOR EACH TYPE OF FLOORING. PROCEED WITH INSTALLATION ONLY AFTER SUBSTRATES PASS TESTING. VERIFY RESULTS WITH FLOORING MANUFACTURER. CONTRACTOR TO CARRY ALLOWANCE FOR TOPICAL TREATMENT IF REQUIRED, KOESTER OR EQUAL.

FINISH ABBREVIATIONS:

ACT	ACOUSTICAL CEILING TILE
CC	CUBICLE CURTAIN
CG	CORNER GUARD
CPT	CARPET
EXIST	EXISTING TO REMAIN
EXP	EXPOSED STRUCTURE
GWB	GYPSTUM WALLBOARD
PLAM	PLASTIC LAMINATE
PTD	PAINTED
RB	RUBBER BASE
RCP	REFLECTED CEILING PLAN
RUB	RUBBER SHEET FLOORING
WD	WOOD

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PROJECT NORTH

LICENSED ARCHITECT
 DEREK J. VAILLEUX
 No. 3185
 STATE OF MAINE
 9.20.13

DOOR SCHEDULE

DOOR NUMBER	DOOR				GLAZING	FRAME				HWS	FIRE RATING (MIN.)	DOOR NUMBER	NOTES
	SIZE	MATERIAL	ELEVATION			MATERIAL	ELEVATION	HEAD	JAMB				
B561	3'-0"x7'-0"	WD	NG2	TINTED FILM		HM	1	A1/AE602	A3/AE602		2	B561	SOUND GASKETS AND SWEEP
B576	4'-0"x7'-0"	WD	F									B576	RF SHIELDING, SUPPLIED AND INSTALLED BY RF SHIELDING VENDOR(GAVEN)
B576A	(1)1'-6", (1)3'-0"x7'-0"	WD	F		WD	1	A1/AE602	A3/AE602			3	B576A	NON-FERROUS HARDWARE
B577	3'-0"x7'-0"	WD	NG		HM	1	A1/AE602	A3/AE602			2	B577	
B578	3'-0"x7'-0"	WD	NG2	TINTED FILM	HM	1	A1/AE602	A3/AE602			2	B578	SOUND GASKETS AND SWEEP
B579	3'-0"x7'-0"	WD	NG2	TINTED FILM	HM	1	A1/AE602	A3/AE602			2	B579	SOUND GASKETS AND SWEEP
B580	3'-0"x7'-0"	WD	NG2	TINTED FILM	HM	1	A1/AE602	A3/AE602			1	B580	SOUND GASKETS AND SWEEP
B581	3'-0"x7'-0"	WD	NG2	TINTED FILM	HM	1	A1/AE602	A3/AE602			1	B581	SOUND GASKETS AND SWEEP
BMRI3	3'-0"x7'-0"	WD	NG		HM	1	A1/AE602	A3/AE602			2	BMRI3	
BMRI5	3'-0"x7'-0"	WD	NG		HM	1	A1/AE602	A3/AE602			2	BMRI5	
B590	(2)3'-0"x7'-0"	WD	F		HM	1	A1/AE602	A3/AE602			3	B590	
B591	3'-0"x7'-0"	WD	NG2	TINTED FILM	HM	1	A1/AE602	A3/AE602			1	B591	SOUND GASKETS AND SWEEP
B594	3'-0"x7'-0"	WD	NG2	TINTED FILM	HM	1	A1/AE602	A3/AE602			1	B594	SOUND GASKETS AND SWEEP

GENERAL DOOR NOTES:

- SEE SPECIFICATIONS FOR HARDWARE SET DESCRIPTIONS.
- SEE TITLE SHEET G001 FOR STANDARD ABBREVIATIONS.
- ALL SWINGING DOORS TO BE 1-3/4" THICK (U.N.O.).
- ALL DOORS SHALL BE 3/4" UNDERCUT (TYPICAL) EXCEPT WHEN THERE IS A BOTTOM FRAME OR SILL THRESHOLD OR SPECIFICALLY NOTED OTHERWISE.
- ALL DOORS WITH BOTTOM FRAMES OR SILL THRESHOLDS SHALL HAVE MANUFACTURERS RECOMMENDED STANDARD UNDERCUT.
- GLAZING NOTED ON DOOR SCHEDULE IS FOR THE DOOR AND SIDELIGHTS IN THE FRAME (TYPICAL).
- REFER TO FLOOR PLAN FOR NOTES ON EXISTING DOORS.
- WOOD DOORS SPECIES/FINISH TO MATCH EXISTING.
- HARDWARE FINISH TO MATCH EXISTING.
- DOOR HARDWARE TO MATCH EXISTING. REUSE HARDWARE WHERE POSSIBLE.

KEYED NOTES:


- EXISTING DOOR, FRAME, AND HARDWARE REINSTALLED AT NEW LOCATION

DOOR ABBREVIATIONS:

AL/ALUM	ALUMINUM	S/S	STAINLESS STEEL
HM	HOLLOW METAL	STL	STEEL
LAM	LAMINATED	TEMP	TEMPERED GLASS
INS	INSULATED	WIRE	WIRE GLASS
WD	WOOD	R/E	RE-USE EXISTING

HARDWARE SETS:

- HWS 1:** (OFFICE) EACH LEAF TO HAVE: HINGES, LOCKSET(OFFICE FUNCTION), WALL STOP, PROVIDE ACOUSTICAL GASKETING ALL SIDES
- HWS 2:** (PASSAGE FUNCTION): EACH LEAF TO HAVE: HINGES, LOCKSET(PASSAGE FUNCTION), CLOSER
- HWS 3:** (STOREROOM) EACH LEAF TO HAVE: HINGES, LOCKSET(STORAGE FUNCTION, CLOSER, KICKPLATE, WALL STOP, PROVIDE FLUSH BOLT AT DOOR HEAD OF INACTIVE LEAF.

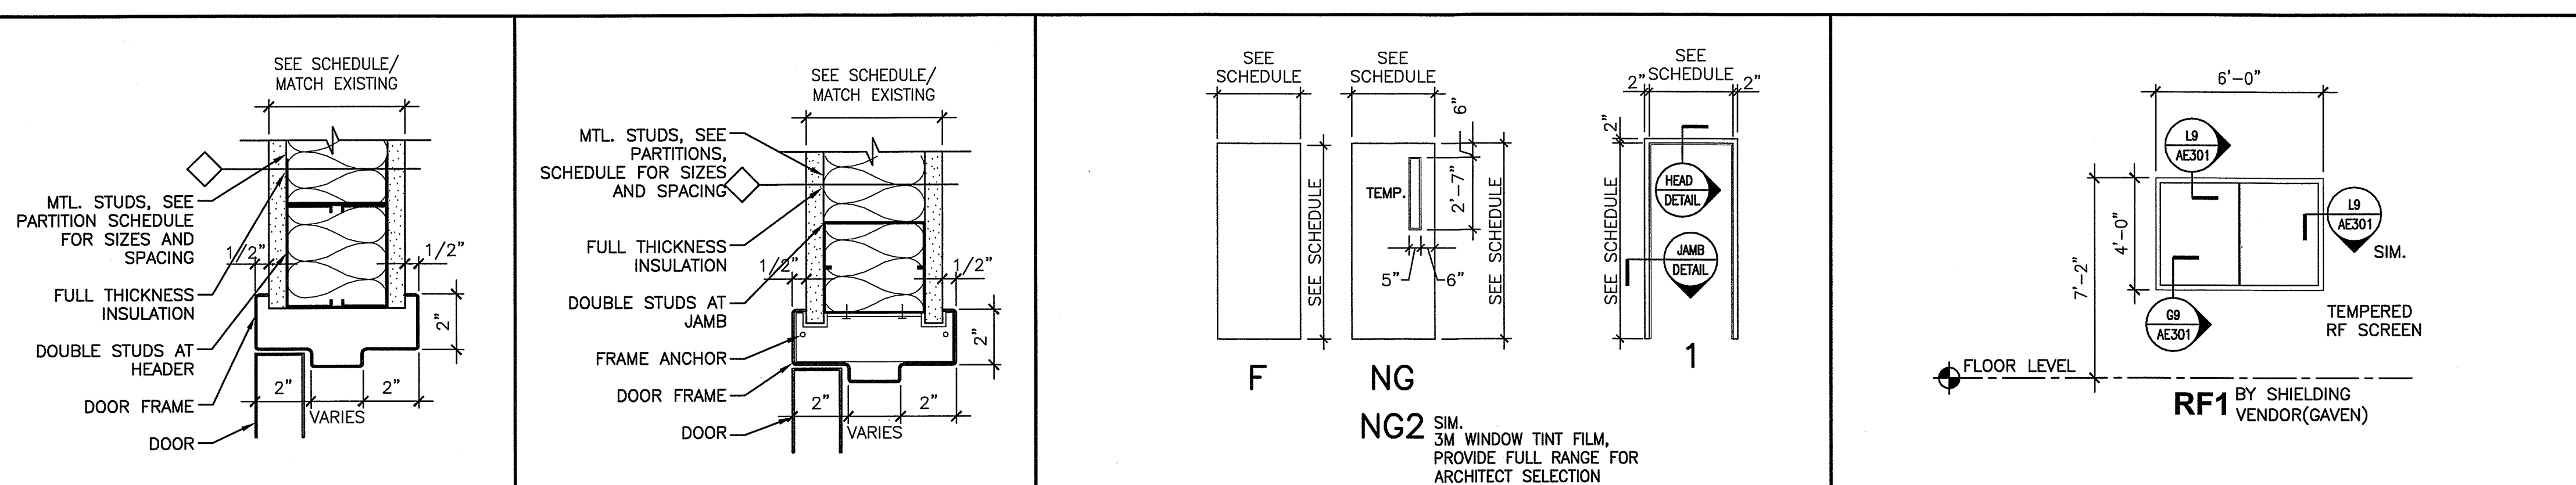

A1	DOOR HEAD	A3	DOOR JAMB	A5	DOOR AND FRAME ELEVATIONS	A9	BORROWED LITE ELEVATIONS
3"-1'-0"	*	3"-1'-0"	*	1/4"-1'-0"	*	1/4"-1'-0"	*

MAINE MEDICAL CENTER
 MRI #1 AND READING ROOM RENOVATION
 PORTLAND, MAINE

ISSUED FOR CONSTRUCTION
 9-20-13

CURRENT ISSUE STATUS:

REV	DESCRIPTION	DATE
0	ISSUED FOR CONSTRUCTION	9-20-13

GRAPHIC SCALE:
 0" 1"

SCALE: 1/4"=1'-0"

PROJECT MANAGER: DJV
 JC/DRAWN BY: MDR
 A/E OF RECORD: DJV
 CAD FILE: AE600-12118
 PROJECT NO: 12118
 DATE: 9-20-13
 SHEET TITLE: SCHEDULES

SHEET No. AE600
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