

BASEMENT LEVEL: BRAMHALL CAMPUS

1/32" = 1'-0"

#### **GENERAL NOTES:**

**SYMBOL LEGEND:** 

∖ A101 /

\ A101 ∫

(101)

Room name

101

1 View Name 1/8" = 1'-0"

WALL SECTION

EXTERIOR ELEVATION

INTERIOR ELEVATION

LEVEL LINE

KEY NOTE

WINDOW TAG

PARTITION TAG

DOOR TAG

ROOM NUMBER

COLUMN BUBBLE & CENTERLINE

BACKER ROD & SEALANT

EQUIPMENT ACCESSORY TAG

- FIELD VERIFY ALL DIMENSIONS AND LAYOUT PRIOR TO PROCEEDING WITH WORK. NOTIFY ARCHITECT IN WRITING OF ANY DISCREPANCIES OR INCONSISTENCIES. FAILURE TO REPORT ANY DISCREPANCIES WITHIN THESE CONSTRUCTION DOCUMENTS TO THE ARCHITECT WILL NOT BE GROUNDS FOR ADDITIONAL COST OR CHANGE ORDERS.
- THE CONTRACTOR SHALL BE RESPONSIBLE FOR PROVIDING ALL MATERIALS (UNLESS NOTED OTHERWISE), AND WORKMANSHIP IN ACCORDANCE WITH FEDERAL, STATE, CITY, AND LOCAL BUILDING CODES AND THEIR REQUIREMENTS.
- CONTRACTOR TO CONFIRM EXISTING WALL RATINGS.
- THE CONTRACTOR AND ALL TRADES SHALL NOTE REQUIREMENTS OF "GENERAL NOTES" ON ALL SHEETS.
- EACH TRADE TO PROVIDE SMOKE OR FIRE SEALANT AT PENETRATIONS AS REQUIRED FOR WALL TYPE. ALL SEALANT, FIRE STOPPING, AND SMOKE STOPPING ASSEMBLIES SHALL BE U.L. RATED.
- DIMENSIONS ARE FACE OF CONCRETE, FACE OF MASONRY, FACE OF EXISTING PARTITION AND CENTERLINE OF STUD PARTITIONS, UNLESS INDICATED
- REFER TO ALL CONSTRUCTION DOCUMENTS FOR REQUIREMENTS WHICH MAY AFFECT THE WORK IN ANOTHER DISCIPLINE AND COORDINATE WORK.
- REFER TO DETAILS FOR ADDITIONAL DIMENSIONAL INFORMATION.
- DOOR JAMBS SHALL BE LOCATED 6" FROM CORNER IN STUD PARTITIONS AND 8" FROM CORNER IN MASONRY PARTITIONS UNLESS INDICATED OTHERWISE.
- 10. PROVIDE BLOCKING IN WALLS AS NECESSARY WHERE CASEWORK, SHELVES, HANDRAILS, AND MISC. EQUIPMENT ARE LOCATED.
- 11. PATCH ALL HOLES, WALLS AND CRACKS IN ROOMS TO RECEIVE NEW PAINT.
- 12. ANY EXISTING WALLS THAT ARE FOUND TO BE UNBRACED OR DO NOT EXTEND TO BOTTOM OF DECK/SLAB SHOULD BE BRACED BACK TO STRUCTURE. WHEN PRIVACY IS AN ISSUE EXTEND WALL TO BOTTOM OF DECK/SLAB.
- 13. DO NOT SCALE DRAWINGS.
- 14. "PROVIDE" MEANS "FURNISH AND INSTALL."

### **APPLICABLE CODES:**

<b>GENERALS:</b>	

- INTERNATIONAL BUILDING CODE (IBC); 2009 EDITION NATIONAL FIRE PROTECTION ASSOCIATION (NFPA101); 2010 EDITION
- ACCESSIBILITY GUIDELINES FOR BUILDINGS AND FACILITIES (ADA); 1994 EDITION AIA GUIDELINES FOR DESIGN AND CONSTRUCTION OF HOSPITAL AND HEALTHCARE FACILITIES; 2010 EDITION

#### NFPA 13: INSTALLATION OF SPRINKLER SYSTEMS; 2002

- 2. STATE OF MAINE INTERNAL PLUMBING CODE; 2005
- MECHANICAL CODE: INTERNATIONAL MECHANICAL CODE; 2003 EDITION
- NFPA 99 HEALTHCARE FACILITIES; 2002 EDITION
- ENERGY CODE: ASHRAE 90.1: 2001 EDITION WITH AMENDMENTS ASHRAE 62; 2001 EDITION
- FIRE AND SMOKE DAMPER INSTALLATION: NFPA 90A AND NFPA 10; 2003 EDITION DUCT MOUNTED SMOKE DETECTORS: NFPA 72 EDITION

#### ELECTRICAL:

- 1. NFPA 70; 2005 EDITION
- 2. NFPA 72; 2003 EDITION 3. IESNA LIGHTING HANDBOOK REFERENCE AND APPLICATION, 9th EDITION



# MAINE MEDICAL CENTER

BRAMHALL CAMPUS: PORTLAND, MAINE

## **FLUORO RENOVATIONS**

ΓAG	DESCRIPTION	PROVIDE
1	PHONE	O/C
2	COMPUTER CART	0/0
3	CART	0/0
4	WALL MOUNTED COMPUTER	O/C
5	MONITOR	0/0
6	TRASH BIN	0/0
7	VENDOR EQUIPMENT	O/C
8	COPY/PRINT/FAX	Е
9	WHITE BOARD	O/C
10	DESK	O/C
11)	BABY CHANGING STATION	C/C
12	SOAP DISPENSER	O/C
13	PAPER TOWEL DISPENSER	O/C
14)	READING STATION	0/0
15	PROJECTOR	0/0
16	DVR (POWER/DATA)	0/0

EQL	JIPMENT AND ACCESSORIES SCH	HEDULE	
TAG	DESCRIPTION	PROVIDE	
1	PHONE	O/C	
2	COMPUTER CART	0/0	
3	CART	0/0	
4	WALL MOUNTED COMPUTER	O/C	
5	MONITOR	0/0	•
6	Trash bin	0/0	
7	VENDOR EQUIPMENT	O/C	,,
8	COPY/PRINT/FAX	E	
9	WHITE BOARD	O/C	
10	DESK	O/C	
11	BABY CHANGING STATION	C/C	,
12	SOAP DISPENSER	O/C	, ,
13	PAPER TOWEL DISPENSER	O/C	
14)	READING STATION	0/0	
(15)	PROJECTOR	0/0	

O/O: OWNER FURNISHED/OWNER INSTALLED

NOTE: PROVIDE TOILET ACCESSORIES IN ACCORDANCE WITH MAINE MED. STANDARDS

EXISTING

Sheet Number	Sheet Name	Issue Status	Issue Date
G- 001	GENERAL INFORMATION	IFC	8.24.10
A- 001	BASEMENT LIFE SAFETY PLAN, PHASING PLAN & DEMOLITION PLANS	IFC	8.24.10
A- 101	BASEMENT FLOOR PLAN	IFC	8.24.10
A- 102	BASEMENT REFLECTED CEILING PLAN	IFC	8.24.10
A - 201	INTERIOR ELEVATIONS	IFC	8.24.10
A - 600	INTERIOR FINISHES, SCHEDULES & DETAILS	IFC	8.24.10
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Sheet Number	Sheet Name	Issue Status	Issue Date
M-001	MECHANICAL LEGEND AND ABBREVIATIONS	IFC	8.24.10
MD101	FLUORO DEMOLITION PLAN	IFC	8.24.10
MH101	FLUORO MECHANICAL DUCTWORK PLAN	IFC	8.24.10
MP101	FLUORO MECHANICAL PIPING PLAN	IFC	8.24.10
MP102	FLUORO MECHANICAL PIPING PLAN ROOF	IFC	8.24.10
M-601	MECHANICAL SCHEDULES	IFC	8.24.10
		IFC	8.24.10
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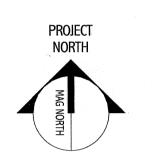
PLUMBING			
<b>Sheet Number</b>	Sheet Name	Issue Status	Issue Date
PL001	PLUMBING LEGEND AND ABBREVIATIONS	IFC	8.24.10
PL101	FLUORO PLUMBING PLANS	IFC	8.24.10
PL501	PLUMBING DETAILS	IFC	8.24.10
PL601	PLUMBING SCHEDULES	IFC	8.24.10

Sheet Number	Sheet Name	Issue Status	Issue Date
E-001	FLUORO LEGEND AND GENERAL NOTES	IFC	8.24.10
E-002	FLUORO SPECIFICATIONS SHEET 1	IFC	8.24.10
E-003	FLUORO SPECIFICATIONS SHEET 2	IFC	8.24.10
ED101	FLUORO DEMOLITION BASEMENT PLAN	IFC	8.24.10
EP101	FLUORO POWER PLAN	IFC	8.24.10
EP401	ENLARGED POWER PLAN SHEET 1	IFC	8.24.10
EP402	ENLARGED POWER PLAN SHEET 2	IFC	8.24.10
EL101	FLUORO BASEMENT LIGHTING PLAN	IFC	8.24.10
EY101	FLUORO BASEMENT SYSTEMS PLAN	IFC	8.24.10
EP601	ONE - LINE DIAGRAM AND PANEL SCHEDULES	IFC	8.24.10

<b>Sheet Number</b>	Sheet Name	Issue Status	Issue Date
Q-001	VENDOR EQUIPMENT DRAWINGS SHEET 1	IFC	8.24.10
Q-002	VENDOR EQUIPMENT DRAWINGS SHEET 2	IFC	8.24.10
<b>Q</b> -003	VENDOR EQUIPMENT DRAWINGS SHEET 3	IFC	8.24.10
Q-004	VENDOR EQUIPMENT DRAWINGS SHEET 4	IFC	8.24.10
Q-005	VENDOR EQUIPMENT DRAWINGS SHEET 5	IFC	8.24.10
Q-006	VENDOR EQUIPMENT DRAWINGS SHEET 6	IFC	8.24.10
Q-007	VENDOR EQUIPMENT DRAWINGS SHEET 7	IFC	8.24.10
Q-008	VENDOR EQUIPMENT DRAWINGS SHEET 8	IFC	8.24.10
Q-009	VENDOR EQUIPMENT DRAWINGS SHEET 9	IFC	8.24.10
Q-010	VENDOR EQUIPMENT DRAWINGS SHEET 10	IFC	8.24.10
Q-011	VENDOR EQUIPMENT DRAWINGS SHEET 11	IFC	8.24.10
Q-012	VENDOR EQUIPMENT DRAWINGS SHEET 12	IFC	8.24.10

ARCHITECTURAL			
Sheet Number	Sheet Name	Issue Status	Issue Date
G- 001	GENERAL INFORMATION	IFC	8.24.10
A- 001	BASEMENT LIFE SAFETY PLAN, PHASING PLAN & DEMOLITION PLANS	IFC	8.24.10
A- 101	BASEMENT FLOOR PLAN	IFC	8.24.10
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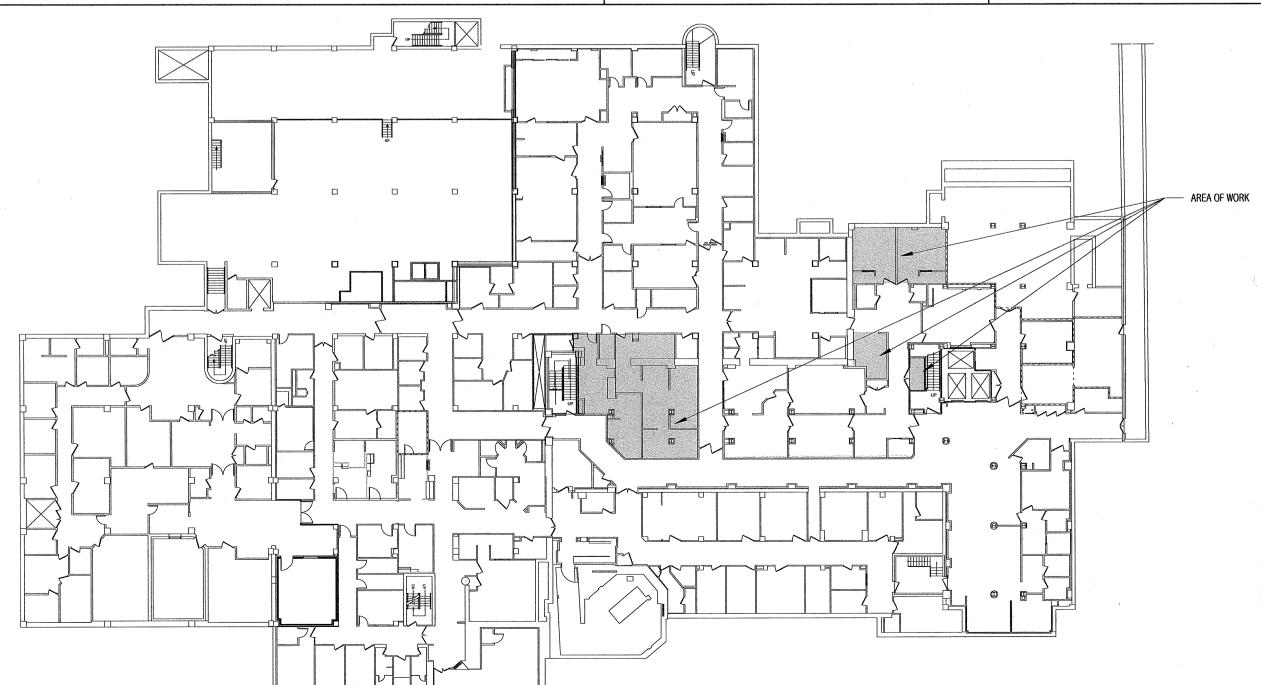
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GRAPHIC SCALE: PROJECT MANAGER:

A/E OF RECORD: PROJECT NO:

**GENERAL** INFORMATION

G-001



^	FURRING PARTITION	
⟨F1⟩—	-7/8" METAL HAT SECTION 24" O.C. TO DECK -(1) LAYER 5/8" GWB, TO DECK	
	FURRING PARTITION	
F2—	-3 5/8" 25 GA. STEEL STUDS @ 24" O.C. TO DECK -(1) LAYER 5/8" INTERIOR GYPSUM BOARD TO DECK, TAGGED SIDE	
<del>(F3)</del> —	-(1) LAYER 5/8" MOISTURE RESISTANT GWB. -2 1/2" METAL STUDS	
	1 HOUR RATED PARTITION; U.L. #U415	
<u> </u>	-(1) LAYER 5/8" TYPE X INTERIOR GYPSUM BOARD TO DECK -3 5/8" 25 GA. STEEL STUDS @ 24" O.C. TO DECK; U.N.OFULL BATT INSULATION -(1) LAYER 5/8" TYPE X INTERIOR GYPSUM BOARD TO DECK -SEAL ALL PENETRATIONS	
X1 <sub>E</sub>	EXISTING WALL CONSTRUCTION TO BE VERIFIED BY CONTRACTOR. MODIFY WALL CONSTRUCTION TO MEET U.L. #U415 WALL CONSTRUCTION	
	SOUND ATTENUATED PARTITION: STC 45	
<u>\$1</u>	-(1) LAYER 5/8" INTERIOR GYPSUM BOARD TO DECK -3 5/8" 25 GA. STEEL STUDS @ 24" O.C. TO DECK; U.N.OFULL BATT INSULATION -(1) LAYER 5/8" INTERIOR GYPSUM BOARD TO DECK -SEAL ALL PENETRATIONS	
\$2\—	-(1) LAYER 5/8" INTERIOR GYPSUM BOARD TO CEILING -3 5/8" 25 GA. STEEL STUDS @ 24" O.C. TO CEILINGFULL BATT INSULATION -(1) LAYER 5/8" INTERIOR GYPSUM BOARD TO CEILING	
(E)	MATCH EXISTING ADJACENT WALL CONSTRUCTION AND LEAD SHEILDING	