


NOTE:
 1. SEE SHEET E-001 FOR LEGEND AND GENERAL NOTES.
 2. REFER THE SHEET EP101 FOR PANELBOARD LP2-1 LOCATION.
 3. BRANCH CIRCUIT NUMBERS INDICATED ARE FOR CIRCUIT ORGANIZATION ONLY UNLESS SPECIFICALLY NOTED OTHERWISE. ALL THE ABOVE CIRCUIT NUMBERS SHALL BE DEVOLVED AND DOCUMENTED WITH AS-BUILT DRAWINGS. (EX. LP2-2-1 EQUALS THE FIRST AVAILABLE SPARE CIRCUIT IN PANELBOARD LP2-2).

KEYED NOTE:
 ① CONNECT TO EXISTING NORMAL POWER BRANCH CIRCUIT SERVING THE SPACE
 ② PROVIDE NEW FEEDER TO AC-1 & CU-1 UTILIZE EXISTING SPARE CIRCUITS AS INDICATED. REMOVE EXISTING SPARE CIRCUIT BREAKER AND PROVIDE NEW 25A/2P BREAKER TO MATCH EXISTING STYLE AND AG RATINGS.
 ③ CONNECT THE EXISTING CRITICAL POWER BRANCH CIRCUIT SERVING THE AREA
 ④ COORDINATE MOUNTING HEIGHT W/ OWNER, ARCHITECT AND EQUIPMENT SUPPLIER.
 ⑤ MOUNT 42" AFF TO CENTER OF DEVICE

REV.	ISSUED FOR CONSTRUCTION DESCRIPTION	DATE
0		9-12-08

ISSUED FOR CONSTRUCTION
 9-12-08

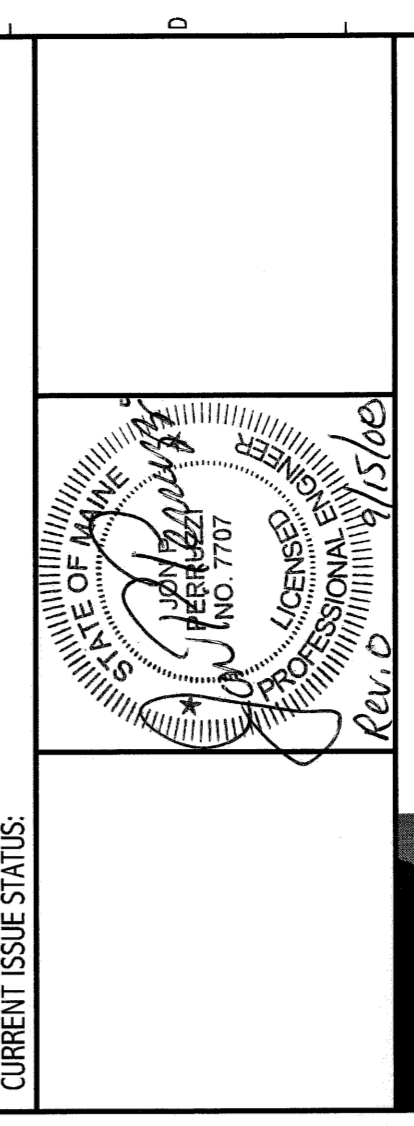

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MAINE MEDICAL CENTER - RICHARDS WING 2ND FLOOR
 INPATIENT SERVICES
 PORTLAND, MAINE

POWER
PARTIAL FLOOR PLAN SHEET 2

SCALE: 1/4" = 1'-0"
 DATE: 9-12-08
 PROJECT MANAGER: CDP GRAPHIC SCALE: 0'
 1"

DATE OF RECORD: JPP SHEET No. EP102
 PROJECT No.: EP102-08103
 SHEET No.: 08103

MACHINE EP101
 MATCHLINE EP102

MACHINE EP101
 MATCHLINE EP102

A1 PARTIAL FLOOR PLAN

1/4"=1'-0"