


NOTE:
 1. SEE SHEET E-001 FOR LEGEND AND GENERAL NOTES.
 2. BRANCH CIRCUIT NUMBERS INDICATED ARE FOR CIRCUIT ORGANIZATION ONLY UNLESS SPECIFICALLY NOTED OTHERWISE. ACTUAL BRANCH CIRCUIT NUMBERS SHALL BE DETERMINED BY THE ELECTRICAL CONTRACTOR AFTER DEMOLITION AND DOCUMENTED WITH AS-BUILT DRAWINGS. (EX. LP2-2-1 EQUALS THE FIRST AVAILABLE SPARE CIRCUIT IN PANELBOARD LP2-2).
 3. REFER TO SHEET EP102 FOR PANELBOARD ELP2-2 LOCATION.

KEYED NOTE:
 ① CONNECT TO EXISTING NORMAL POWER BRANCH CIRCUIT SERVING THE SPACE
 ② CONNECT TO EXISTING CRITICAL POWER BRANCH CIRCUIT SERVING SPACE.
 ③ MOUNT 6" ABOVE COUNTER TO CENTER OF DEVICE.
 ④ MOUNT 42" AFF TO CENTER OF DEVICE
 ⑤ COORDINATE MOUNTING HEIGHT W/ OWNER, ARCHITECT AND EQUIPMENT SUPPLIER

REV.	DESCRIPTION	DATE
0	ISSUED FOR CONSTRUCTION	9-12-08

ISSUED FOR CONSTRUCTION
 9-12-08

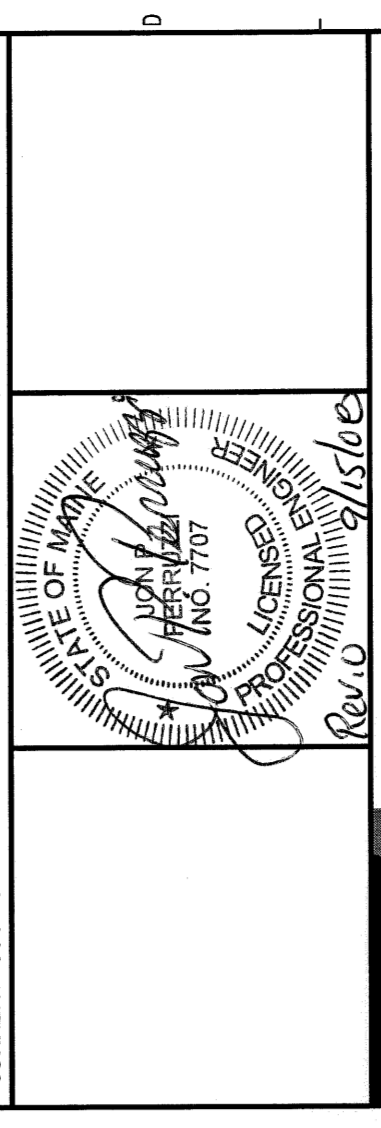

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MAINE MEDICAL CENTER - RICHARDS WING 2ND FLOOR
 INPATIENT SERVICES
 PORTLAND, MAINE

POWER
 PARTIAL FLOOR PLAN SHEET 1
 SHEET TITLE
 SCALE: 1/4" = 1'-0"
 DATE: 9-12-08
 PROJECT MANAGER: CJP
 GRAPHIC SCALE: 0' 1'
 JOB CAP/DRAWN: MRC/COS
 PROJECT NO.: 08103
 A/E OF RECORD: JPP
 SHEET NO.: EP101
 SMRTI CAD FILE: EP101-08103
 PROJECT NO.: 08103

A1 PARTIAL FLOOR PLAN
 1/4"=1'-0"