




G1 **DETAIL**
3" = 1'-0"

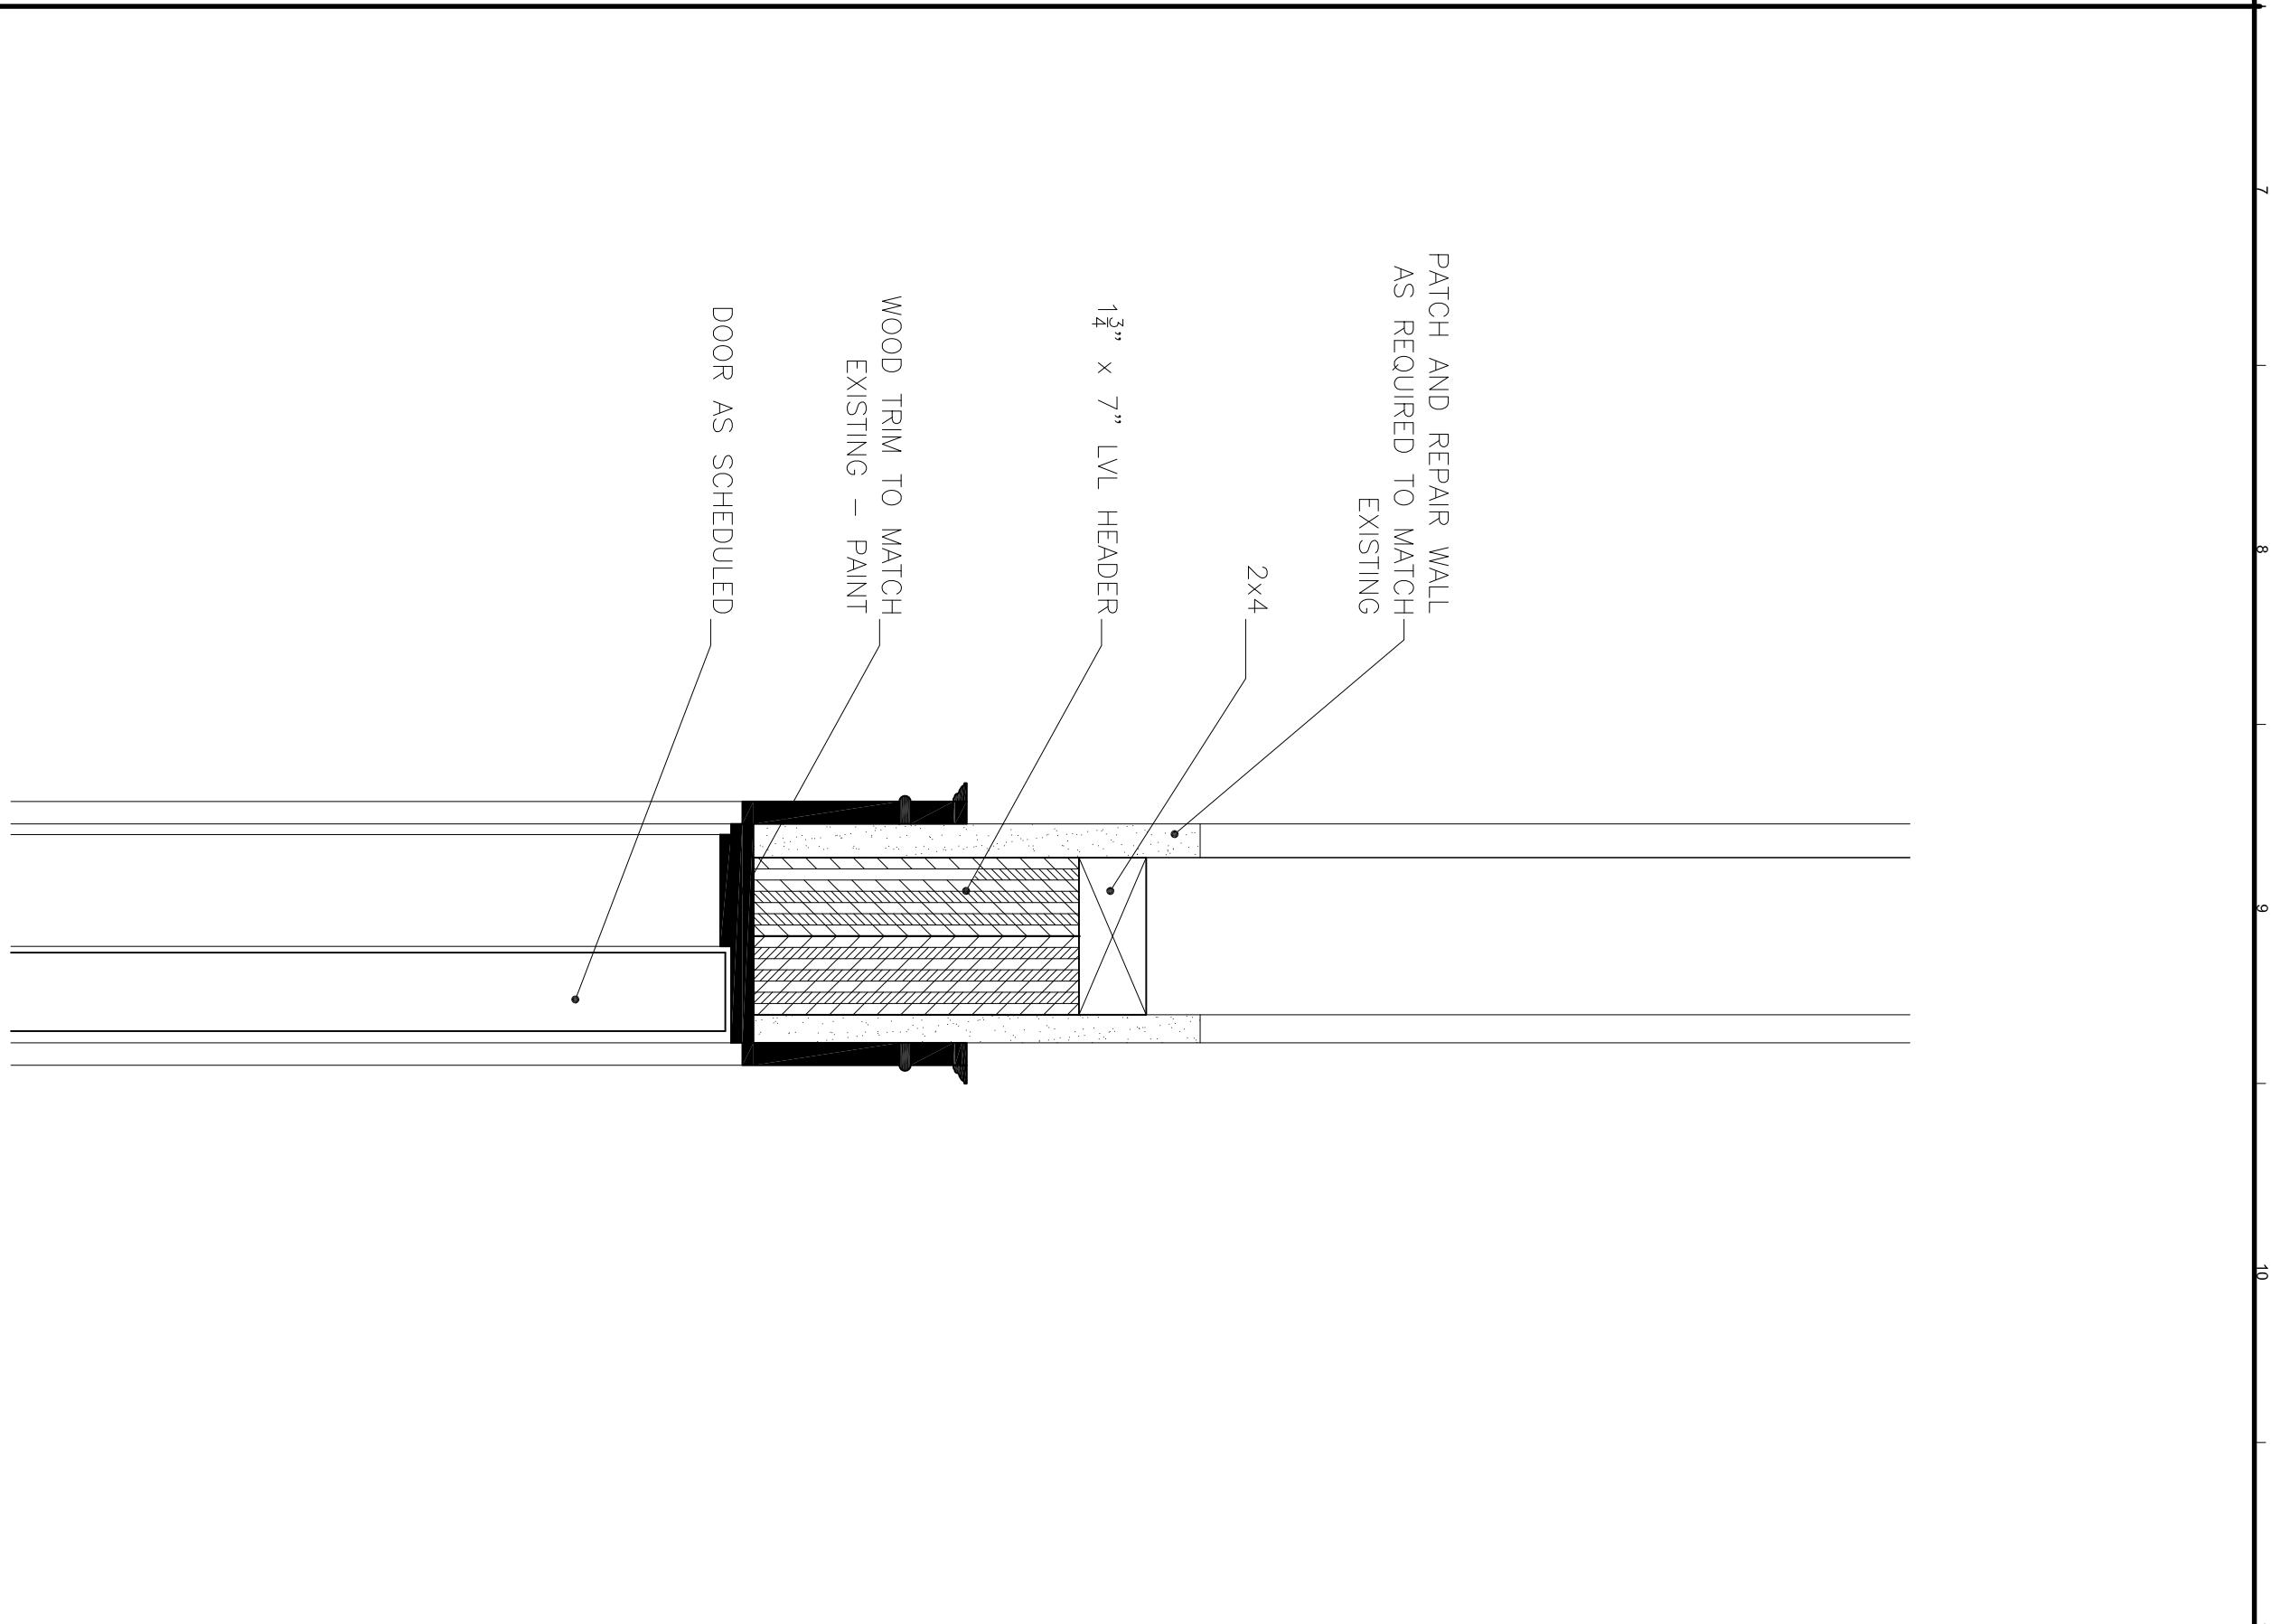

G6 **HEAD DETAIL**
3" = 1'-0"

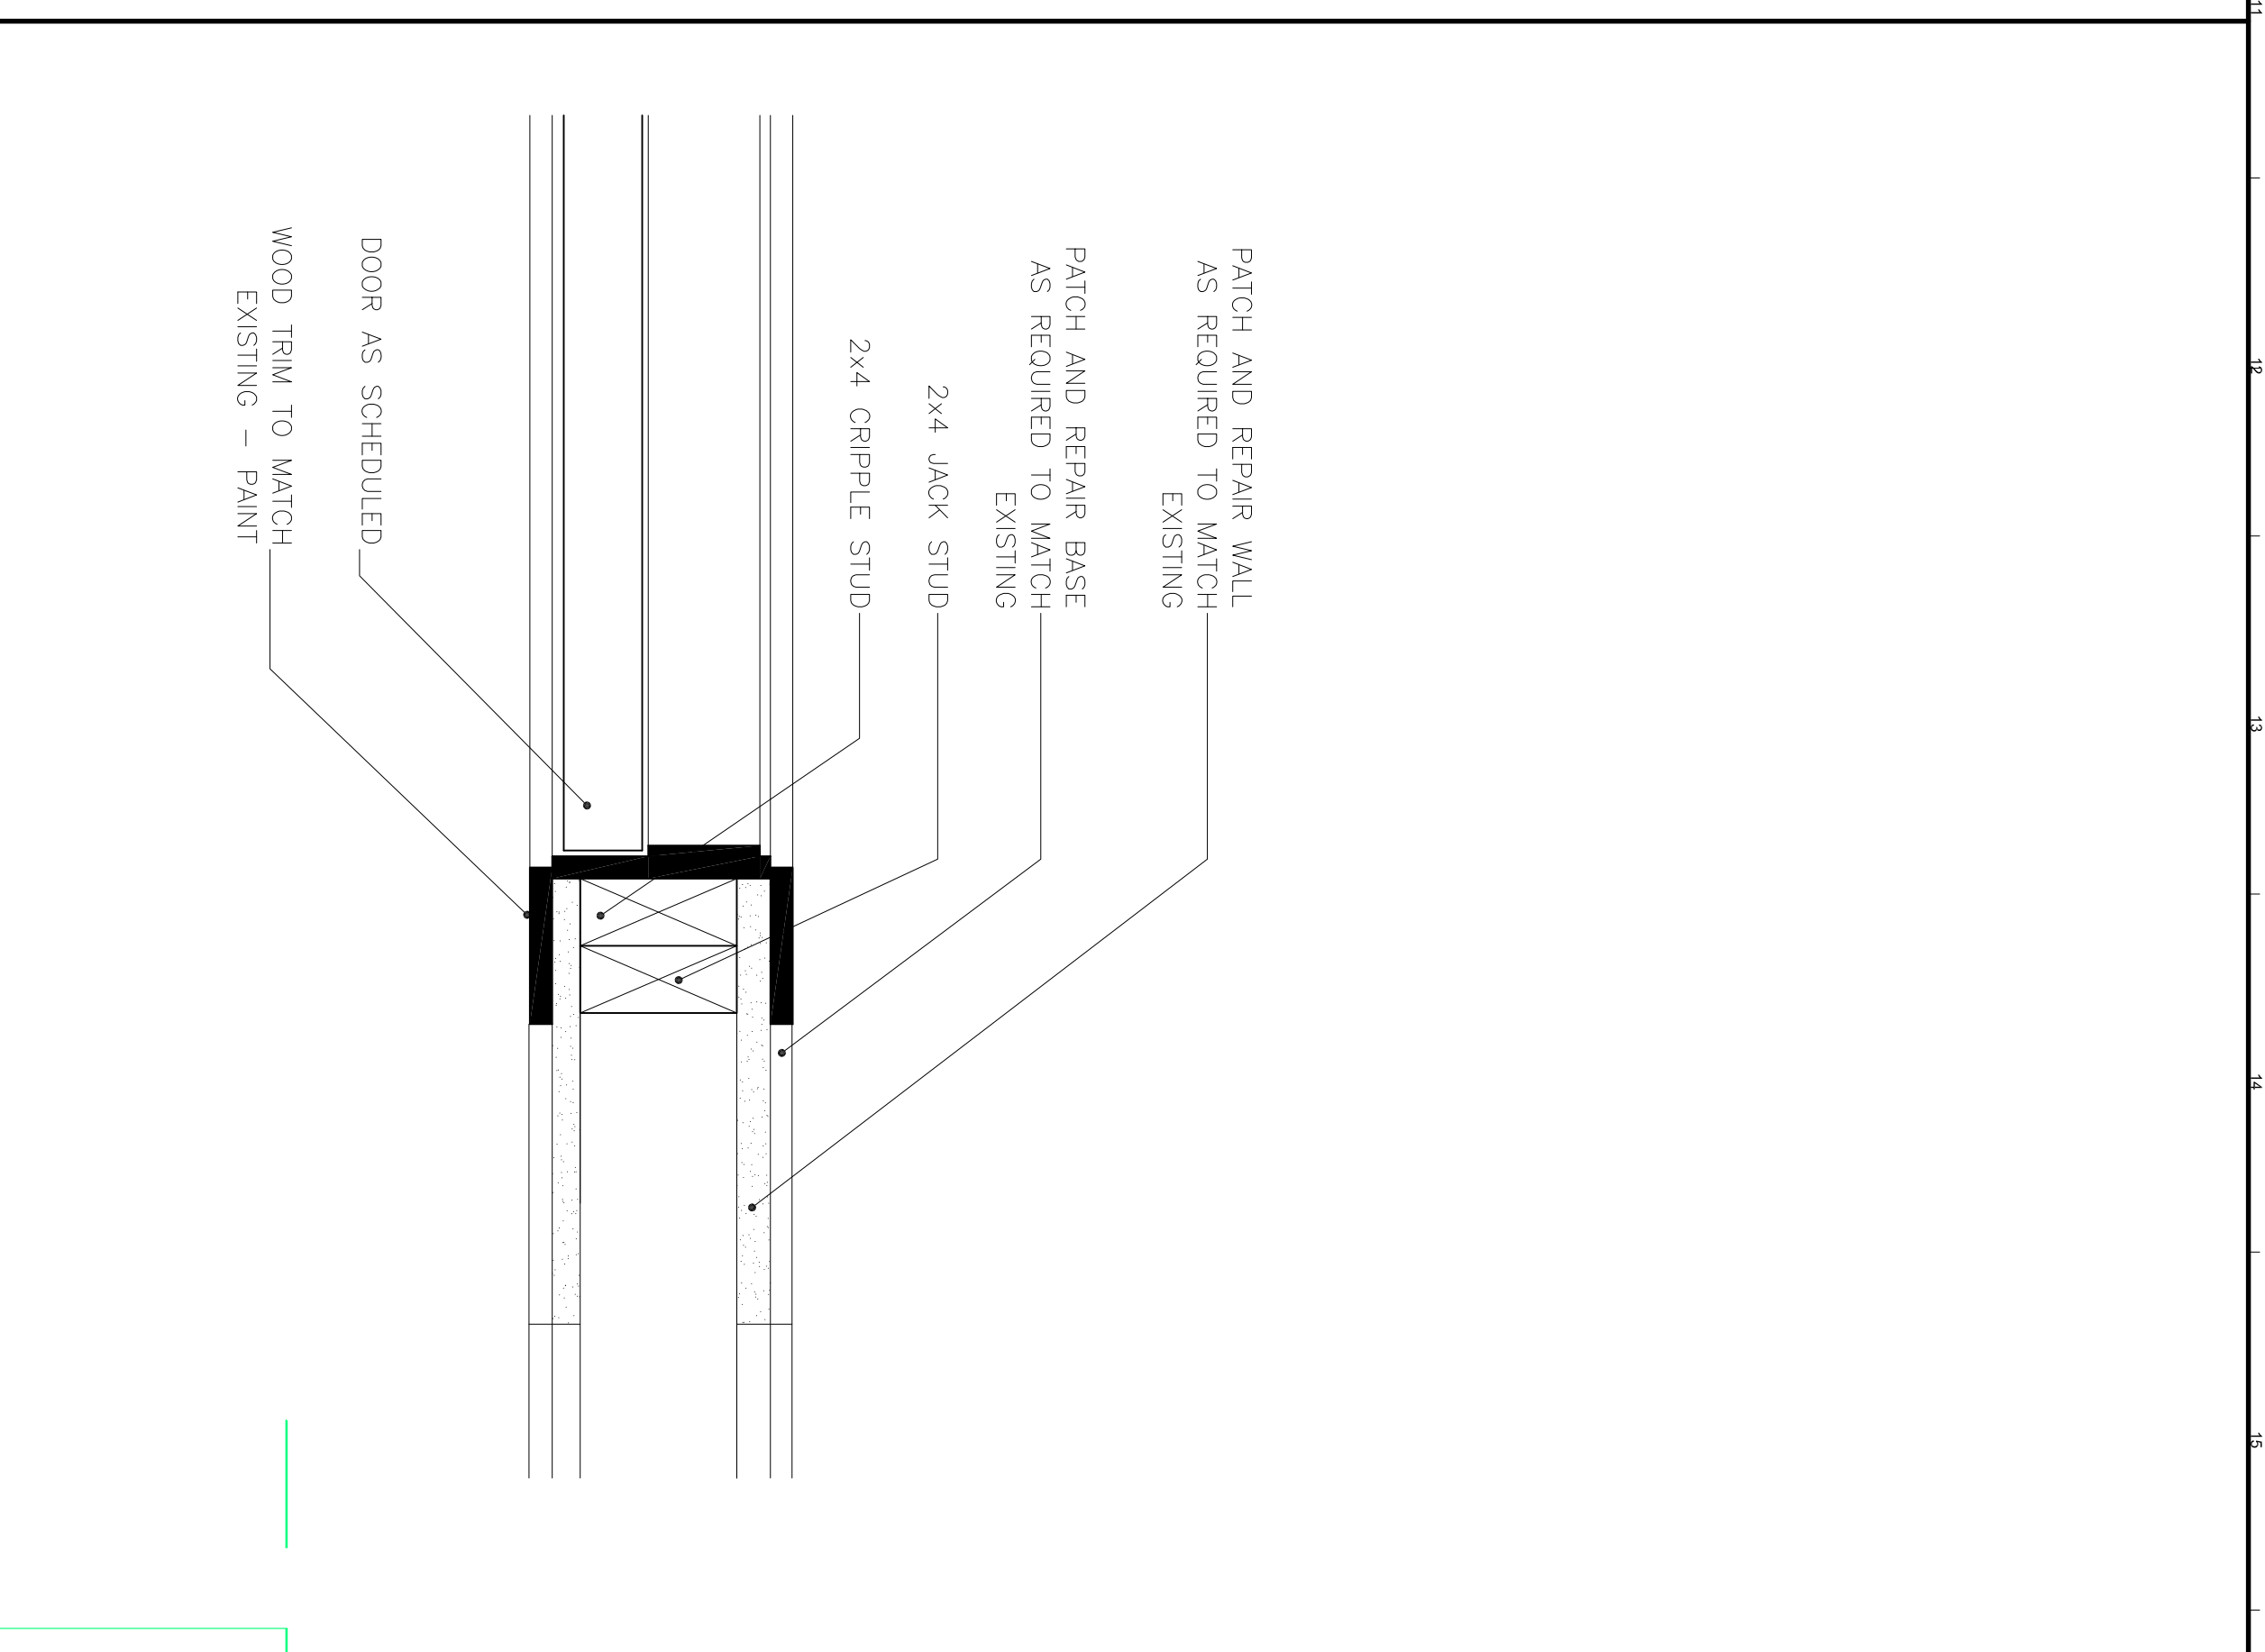

G12 **JAMB DETAIL**
3" = 1'-0"

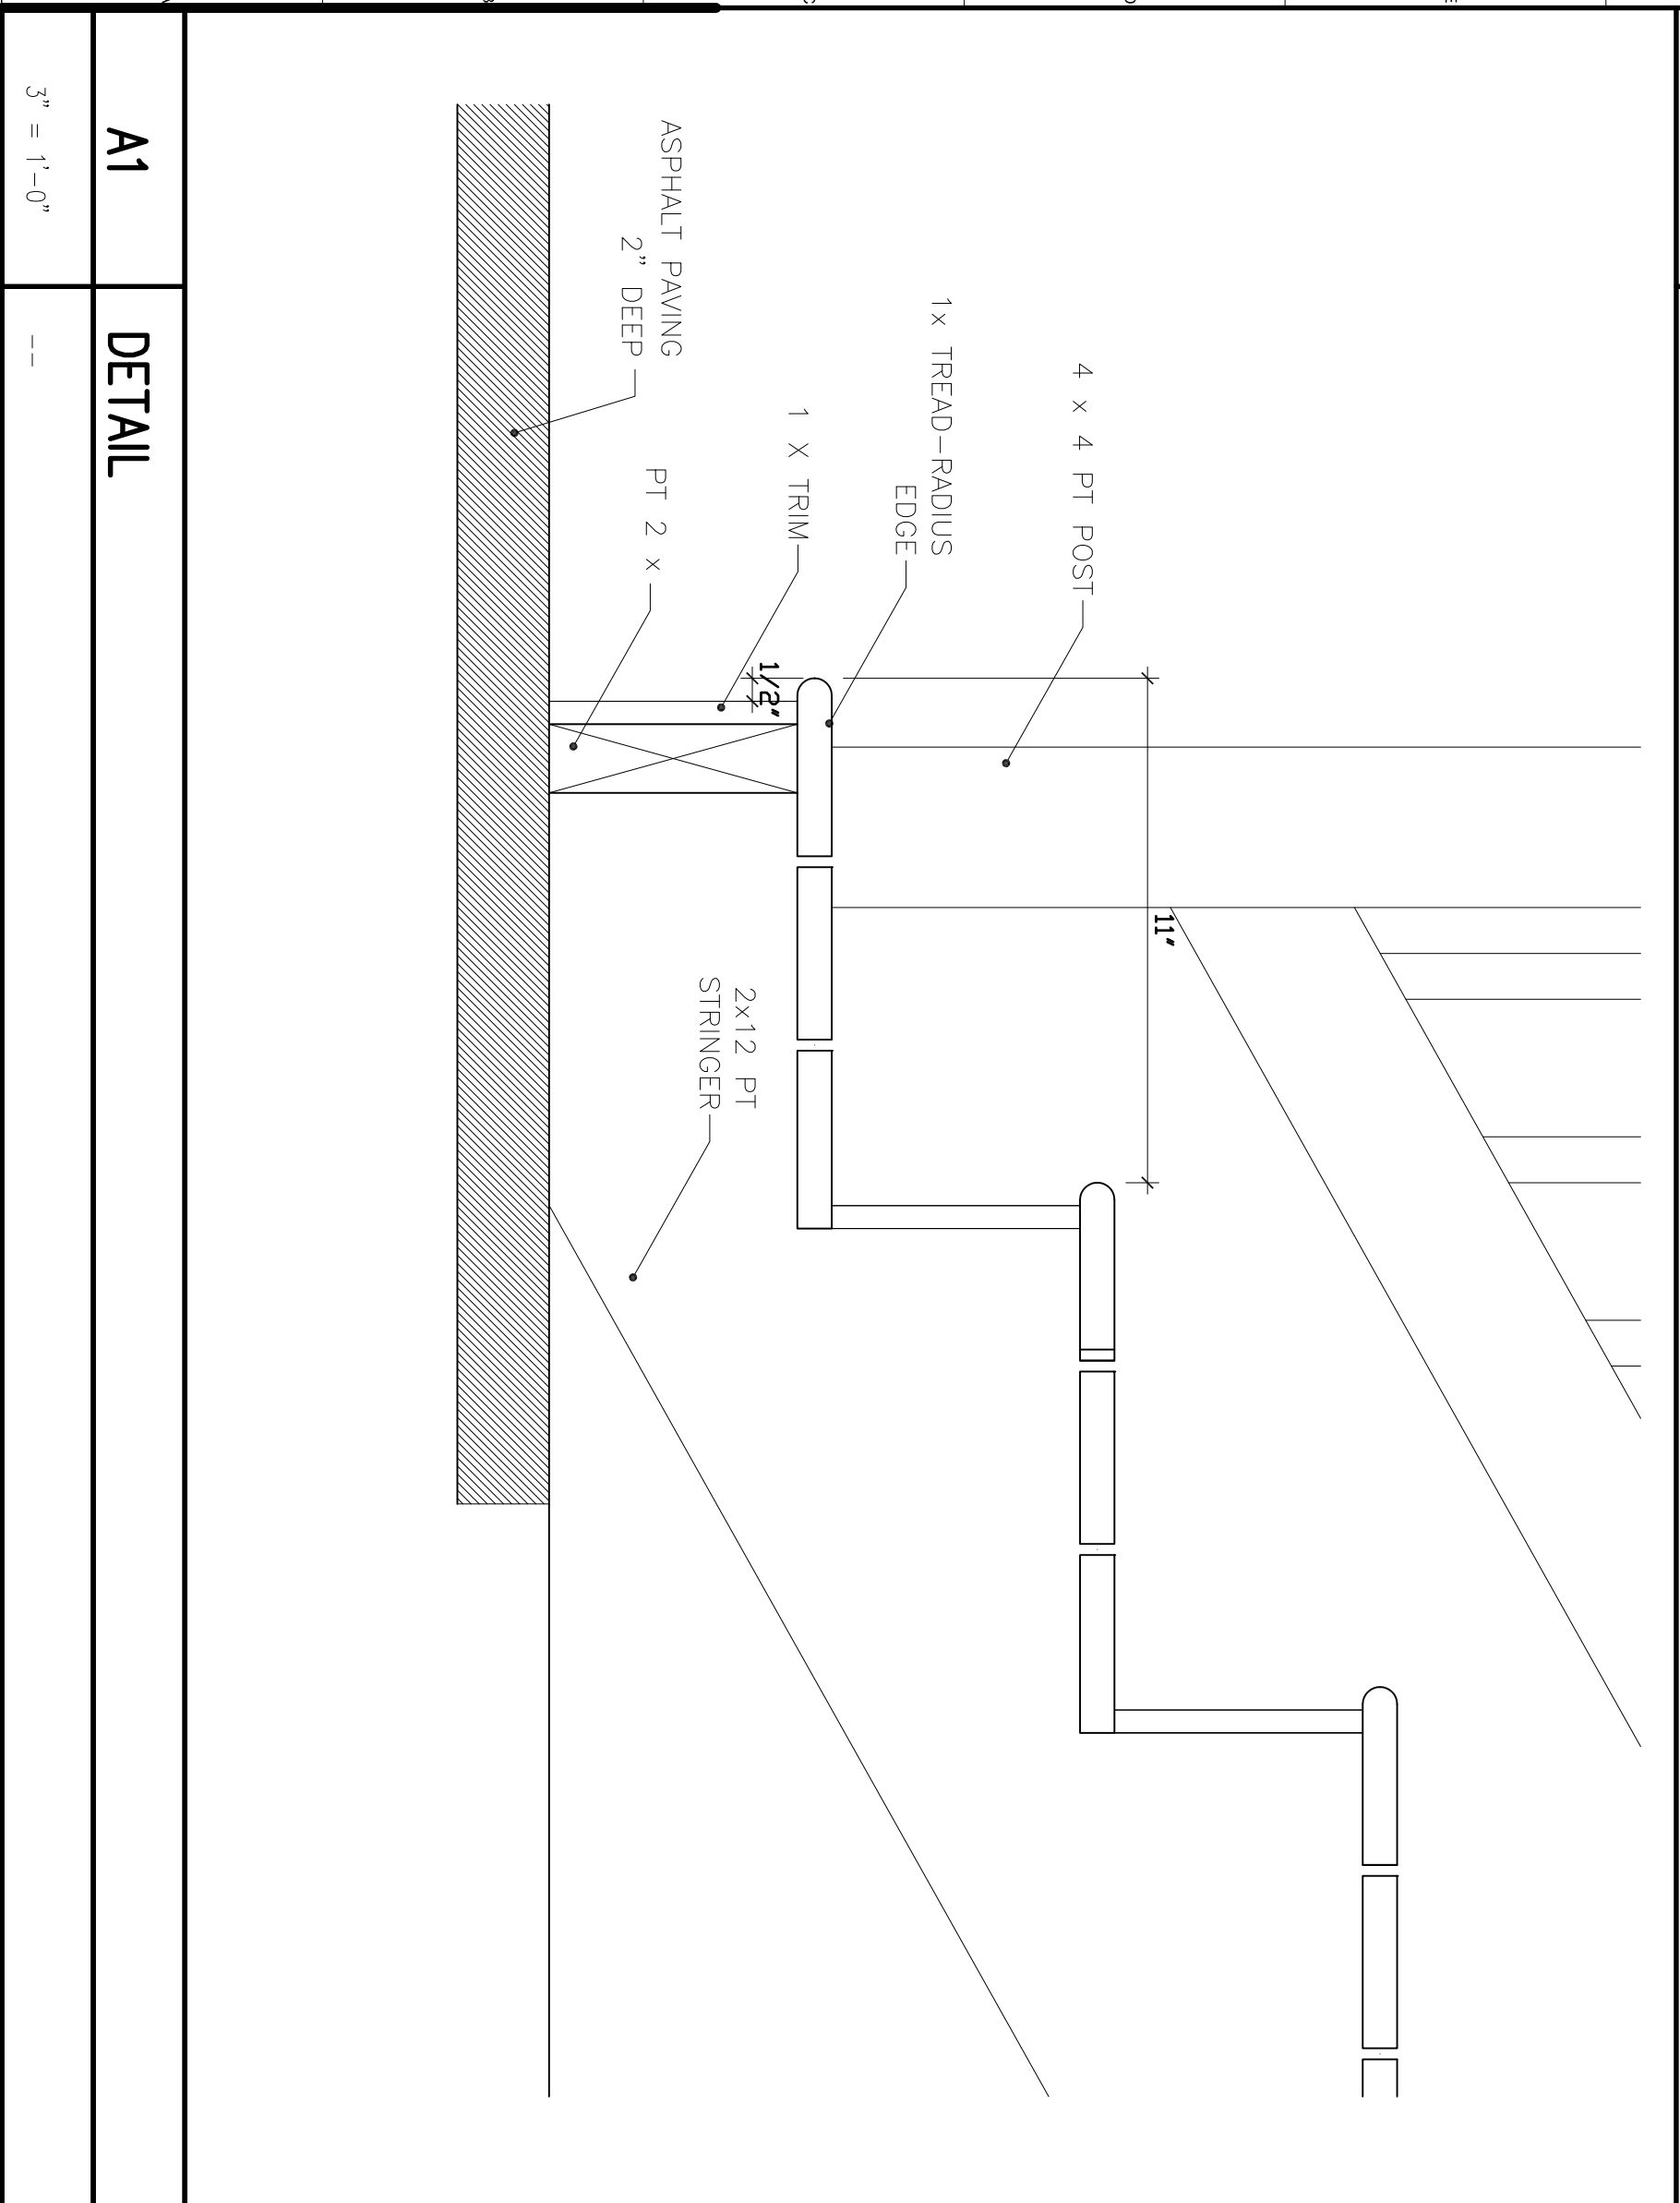

A1 **DETAIL**
3" = 1'-0"

A6 **DOOR SCHEDULE**
no scale

DOOR NO.	SIZE	DOOR		GLAZE		FRAME TYPE		DETAIL		HWS	FIRE RTG. (MIN.)	REMARKS
		MATL	ELEVATION	INS./TEMP.	TEMP.	MATL	ELEV	HEAD	JAMB			
107	3'-0" X 6'-8"	ALUM.	HG	NS/TEMP.	TEMP.	-	-	G1/A102	-	-	-	PROVIDE STORM DOOR, INSULATED DOOR
107A	3'-0" X 6'-8"	WOOD	FG	EXG	EXG	-	-	G6/A104	-	-	*	PROVIDE NEW LOCK SET
106	3'-0" X 6'-8"	EXG	EXG	EXG	EXG	-	-	G2/A104	-	-	-	1.
102	3'-0" X 6'-8"	WOOD	FG	TEMP.	TEMP.	-	-	G6/A104	-	-	-	FINISH TO MATCH DOOR 104 JAMB
101	-	-	-	-	-	-	-	-	-	-	-	1., 2.

REMARKS
1. COORDINATE ALL HARDWARE AND KEYS WITH OWNER
2. REPLACE THRESHOLD.
3. PROVIDE (2) 1 1/2" x 7" LVL HEADERS AT DOORS, 107, 107A AND 102

ISSUED FOR BID
07.31.2013
CURRENT ISSUE STATUS

DESIGN GROUP COLLABORATIVE ARCHITECTURE DESIGN + PLANNING
22 FREE STREET
PORTLAND, MAINE 04101
(207) 699-5300

University of Southern Maine, ADA Upgrades
39 Exeter Street, Portland, Maine

DOOR SCHEDULE, DETAILS

DATE: 07.31.2013
SCALE: 1/4" = 1'-0"
NO. 13301
DRAWN BY: [Signature]

GRAPHIC SCALE
SHEET NO. **A 104**

DATE OF RECORDS