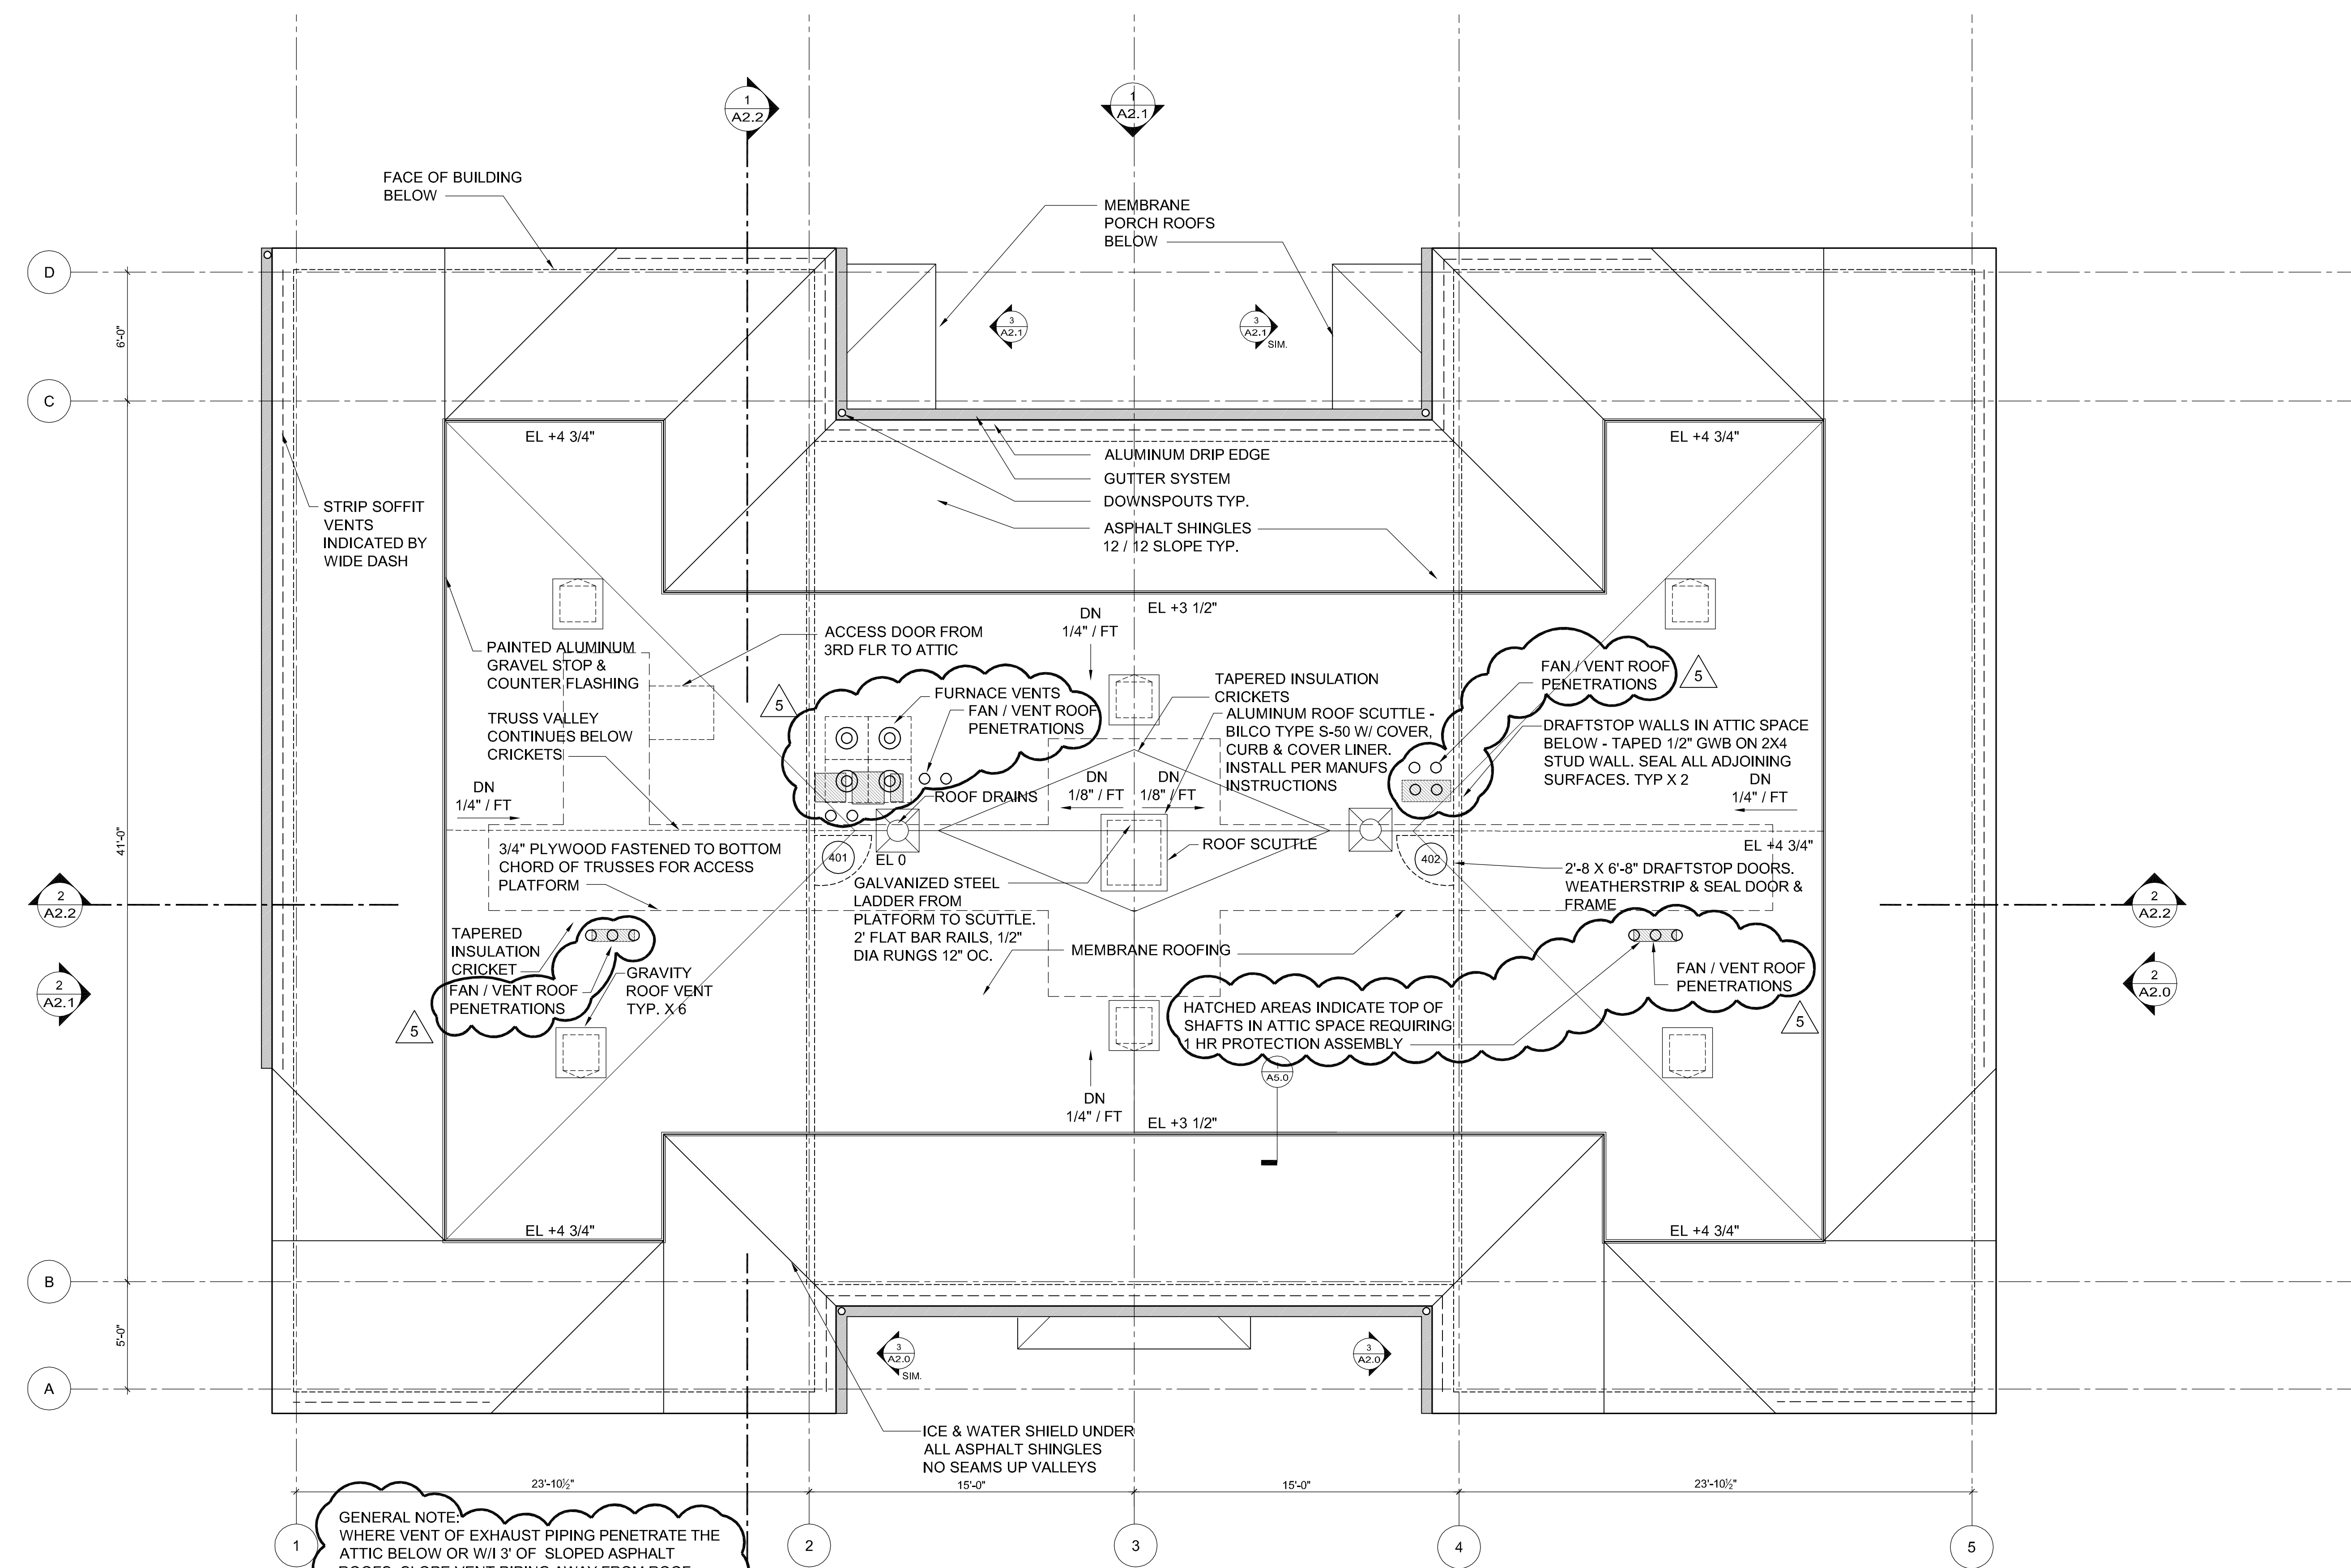


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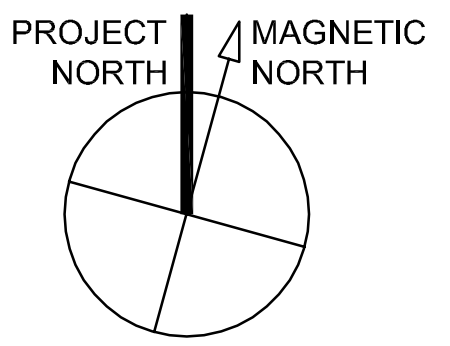
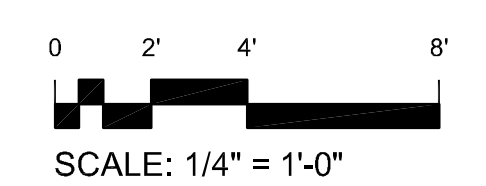
**GENERAL NOTE:**  
WHERE VENT OF EXHAUST PIPING PENETRATE THE ATTIC BELOW OR W/ 3' OF SLOPED ASPHALT ROOFS, SLOPE VENT PIPING AWAY FROM ROOF EDGES IN ORDER TO DECREASE VISIBILITY FROM ADJACENT BUILDINGS. LOCATIONS AND QUANTITIES OF ROOF PENETRATIONS ARE SHOWN SCHEMATICALLY. COORDINATE ALL REQUIRED ROOF PENETRATIONS WITH MEP DRAWINGS

**NOTE:** ELEVATIONS ARE APPROXIMATE ABOVE ROOF DRAINS

HATCHED AREAS INDICATE TOP OF SHAFTS IN ATTIC SPACE REQUIRING 1 HR PROTECTION ASSEMBLY

**ATTIC VENTILATION:**  
 ROOF AREA = 3701 SF/150 = 24.6 SF REQUIRED  
 194 LF OF SOFFIT VENTS @ 9 CUBIC IN./LIN. FT = 145.6 SF  
 6 GABLE VENTS @ 100 CU IN EA. = 4.1 SF  
 6 ROOFTOP VENTS @ 2.25 SF EA = 13.5 SF  
**TOTAL PROVIDED = 163.2 SF**

**1 ROOF PLAN BUILDING B**  
1/4" = 1'-0"



**GRANT & MELLEN SREET**  
**PARKSIDE NEIGHBORHOOD CENTER & AFFORDABLE HOUSING**  
**PEOPLE'S REGIONAL OPPORTUNITY PROGRAM**  
**PORTLAND, MAINE**

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**REVISIONS:**  
 5 GENERAL REVISIONS - 5/30/4

DATE: 01/29/04  
 PROJECT No. 0114  
 DRAWN BY: DAMISA  
 CHECKED BY: TST  
 SCALE: AS NOTED

SHEET TITLE:  
**ROOF PLAN**

**BUILDING B**  
**A1.4**