



GRANT & MELLEN SREET
 PARKSIDE NEIGHBORHOOD CENTER & AFFORDABLE HOUSING
 PEOPLE'S REGIONAL OPPORTUNITY PROGRAM
 PORTLAND, MAINE

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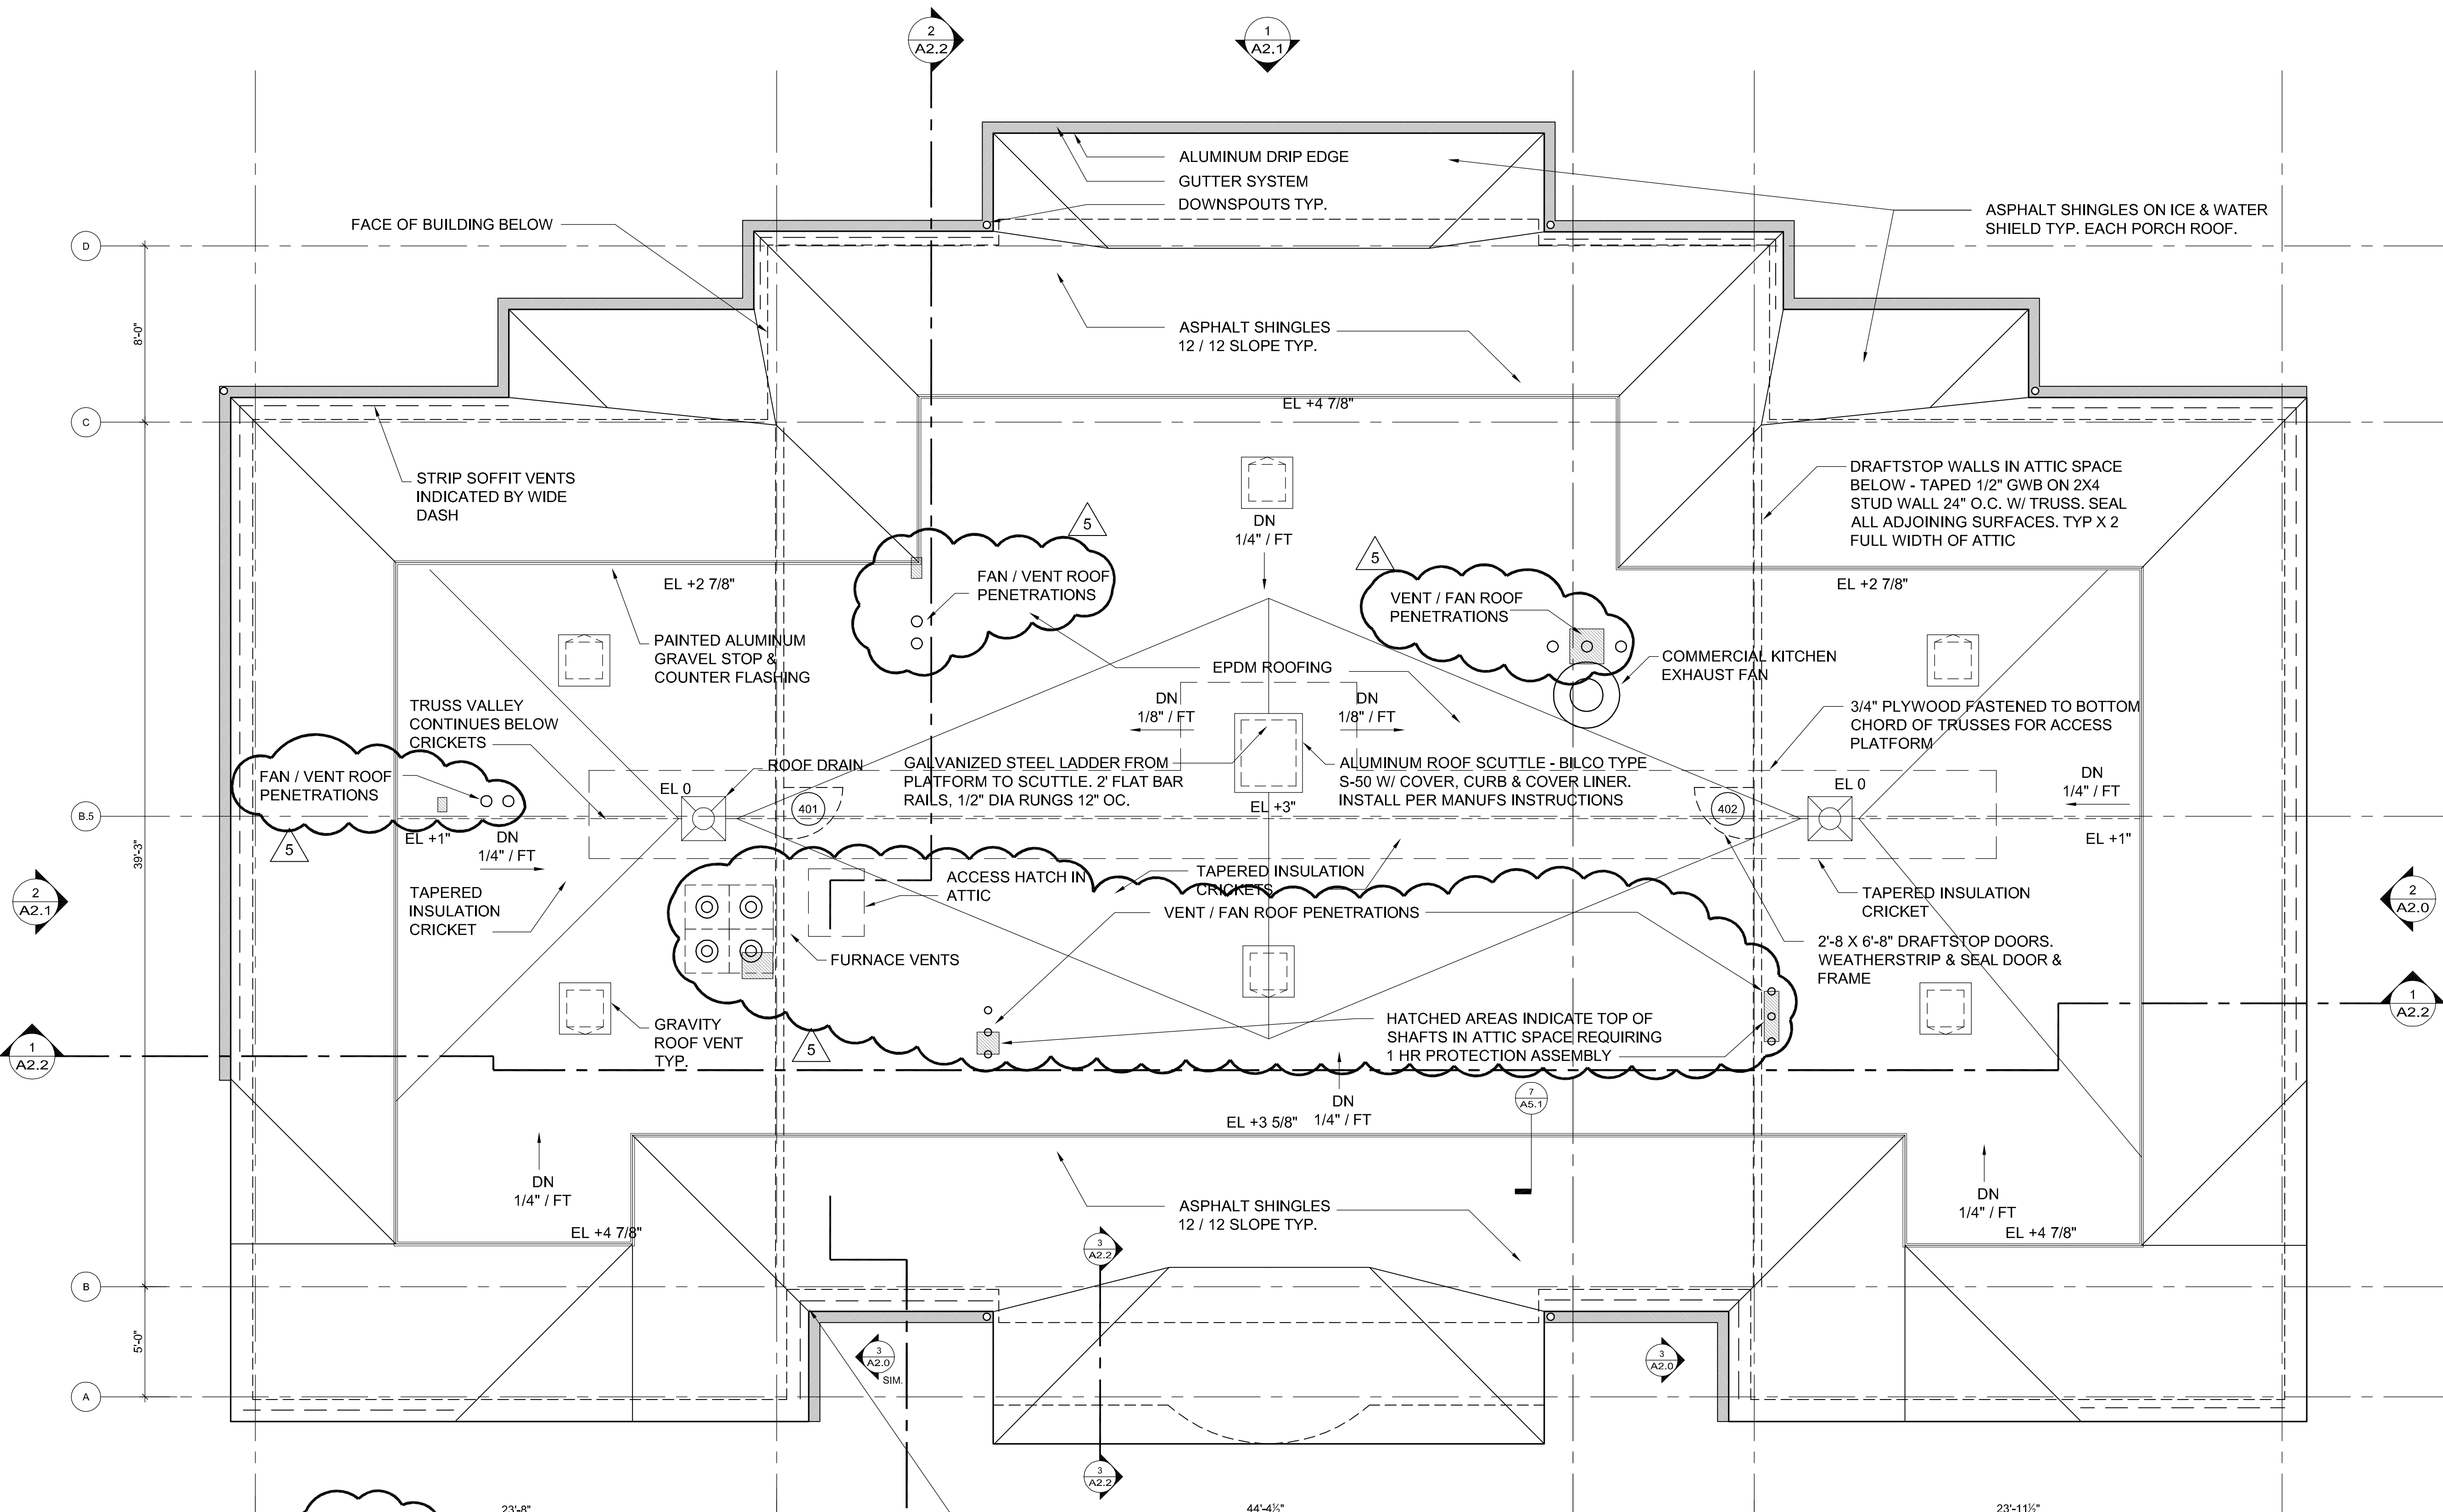
REVISIONS:
 5 GENERAL REVISIONS - 5/30/4

DATE: 01/29/04
 PROJECT No. 0114
 DRAWN BY: DAMISA
 CHECKED BY: TST
 SCALE: AS NOTED

SHEET TITLE:
 ROOF PLAN

BUILDING A

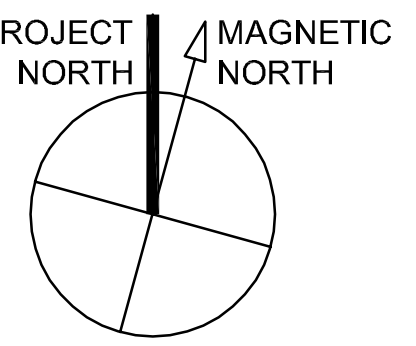
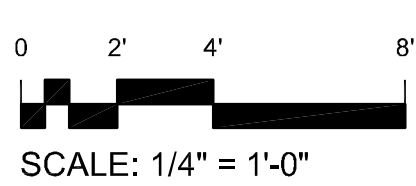
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GENERAL NOTE:
 WHERE VENT OF EXHAUST PIPING PENETRATE THE ATTIC BELOW OR W/ 3' OF SLOPED ASPHALT ROOFS, SLOPE VENT PIPING AWAY FROM ROOF EDGES IN ORDER TO DECREASE VISIBILITY FROM ADJACENT BUILDINGS. LOCATIONS AND QUANTITIES OF ROOF PENETRATIONS ARE SHOWN SCHEMATICALLY. COORDINATE ALL REQUIRED ROOF PENETRATIONS WITH MEP DRAWINGS

HATCHED AREAS INDICATE TOP OF SHAFTS IN ATTIC SPACE REQUIRING 1 HR PROTECTION ASSEMBLY

ATTIC VENTILATION:
 ROOF AREA = 4865 SF / 150 = 32.5 SF REQUIRED
 158 LF OF SOFFIT VENTS @ 9 CUBIC IN./LIN. FT 158'-6" x 9" = 118.5 SF
 4 GABLE VENTS @ 100 CU IN EA. 400 SQ IN. = 2.7 SF
 6 ROOFTOP VENTS @ 2.25 SF EA 13.5 SF
 TOTAL PROVIDED 134.7 SF



1 ROOF PLAN BUILDING A
 1/4" = 1'-0"

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