DISPLAY THIS CARD ON PRINCIPAL FRONTAGE OF WORK

CITY OF PORTLAND

Please Read Application And Notes, If Any, Attached

BU

Permit Number: 081391

f buildings and structures, and of the application on file in

This is to certify that NICO REAL ESTATE LLC /I has permission to Amendment to permit# 08105 -include ral supp for HVAC unit, add storage above break room np, stru AT 691 CONGRESS ST 047 C033001 ting this permit shall comply with all provided that the person or persons, fi or co andn ag

of the provisions of the Statutes of Mane and of the care acces of the City of Portland regulating the construction, maintenance and use this department.

> Not ation o must b spectid nd writte give permissi procure befd this bui hereof i sed-in. 2 lath or oth NOTICE IS REQUIRED. HO

A certificate of occupancy must be procured by owner before this building or part thereof is occupied.

OTHER REQUIRED 4 PPROVALE Fire Dept. Health Dept. DEC Appeal Board Other

Apply to Public Works for street line

and grade if nature of work requires

such information.

PENALTY FOR REMOVING THIS CARD

City of Portland, Main		-			**	mit No:	Issue Date]	CBL:	2001
389 Congress Street, 0410	1 Tel: (207) 874-87 03	, Fax:	(207) 874-871	.6	08-1391	1/1/25/	08	047 C03	3001
Location of Construction:		Owner Name:			Į.	r Address:	77		Phone:	
691 CONGRESS ST		NICO REAL	ESTAT	E LLC	148	SUMMIT PA	ARK AVÉ			
Business Name:		Contractor Name	:		Contr	actor Address:			Phone	
		Benchmark	:	1 take	34 T	homas Dr. W	/estbrook		20759176	00
Lessee/Buyer's Name		Phone:			Permi	t Type:				Zone:
					Ame	endment to C	Commercial		j	RZ
Past Use:		Proposed Use:	===	<u> </u>		it Fee:	Cost of Wor		CEO District:	<i>معادند</i> 1
Commercial - Retail "Gorha	m Dika	Commercial -	Dotail "	Carbam Dilea	[[[[]	\$290.00			2	1
& Ski"	III DIKE	& Ski" Ameno			PIDE		\$27,00			<u> </u>
C SKI		081058 to incl		•	FIRE	DEPT:	Approved	1	CTION:	T.ma. (-1
		support for H					Denied	Use G	roup: M	Type 2
		above break ro			5.	چور		-	TB/	
		metal facade			J ñ	forcliba	2003	سر ا	i e c	ككو
Proposed Project Description:							\sim		^	1
Amendment to permit# 0810					Signat	ture: (, ~ ~ ~ ~	CARR	Signat	ure:	11/25
HVAC unit, add storage abo	ve break	room, add exter	ior met	al facade, add	PEDE	STRIAN ACT	VITIES DIST	RICT (P.A.D.)	17
bar joists					Action	n: Appro	ved 🗀 An	roved 11	/Conditions	l Penied
					Action	п Аррго	ved App	noved w	Conditions	Dellieu
					Signa	ture:			Date:	
Permit Taken By:	Date Ar	oplied For:	T			Zonino	Approva	1	-	
ldobson	1 -	9/2008				Zoning	Approva	11	/	
			Spe	cial Zone or Revi	ews	Zoni	ng Appeal	T	Historic Prese	rvation
1. This permit application			l							
Applicant(s) from meeti Federal Rules.	ng appno	able State and	U Si	oreland		☐ Varianc	e	- 1	Not in District	t or Landn
redetal Rules.										
2. Building permits do not		plumbing,	□ w	etland		Miscella	aneous		Does Not Req	uire Revie
septic or electrical work	•									
3. Building permits are vo	id if work	s is not started	F1	ood Zone		Conditi	onal Use		Requires Revi	iew
within six (6) months of										
False information may i		a building	☐ Sı	ıbdivision		Interpre	tation		Approved	
permit and stop all work	ζ				1-					
			∏ Si	te Plan ALM	ptur	Approve	ed		Approved w/C	Conditions
	_		Loh	e sported!	70				$\widehat{}$	
PEGES	IT ISSU	IED	Maj	☐ Minor ☐ MM		Denied			Denie Denie	
	11336	JLIJ	أ أما		T.L	ر ا		1	- $/$	7
Ì		1 1	Date.	wullan	gm	Date:				
DEC	1 00	5g	Date.	-	 	Date.		12	Date:	
	4	·	•	11	14/0	R				
Marie of Arthurst Marie (1921)						V				
CITY (F										
How insuration has a st. relicio approximate or continuental for continuent) (vi vi vi								
			C	CERTIFICATI	ON					
hereby certify that I am the										
have been authorized by the										
urisdiction. In addition, if a										
shall have the authority to ent	er all are	as covered by su	ich perr	nit at any reaso	nable h	our to enforce	e the provi	sion of	the code(s) app	olicable
uch permit.										
SIGNATURE OF APPLICANT				ADDRES	S		DATE		PHON	NE.
order of the bloom				ADDRES	J		DATE		11101	
RESPONSIBLE PERSON IN CHA		LODE WINT D					DATE		PHON	

BUILDING PERMIT INSPECTION PROCEDURES

Please call 874-8703 or 874-8693 (ONLY)

to schedule your inspections as agreed upon Permits expire in 6 months, if the project is not started or ceases for 6 months.

The Owner or their designee is required to notify the inspections office for the following inspections and provide adequate notice. Notice must be called in 48-72 hours in advance in order to schedule an inspection:

By initializing at each inspection time, you are agreeing that you understand the inspection procedure and additional fees from a "Stop Work Order" and "Stop Work Order Release" will be incurred if the procedure is not followed as stated below.

A Pre-construction Meeting will take place upon receipt of your building permit.

X Final inspection required at completion of work.

·		
Certificate of Occupancy is not required for certain	n projects. Your inspecto	r can advise you if
your project requires a Certificate of Occupancy.	All projects DO require a	final inspection.

If any of the inspections do not occur, the project cannot go on to the next phase, REGARDLESS OF THE NOTICE OR CIRCUMSTANCES.

CERIFICATE OF OCCUPANICES MUST BE ISSUED AND PAID FOR, BEFORE THE SPACE MAY BE OCCUPIED.

Beach IL	12/1/08
Signature of Applicant/Designee	Date
Signature of Inspections Official	Date

CBL: 047 C033001

Building Permit #: 08-1391

City of Portland, Main	e - Building or Use Permit			Permit No:	Date Applied For:	CBL:
•	1 Tel: (207) 874-8703, Fax: (2	207) 87	4-8716	08-1391	10/29/2008	047 C033001
Location of Construction:	Owner Name:			Owner Address:		Phone:
691 CONGRESS ST	NICO REAL ESTATE	LLC		148 SUMMIT PA	RK AVE	
Business Name:	Contractor Name:		- (Contractor Address:		Phone
	Benchmark			34 Thomas Dr. We	estbrook	(207) 591-7600
Lessee/Buyer's Name	Phone:		j	Permit Type:		
				Amendment to Co	ommercial	
Proposed Use:			Propose	d Project Description:		<u></u>
Commercial - Retail "Gorha	m Bike & Ski" Amendment to per	mit#	Amend	dment to permit# 0	81058 to include rar	mp, structural supp
	ictural support for HVAC unit, add				ge above break rooi	m, add exterior met
storage above break room, a	dd exterior metal facade, add bar j	joists	facade	, add bar joists		
				<u> </u>		
Dept: Zoning S	tatus: Approved with Conditions	Rev	viewer:	Marge Schmucka	al Approval I	Date: 11/04/200
Note:	-					Ok to Issue:
1) Any previous conditions	on the previous renovation permit	t are still	l in forc	e.		
, , ,	•					
	e required for any new signage.					
This permit is being appropriate starting that work.	roved on the basis of plans submit	ted on 1	1/3/08.	Any deviations sh	all require a separat	e approval before
Dept: Building S	tatus: Approved with Conditions	Rev	viewer:	Chris Hanson	Approval I	Date: 12/01/200
Note:					• •	Ok to Issue:
This permit is issued bas for handrails and guards.	ed on the plans submitted. Variation	ons in ac	ctual co	nstruction that effe	ct grades may chang	ge the requirements
Permit approved based of noted on plans.	on the plans submitted and reviewe	ed w/own	ner/cont	ractor, with addition	onal information as a	agreed on and as
Dept: Fire S	tatus: Approved with Conditions	Rev	viewer:	Capt Greg Cass	Approval D	Date: 11/06/200
l -	neet to reflect current codes used.					Ok to Issue:
-	uired to be tested at the electrical	nanel				
	ed. Installation per NFPA 10	Panoi.				
, , , , , , , , , , , , , , , , , , , ,	•					
3) All means of egress to re				•		
4) The Fire alarm and Spring	nkler systems shall be reviewed by	a licens	ed cont	ractor[s] for code of	ompliance.	

- 4) The Fire alarm and Sprinkler systems shall be reviewed by a licensed contractor[s] for code compliance. Compliance letters are required.
- 5) All construction shall comply with NFPA 101
- 6) Application requires State Fire Marshal approval.

Comments:

11/26/2008-gg: received granted site exemption as of 11/25/08. /gg filed with permit (Chris)

10/30/2008-mes: The front staff did not get a site plan with this application. There is a new exterior ramp addition being added. Applicant had the wrong zone on other drawings. This property is located within a B-2b Zone not a B-1b zone. Left a message with Richard Egan - remided him that he needs a site plan review or an exemption from it from Planning.

11/4/2008-mes: on 11/3/08 I received a plot plan for the new work (ramp & new façade extension). I reminded Jessie Thompson that at a minimum a site plan exemption is required from Planning - Barbara is aware of the work. HOLD FOR SITE PLAN EXEMPTION

Amended General Building Permit Application

If you or the property owner owes real estate or personal property taxes or user charges on any property within the City, payment arrangements must be made before permits of any kind are accepted.

Location/Address of Construction: 69/	Congress St Portland Square Footage of Lot	
Total Square Footage of Proposed Structure	Square Footage of Lot	
4,800	, 247	·
Tax Assessor's Chart, Block & Lot	Owner: Koutsivitis Dorothy	B Telephone:
Chart# Block# Lot#	Trustee	591-7606
047 603301		011 7000
Lessee/Buyer's Name (If Applicable)	Applicant name, address & telephone:	Cost Of Work: \$ 27,000
James Wright Gorham	207-591-7606	Work: \$ & 1,000
Bike - Ski	Benchmark.	Fee: \$ 290
101/22	34 Thomas Drive	
	Westbrook	C of O Fee: \$
Current legal use (i.e. single family) If vacant, what was the previous use?	an (
Proposed Specific use: Refail		
Is property part of a subdivision?	If yes, please name	
Project description: Amendment - 1	Add ramp eside door, Add	Structural support
Project description: Amendment - For HVAC unit, Add storage	e above breakvoom, add ex	terior metal facade
add bar joists		,
Contractor's name, address & telephone: Who should we contact when the permit is read Mailing address:	enchmade 34 Thomas D	rive Westbrook
Who should we contact when the permit is read	dy: Richard Egan	591-7606
Mailing address:	Phone:	
Please submit all of the information out	lined in the Commercial Application (Checklist
Failure to do so will result in the automa		one canon
In order to be sure the City fully understands the ful request additional information prior to the issuance other applications visit the Inspections Division on-l	of a permit. For further information or to downlo	oad copies of this form and
room 315 City Hall or call 874-8703.		pat g 0 23 _g :
I hereby certify that I am the Owner of record of the name been authorized by the owner to make this application as h In addition, if a permit for work described in this application authority to enter all areas covered by this permit at any rea	nis/her authorized agent. I agree to conform to all app on is issued, I certify that the Code Official's authorized	licable laws of this jurisdiction. d representative shall have the

This is not a permit; you may not commence ANY work until the permit is issued.

Signature of applicant:

Date: 10-29-08



Certificate of Design

Date:	10/24/08
From:	Aaron C Jones, PE, SECB
-	Bike + SKI RNOVE from 1+
	Congress street
Have been designed	d and drawn up by the undersigned, a Maine registered Architect / to the 2003 International Building Code and local amendments. Structure ONLy! Signature: President Firm: Structural Integrity, Inc. Address: 77 OAK Street
	for Hand, ME 0410

For more information or to download this form and other permit applications visit the Inspections Division on our website at www.portlandmaine.gov

Phone:



Certificate of Design Application

From Designer: Date: Job Name: Address of Construction: 2003 International Building Code Construction project was designed to the building code criteria listed below: Building Code & Year 2003 IBC Use Group Classification (8) Type of Construction V-B Now 1 Will the Structure have a Fire suppression system in Accordance with Section 903.3.1 of the 2003 IRC Is the Structure mixed use? See Arch If yes, separated or non separated or non separated (section 302.3) Supervisory alarm System? See My Geotechnical/Soils report required? (See Section 1802.2) Structural Design Calculations Live load reduction Freque Submitted for all structural members (106.1 – 106.11) Roof live loads (1603.1.2, 1607.11) Roof snow loads (1603.7.3, 1608) Design Loads on Construction Documents (1603) Ground snow load, Pg (1608.2) Uniformly distributed floor live loads (7603.11, 1807) Floor Area Use If Pg > 10 psf, flat-roof snow load pr If $P_g > 10$ psf, snow exposure factor, C_g If $P_g > 10$ psf, snow load importance factor, I_c Roof thermal factor, G(1608.4)Sloped roof snowload, Ps(1608.4) Wind loads (1603.1.4, 1609) Seismic design category (1616.3)

Basic seismic foice resisting system (1617.6.2) Amalytical Design option utilized (1609.1.1, 1609.6) flom Masony Basic wind speed (1809.3) Response modification coefficient, Rt and .0 Building category and wind importance Factor, b deflection amplification factor (1617.6.2) Wind exposure category (1609.4) Analysis procedure (1616.6, 1617.5) p : <u>50.18</u> Internal pressure coefficient (ASCE 7) **4** Design base shear (1617.4, 16175.5.1) Component and cladding pressures (1609.1.1, 1609.6.2.2) Flood loads (1803.1.6, 1612) Main force wind pressures (7603.1.1, 1609.6.2.1) Flood Hazard area (1612.3) Earth design data (1603.1.5, 1614-1623) 150/th Simplified Elevation of structure Design option utilized (1614.1) Other loads Seismic use group ("Category")


Concentrated loads (1607.4)

Misc. loads (Table 1607.8, 1607.6.1, 1607.7, 1607.12, 1607.13, 1610, 1611, 2404

Partition loads (1607.5)

Spectral response coefficients, SDs & SD1 (1615.1)

Site class (1615.1.5)

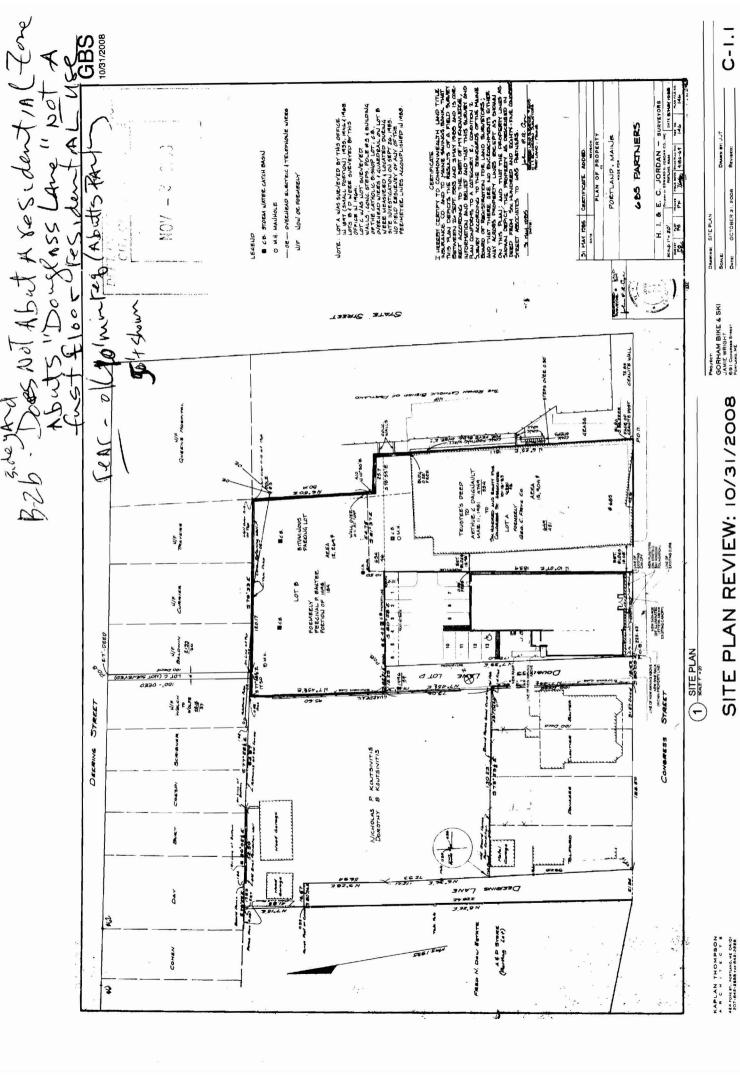

KAPLAN THOMPSON ARCHITECTS

TRANSMITTAL

TO: CHRIS HANSON

VIA: FAX 974-4716


DATE: Nov 25, 2008

PAGES: 3

RE: 691 CONGRESS, GORHAM BIKE & SKI

Chris,

SK's for GBS ramp / stair.

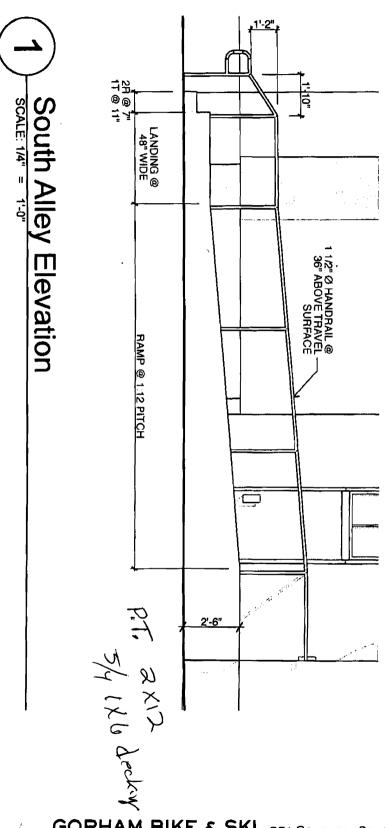

снітєсть

424 FORE ST., PORTLAND, ME 04101 207-842-2888 FAX:842-2828


GORHAM BIKE & SKI, 69 | CONGRESS ST., PORTLAND, ME

REVISED REAR ENTRY ELEVATION DRAWING:

NOVEMBER 25, 2008

1/4" = 1'-0" SCALE: DATE:

SK-13

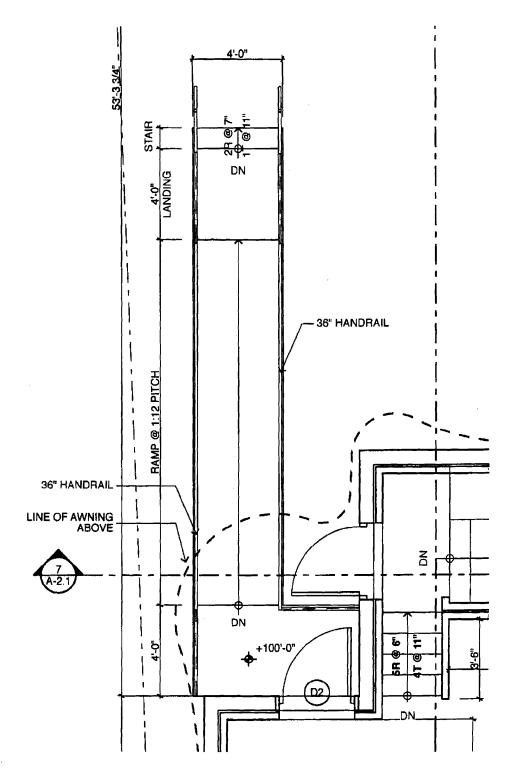



CHITECTS 424 FORE ST., PORTLAND, ME 04101 207-842-2888 FAX:842-2828

GORHAM BIKE & SKI, 691 CONGRESS ST., PORTLAND, ME REVISED REAR ENTRY PLAN

DRAWING: SCALE: 1/4" = 1'-0" DATE: NOVEMBER 25, 2008

SK-12

KAPLAN THOMPSON ARCHITECTS

TRANSMITTAL

TO: CHRIS HANSON

VIA: FAX 974-8716

DATE: Nov 25, 2008

PAGES: 3

RE: 691 CONGRESS, GORHAM BIKE & SKI

Chris,

SK's for GBS ramp / stair.



GORHAM BIKE & SKI

PROJECT INFORMATION

Client: JAMIE WRIGHT

Architect: Kaplan Thompson Architects

Contractor: Benchmark Construction

Book/Page: 26121/337, 47-C-33

Project Address: 691 Congress St.

Zoning: B-2B district

Building Codes: IRC 2003 NFPA / 1999

Site Area: 10,762 SF / 0.24 ACRE

Building SF: 5,200 SF

Occupancy: I-M (Retail), Type V-B Non-Rated

Maximum Building Height: 45'-0"

Setbacks: Front: !10'-0" Max Side: !0'-0" Rear: !10'-0"

DRAWING INDEX

COVER SHEET

C-1.1 SITE PLAN

A-1.1 BASEMENT FLOOR PLAN

A-1.2 MAIN FLOOR PLAN

A-1.3 UPPER FLOOR PLAN

A-1.4 ROOF PLAN

A-2.1 ELEVATIONS & SECTIONS

A-5.1 CANOPY DETAILS

A-6.1 INTERIOR ELEVATIONS

A-9.1 PERSPECTIVES

E-1.1 REFLECTED CEILING PLAN

E-1.2 REFLECTED CEILING PLAN: QU...

S-1.1 STRUCTURAL GENERAL NOTES

S-1.2 FRAMING PLANS


S-1.3 STRUCTURAL DETAILS

KAPLAN THOMPSON 424 FORE ST., PORTLAND, ME 0410: 207-842-2888 FAX:842-2828


DRAWING: COVER SHEET

DATE: OCTOBER 31, 2008


2 North Alley Elevation DECORATIVE 1/8" X 4" STEEL RING, POWDER COATED 88 South Alley Elevation 88 6 North / South Building Section **(A)** ₿ **F** 8 North / South Building Section 1101/ - -

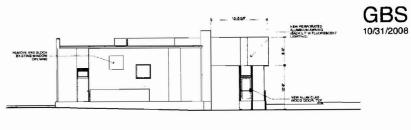


Rear Elevation

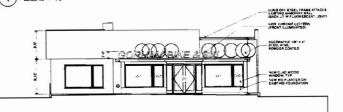


3 Congress Elevation

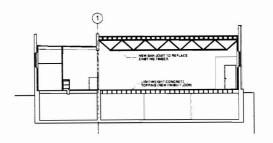

5 East / West Building Section

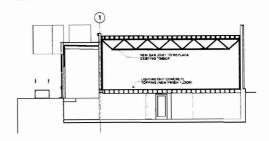

7 East / West Building Section

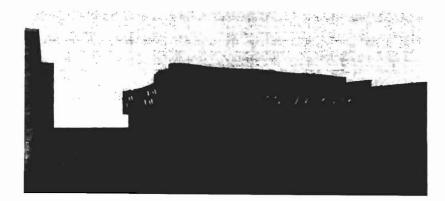

GORHAM BIKE & SKI

PROJECT INFORMATION

Client: JAMIE WRIGHT

Architect: Kaplan Thompson Architects

Contractor: Benchmark Construction

Book/Page: 26121/337, 47-C-33

Project Address: 691 Congress St.

Zoning: B-2B district

Building Codes: IBC 2003 NFPA / 2006

Site Area: 10,762 SF / 0.24 ACRE

Building SF: 5,200 SF

Occupancy: I-M (Retail), Type V-B Non-Rated

Maximum Building Height: 45'-0"

Setbacks: Front: 10'-0" Max Side: 0'-0" Rear: 10'-0"

DRAWING INDEX

COVER SHEET

C-1.1 SITE PLAN

A-1.1 BASEMENT FLOOR PLAN

A-1.2 MAIN FLOOR PLAN

A-1.3 UPPER FLOOR PLAN

A-1.4 ROOF PLAN

A-2.1 ELEVATIONS & SECTIONS

A-5.1 CANOPY DETAILS

A-6.1 INTERIOR ELEVATIONS

A-9.1 PERSPECTIVES

E-1.1 REFLECTED CEILING PLAN

E-1.2 REFLECTED CEILING PLAN: QUALITY LIGHTING

S-1.1 STRUCTURAL GENERAL NOTES

S-1.2 FRAMING PLANS


S-1.3 STRUCTURAL DETAILS

KAPLAN THOMPSON 424 FORE ST , PONTLAND, ME 04101 207-842-2888 FAX:842-2828

PROJECT:
GORHAM BIKE & SKI
JAMIE WRIGHT
691 CONGRESS 51
POSTURED, ME

DRAWING: COVER SHEET

DATE: OCTOBER 31, 2008

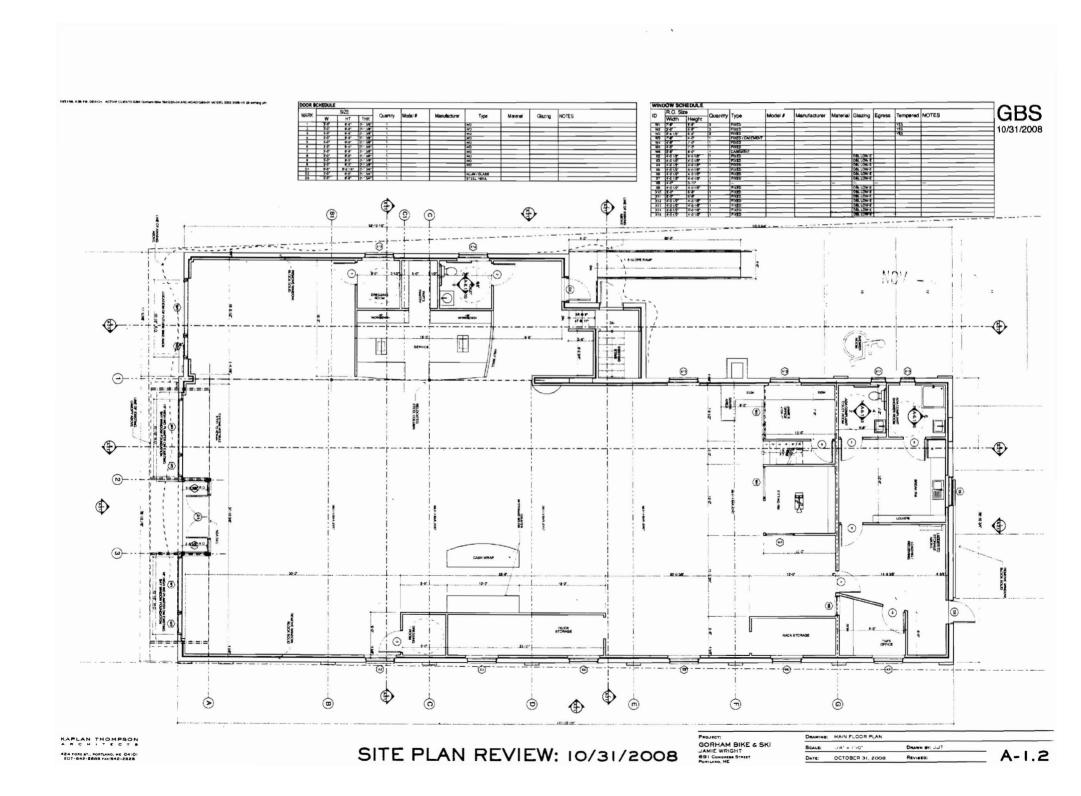



Application for Exemption from Site Plan Review Portland, Maine

Department of Planning and Urban Development, Planning Division and Planning Board

1.	Applicant Information	2. Project Information	o n
	Coorham Biller SKi - Jamie Waryth Applicant/Owner	Application Date	
	Mailing Address	Project Name/Description	
	Consultant/Agent 424 Fine St. Port M. 04101	Address of Proposed Site	~ (033
	842 - 2888 /842 2828 / Phone Fax Cell	Assessor's Reference (Chart	t-Block-Lot) et 1391
	Adding a new camp, Signage	and intoxio	a complyint is
•	ease Attach Sketch/Plan of Proposal/Development) riteria for Exemptions: (See Section 14-523 (4) on page 2 of	this application) Applicant's Assessment (Yes, No, N/A)	Planning Division Use Only
a)	Within Existing Structures: No New Buildings, Demolitions or Additions	_ O o	
b)	Footprint Increase Less Than 500 sq. ft.		<i>\bigcup'</i>
c)	No New Curb Cuts, Driveways, Parking Areas		
d)	Curbs and Sidewalks in Sound Condition/Comply with ADA		
e)	No Additional Parking/No Traffic Increase	— yes	
f)	No Known Stormwater Problems	<u> </u>	
g)	Sufficient Property Screening Exists		
h)	Adequate Utilities		· · · · · · · · · · · · · · · · · · ·
Г	Planning Divi	ision Use Only	
E	exemption Granted Partial Exemption Exe	mption Denied	NOV 2 6 2003
P	lanner's Signature	Date Nov. 25, 2	COX

PROVISION OF PORTLAND CITY CODE 14-523 (SITE PLAN ORDINANCE) RE: EXEMPTIONS FROM SITE PLAN REVIEW

Sec. 14-523. Approval required.

No person shall undertake any development without obtaining approval therefore under this article.

- (4) The Planning authority shall exempt from review under all standards in this article developments that meet all of the following requirements:
 - a. The proposed development will be located within existing structures, and there will be no new buildings, demolitions, or building additions other than those permitted by subsection b of this section;
 - b. Any building addition shall have a new building footprint expansion of less than five hundred (500) square feet;
 - c. The proposed site plan does not add any new curb cuts, driveways, or parking areas; the existing site has no more than one (1) curb cut and will not disrupt the circulation flows and parking on-site; and there will be no drive-through services provided;
 - d. The curbs and sidewalks adjacent to the lot are complete and in sound condition, as determined by the public works authority, with granite curb with at least four (4) inch reveal, and sidewalks are in good repair with uniform material and level surface and meet accessibility requirements of the Americans with Disabilities Act;
 - e. The use does not require additional or reduce existing parking, either on or off the site, and the project does not significantly increase traffic generation;
 - f. There are no known stormwater impacts from the proposed use or any existing deficient conditions of stormwater management on the site;
 - g. There are no evident deficiencies in existing screening from adjoining properties; and
 - h. Existing utility connections are adequate to serve the proposed development and there will be no disturbance to or improvements within the public right-of-way.

A developer claiming exemption under this subsection shall submit a written request for exemption stating that the proposed meets all of the provisions in standards a-h of this subsection, including an itemized statement by a qualified professional. Upon receipt of such a request, the planning authority will visit the site to verify that the exemption is applicable due to compliance with the standards. The planning authority, after consultation with the public works authority, shall render a written decision within twenty (20) working days after receipt of a written request for exemption that contains all the information required by this subsection. If a full exemption is granted, the application shall be approved without further review under this article, and no performance guarantee shall be required. The planning authority may require full site plan review of a project that meets the criteria of this subsection if it determined that there is a substantial public interest in the project.

In the event that the planning authority determines that standards a and b of this subsection and at least four (4) of the remaining standards have been met, the planning authority shall review the site plan under the review standards in section 14-526 that are affected by the standards in this subsection that have not been met. An application that receives review by the planning board shall receive a complete review under the standards of section 14-526. The planning authority shall notify an applicant in writing that full or partial site plan review is required, the reasons for the decision, and the information that will be required for site plan review.

IMPORTANT NOTICE TO APPLICANT

An Exemption from site plan review does not exempt this proposal from other approvals or permits, nor is it an authorization for construction. You should first check with the Building Inspections Office, Room 315, City Hall (874-8703), to determine what other City permits, such as a building permit, will be required.

see en seu recarred bi



GORHAM BIKE & SKI

PROJECT INFORMATION

Client: JAMIE WRIGHT

Architect: Kaplan Thompson Architects

Contractor: Benchmark Construction

Book/Page: 26121/337, 47-C-33

Project Address: 691 Congress St.

Zoning: B-1B district

Building Codes: IRC 2003 NFPA / 1999

Site Area: 10,762 SF / 0.24 ACRE

Building SF: 5,200 SF

Occupancy: I-M (Retail), Type V-B Non-Rated

Maximum Building Height: 35'-0"

Setbacks: Front: 10'-0" Max

Side: 0'-0" Rear: 0'-0"

DRAWING INDEX

Cover Sheet

A-1.1 Basement Floor Plan

A-1.2 Main Floor Plan

A-1.3 Upper Floor Plan

30 2

A-1.4 Roof Plan

A-2.1 ELEVATIONS & SECTIONS

A-6.1 INTERIOR ELEVATIONS

E-1.1 REFLECTED CEILING PLAN

E-1.2 REFLECTED CEILING PLAN: QU...

S-1.1 STRUCTURAL GENERAL NOTES

S-1.2 FRAMING PLANS


S-1.3 STRUCTURAL DETAILS

PROJECT:
GORHAM BIKE & SKI
JAMIE WRIGHT
691 CONGRESS ST.
PORTLAND, ME

DRAWING: COVER SHEET

DATE: OCTOBER 24, 2008

REVISED:

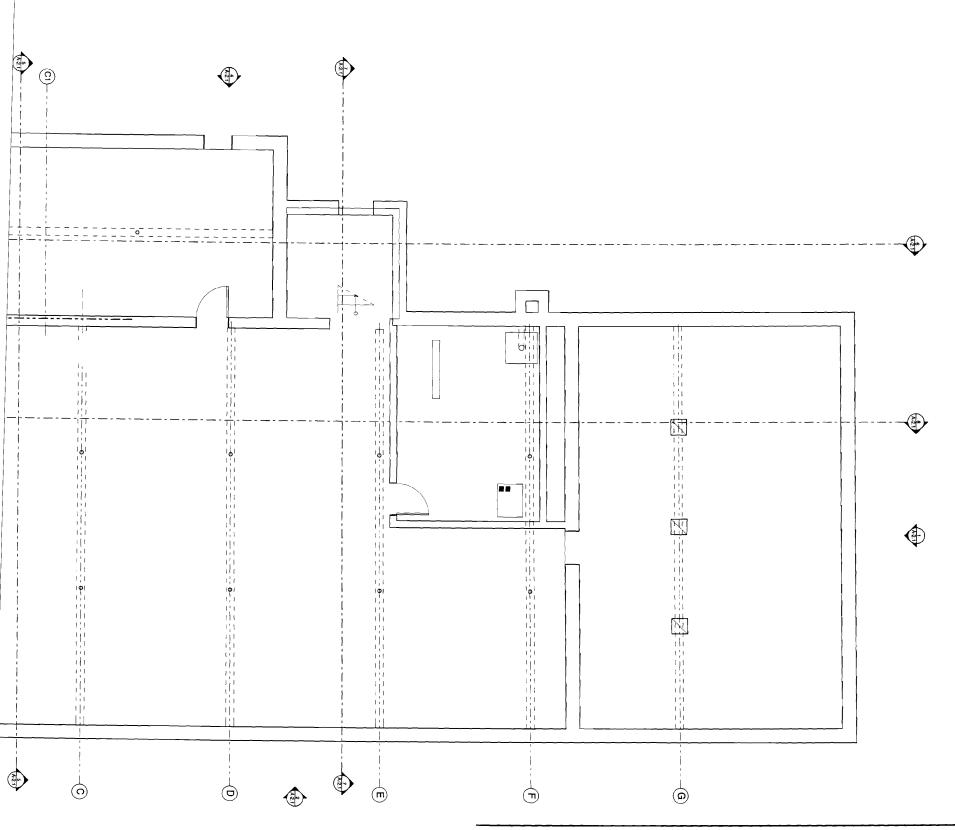


ON DOCUMENTS: 10/24/2008

PROJECT:
GORHAM BIKE & SKI
JAMIE WRIGHT
691 CONGRESS STREET
PORTLAND, ME

DRAWING:	BASEMENT FLOOR PLAN		
SCALE:	1/4" = 1'-0"	DRAWN BY: JJT	
DATE:	OCTOBER 24, 2008	REVISED:	


A-1.1

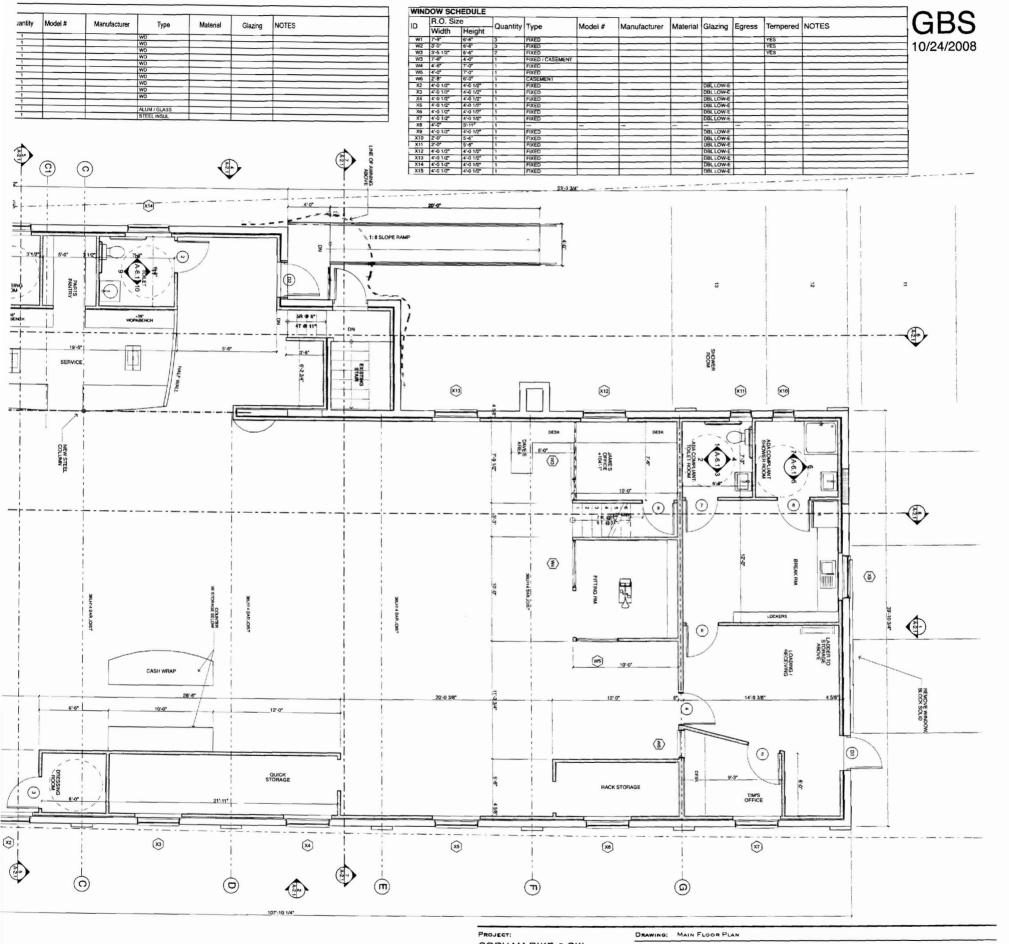

ON DOCUMENTS: 10/24/2008

GORHAM BIKE & SKI JAMIE WRIGHT 691 Congress Street Portland, ME
 Scale:
 1/4" = 1'-0"
 Drawn BY: JJT

 Date:
 OCTOBER 24, 2008
 Revised:
 A-1.2

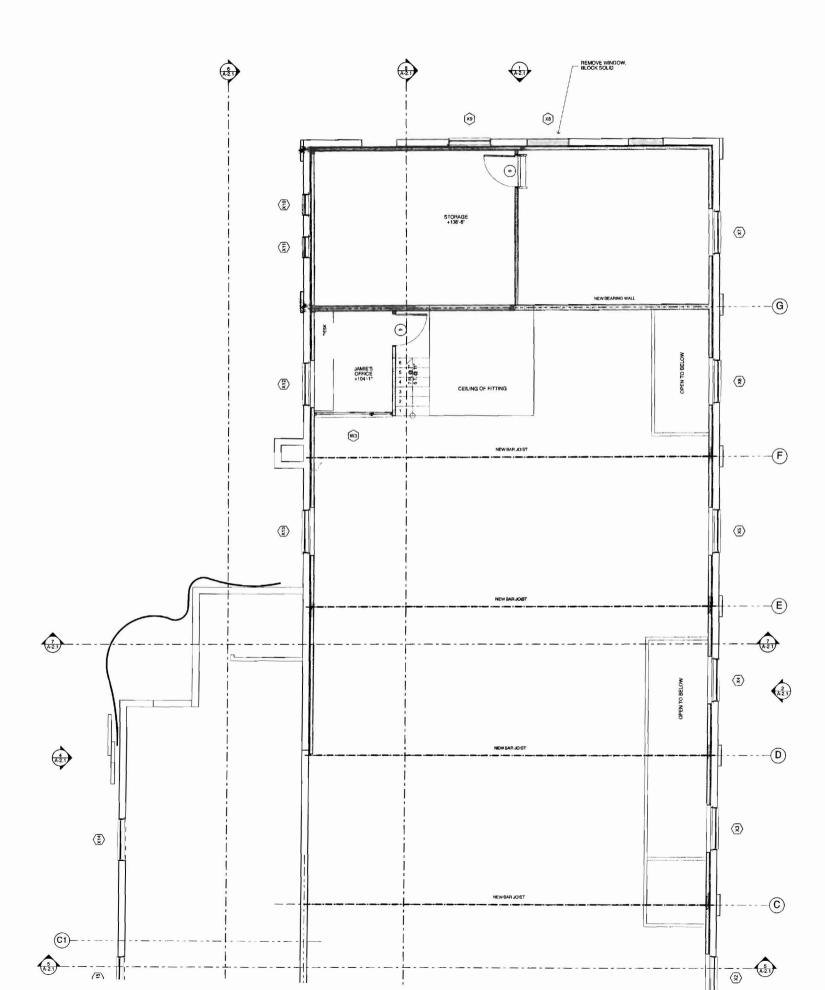


PROJECT:
GORHAM BIKE & SKI
JAMIE WRIGHT
691 CONORES STREET
PORTLAND. ME

DRAWN BY: JUT 1/4" = 1'-0" OCTOBER 24, 2008 DRAWING: SCALE: DATE:

A-1.3

ON DOCUMENTS: 10/24/2008

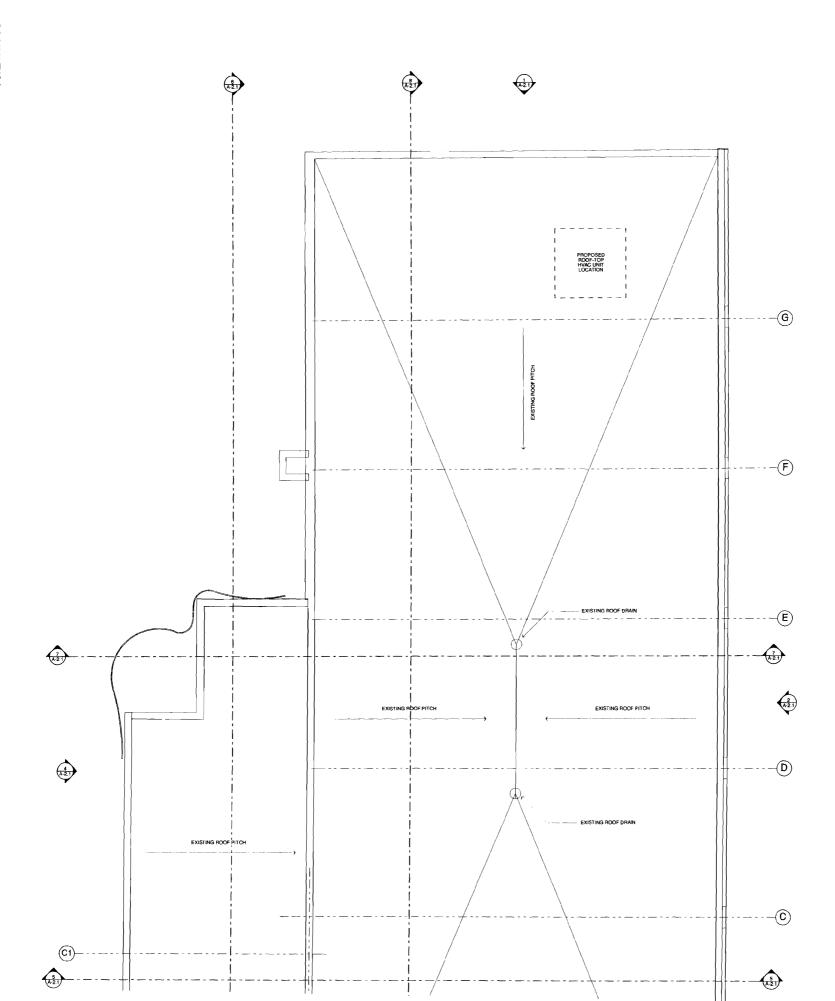


ON DOCUMENTS: 10/24/2008


PROJECT:
GORHAM BIKE & SKI
JAMIE WRIGHT
691 CONORES STREET
PORTIVAL, ME

DRAWN BY: JUT ROOF PLAN 1/4" = 1'-O" OCTOBER 24, 2008 DRAWING: SCALE: DATE:

A-1-A

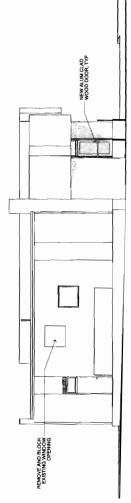


Rear Elevation

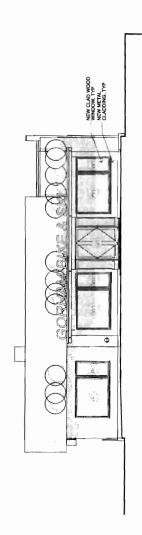

Congress Elevation

(B)


0

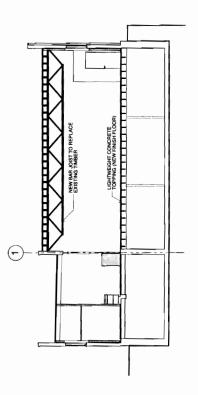

East / West Building Section

a


(0)

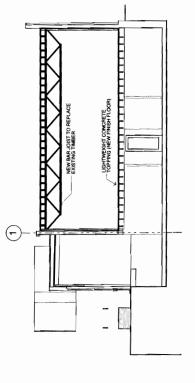


East / West Building Section


PROJECT:
GORHAM BIKE & SKI
JAMIE WRIGHT
691 CONGRESS STREET
PORTUND, ME

DRAWN BY: JUT REVISED: OCTOBER 24, 2008 DRAWING: SCALE: DATE:

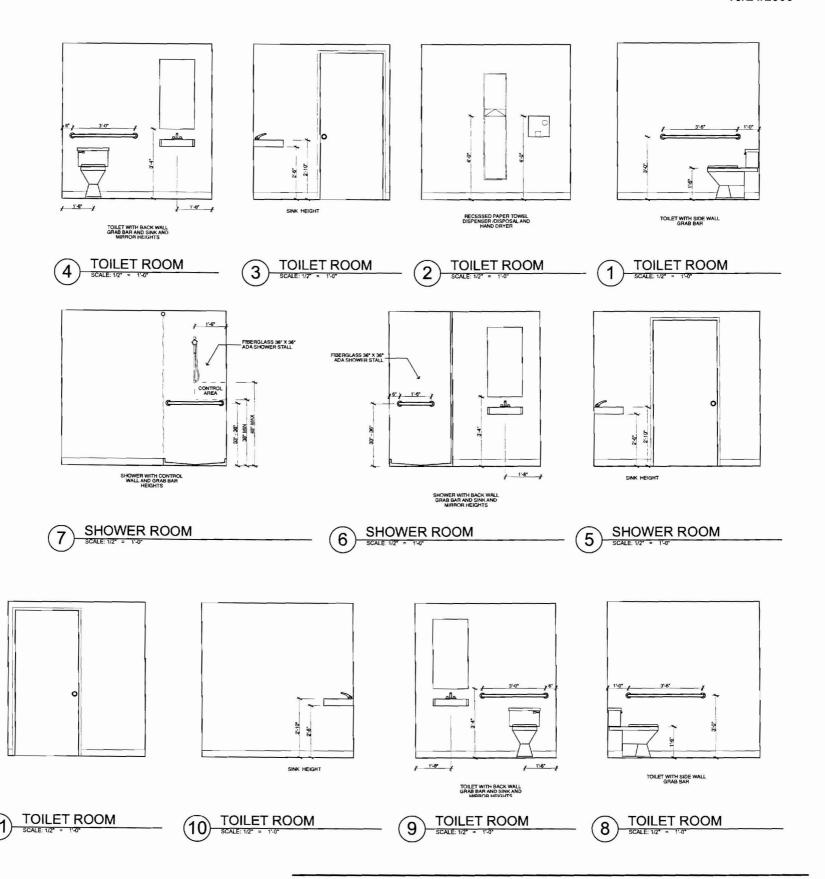



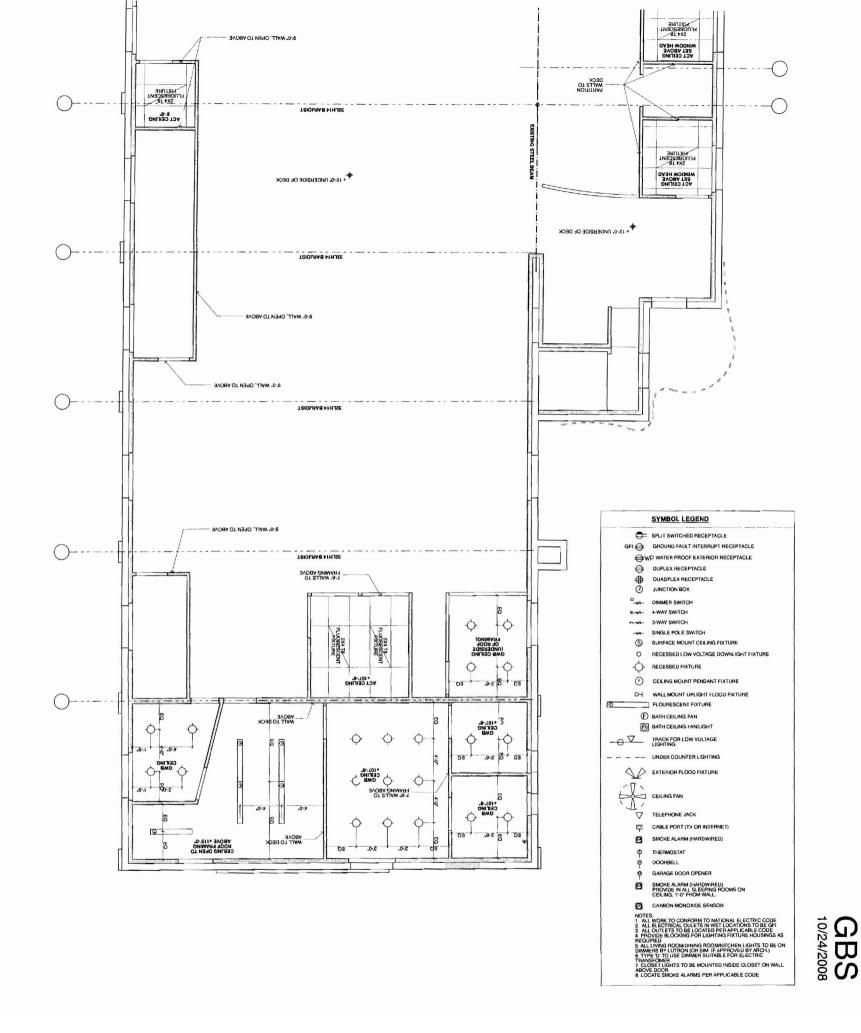

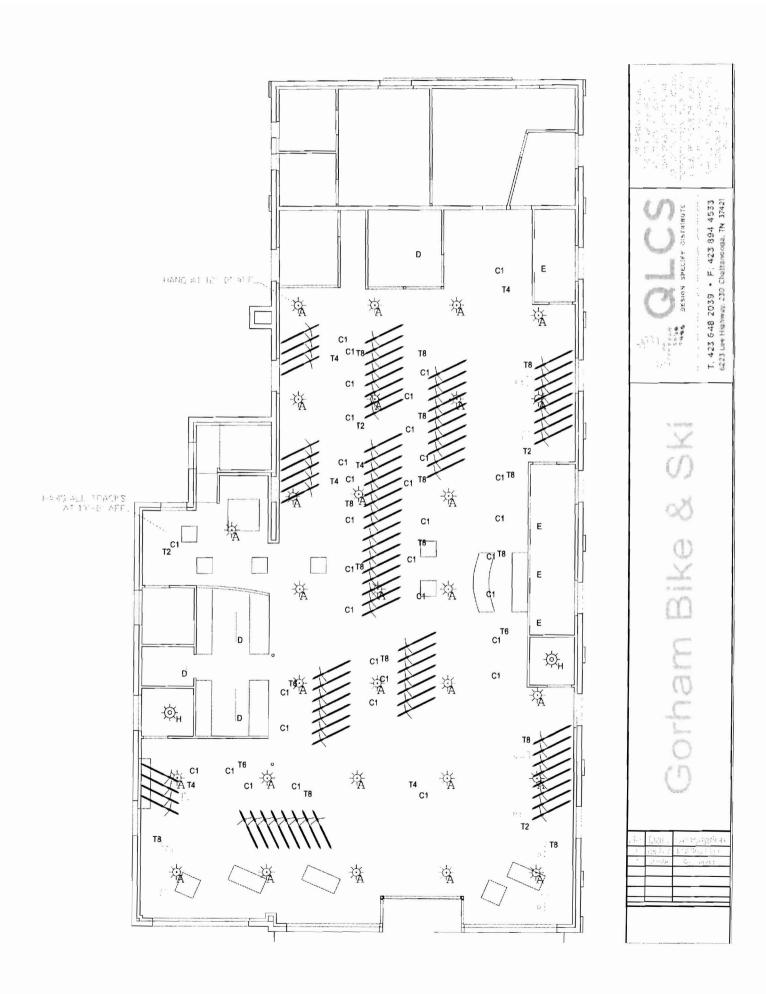

ON DOCUMENTS: 10/24/2008

PROJECT:
GORHAM BIKE & SKI
JAMIE WRIGHT
691 Congress Street
Postland, ME

DRAWING: REFLECTED CEILING PLAN: OUALITY LIGHTING
SCALE: DRAWN BY; JUT
DATE: OCTOBER 24, 2009 REVIEED:

E-1.2

STRUCTURAL GENERAL NOTES

DESIGN LOADS: International Building Code; IBC 2003 Edition, except as noted Occupancy Category, Table 1604.5

Roofs: Ground Snow, Pg S0 psf (used for dr 35 psf Flat Roof Snow, Pf Snow Exposure Factor Pf Snow importance Factor, Snow Thermal Factor, Ct Table 1608.3.2 1.0 Floors: Office S0 psf Partitions in Offices Corridors & Public Spaces Storage Areas 125 psf Commercial 1" floor 100 psf Lateral Lateral 100 psf Storage Areas 100 psf Commercial 1" floor 100 psf Commercial 1" floor	rifting ca	loulations
Flat Roof Snow,	rifting ca	leulatione
Snow Exposure Factor		in unations
Snow importance Factor, Is Table 1604.5 1.0		
Snow Thermal Factor, Ct Table 1608.3.2 1.0		
Floors: Office		
Office 50 psf Partitions in Offices 20 psf Corridors & Public Spaces 100 psf Storage Areas 1.25 psf Commercial 1" floor 100 psf		
Partitions in Offices 20 psf Corridors & Public Spaces 100 psf Storage Areas 125 psf Commercial 1" floor 100 psf		
Corridors & Public Spaces 100 psf Storage Areas 125 psf Commercial 1 st floor 100 psf		
Storage Areas 125 psf Commercial 1 st floor 100 psf		
Commercial 1st floor 100 psf		
Internal		
Wind IBC 1603.1.4, ASCE 7-02 Analytic Method		
3 Second Gust Velocity 100 mph		
Importance Factor 1.0		
Building Category and Internal Pressure Coefficient		
IBC 1609.2, ASCE Figure 6-5 Enclosed	GCp	i=0.18
Exposure B		
Seismic Use Group		
Importance Factor 1.0		
Spectral Response Acceleration	Coef	fficient
Short Period S _s 0.30 g	Sps	0.20 g
One Second S ₁ 0.07 g	Spt	0.05 g
Soils Site Class Table 1615.1.1 D		
Design Category Table 1616.3 B		

- CONCRETE AND REINFORCEMENT: shall conform to applicable provisions of ACI-301 and 318. Concrete shall conform to applicable provision Minimum 28 day compressive strength (F'c)
- as follows:
 Interior Slabs on Deck: 3,000 psi with Fibermesh
 Cement Type:
 All other: I/II
- * Deformed reinforcement: ASTM A615 grade 60, except bars specified to be field-bent, stirrups, and ties Deformed reinforcement: ASIM A615 grade 60, except bars specified to be field-bent, stirrups, and ties which shall be grade 40.

 Fibremesh: 100% virgin polypropylene, fibrillated fibers as manufactured by Fibremesh Co. per ASTM C-1116 type 1114 1.13 and ASTM C-1116 be per formance level one. 1.5 lb. per cubic yard. Welded Wire Fabric (WWF): ASTM A185. See also plan.

 Reinforcement shall be fabricated and placed per ACI Manual of Standard Practice (ACI-315). At splices, lap bars 50 diameters unless noted otherwise.

- lap bars 30 dameters unless noted otherwise.

 Minimum 2 #5 around all four sides of all openings, extend min. 2'-0 beyond openings.

 * Concrete cover over reinforcing: 1'/₂" for concrete placed against forms; 3" for concrete placed against earth. See also drawings.

 In continuous members, splice top bars at mid span and bottom bars over supports.

 * Keep reinforcement clean and free of dirt, oil, scale. Oil forms prior to placing reinforcement.

- WOOD FRAMING:

 Dimension Lumber is designed and shall be supplied using BASE VALUES Design Criteria.

 SPF #2 and better (Maximum Moisture Content 19%) U.O.N.
- SPF #2 and better (Maximum Moisture Content 19%) U.O.N.
 Plates: Sill plates: Preservative treated Southern Pine.
 "Pressure treated lumber" shall be framing material of the specified species which has been pressure treated with a decay and insect resistant solution, neeting all current standards for wood in contact with concrete orarth. Sill plates in contact with masonry or concrete foundations, footings or slass may be treated Timber Strand LSL (zine borate treatment). Acceptable treatment mediums for wood in contact with earth or in exterior applications include ACQ (Alkaline Copper Quaternary) and copper azole. All connectors shall meet the recommendations of the pressure treated wood manufacturer, but shall be not less than Hol Dipped Galvanized or Stainless Steel. All screws, nails and bolts shall match hangers and other connectors. Do not mix estimless with adaptainged producers.

- meet the recommendations of the pressure treated wood manufacturer, but shall be not less than Hot Dipped Galvanized or Stainless Steel. All screws, nails and bolts shall match hangers and other connectors. Do not mix stainless with galvanized products.

 Do not allow aluminum to contact treated wood.

 Top and Bottom Plates: Hern Fir

 SPF Studs U.O.N: 2 x 4 and 2 x 6 to 8*-0: stud grade

 2x4 over 8*-0 standard and better

 2x6 over 8*-0 No. 2 and better

 Floor Joists: SPF No. 1 or better Fb=875 psi, E=1,400,000

 Rafters: SPF No. 1 or better Fb=875 psi, E=1,400,000

 Beams:SPF No. 1, Fb=1100 psi, E=1,300,000 psi
 Existing Framing: Fb=1,500 psi, E=1,600,000, Assumed Strength Values for Historic Lumber

 All plywood and oriented strand board (OSB) sheathing shall be engineered grades with APA grade stamp indicating appropriate maximum spacing of supports.

 Floor sheathing: nominal ½*, "APA Sturd-1-loor "24" inch o.c. longue & groove glucd and nailed.

 Roof sheathing: minimum ½*," CDX plywood or 19/32" OSB, APA 40/20, nailed.

 Wall sheathing with 8d commons at 6* o.c. at panel edges, and 12* o.c. intermediate framing U.N.O.

 BLOCK AND NAIL ALL EDGES BETWEEN STUDS. Sheathing shall be continuous from bottom plate to top plate. Cut in "L" and "T" shapes around openings. Lap sheathing over firm joists min. 4" at all floors to tie upper and lower stud walls together. Minimum height of sheathing panels shall be 16" to assure that plates are tied to studs. Use minimum 3*-8d per stud and nail plates are those pails spacing.

 Sole plate at all perimeter walls and at designated shear walls shall be nailed as for braced panels with 346d x 3 1/2" long box nails (coated or deformed shank) per 16*. 12d nails are not acceptable.

STRUCTURAL STEEL: ASTM A36

- Angles, m

- Anchor Bolts: ASTM A307 or A36.
 Standard pipe columns: ASTM A 53, Grade B.
 Connector bolts: ASTM A 307
 Expansion Anchors shall be ICC approved, installed in accordance with manufacturers specifications

- Expansion Anchors shall be ICC approved, installed in accordance with manufacturers specifications. In concrete: Wedge Type
 In solid masonry: Sleeve Type
 Epoxy Sct Anchors shall be ICC approved, installed in accordance with manufacturers specifications.
 In Solid Material: HIT HY 150
 In Hollow Masonry: HIT HY 20 with Screen Tubes
 Non-shrink grout beneath column base and bearn bearing plates shall be non-metallic with minimum compressive strength 5000psi.
 All structural steel shall be fabricated and erected per the current edition of AISC Steel Construction Manual.
 Welding by qualified welders. E70XX electrodes. 3/16" fillet welds, unless noted otherwise.
 Except as noted, framed beam connections shall be detailed to develop 0.6 x Allowable Uniform Load values tabulated in the 9th Edition AISC Manual, Pp. 2-27 and following.
 All beams shall have full depth web stiffeners each side of webs above and below columns. (3" or as noted)
 Attach wood nailer plates to beams with 1/2" diameter machine or carriage bolts at maximum 32" o.c., of 3/8" diameter bolts at 32" with glued contact face, or 5/32" diameter powder actuated drive pins at 24" o.c. U.O.N.

- **TRICTURAL ERECTION AND BRACING REQUIREMENTS**


 The structural drawings illustrate the completed structure with all elements in their final positions, properly supported and braced. The contractor, in the proper sequence, shall provide proper shoring and bracing as may be required to achieve the final completed structure.

 These plans have been engineered for construction at one specific building, site. Builder assumes ALL exposition for the specific building site. Builder assumes ALL exposition for the specific building site. Builder assumes ALL exposition for the specific provides and any other building pair without specific review by therengineer.

 Observations of foundation reinforcing or firming required by the owner, londer, insurer, building department or any otherparty will be accomplished by the engineer at the owner's expense. At least 24 hours advocance notice is requested.


 All slabs on grade shall be separated from adjacent structural and finish elements to allow free movement of the slab, unless specifically shown and noted otherwise.

 The foundation design shown assumes that the owner/builder is aware of the presence of expansive soils, and that he has readile previously referenced only report. Use of these plans is indication that the owner/builder accepts the risks associated withing on this stace, expecially those related to slab on grade construction in finished areas. JVA will not be beld liable for damages caused byslab movement.

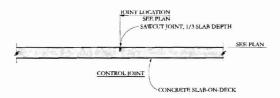

Stru	actural Drawing Index
S-1.0	General Notes, Etc.
S-1.1	Framing Plans
S-1.2	Sections


SCALE:		DRAWN BY: JJT	
DATE:	OCTOBER 24, 2008	REVISED:	

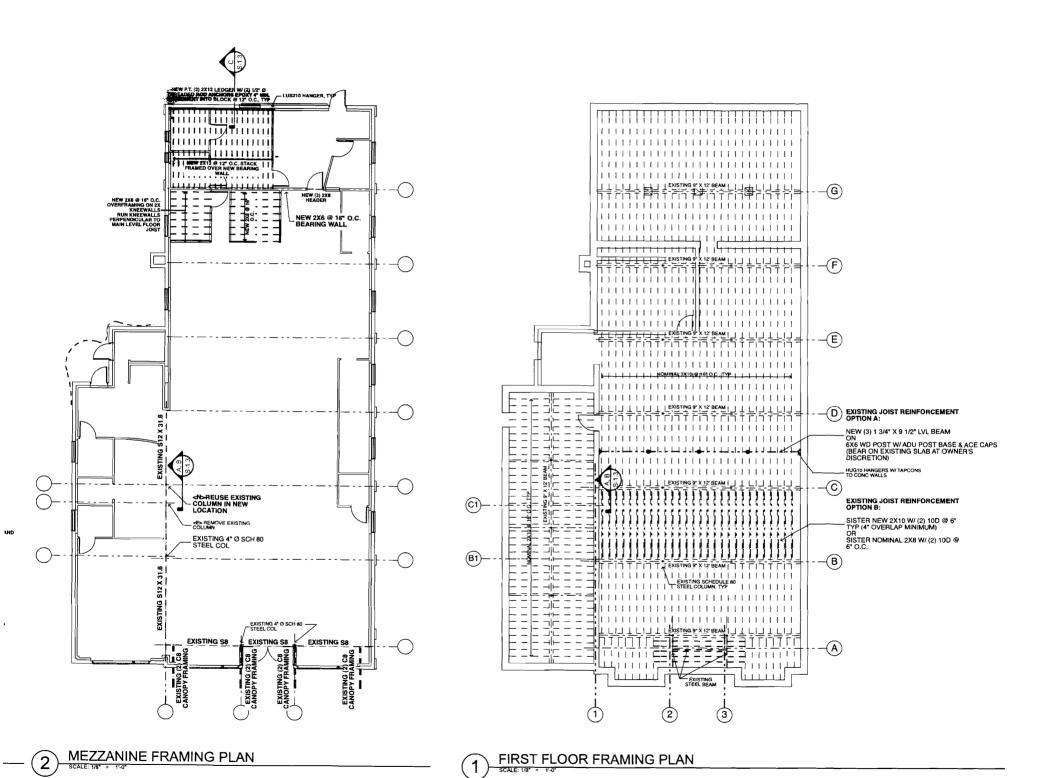


ION DOCUMENTS: 10/24/2008

PROJECT:
GORHAM BIKE & SKI
JAMIE WRIGHT
691 CONGRESS STREET
PORTLAND, ME


SCALE:		DRAWN BY: JJT	_
DATE:	OCTOBER 24, 2008	REVISED:	S-1.2

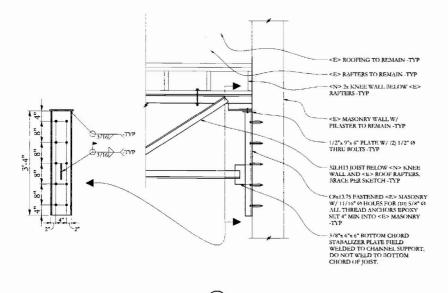


SECTION

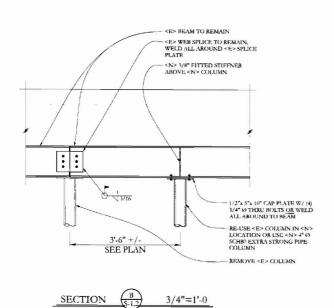

3/4"=1'-0

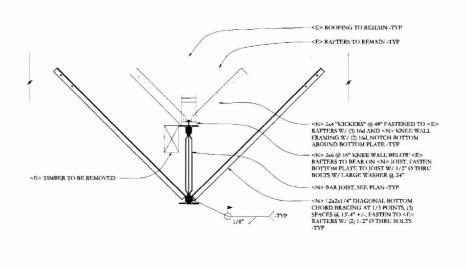

3/4"=1'-0

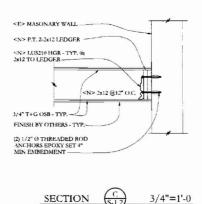

SECTION

PROJECT:
GORHAM BIKE & SKI
JAMIE WRIGHT
691 CONGRESS STREET
PORTLAND, ME

STRUCTURAL GENERAL NOTES

DESIGN LOADS: International Building Code; IBC 2003 Edition, except as noted Occupancy Category, Table 1604.5

					11	Standard		
Roofs:								
Grou	nd Snow,	Pg			50 psf	(used for	drifting ca	lculations)
Flat R	toof Snow.	Pf			35 psf	•	•	
Snow	Exposure Factor	Cc	Table 16	508.3.1	1.0			
	importance Factor.	Is	Table 16	504.5	1.0			
Snow	Thermal Factor.	α	Table 16	508.3.2	1.0			
Floors:								
Office	2				50 psf			
Partiti	ions in Offices				20 psf			
Corric	tors & Public Spaces				100 ps			
	c Arcas				125 ps			
Commo	nercial 1* floor				100 ps			
Lateral					,			
Wind	TBC 1603.1.4, ASCI	7-02			Analyt	ic Method	1	
	3 Second Gust Velo				100 m			
	Importance Factor	•			1.0	,		
	Building Category a	nd Inter	mal Pressu	re Coefficien	t			
	IBC 1609, 2, ASCE 1				Enclos	ecd	GCn	i=0.18
	Exposure	•			В		,	
Seism	ic Use Group				1			
	Importance Factor				1.0			
	Spectral Response				Accele	ration	Cocf	ficient
	Short Period				S.	0.30 g	Sps	0.20 g
	One Second				Si	0.07 g	Spi	0.05 g
	Soils Site Class		-	Table 1615.1.		D	001	
	Design Category			able 1616.3	-	В		
	_ ,					_		

CONCRETE AND REINFORCEMENT:
Concrete shall conform to applicable provisions of ACI-301 and 318.
Minimum 28 day compressive strength (F'c)

nterior Slabs on Deck: 3,000 psi with Fibermesh

Cement Type: All other: I/II

- Deformed reinforcement: ASTM A615 grade 60, except bars specified to be field-bent, stirrups, and ties

- Deformed reinfurcement: ASTM A615 grade 60, except bars specified to be field-bent, stirrups, and ties which shall be grade 40.

 Fibremesh: 100% virgin polypropytene, fibrillated fibers as manufactured by Fibremesh Co. per ASTM C-1116 type 111.4.1.3 and ASTM C-1116 performance level one. 1.5 lb. per cubic yard.

 Welded Wire Fabric (WWF): ASTM A185. See also plan.

 Reinforcement shall be fabricated and placed per ACI Manual of Standard Practice (ACI315). At splices, lap bars 50 diameters unless noted otherwise.

 Minimum 2 #5 around all four sides of all openings, extend min. 2:0 beyond openings.

 Concrete cover over reinforeing: 11/4° for concrete placed against forms; 3° for concrete placed against carth. See also drawings. carth. See also drawings.
 In continuous members, splice top bars at mid span and bottom bars over supports.
 Keep reinforcement clean and free of dirt, oil, scale. Oil forms prior to placing reinforcement.

- WOOD FRAMING:

 * Dimension Lumber is designed and shall be supplied using BASE VALUES Design Criteria.

 * SPF #2 and better (Maximum Moisture Content 19%) U.O.N.
 Plates: Slit plates: Preservative treated Southern Pine.

 * "Pressure treated lumber" shall be framing material of the specified species which has been pressure treated with a decay and insect resistant solution, meeting all current standards for wood in contact with onerere or earth. Sill plates in contact with masomy or concrete foundations, footings or slabs may be treated Timber Strand LSL (zine borate treatment). Acceptable treatment mediums for wood in contact with earth or in exterior applications include ACQ (Alkaline Copper Quaternary) and copper azole. All connectors shall meet the recommendations of the pressure treated wood manufacturer, but shall be not less than Hot Dipped Galvanized or Stainless Steel. All screws, nails and boits shall match hangers and other connectors. Do not mix stainless with galvanized products.

mix stainless with galvanized products.

Do not allow aluminum to contact treated wood.

- mix stainless with galvanized products.

 Do not allow aluminum to contact treated wood.

 Top and Bottom Plates: Horn Fir

 SPF Studs U.O.N: 2 x4 and 2 x6 to 8"-0; atud grade
 2x4 over 8"-0 No. 2 and better
 2x6 over 8"-0 No. 2 and better
 2x6 foor SpF No. 1 or better Fb-875 psi; E-1,400,000

 Rafters: SPF No. 1 or better Fb-875 psi; E-1,400,000

 Rafters: SPF No. 1. Fb-1100 psi; E-1,500,000 psi
 Existing Framing: Fb-1,500 psi; E-1,600,000, Assumed Strength Values for Historic Lumber
 All phywood and oriented strand board (OSB) sheathing shall be engineered grades with APA grade stamp indicating appropriate maximum spacing of supports.

 Floor sheathing: orninal 1/", APA Sturd-1-floor "24" inch o.e. tongue & groove glued and nailed.
 Roof sheathing: minimum 9x8" CDX phywood or 19/32" OSB, APA 40/20, railed.
 Wall sheathing: "1," CDX phywood or "1," OSB, APA 24/16, blocked and nailed.
 Nail wall sheathing with 8d commons at 6" o.e. at panel edges, and 12" o.e. intermediate framing U.N.O.
 BLOCK AND NAIL ALL EDGES BETWEEN STUDS. Sheathing shall be continuous from bottom plate to top plate. Cut in "U" and "P" shapes around openings. Lap sheathing over imposites min -4" at all floors to tie upper and lower stud walls together. Mimmum height of sheathing panels shall be 16" to assure that plates are tied to studs. Use minimum 3-8d per stud and nail plates are tied to studs. Use minimum 3-8d per stud and nail plates are tied to studs. Use minimum 3-8d per stud and nail plates are total ost tide use in shall be contracted and nailed as for braced panels with 3-46d x 3 1/2" long box nails (coated or deformed shank) per 16". 12d nails are not acceptable.

STRUCTURAL STEEL:

•	Angics, misc:	ASIM AJO
	Anchor Bolts:	ASTM A307 or A36.
٠	Standard pipe columns:	ASTM A 53, Grade B.
		4.00m 4.400

Connector bolts: ASTM A307
 Expansion Anchors shall be ICC approved, installed in accordance with manufacturers specifications

In concrete: Wedge Type In solid masonry: Sleeve Type

In solid masconty: Sieve Lype

Epoxy Set Anchors shall be ICC approved, installed in accordance with manufacturers specifications.

In Solid Material: HIT HY 150
In Hollow Masonry: HIT HY 20 with Screen Tubes

Non-shrink grout beneath column base and beam bearing plates shall be non-metallic with minimum compressive strength Solopasi.

All structural steel shall be fabricated and creeted per the current edition of AISC Steel Construction Manual.

Welding by the medical column base and creeted per the current edition of AISC Steel Construction Manual.

All structural steel shall be fabricated and creeted per the current edition of AISC Steel Construction Manual. Welding by qualified welders. EPOXX electrodes 31/16" filler welds, unless noted otherwise. Except as noted, framed beam connections shall be detailed to develop 0.6 x Allowable Uniform Load values tabulated in the 9th Edition AISC Manual, Pp. 2-27 and following.

All beams shall have full depth web stiffeners each side of webs above and below columns. Q" or as noted) Attach wood natier plates to beams with 1/2" diameter machine or earniage bolts at maximum 32" o.e., or 3/8" diameter bolts at 32" with glued contact face, or 5/32" diameter powder actuated drive pins at 24" o.e.,

STRUCTURAL FRECTION AND BRACTING REQUIREMENTS


The structural drawings illustrate the completed structure with all elements in their final positions, properly supported anothraced. The contraction, in the proper response, shall provide proper shoring and baseing as may be required to achieve the final completed structure.

These plans have been engineered fire construction at one specific-building site. Building size substant specific provides as Any Other building size. Plans shall not be used for construction at any other building size whom the specific provide by themsigherer.

Chservations of foundation reinforcing or framing required by the owner, bender, insurer, building department or any otherparry will be accomplished by the engineer at the owner's extremes. At least 24 hours advance notice is requested.

All substant grade shall be separated from adjacent structural and finish elements to allow free movement of the slab, unless specifically shown and mode otherwise.

The foundation design shown assumes that the owner/builder is aware of the presence of expansive soils, and that the behas results previously referenced onlies report. Use of these plans is indication that the owner/builder is acceptable thinks associated with thing on this size, especially those related to slab on grade construction in finished areas. IVA will not be held liable for damages caused byslab movement.

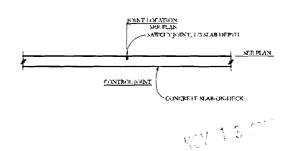


Str	Structural Drawing Index		
S-1.0	General Notes, Etc.		
S-1.1	Framing Plans		
S-1.2	Sections		



PROJECT: GORHAM BIKE & SKI JAMIE WRIGHT

DRAWING: STRUCTURAL GENERAL NOTES SCALE: DRAWN BY: JJT OCTOBER 24, 2008 DATE: REVISED:

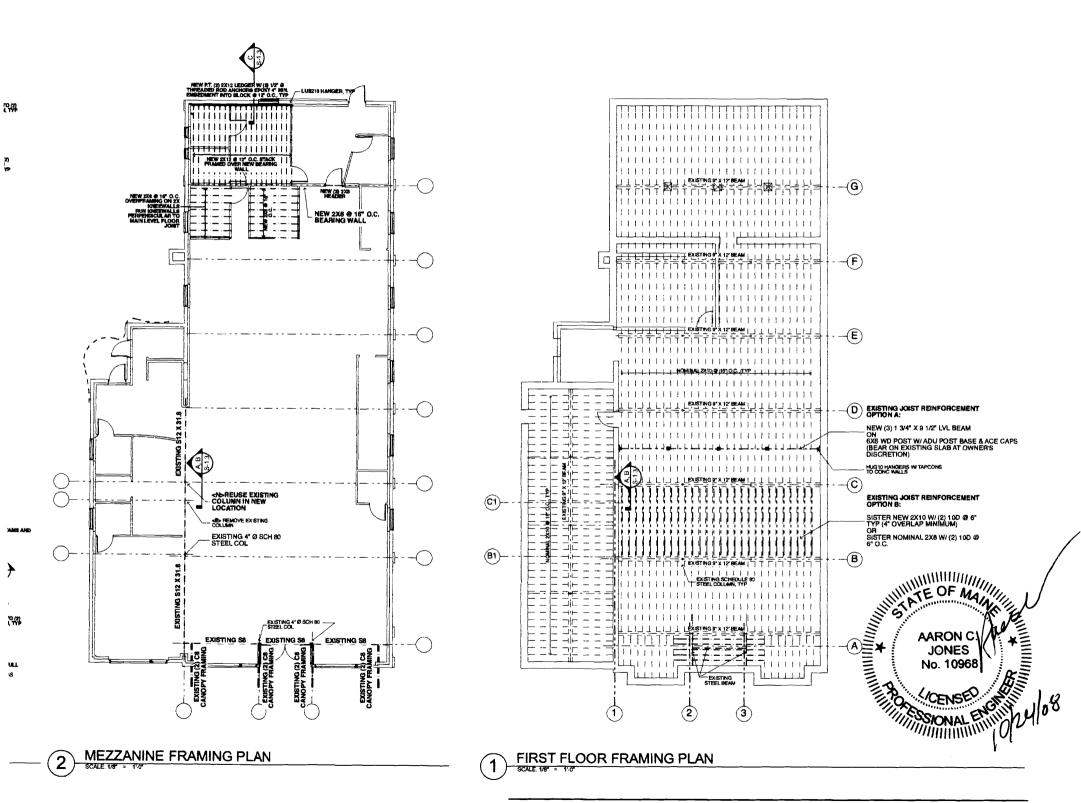

10N DOCUMENTS: 10/24/2008


PROJECT:
GORHAM BIKE & SKI
JAMIE WRIGHT
69 | CONGRESS STREET
PORTLAND, ME

DRAWING: FRAMING PLANS


SCALE: DRAWN SY: JJT

DATE: OCTOBER 24, 2008 REVISED:


S-1.2

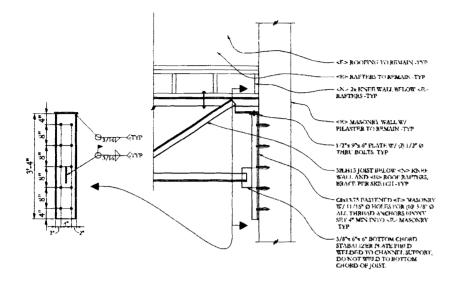


SECTION

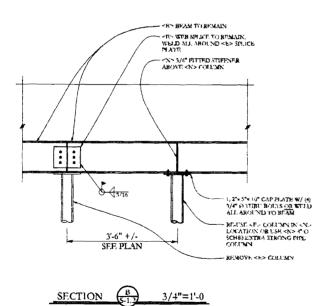

3/4"=1'-0

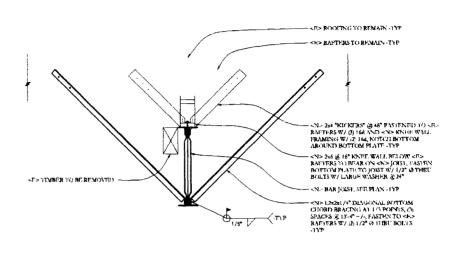

SECTION

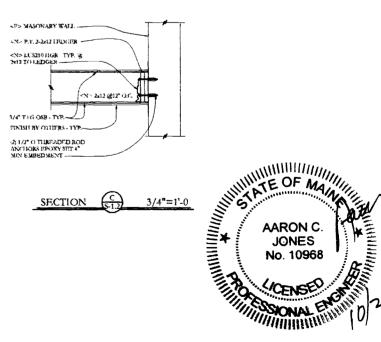

3/4"=1'-0

PROJECT:
GORHAM BIKE & SKI
JAMIE WRIGHT
691 CONGRESS STREET
PORTLAND, ME

DRAWNING: STRUCTURAL DETAILS

SCALE: DRAWN 8Y: JJT

DATE: OCTOBER 24, 2008 REVISED: S-1.3