

Scale: 1/4" = 1'-0"

STRUCTURAL NOTES:

CODE: Comply with the 2015 International Residential Building Code.

DESIGN LOADS: Dead Loads: Roof = 15.0 psf., Floor = 10.0 psf. Live Loads: Roof = 45.0 psf (Plus Drift), 1st Floor = 40.0 psf, 2nd Floor = 35.0 psf. Wind Load: Building = 31.0 psf.

WOOD:


1. General:

- a. Each piece of lumber shall be "S-DRY" and bear the grade stamp of a grading rules agency approved by the American Lumber Standards Committee.
 b. Do not notch or drill joists, beams or load bearing studs without approval.
- 2. Structural Sawn Lumber:
- a. 2 x 6 thru 2 x 14 joists: Spruce Pine Fir No. 2 with Fb (repetitive) = 1200 p.s.i.
 b. Studs: Spruce Pine Fir No. 2 with Fb (repetitive) = 1200 p.s.i.
 4. Laminated Veneer Lumber (LVL); Beams: Fb = 2,800 psi, Fv = 285 psi, E = 2,000 ksi Posts: Fb = 2,400 psi, Fv = 190 psi, E = 1,800 ksi

SUPPLEMENTARY NOTES:

- 1. Verify all dimensions and conditions in field prior to starting work. Notify the Engineer of any
- discrepancies or inconsistencies.Provide all necessary temporary bracing, shoring, guying or other means to avoid excessive stresses and to hold structural elements in place during construction.

 \Box

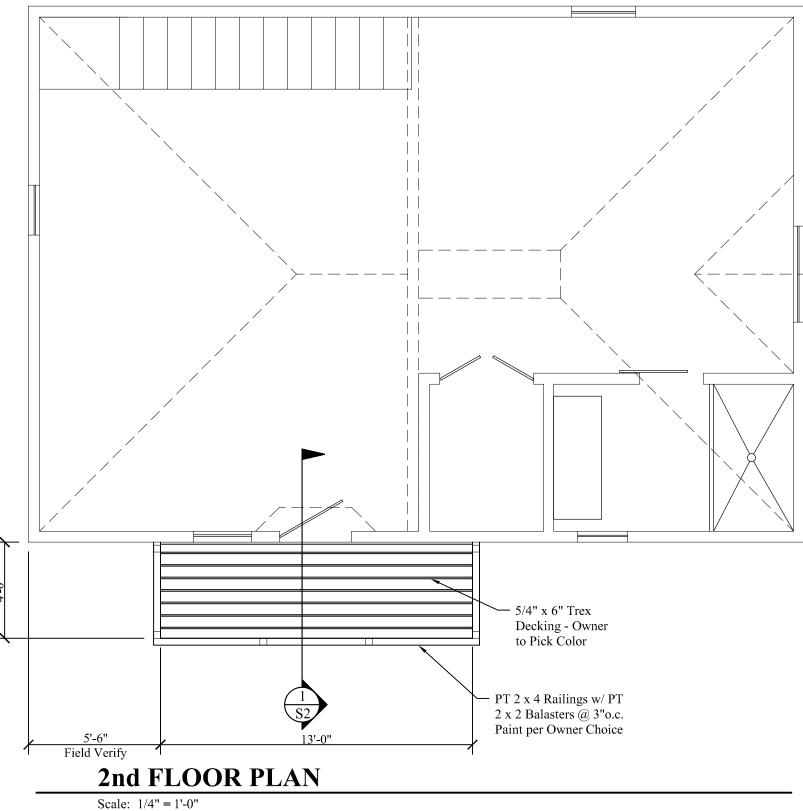

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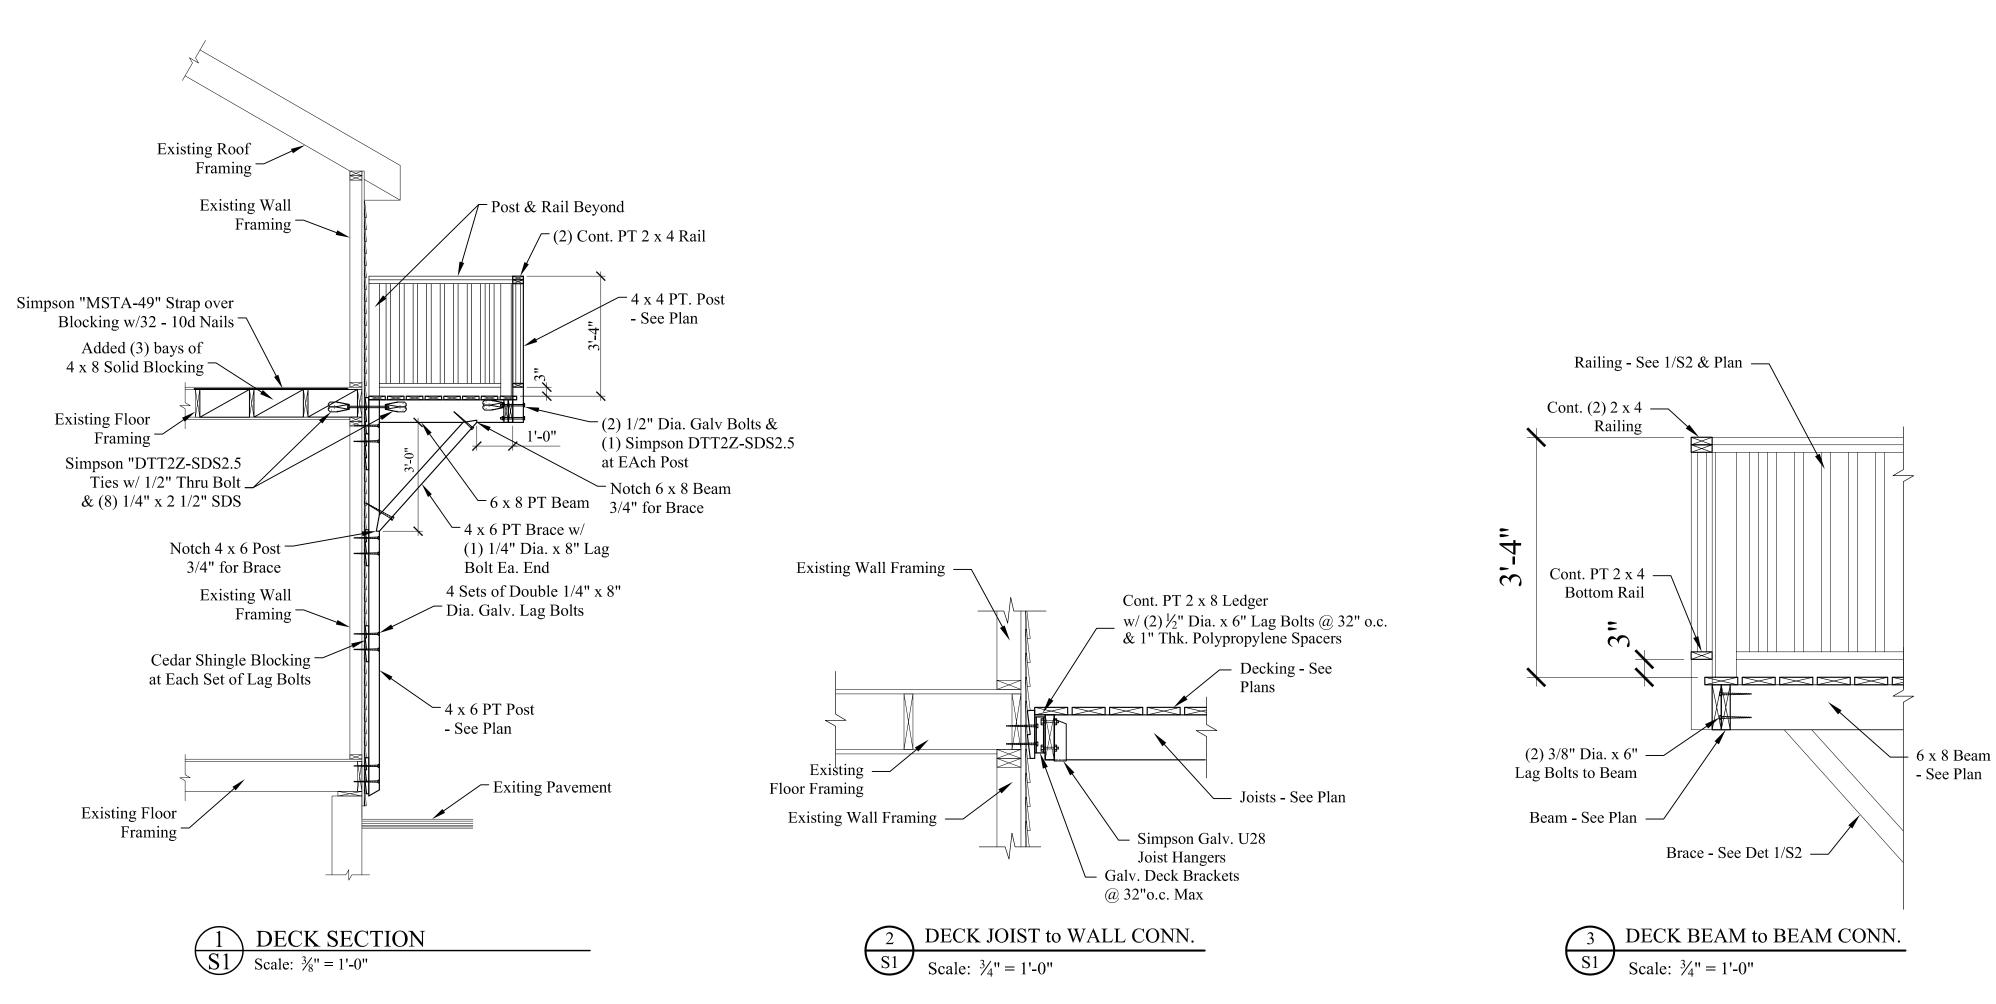
ENGINEERING DESIGN PROFESSIONALS	P.O. BOX 575, FREEPORT, MAINE 04032 • (207) 865–9505	
Carage House Exterior Deck 11 Mellen Street, Portland, Maine	NOTES & PLANS	
DESIGNED BY: Larry A. V DRAWN BY: JOB #: DATE:	DF MA RY A. RY A. RY A. RY A. ROSKI S990 NAL NAL Vichroski, P.E. LAW 03918 7-24-2018 S1 of 2	

0	2'	4'		8'
	SCAL	.E: 1/4"	= 1'-0"	


Mechanical, Electrical and Plumbing Design and Building Weatherization-Insulation-Ventilation by Others.



LEFT SIDE ELEVATIONS Scale: 1/4'' = 1'-0''



 \sim PT 4 x 6 Posts

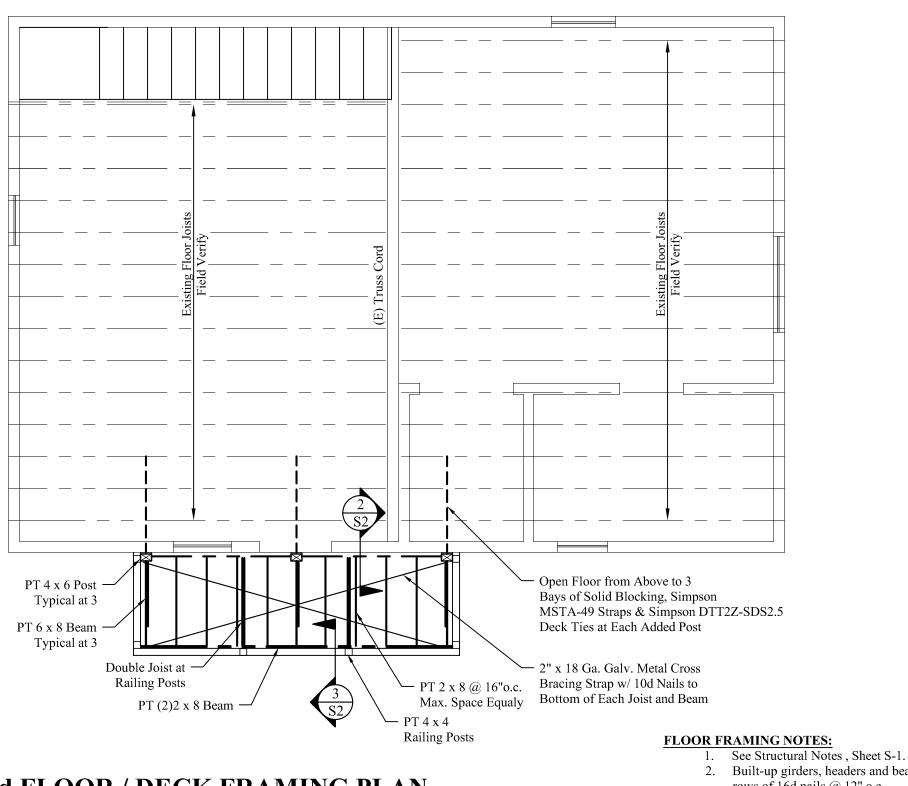

2nd FLOOR / DECK FRAMING PLAN

Scale: 1/4'' = 1'-0''



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DESIGN PROFE nsulting Engineers 'ORT, MAINE 04032 • (

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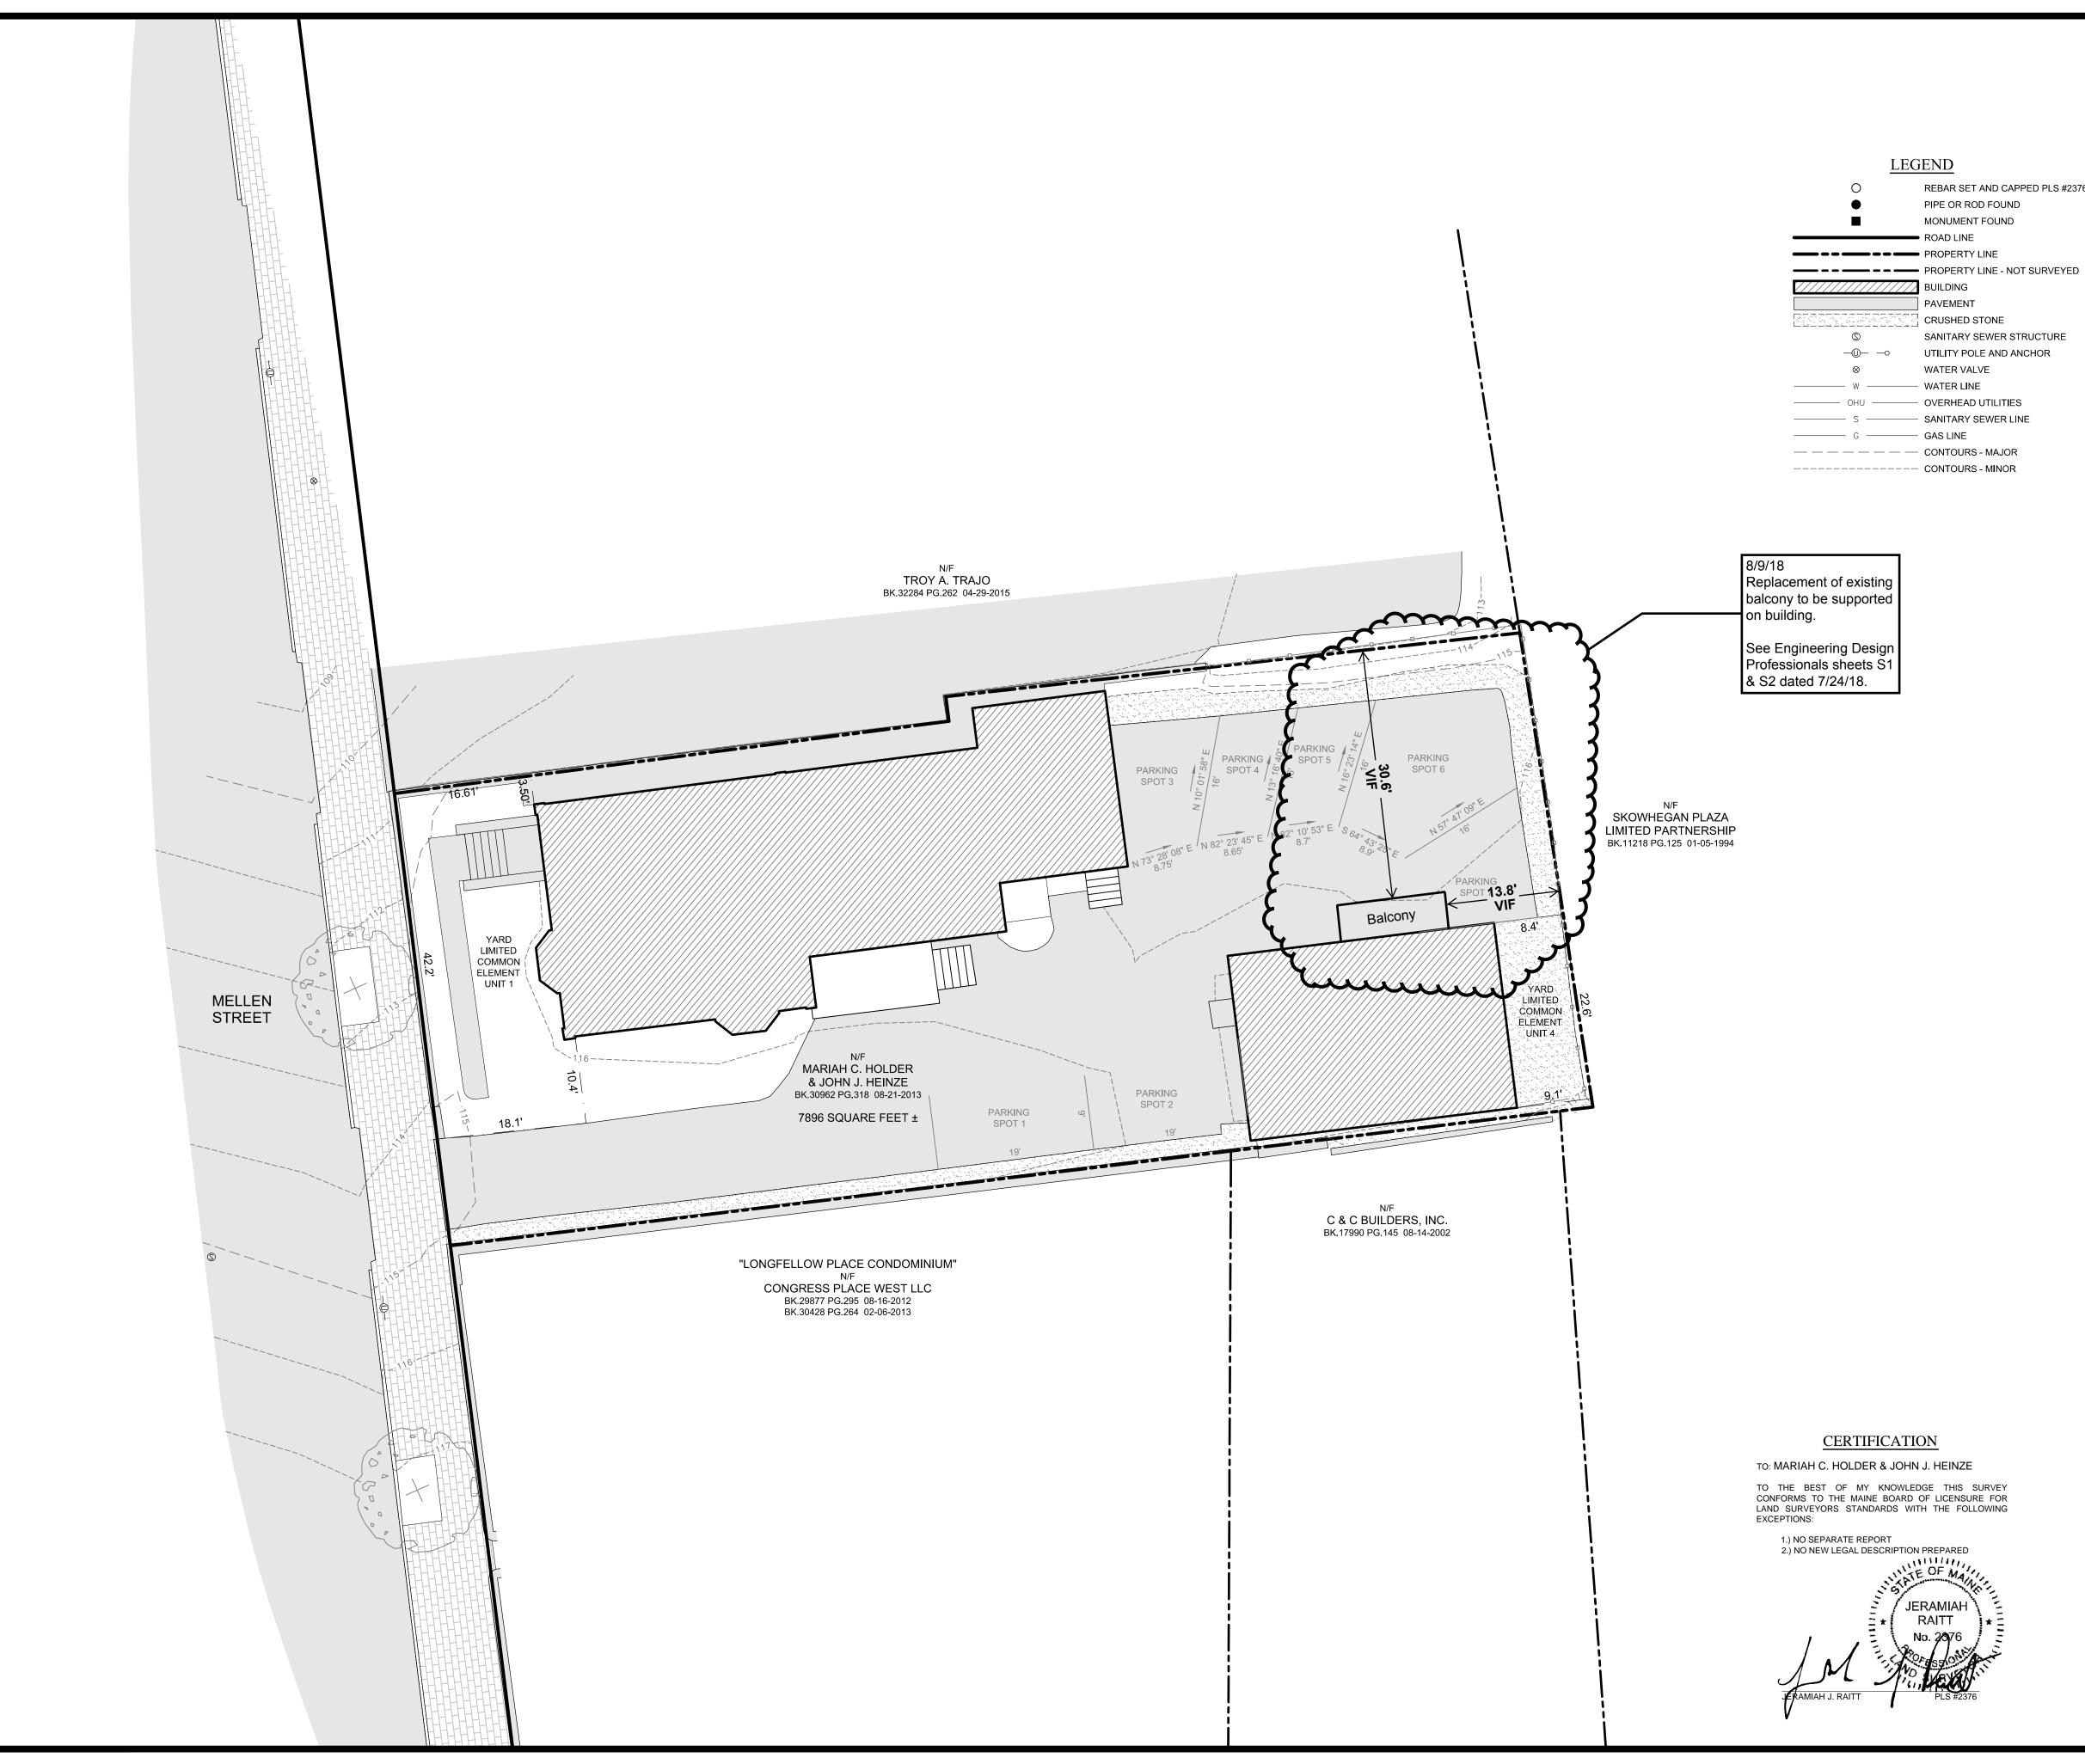
- Built-up girders, headers and beams shall be spiked w/ 3 rows of 16d nails @ 12" o.c.
 Provide metal hangers at all flush joist connections.
 Field verify all existing conditions and dimensions.

2'	4'			8'	
SCAL	.E: 1/4"	= 1'-0)"		
1.51		F			

ENGINEERING ŝ BOX . O Ω_ \frown DETAILS Deck Ś **PLAN** Xterior **UC** Ē AMII Carage House] 11 Mellen Street,] FR • ELEVATION \bigcirc IN ATE OF MA LARRY A. WICHROSKI /No. 5990-DESIGNED BY Larry A. Wichroski, P.I DRAWN BY: LAW **DB** #: 03918 ATE: 07-24-2018 REVISIONS **S**2

of 2

Mechanical, Electrical and Plumbing Design and Building Weatherization-Insulation-Ventilation by Others.





REBAR SET AND CAPPED PLS #2376

SANITARY SEWER STRUCTURE

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SOURCE SPCS 1983 - ME WEST

NOTES

1) OWNERS OF RECORD: MARIAH C. HOLDER & JOHN J. HEINZE, REFERENCE DEED BOOK 30962, PAGE 318 DATED AUGUST 21, 2013. (BOOK AND PAGE REFERENCES ARE TO THE CUMBERLAND COUNTY REGISTRY OF DEEDS.) FOR MORE BOUNDARY DETAIL SEE A PLAN ENTITLED "STANDARD BOUNDARY SURVEY FOR RECORD OWNER MARIAH C. HOLDER & JOHN J. HEINZE" DATED AUGUST 16, 2016 BY THIS SURVEYOR.

2) BEARINGS ARE REFERENCED TO THE STATE PLANE COORDINATE SYSTEM OF 1983, MAINE WEST ZONE, AS DERIVED FROM RTK OBSERVATIONS PERFORMED WITH A LEICA GS14 GNSS RECEIVER AND THE STATE OF MAINE DEPARTMENT OF TRANSPORTATION VRS NETWORK.

3) ELEVATIONS ARE REFERENCED TO THE CITY OF PORTLAND VERTICAL DATUM DERIVED FROM NGVD 1929. THIS SURVEY IS TIED TO THE FOLLOWING BENCH MARK AS PROVIDED BY THE DEPARTMENT OF PUBLIC SERVICES ENGINEERING DIVISION ARCHIVIST: A BOLT FOUND IN THE GRANITE MONUMENT ON THE THREE OFFSET AT NORTHEASTERLY CORNER OF DEERING STREET AND MELLEN STREET WITH AN ELEVATION OF 95.11 FEET.

4) THE SUBJECT PARCEL IS SHOWN IN ZONE C, AREAS OF MINIMAL FLOODING (NO SHADING), AS DEPICTED ON THE FLOOD INSURANCE RATE MAP FOR THE CITY OF PORTLAND, MAINE WITH COMMUNITY-PANEL NUMBER 230051 0013 B AND AN EFFECTIVE DATE OF JULY 17, 1986.

5) THE SUBJECT PARCEL IS SHOWN ON THE NATURAL RESOURCES CONSERVATION SERVICE NATIONAL COOPERATIVE SOIL SURVEY AS BEING COMPRISED OF HINCKLEY LOAMY SAND, 3 TO 8 PERCENT SLOPES.

6) THE SUBJECT PARCEL IS SHOWN IN THE B-2B COMMUNITY BUSINESS ZONE ON THE CITY OF PORTLAND ZONING MAP AVAILABLE ONLINE WITH THE FOLLOWING DIMENSIONAL REQUIREMENTS FOR RESIDENTIAL USES TAKEN FROM CITY CODE, SECTION 14-185: PER ORDINANCE

MINIMUM LOT SIZE: MINIMUM STREET FRONTAGE: 20 FEET MINIMUM FRONT YARD SETBACK: NONE MAXIMUM LOT COVERAGE: MAXIMUM HEIGHT: MINIMUM AREA PER UNIT:

NONE MINIMUM SIDE YARD SETBACK: NONE, WITH ALTERNATE PROVISIONS MINIMUM REAR YARD SETBACK: 10 FEET, WITH ALTERNATE PROVISIONS NONE 45 FEET, WITH LIMITATIONS 435 SQUARE FEET

SCALE IN FEET

SITE PLAN WITH TOPOGRAPHIC DETAIL OF 11 MELLEN STREET CONDOMINIUMS

FOR MARIAH C. HOLDER & JOHN J. HEINZE PO BOX 4038, PORTLAND, MAINE 04101 OWNER

SITE LOCATION 9-11 MELLEN STREET PORTLAND, MAINE

LITTLE RIVER
LAND SURVEYING
JERAMIAH J. RAITT
ME PLS #2376 NH LLS #957
PO BOX 332, LISBON FALLS MAINE 04252

(207) 841-0056

DATE: AUGUST 16, 2016 REVISED: JUNE 21, 2017

> SCALE: 1" = 10'

PROJECT #16-014 DRAWING #16-014

DRAWN BY: JJR

