FIRE ALARM SYMBOL LEGEND NOTE: ALL SYMBOLS MAY NOT BE USED ON THIS PROJECT SYMBOL DESCRIPTION FACP FIRE ALARM CONTROL PANEL ② SMOKE DETECTOR HEAT DETECTOR SERIAL INTERFACE MODULE MANUAL PULL STATION MINI HORN

HORN / STROBE

ABBREVIATION	DESCRIPTION	SDEANER SSK1 _STRABE WK1
E	EXISTING	SPEAKER STROBE S
G	WITH GUARD	(211) 70
Р	PENDANT MOUNT	
R	RESIDENTIAL (110V)	② ✓ DEVICE ADDRESS → 【↓)
S	SOUNDER BASE	L1D001 OR D01
WP	WEATHER PROOF	(L - DENOTES LOOP #) (D or M - DENOTES DETECTOR OR MODULE #)
EOL	END OF LINE RESISTOR	(",
EOLR	END OF LINE RELAY	
AWG	AMERICAN WIRE GAUGE	
TWP	TWISTED PAIR	<u> </u>
TWSP	TWISTED SHIELDED PAIR	WIRE TYPE ABBREVIATED CONDUCTOR COUNT
FPLP	FIRE POWER LIMITED PLENUM	WIRE SIZE
FPLR	FIRE POWER LIMITED RISER	# OF CABLES (IF OMITTEI ONLY 1 CABLE NEEDED)
NAC	NOTIFICATION APPLIANCE CIRCUIT	ONLI I CABLE NEEDED)
SLC	SIGNALING LINE CIRCUIT	

TO UPPER (CLASS B) LEVEL 1-10 TO UPPER LEVEL LEVEL LEVEL	FROM BASEMENT LEVEL 1-4 #14/2 AWG
ENTRY ENTRY FRONT HALL/ STAIRS 1-5 1-8	7 15 P ENTRY
WIT I LIVING ROOM	#16/2 AWG (CLASS B) FROM
1-7 UNIT I BEDROOM 2	FROM BASEMENT LEVEL
DINING DECK	
MAIN LEVEL FIRE ALARM PLAN SCALE: 1/8"=1'-0" Output SCALE: 1/8"=1'-0" MAIN LEVEL FIRE ALARM PLAN	

-#16/2 AWG (CLASS B)

REAR HALL / STAIRS

KITCHEN

UNIT 2

LIVING

ROOM

DINING

FROM FACP-1

L#14/2 AWG

BASEMENT LEVEL

FIRE ALARM PLAN

TO MAIN


UNIT3

TO MAIN

LEVEL

└#14/2 AWG

HALL/STAIRS

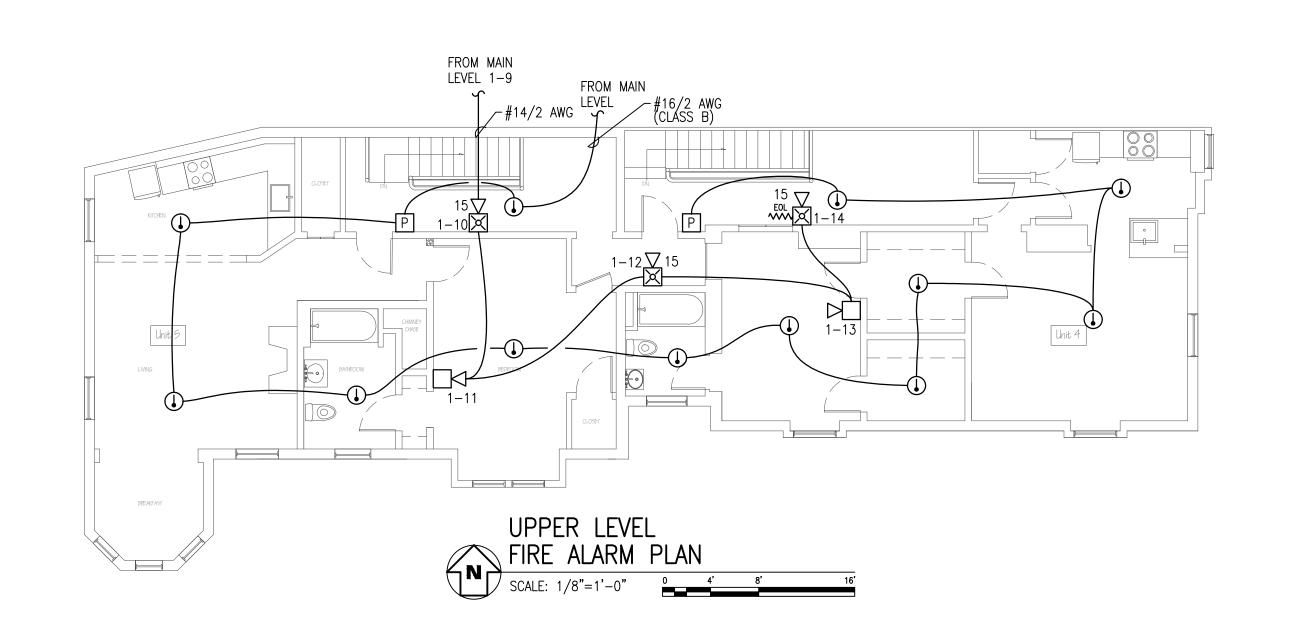

OPERATIONS MATRIX FIRE ALARM INPUT	FIRE ALARM OUTPUT	ACTIVATE ALARM INDICATOR	ACTIVATE AUDIBLE ALARM	ACTIVATE SUPERVISORY INDICATOR	ACTIVATE AUDIBLE SUPERVISORY SIGNAL	ACTIVATE TROUBLE INDICATOR	ACTIVATE AUDIBLE TROUBLE INDICATOR	TRANSMIT ALARM SIGNAL	TRANSMIT SUPERVISORY SIGNAL	TRANSMIT TROUBLE SIGNAL	ACTIVATE NOTIFICATION APPLIANCES
SMOKE DETECTORS		•	•					•			•
PULL STATIONS		•	•					•			•
HEAT DETECTORS		•	•					•			
FIRE ALARM AC POWER FAIL						•	•			•	
FIRE ALARM LOW BATTERY						•	•			•	
OPEN CIRCUIT						•	•			•	
GROUND FAULT						•	•			•	
NAC SHORT CIRCUIT						•	•			•	
LOSS OF AC TO BUILDING							•			•	

GENERAL NOTES:

MOUNTING

WALL-TOP @ 66"

CEILING

CEILING

FIELD VERIFY

WALL @ 48"

WALL @ 10'-0

WALL 80"-96"

- 1. SCOPE OF WORK: THIS PROJECT SHALL INCLUDE THE INSTALLATION OF A NEW FIRE ALARM CONTROL PANEL WITH OCCUPANT NOTIFICATION AND AREA HEAT DETECTION.
- 2. THESE DRAWINGS ARE DIAGRAMMATIC. REFER TO THE ARCHITECTURAL DRAWINGS FOR EXACT DIMENSIONS.
- 3. INSTALLATION SHALL COMPLY WITH NEC, NFPA 72 AND ALL OTHER APPLICABLE CODES AS REQUIRED BY THE LOCAL AUTHORITY HAVING JURISDICTION.
- 4. WIRING DEPICTED ON THESE PLANS IS SCHEMATIC ACTUAL WIRE LOCATIONS MAY DIFFER FROM THESE PLANS. WIRING SHALL BE PERFORMED AS ACTUAL BUILDING CONSTRUCTION CONDITIONS ALLOW AND TO MINIMIZE PENETRATIONS THROUGH AREA SEPARATION WALLS AND FIRE WALLS. THE USE OF A RACEWAY IS PERMITTED AS LONG AS NO 110V OR HIGHER VOLTAGE CABLES ARE IN THE SAME RACEWAY.
- 5. FIRE RATINGS SHALL BE MAINTAINED FOR ALL PENETRATIONS THROUGH FIRE-RATED CONSTRUCTION.
- POWER FOR ALL FIRE ALARM PANELS AND FIRE ALARM POWER SUPPLIES MUST BE PROVIDED BY A DEDICATED AC BRANCH CIRCUIT. THE LOCATION OF THE BRANCH CIRCUIT BREAKER SHALL BE PERMANENTLY IDENTIFIED AT THE CONTROL UNIT AND SHALL HAVE A RED MARKING IN ACCORDANCE WITH NFPA 72.
- 7. POWER-LIMITED AND NONPOWER-LIMITED CIRCUIT WIRING MUST REMAIN SEPARATED IN CABINET. ALL POWER-LIMITED CIRCUIT WIRING MUST REMAIN AT LEAST 0.25" AWAY FROM ANY NONPOWER-LIMITED CIRCUIT WIRING. FURTHERMORE. ALL POWER-LIMITED AND NONPOWER-LIMITED CIRCUIT WIRING MUST ENTER AND EXIT THE CABINET THROUGH DIFFERENT KNOCK OUTS AND/OR SEPARATE CONDUITS.
- . WHEN UTILIZING CLASS "A" CIRCUITS, SEPARATE OUTGOING AND RETURN CONDUCTORS OF CLASS "A" CIRCUITS BY A MINIMUM OF 12" WHERE RUN VERTICALLY AND 48" WHERE RUN HORIZONTALLY.
- 9. WHEN UTILIZING SHIELDED CABLE TIE SHIELDS THROUGH AND INSULATE AT EACH JUNCTION BOX. INSULATE AND TAPE BACK AT END.
- 10. ALL FIRE ALARM CABLING SHALL BE ACCEPTABLE TO THE FIRE ALARM EQUIPMENT MANUFACTURER FOR THE INTENDED PURPOSE.
- 11. SMOKE DETECTORS SHALL NOT BE INSTALLED UNTIL AFTER CONSTRUCTION CLEAN-UP IS COMPLETED AND FINAL.
- 12. LOCATE SMOKE DETECTORS A MINIMUM OF THREE (3) FEET FROM MECHANICAL DIFFUSERS. WALL-MOUNTED SMOKE DETECTORS SHÀLL BE LOCATED A MINIMUM OF 4" AND A MAXIMUM OF 12" FROM CEILING. CEILING-MOUNTED SMOKE DETECTORS SHALL BE MOUNTED ON CEILINGS AND NOT ON THE BOTTOMS OF BEAMS OR JOISTS.
- 13. PROVIDE SYNCHRONIZATION OF ALL VISUAL NOTIFICATION APPLIANCE CIRCUITS. PROVIDE ALL REQUIRED SYNC MODULES. PROVIDE A MULTI-SYNC MODE SLAVE CONNECTION BETWEEN ALL SYNC MODULES.
- 14. VERIFY ALL FIELD SELECTABLE AUDIBILITY SETTINGS OF NOTIFICATION APPLIANCES WITH FIRE ALARM CONTRACTOR.
- 15. UPON COMPLETION OF THE FIRE ALARM SYSTEM INSTALLATION AND PROGRAMMING. THE INSTALLING CONTRACTOR SHALL PERFORM FINAL TESTING OF THE ENTIRE SYSTEM, PER ALL APPLICABLE CODES, AND SHALL COORDINATE AND PERFORM A FINAL FIRE ALARM SYSTEM INSPECTION.
- 16. PROVIDE OFF-SITE MONITORING AS REQUIRED BY THE INTERNATIONAL FIRE CODE, SECTION 907.6.5 AND THE LOCAL AUTHORITY HAVING JURISDICTION.
- 17. INSTALLING CONTRACTOR SHALL, PHYSICALLY, LABEL ALL INITIATING DEVICES AND NOTIFICATION APPLIANCE CIRCUIT END OF LINE (WHEN WIRING CLASS "B"). THESE LABELS SHALL BE IN PLACE PRIOR TO START-UP AND TESTING.

APPLICABLE CODES:

MAINE UNIFORM ENERGY & BUILDING CODE PORTLAND CITY CODE, CHAPTER10, FIRE PREVENTION & PROTECTION NFPA 1, FIRE CODE, & NFPA 101, LIFE SAFETY CODE

> CWS UNICAD JOB #17248 DRAWN WAYNE B. HAWS CHECKED NICET IV 90496 4/12/2017 DATE REVISION

SCALE

FA-1

1/8"=1'-0"

(1)

> S **DEERING** ERING AND POR 39 39