
767 Congress Street

Life Safety Improvements

SCALE: 1" = 20'-0"

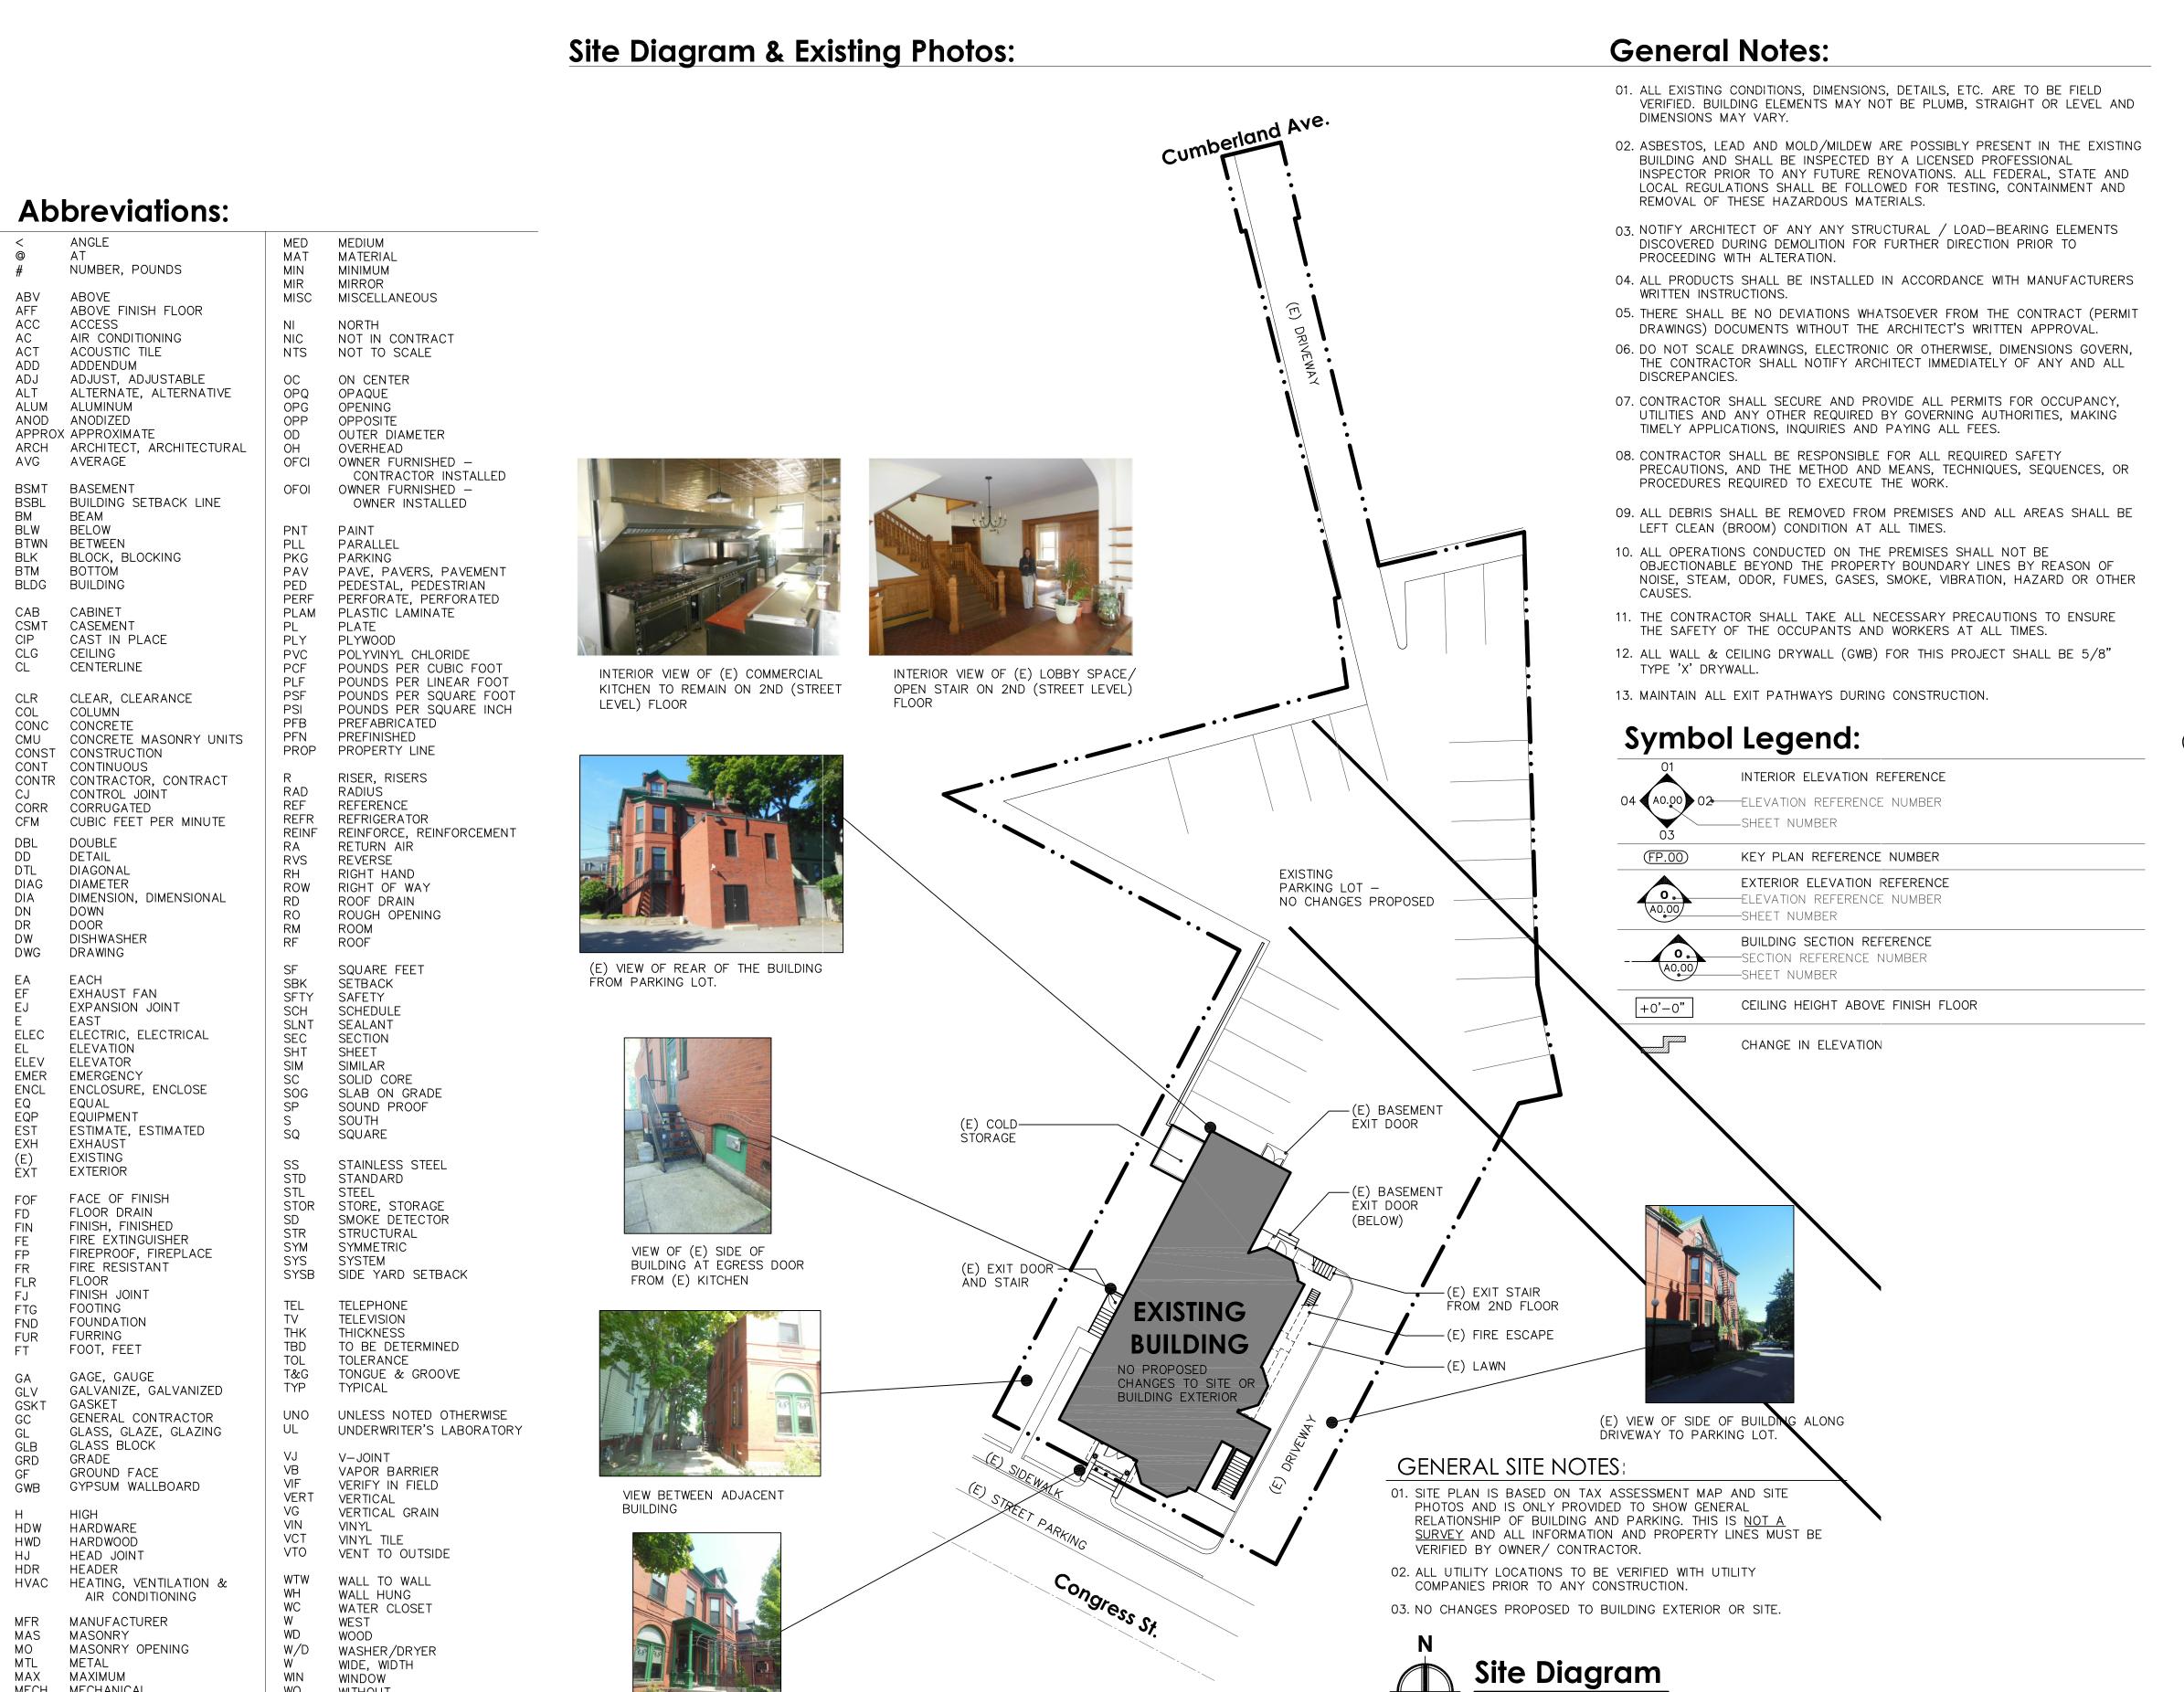

MAXIMUM

MECHANICAL

WIN

WINDOW

WITHOUT

WALK-IN CLOSET WATERPROOF

> VIEW OF (E) BUILDING ENTRY FROM CONGRESS STREET

Project Contacts:

2A architects, LLC P.O. BOX 189 ROCKPORT, ME 04856 PROJECT ARCHITECT: AMANDA ROBERSON AUSTIN, R.A. (207) 236.6545 WWW.2AARCH.COM CLIENT/OWNER: QUIMBY COLONY INC PO BOX 445 PORTLAND, ME 04112 CONTACT: LUCAS ST. CLAIR

Project Data:

767 CONGRESS STREET PORTLAND, ME 04112 YEAR BUILT: 1900 (PER ASSESSOR SUMMARY) 047 A017001 (PER ASSESSOR SUMMARY) LOT SIZE: .3923 ACRES (PER ASSESSOR SUMMARY) ZONE: B2-B BUILDING GROSS 1ST FLOOR (RESTAURANT): ±2,487 SF AREAS: 2ND (STREET LEVEL) FLOOR ±2,416 SF 3RD FLOOR (OFFICES): ±1,984 SF 4TH FLOOR (RESIDENCE): ±1,882 SF TOTAL GROSS AREA ±8,769 SF

Project Description:

MODIFICATIONS TO 2ND FLOOR (STREET LEVEL) AND DOORS AT STAIR ENCLOSURE TO PROVIDE EGRESS ENCLOSURE TO EXTERIOR FROM UPPER FLOORS. FIRE-RATED DOORS ON UPPER FLOORS TO INCREASE EGRESS

FUTURE TENANT IMPROVEMENT AT SECOND FLOOR ASSEMBLY OTHERS. NO MODIFICATIONS PROPOSED TO SITE OR BUILDING EXTERIOR. NO EXTERIOR WORK IS ANTICIPATED AS PART OF THIS PROJECT. IF EXTERIOR WORK IS FOUND TO BE NECESSARY, NOTIFY THE CITY OF PORTLAND FOR APPROVAL

Applicable Codes:

ZONING CODE: CITY OF PORTLAND LAND USE ORDINANCE BUILDING CODE: NFPA 101 2009 MUBEC 2009 W/ MAINE AMENDMENTS ENERGY CODE: IECC 2009 W/ MAINE AMENDMENTS FIRE CODE: NFPA 1 (FIRE PREVENTION CODE) PLUMBING CODE: MAINE UNIFORM PLUMBING CODE 2009 NATIONAL ELECTRICAL CODE 2008 ELECTRICAL CODE:

NOTE:
BIDDER DESIGN SYSTEMS SHALL MEET ALL APPLICABLE LOCAL, STATE & FEDERAL CODES RELATED TO THEIR SCOPE OF WORK (EVEN IF NOT SPECIFICALLY MENTIONED ABOVE).

Permitting / Deferred Submittals:

BUILDING & ADA PERMIT REVIEW: BUILDING PERMIT REVIEW AND APPROVAL WILL BE PER CITY OF PORTLAND AND STATE FIRE MARSHAL.

SPRINKLER & FIRE ALARM SYSTEM:

BIDDER DESIGN, DEFERRED SUBMITTAL. THE BUILDING HAS NFPA 13 FIRE PROTECTION SYSTEM AND FIRE ALARM SYSTEM. BIDDER DESIGNER SHALL SUBMIT TO REQUIRED PERMITTING AGENCIES FOR APPROVAL FOR ANY MODIFICATIONS TO SUPPORT PROPOSED CHANGES.

ELECTRICAL SYSTEMS: BIDDER DESIGN, DEFERRED SUBMITTAL.

MECHANICAL (HEATING & VENTILATION) SYSTEMS: BIDDER DESIGN, DEFERRED SUBMITTAL.

BIDDER DESIGN, DEFERRED SUBMITTAL

ASBESTOS / LEAD REMOVAL:

THE CONTRACTOR SHALL ENSURE THAT THIS PROJECT AND ALL CONSTRUCTION ACTIVITIES RELATED THERETO CONFORM WILL ALL LOCAL, REGIONAL, STATE, AND/OR FEDERAL REGULATIONS PERTAINING TO DISTURBING, DISPLACING, ENCAPSULATING, AND/OR REMOVAL OF ASBESTOS, ASBESTOS CONTAINING MATERIALS (ACM), OR LEAD PAINTED MATERIALS.

heet Index:	
CHITECTURAL:	

		_	_	_	_	1
HITECTURAL	L:	RE	REV	REV	REV	
1.0	SITE DIAGRAM, PROJECT DATA & NOTES					Ī
B3.0	AS-BUILT FLOOR PLAN - FIRST & SECOND FLOORS					ſ
B3.1	AS-BUILT FLOOR PLAN - THIRD & FOURTH FLOORS					Ī
3.0	2ND (STREET LEVEL) FLOOR PLAN					Ī
.3.1	3RD FLOOR PLAN & DOOR SCHEDULE					Ī
3.2	4TH FLOOR PLAN					Ī
7.0	DETAILS, CEILING PLAN, INTERIOR ELEVATIONS					ſ



architects, Ilc 724 Rockland Street (Office) P.O. Box 189 (Mailing) Rockport, Maine 04856 Tel: 207.236.6545 Web: www.2Aarch.com ©Copyright 2010, 2A architects I Registration: S Consultant:

> Sheet Issue Date: 11/3/14 Pre-App. Meeting 12/15/14 Client Record 3/13/15 Prelim. Pricing 6/8/15 Permit Submittal Permit Resubmittal - Rev 1

August 2014 Project Number: 14-119

Project Start Date:

- 0 N 4 D

COVER

& NOTES

08/04/2015 A1.0_767Congress_Cover.dw

Sheet Number: