

STREE<sup>-S</sup>

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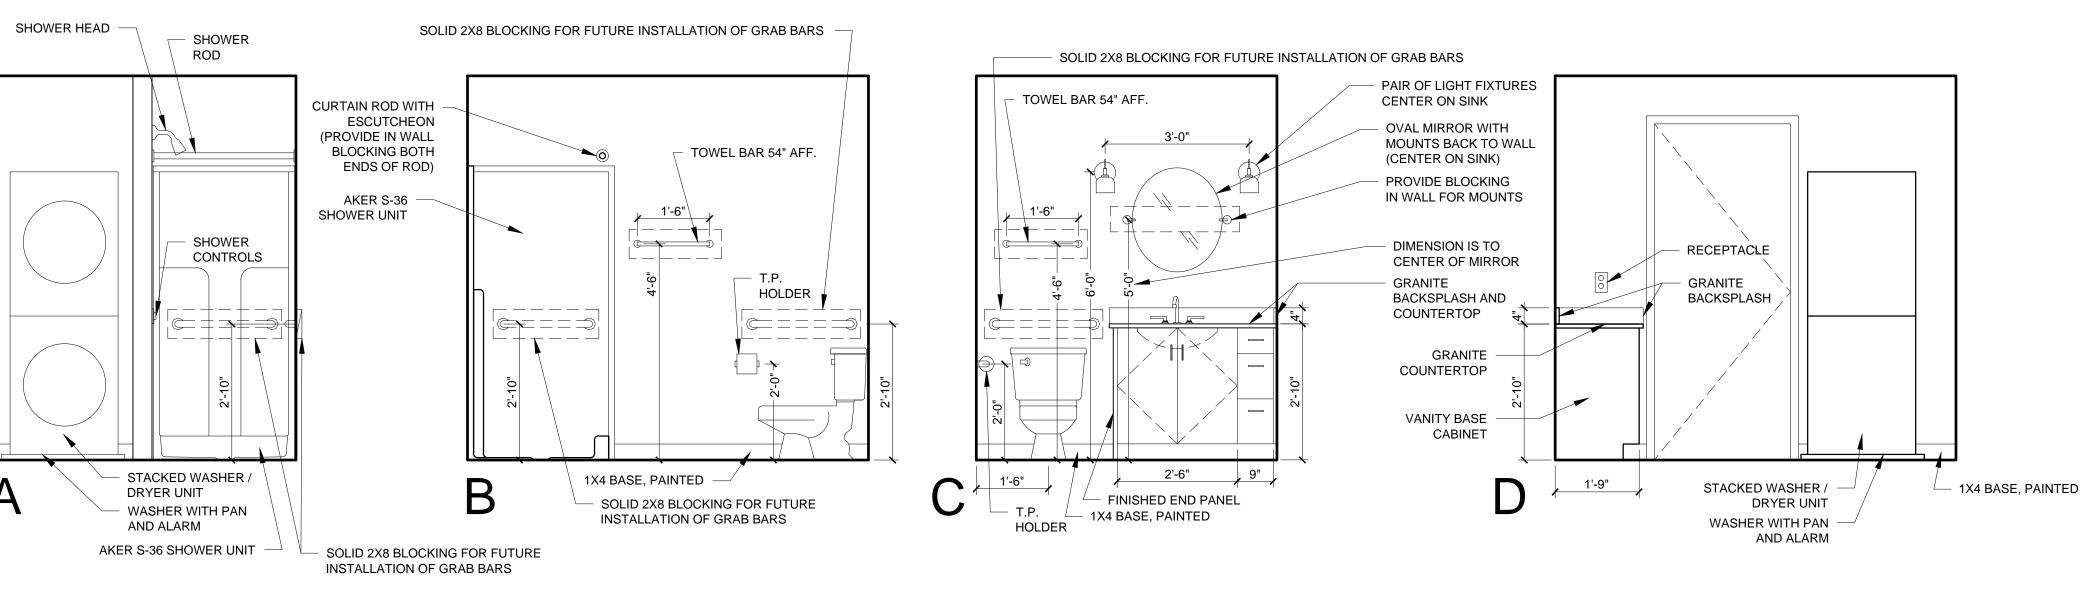
STRUCTURAL: Structural Integrity 77 Oak Street Portland, ME 04101 207-774-4614

1\ REVISION #1 - 05/17/16 DATE: FEBRURAY 15, 201

**REVISIONS:** 

PROJECT No. DRAWN BY: RJS / RR CHECKED BY: SCALE: AS NOTED SHEET TITLE:

UNIT 717-817 PLANS AND INTERIOR ELEVATIONS



 $4'-6\frac{1}{2}"$ 

DIMENSION

8'-3<u>1</u>"

FLOORING -

DIRECTION

COAT HOOKS

CLOSET

SHELF

AND ROD

A4-3

MIRRORED

HALF WALL - ALIGN -

KITCHEN (TYPE 1)

/ INFILL WALL FROM

1 UNIT 717-817 FLOOR PLAN
1/2" = 1'-0"

COLUMN TO

DEMISING WALL


FINISHED END

PANEL ON CABINET

WITH EDGE OF

FULL WALL

UNIT 717-817 INTERIOR ELEVATIONS
1/2" = 1'-0"

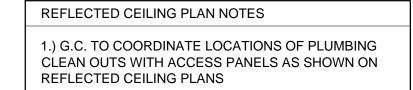

- 2.) G.C. TO PROVIDE ACCESS PANELS AS REQUIRED FOR ALL ELEMENTS (SPRINKLER, VALVES, ETC) NOT SHOWN ON THIS REFLECTED CEILING PLAN)
- 3.) G.C. TO PROVIDE METAL FRAMING AND BLOCKING REQUIRED FOR ALL ACCESS PANELS AND CONTROL JOINTS
- 4.) ALL ACCESS PANELS TO BE FIRE RATED TO MATCH THE CEILING THEY ARE INSTALLED WITHIN

## UNIT NOTES

- .) CEILING HEIGHTS, WINDOW HEAD AND SILL HEIGHTS VARY FROM FLOOR TO FLOOR, INTERIOR ELEVATIONS GRAPHICALLY DEPICT ONE FLOOR ONLY, FOR HEIGHT INFORMATION REFER TO BUILDING SECTIONS AND WALL SECTIONS 2.) G.C. TO CONFRIM AND COORDINATE ALL ROUGH FRAMING
- DIMENSIONS FOR TUBS, SHOWERS, BUILT-IN FIXTURES ETC. G.C. TO CONFRIM AND COORDINATE ALL CABINETRY AND APPLIANCES DIMENSIONS
- 3.) PROVIDE APPROPRIATE FIRE TREATED BLOCKING IN WALLS BEHIND ALL FIXTURES, PARTITIONS AND ACCESSORIES. BLOCKING FOR GRAB BARS TO BE PROVIDED IN WALLS OF BATHROOMS IN ALL UNITS
- 4.) PROVIDE MOISTURE RESISTANT GWB AT ALL WALLS AND CEILINGS IN BATHROOMS TYPICAL 5.) SET ALL CLOTHES WASHERS IN PANS WITH WATER SENSOR
- 6.) REFER TO ELECTRICAL AND MECHANICAL DRAWINGS FOR ADDITIONAL INFORMATION REGARDING, LIGHTING, DIFFUSERS, 7.) PROVIDE FIRE EXTINGUISHER ON BRACKET IN BASE CABINET
- BELOW KITCHEN SINK TYPICAL 8.) HANG HOT WATER HEATER FROM DECK ABOVE. (SEE DETAIL ON TYPICAL UNIT DETAILS SHEET) .) WHERE DROPPED SOFFITS AND CEILINGS ARE SHOWN, THESE
- ARE IN ADDITION TO THE FIRE RATED GWB CEILING ABOVE WHICH IS PART OF THE RATED ASSEMBLY 0.) WHERE PLUMBING VALVES (TUB, SHOWER, ETC) ARE LOCATED IN FIRE RATED WALLS, PROVIDE FIRE RATED BOX IN

## CABINETRY AND APPLIANCE ABBREVIATIONS

WALL FOR VALVE TO BE INSTALLED WITHIN

- DB = DRAWER BASE DRB = DOOR BASE
- SB = SINK BASE
- WC = WALL CABINET WC(24) = WALL CABINET 24" DEEP PU = PANTRY UNIT 24" DEEP
- OS = OPEN SHELVES RA = RANGE
- DW = DISHWASHER REF = REFRIGERATOR

## REFLECTED CEILING PLAN AND LIGHTING LEGEND SYMBOL TAG DESCRIPTION

	Α	SURFACE MOUNT - TBD
	В	SURFACE MOUNTED - TBD
0	С	SURFACE MOUNT - IN CLOSETS
	D	SURFACE MOUNTED ON WALL ABOVE DOOR
	Е	WALL SCONCE IN BATHROOM OVER VANITY
$\circ$	F	SURFACE MOUNT - WET LOCATION
$\overline{}$		

H SURFACE MOUNT CENTER IN BEDROOMS SURFACE MOUNT - WET LOCATION K EXTERIOR CUT OFF DOWN LIGHT

CEILING GRILLE

16"X16" FIRE RATED ACCESS PANEL BELOW DUCT HEATER ERV \_ \_ \_ \_ \_ \_ \_ \_ \_ \_ \_ \_ **EQUAL** − 24"X24" FIRE RATED ACCESS PANEL BELOW ERV CENTER PAIR OF FIXTURES OVER SINK CENTER ON -BED ROOM - CENTER ON CEILING AT 8'-0" AFF TYPICAL WITHIN UNIT CENTER ON SINK 1'-10" | β'-6<sup>3</sup>/<sub>4</sub>" SOFFIT AT 7'-6" AFF DUCT DROP WITHIN SOFFIT BELOW EXTERIOR PERIMETER BEAM

UNIT 717-817 REFLECTED CEILING PLAN

1/2" = 1'-0"

