REFLECTED CEILING PLAN NOTES

1.) G.C. TO COORDINATE LOCATIONS OF PLUMBING CLEAN OUTS WITH ACCESS PANELS AS SHOWN ON REFLECTED CEILING PLANS

2.) G.C. TO PROVIDE ACCESS PANELS AS REQUIRED FOR ALL ELEMENTS (SPRINKLER, VALVES, ETC) NOT SHOWN ON THIS REFLECTED CEILING PLAN)

3.) G.C. TO PROVIDE METAL FRAMING AND BLOCKING REQUIRED FOR ALL ACCESS PANELS AND CONTROL JOINTS

4.) ALL ACCESS PANELS TO BE FIRE RATED TO MATCH THE CEILING THEY ARE INSTALLED WITHIN

UNIT NOTES

.) CEILING HEIGHTS, WINDOW HEAD AND SILL HEIGHTS VARY FROM FLOOR TO FLOOR, INTERIOR ELEVATIONS GRAPHICALLY

DEPICT ONE FLOOR ONLY, FOR HEIGHT INFORMATION REFER TO BUILDING SECTIONS AND WALL SECTIONS 2.) G.C. TO CONFRIM AND COORDINATE ALL ROUGH FRAMING DIMENSIONS FOR TUBS, SHOWERS, BUILT-IN FIXTURES ETC.

G.C. TO CONFRIM AND COORDINATE ALL CABINETRY AND

APPLIANCES DIMENSIONS 3.) PROVIDE APPROPRIATE FIRE TREATED BLOCKING IN WALLS BEHIND ALL FIXTURES, PARTITIONS AND ACCESSORIES. BLOCKING FOR GRAB BARS TO BE PROVIDED IN WALLS OF BATHROOMS IN ALL UNITS

4.) PROVIDE MOISTURE RESISTANT GWB AT ALL WALLS AND CEILINGS IN BATHROOMS TYPICAL 5.) SET ALL CLOTHES WASHERS IN PANS WITH WATER SENSOR 6.) REFER TO ELECTRICAL AND MECHANICAL DRAWINGS FOR ADDITIONAL INFORMATION REGARDING, LIGHTING, DIFFUSERS,

7.) PROVIDE FIRE EXTINGUISHER ON BRACKET IN BASE CABINET BELOW KITCHEN SINK - TYPICAL 8.) HANG HOT WATER HEATER FROM DECK ABOVE. (SEE DETAIL ON TYPICAL UNIT DETAILS SHEET)

9.) WHERE DROPPED SOFFITS AND CEILINGS ARE SHOWN, THESE ARE IN ADDITION TO THE FIRE RATED GWB CEILING ABOVE WHICH IS PART OF THE RATED ASSEMBLY

0.) WHERE PLUMBING VALVES (TUB, SHOWER, ETC) ARE LOCATED IN FIRE RATED WALLS, PROVIDE FIRE RATED BOX IN WALL FOR VALVE TO BE INSTALLED WITHIN

## CABINETRY AND APPLIANCE ABBREVIATIONS

DB = DRAWER BASE DRB = DOOR BASE

SB = SINK BASE WC = WALL CABINET

WC(24) = WALL CABINET 24" DEEP PU = PANTRY UNIT 24" DEEP OS = OPEN SHELVES

RA = RANGEDW = DISHWASHER REF = REFRIGERATOR

REFLECTED CEILING PLAN AND LIGHTING LEGEND

A SURFACE MOUNT - TBD SURFACE MOUNTED - TBD SURFACE MOUNT - IN CLOSETS SURFACE MOUNTED ON WALL ABOVE DOOR

K EXTERIOR CUT OFF DOWN LIGHT


WALL SCONCE IN BATHROOM OVER VANITY SURFACE MOUNT - WET LOCATION SURFACE MOUNT CENTER IN BEDROOMS SURFACE MOUNT - WET LOCATION


CEILING GRILLE


SOLID 2X8 BLOCKING FOR FUTURE INSTALLATION OF GRAB BARS ———— PAIR OF LIGHT FIXTURES -TOWEL BAR 54" AFF. CENTER ON SINK OVAL MIRROR WITH -MOUNTS BACK TO WALL (CENTER ON SINK) PROVIDE BLOCKING IN WALL FOR MOUNTS WALL HOOKS -PROVIDE BLOCKING DIMENSION IS TO CENTER OF MIRROR GRANITE -BACKSPLASH AND COUNTERTOP 1'-3" 2'-6" FINISHED END PANEL — T.P. — HOLDER


UNIT 212-812 INTERIOR ELEVATIONS


1/2" = 1'-0"

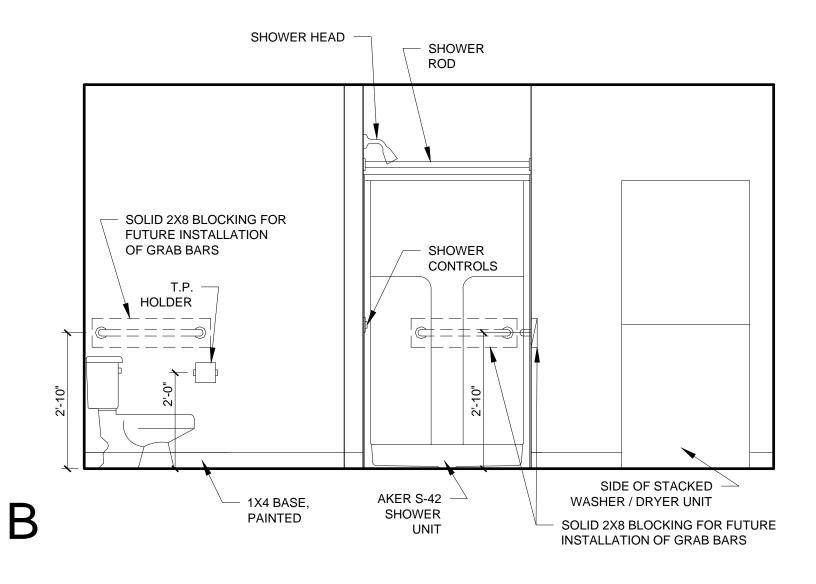


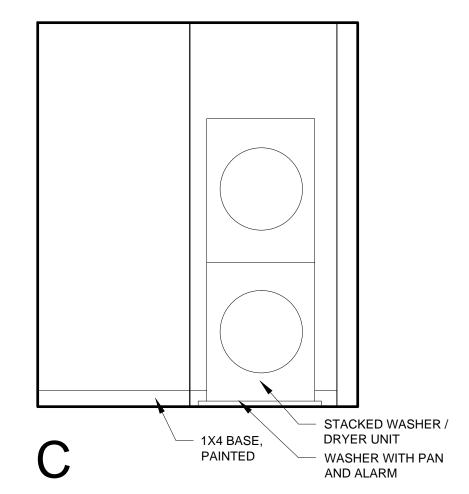

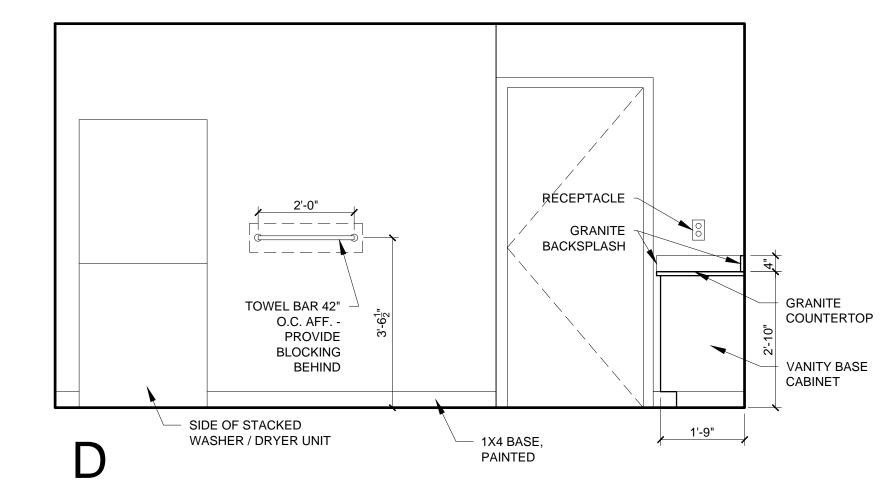

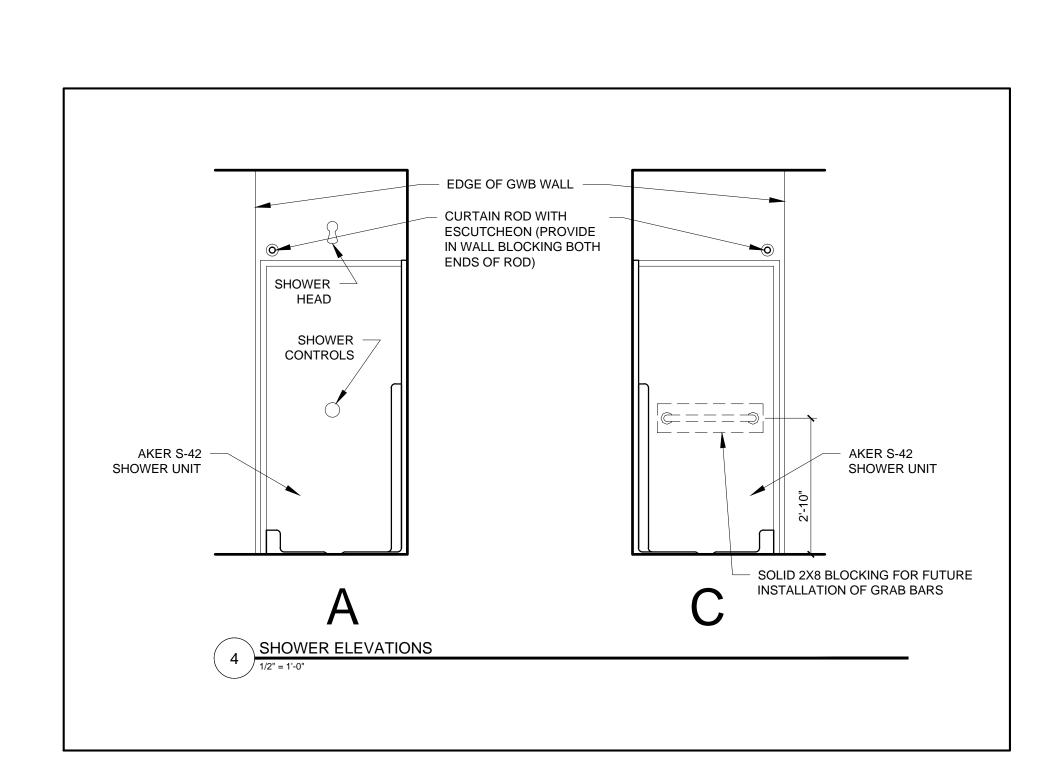

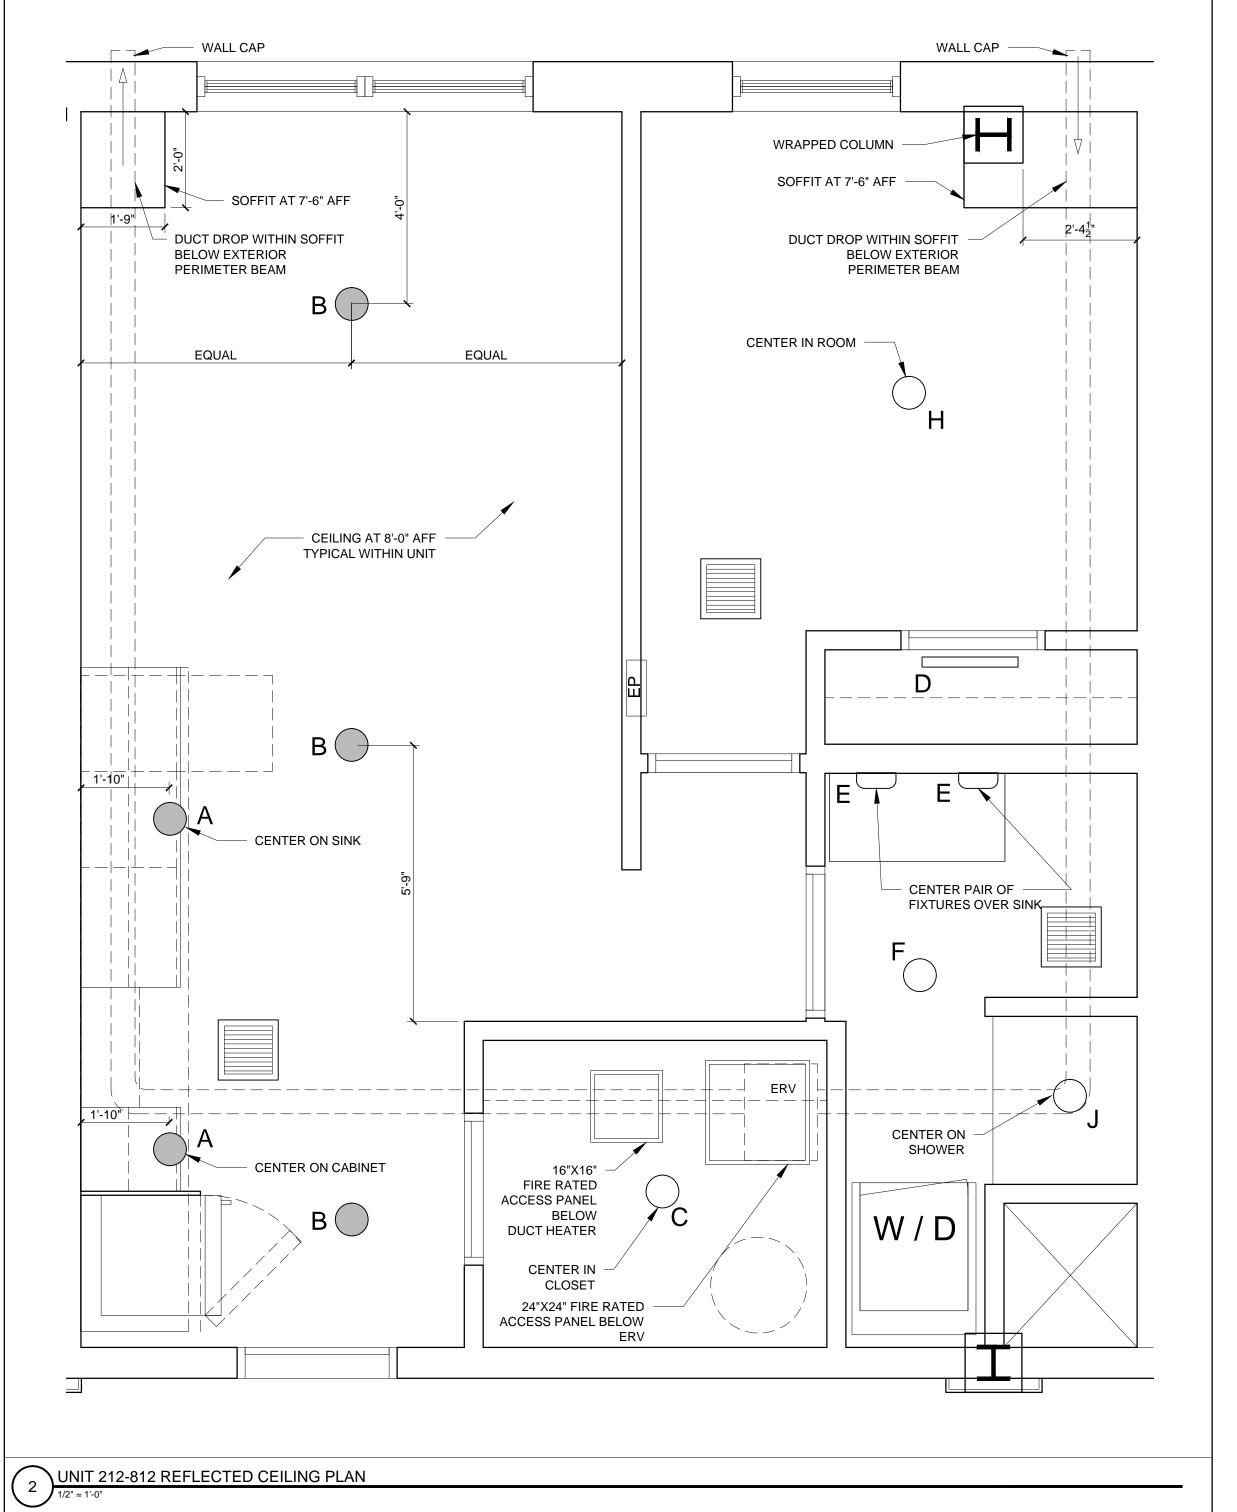

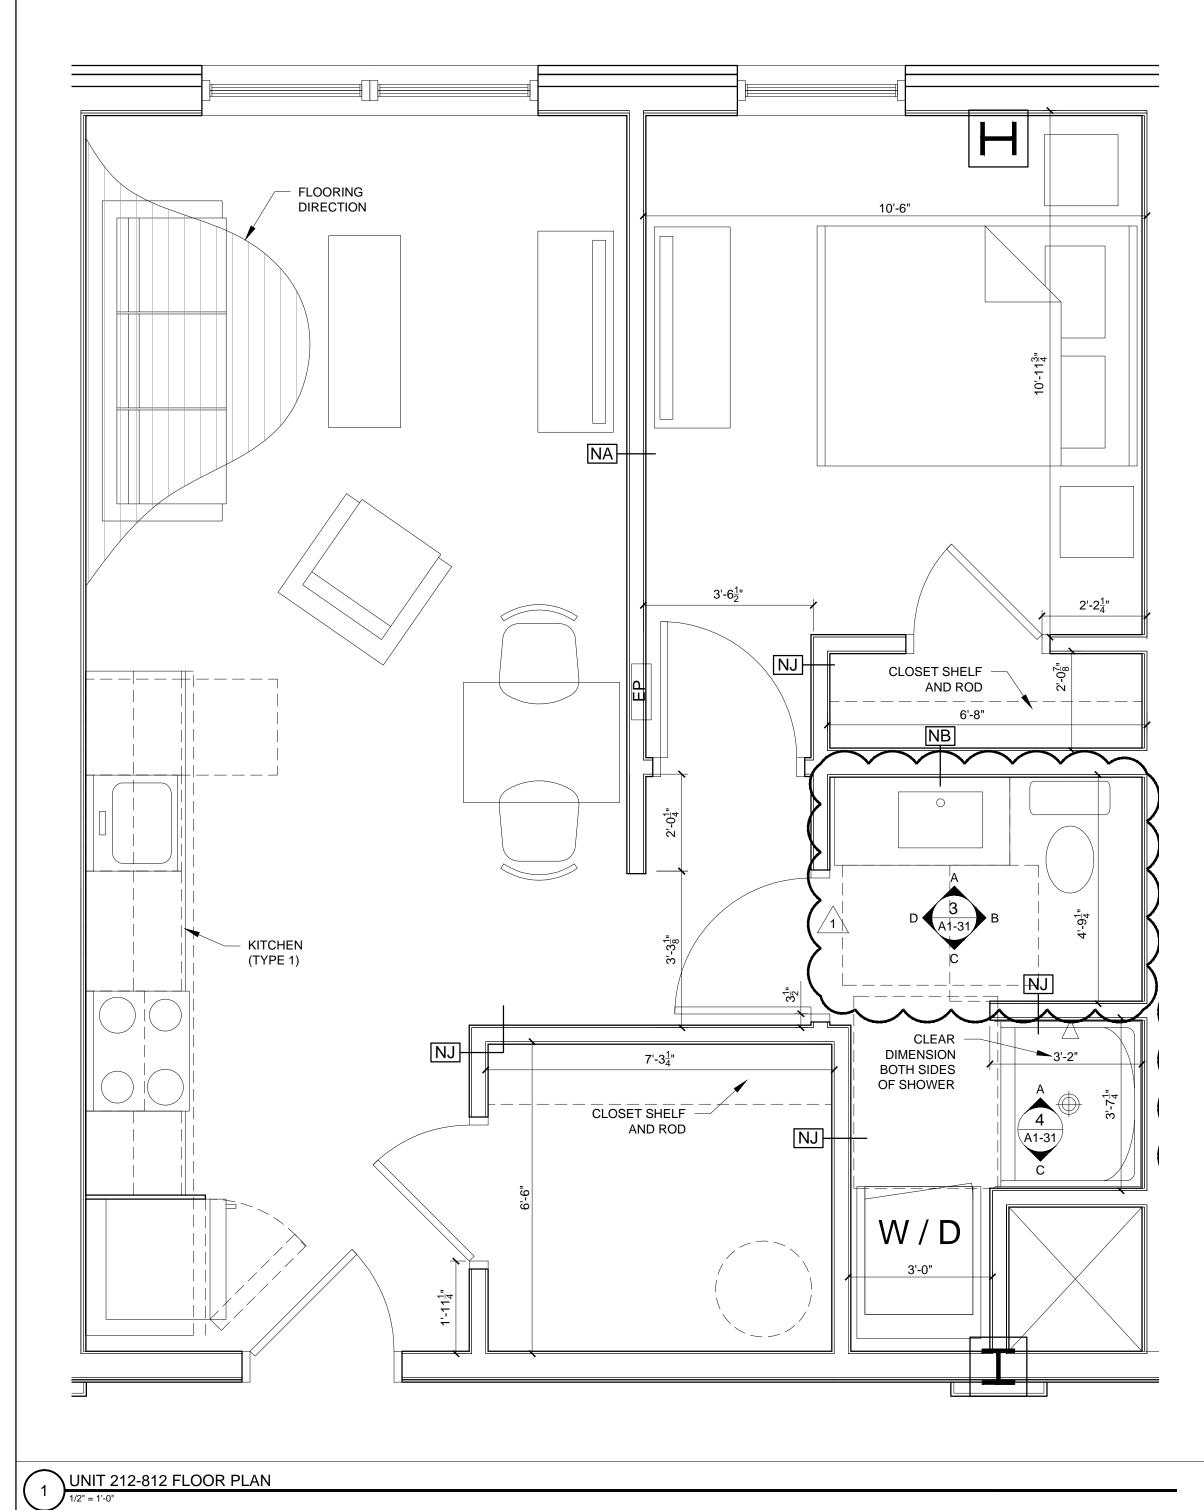



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STRUCTURAL: Structural Integrity 77 Oak Street Portland, ME 04101 207-774-4614

**REVISIONS:** 1 REVISION #1 - 05/17/16

DATE: FEBRURAY 15, 20° PROJECT No. DRAWN BY: RJS / RR CHECKED BY:

AS NOTED SCALE: SHEET TITLE: UNIT 212-812 PLANS AND INTERIOR ELEVATIONS

A1-31