FINISHED END PANEL — 1X4 BASE, PAINTED —

T.P. HOLDER

VANITY BASE CABINET

1'-9"

1X4 BASE, PAINTED

STACKED WASHER /

WASHER WITH PAN – AND ALARM

DRYER UNIT

SOLID 2X8 BLOCKING FOR FUTURE —

INSTALLATION OF GRAB BARS

STACKED WASHER / —

WASHER WITH PAN —

- AKER S-36 SHOWER UNIT

1X4 BASE, PAINTED

DRYER UNIT

AND ALARM

UNIT 211-811 INTERIOR ELEVATIONS

1/2" = 1'-0"

REFLECTED CEILING PLAN NOTES

1.) G.C. TO COORDINATE LOCATIONS OF PLUMBING CLEAN OUTS WITH ACCESS PANELS AS SHOWN ON REFLECTED CEILING PLANS

2.) G.C. TO PROVIDE ACCESS PANELS AS REQUIRED FOR ALL ELEMENTS (SPRINKLER, VALVES, ETC) NOT SHOWN ON THIS REFLECTED CEILING PLAN)

3.) G.C. TO PROVIDE METAL FRAMING AND BLOCKING REQUIRED FOR ALL ACCESS PANELS AND CONTROL JOINTS

4.) ALL ACCESS PANELS TO BE FIRE RATED TO

UNIT NOTES

.) CEILING HEIGHTS, WINDOW HEAD AND SILL HEIGHTS VARY FROM FLOOR TO FLOOR, INTERIOR ELEVATIONS GRAPHICALLY DEPICT ONE FLOOR ONLY, FOR HEIGHT INFORMATION REFER TO BUILDING SECTIONS AND WALL SECTIONS 2.) G.C. TO CONFRIM AND COORDINATE ALL ROUGH FRAMING DIMENSIONS FOR TUBS, SHOWERS, BUILT-IN FIXTURES ETC. G.C. TO CONFRIM AND COORDINATE ALL CABINETRY AND APPLIANCES DIMENSIONS

3.) PROVIDE APPROPRIATE FIRE TREATED BLOCKING IN WALLS BEHIND ALL FIXTURES, PARTITIONS AND ACCESSORIES. BLOCKING FOR GRAB BARS TO BE PROVIDED IN WALLS OF BATHROOMS IN ALL UNITS

4.) PROVIDE MOISTURE RESISTANT GWB AT ALL WALLS AND CEILINGS IN BATHROOMS TYPICAL 5.) SET ALL CLOTHES WASHERS IN PANS WITH WATER SENSOR 6.) REFER TO ELECTRICAL AND MECHANICAL DRAWINGS FOR

ADDITIONAL INFORMATION REGARDING, LIGHTING, DIFFUSERS, 7.) PROVIDE FIRE EXTINGUISHER ON BRACKET IN BASE CABINET BELOW KITCHEN SINK - TYPICAL

3.) HANG HOT WATER HEATER FROM DECK ABOVE. (SEE DETAIL ON TYPICAL UNIT DETAILS SHEET) 9.) WHERE DROPPED SOFFITS AND CEILINGS ARE SHOWN, THESE ARE IN ADDITION TO THE FIRE RATED GWB CEILING ABOVE

10.) WHERE PLUMBING VALVES (TUB, SHOWER, ETC) ARE LOCATED IN FIRE RATED WALLS, PROVIDE FIRE RATED BOX IN WALL FOR VALVE TO BE INSTALLED WITHIN

CABINETRY AND APPLIANCE ABBREVIATIONS

WHICH IS PART OF THE RATED ASSEMBLY

DB = DRAWER BASE DRB = DOOR BASE

SB = SINK BASE WC = WALL CABINET

WC(24) = WALL CABINET 24" DEEP PU = PANTRY UNIT 24" DEEP OS = OPEN SHELVES

RA = RANGE DW = DISHWASHER

REF = REFRIGERATOR


REFLECTED CEILING PLAN AND LIGHTING LEGEND		
SYMBOL	TAG	DESCRIPTION
	Α	SURFACE MOUNT - TBD
	В	SURFACE MOUNTED - TBD
	С	SURFACE MOUNT - IN CLOSETS
	D	SURFACE MOUNTED ON WALL ABOVE DOO
	Е	WALL SCONCE IN BATHROOM OVER VANIT
	F	SURFACE MOUNT - WET LOCATION
	Н	SURFACE MOUNT CENTER IN BEDROOMS
	J	SURFACE MOUNT - WET LOCATION
	K	EXTERIOR CUT OFF DOWN LIGHT

CEILING GRILLE

MATCH THE CEILING THEY ARE INSTALLED WITHIN

 $M \setminus D$ CENTER ON -SHOWER FIRE RATED ACCESS PANEL BELOW DUCT HEATER ERV ┼├──────┼┼────┼┼╒┐ CENTER PAIR OF FIXTURES OVER SINK 24"X24" FIRE RATED ACCESS PANEL BELOW CENTER IN -BED ROOM CENTER ON -CABINET CEILING AT 8'-0" AFF TYPICAL WITHIN UNIT EQUAL EQUAL CENTER ON SINK -- DUCT DROP WITHIN SOFFIT BELOW EXTERIOR DUCT DROP WITHIN SOFFIT BELOW EXTERIOR PERIMETER BEAM PERIMETER BEAM SOFFIT AT 7'-6" AFF SOFFIT AT 7'-6" AFF WALL CAP UNIT 211-811 REFLECTED CEILING PLAN

1/2" = 1'-0"

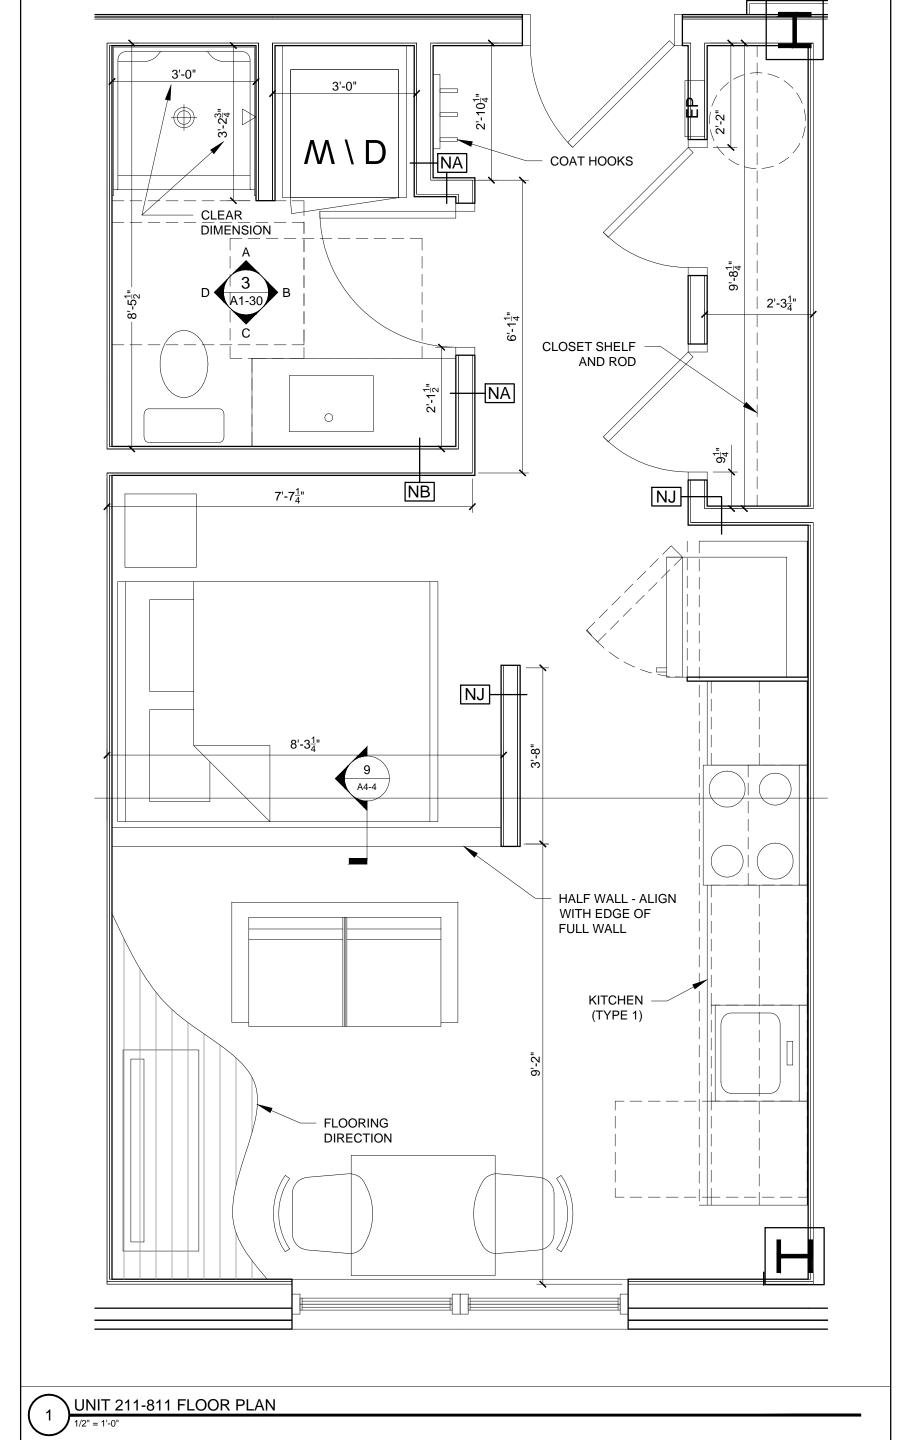

1X4 BASE, PAINTED

SOLID 2X8 BLOCKING FOR FUTURE -INSTALLATION OF GRAB BARS

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REVISIONS:

DATE: 2 NOVEMBER 201 PROJECT No. DRAWN BY: RJS / RR

CHECKED BY: AS NOTED SCALE: SHEET TITLE: UNIT 211-811

PLANS AND INTERIOR **ELEVATIONS**

A1-30