



LEARNINGWORKS 181 BRACKETT STREET, PORTLAND, MAINE

DETAILED PHASING PLAN & DESCRIPTION OF WORK

• MANSARD ROOF: STRIP ALL EXISTING ROOFING. UNDERLAYMENT AND FLASHING FROM LOW-SLOPE ROOF OVER CORNICE, AND STEEP-SLOPE PORTION OF MANSARD ROOF. REPLACE ANY DAMAGED/ROTTING SHEATHING WITH EXTERIOR GRADE PLYWOOD TO MATCH THICKNESS OF EXISTING ADJACENT SHEATHING MATERIAL. REPLACE ANY DAMAGED/ROTTING WOODWORK/TRIM WITH COMPOSITE TRIM MATERIAL TO EXACTLY MATCH PROFILES OF EXISTING. ASSESS CONDITION OF STRUCTURE WHERE EXPOSED DUE TO REPLACEMENT OF EXTERIOR ELEMENTS, NOTIFY ARCHITECT/OWNER'S REP OF ANY SIGNS OF STRUCTURAL DAMAGE TO WOOD FRAMING MEMBERS OR MASONRY. REPLACE DAMAGED/ROTTING EXTERIOR WOOD TRIM AT MANSARD ROOF TRANSITION WITH COMPOSITE TRIM MATERIAL TO EXACTLY MATCH SIZE AND PROFILES OF EXISTING. INSTALL SELF-ADHERED WATERPROOF ROOFING UNDERLAYMENT CONTINUOUS FROM EDGE OF EAVE AT CORNICE, UP FACE OF STEEP-SLOPED MANSARD ROOF TO TRIM BAND AT ROOF SLOPE TRANSITION AND OVER SIDES OF DORMER WALLS. INSTALL METAL DRIP-EDGE AND METAL ROOFING OVER LOW-SLOPE ROOF OVER CORNICE TURNED UP FACE OF MANSARD ROOF AND FLASHED OVER TOP EDGE. INSTALL NEW ASPHALT SHINGLES TO STEEP-SLOPE PORTION OF MANSARD ROOF (CERTAINTEED HATTERAS. 18" X 36" FIBERGLASS REINFORCED ASPHALT SHINGLE WITH 8" EXPOSURE). INSTALL NEW WOOD/COMPOSITE MATERIAL TRIM AT SIDES OF DORMER WALLS AND AT CORNERS OF ROOF. FASTEN ALL NEW TRIM WITH STAINLESS STEEL FASTENERS OR

COMPOSITE SCREWS WITH PLUGS. REPOINT MASONRY AS REQUIRED ON (4) CHIMNEYS OF 3-STORY BUILDING— MORTAR TO MATCH ORIGINAL

· 3RD FLOOR WINDOWS: REPLACE (10) WINDOWS ON 3RD FLOOR OF 3-STORY BUILDING. REMOVE EXISTING STORM WINDOWS AND ORIGINAL WOOD WINDOWS INCLUDING FULL FRAME AND WEIGHT POCKETS. REPLACE WITH CUSTOM ALUMINUM-CLAD WOOD WINDOWS TO MATCH EXISTING SIGHTLINES AS CLOSELY AS POSSIBLE, SIMULATED DIVIDED LIGHTS. REMOVE EXTERIOR WOOD WINDOW SILLS AND REPLACE WITH COMPOSITE MATERIAL. REPLACE ALL EXTERIOR WOOD WINDOW TRIM WITH COMPOSITE TRIM MATERIAL TO EXACTLY MATCH SIZE AND PROFILES OF EXISTING. · REPAINT ALL EXTERIOR TRIM (NEW AND EXISTING) AT CORNICE, THIRD FLOOR WINDOWS, AND MANSARD ROOF IN DARK COLOR (LOW CONTRAST WITH BRICKWORK) TO BE DETERMINED BY ARCHITECT AND AS APPROVED BY PORTLAND HISTORIC

· REMOVE EXISTING GUTTERS TO ALLOW WORK TO ROOF IDENTIFIED ABOVE. RE-INSTALL GUTTERS ON (4) SIDES OF ROOF WITH (4) DOWNSPOUTS, (2) EACH ON NORTH AND SOUTH SIDES OF BUILDING WITH ELBOW ABOVE GROUND AND DIVERTERS AT GROUND LEVEL TO DIRECT WATER AWAY FROM BUILDING.

· HIP ROOF: ASSESS CONDITION OF LOW-SLOPE HIP PORTION OF MANSARD ROOF, REPLACE PER ABOVE IF REQUIRED. PHOTOS DATED 10/30/14 APPEAR TO SHOW

SHINGLES IN GOOD CONDITION · GABLE ROOF 2-STORY BUILDING: STRIP ALL EXISTING ROOFING, UNDERLAYMENT AND FLASHING FROM BOTH PITCHES OF ROOF. REPLACE ANY DAMAGED/ROTTING SHEATHING WITH EXTERIOR GRADE PLYWOOD TO MATCH THICKNESS OF EXISTING ADJACENT MATERIAL. REPLACE ANY DAMAGED/ROTTING WOODWORK/TRIM WITH COMPOSITE TRIM MATERIAL TO EXACTLY MATCH PROFILES OF EXISTING. ASSESS CONDITION OF STRUCTURE WHERE EXPOSED DUE TO REPLACEMENT OF EXTERIOR ELEMENTS, NOTIFY ARCHITECT/OWNER'S REP OF ANY SIGNS OF STRUCTURAL DAMAGE TO WOOD FRAMING MEMBERS OR MASONRY. INSTALL SELF-ADHERED WATERPROOF ROOFING UNDERLAYMENT IN TWO COURSES (6' TOTAL WIDTH) AT EAVES, ONE COURSE (3'WIDTH) AT RAKES AND AROUND SKYLIGHTS AND OTHER PENETRATIONS. INSTALL 30LB ROOFING FELT OVER REMAINED OF ROOF. INSTALL METAL DRIP-EDGE AND STEP FLASHING AT ABUTMENT WITH 3-STORY BRICK BUILDING. INSTALL NEW ASPHALT SHINGLE ROOFING (3-TAB FIBERGLASS

REINFORCED ASPHALT SHINGLE). REMOVE AND REPLACE ALL EXTERIOR WOOD TRIM ON LOWER ROOF: EAVE. SOFFIT, FASCIA. REPLACE WITH COMPOSITE TRIM TO MATCH ORIGINAL PROFILES. REPAINT ALL EXTERIOR TRIM AT CORNICE IN DARK COLOR (LOW CONTRACT WITH BRICKWORK) TO BE DETERMINED BY ARCHITECT AND AS APPROVED BY PORTLAND HISTORIC PRESERVATION BOARD.

· INSTALL NEW GUTTER ON (2) SIDES OF ROOF WITH (2) DOWNSPOUTS, (1) EACH ON NORTH AND SOUTH SIDES OF BUILDING WITH ELBOW ABOVE GROUND AND DIVERTERS AT GROUND LEVEL TO DIRECT WATER AWAY FROM BUILDING. · REPOINT MASONRY AT TOP OF WALL WHERE DAMAGED BY WATER INFILTRATION. REPLACE ANY DAMAGED BRICK WITH NEW/SALVAGED BRICK TO MATCH EXISTING. PRIOR TO COMMENCING ANY MASONRY WORK ON BUILDING EXTERIOR CONDUCT ANALYSIS OF ORIGINAL MORTAR TO DETERMINE COMPOSITION AND STRENGTH. NEW MORTAR FOR POINTING AND BEDDING NEW/REPLACEMENT/REPAIRED BRICKWORK TO MATCH EXISTING MORTAR AS CLOSELY AS POSSIBLE IN TERMS OF COLOR, COMPOSITION AND STRENGTH. CONTRACTOR TO BUILD A TEST PANEL FOR HPB APPROVAL OF BRICK AND MORTAR.

NEW STOREFRONT & ENTRY: AT (2) 7'-0" +/- WIDE ARCHED OPENINGS REMOVE ALL WINDOWS, WOOD FRAMED & FINISHED WALL AND BRICK INFILL BELOW WINDOW SILLS TO 8" ABOVE GRADE. REPLACE WITH NEW ALUMINUM-CLAD WOOD FIXED WINDOWS TO MATCH ORIGINAL DESIGN: FULL HEIGHT, TRIPARTITE WINDOW WITH PANELED WOOD INFILL BELOW SILL HEIGHT WHERE ORIGINAL BULKHEAD WINDOWS WERE LOCATED. MODIFY EXISTING CEILINGS TO SLOPE UP TO ORIGINAL WINDOW HEAD HEIGHT. REMOVE SINGLE DOOR, SURROUNDING INFILL AND '181' SIGN FROM CENTRAL ARCHED OPENING. REPLACE WITH FIXED DOUBLE DOOR PANELS AND TRANSOM WINDOW ABOVE TO

MATCH ORIGINAL LAYOUT. INSULATE BEHIND DOOR PANELS AND FINISH INTERIOR TO BLEND WITH ADJACENT FINISHES · REPLACE FULLY-GLAZED DOORS AT CURRENT MAIN ENTRY WITH PART-GLAZED DOORS AND PHASE 3A - REPAIRS TO WOOD BUILDING SIDELIGHTS. DOORS TO BE CUSTOM WOOD AS DETAILED IN DRAWINGS. COORDINATE NEW

HARDWARE REQUIREMENTS WITH OWNER'S REP. REPLACE FULLY-GLAZED DOOR AT STAIR EXIT WITH PART-GLAZED DOOR. DOOR TO BE CUSTOM WOOD AS DETAILED IN DRAWINGS. COORDINATE NEW HARDWARE REQUIREMENTS

• ENTRY RAMP: DEMO EXISTING CONCRETE AND BRICK ENTRY RAMP. EXCAVATE AND INSTALL NEW POURED CONCRETE FROST WALLS AND FOOTINGS TO DEFINE EXTENT OF NEW RAMP TO MATCH SIZE OF EXISTING. POUR NEW CONCRETE RAMP AT 1:12 PITCH WITH LEVEL LANDING AT TOP AND BOTTOM. FACE CONCETE FROST WALLS AND RAMP SURFACE WITH

BRICK PAVERS. INSTALL NEW PAINTED METAL PIPE RAIL. · AT DOOR ON SOUTH SIDE OF 2-STORY BRICK BUILDING: FILL VOID SPACE BETWEEN DOOR FRAME AND WALL WITH SPRAY FOAM INSULATION, INSTALL NEW SHEATHING OVER FRAMING, WRB AND PAINTED COMPOSITE MATERIAL TRIM AROUND DOOR. PROVIDE SEALANT BETWEEN

PHASE 2 – WINDOW REPLACEMENT & MASONRY REPAIR

· 2ND FLOOR WINDOWS: REPLACE (12) WINDOWS ON 2ND FLOOR OF 3-STORY BUILDING. REMOVE EXISTING STORM WINDOWS AND ORIGINAL WOOD WINDOWS INCLUDING FULL FRAME AND WEIGHT POCKETS. REPLACE WITH CUSTOM ALUMINUM-CLAD WOOD ARCH-TOP WINDOWS TO MATCH EXISTING SIGHTLINES AS CLOSELY AS POSSIBLE, SIMULATED DIVIDED

LIGHTS AND BRICKMOLD REPLACE (3) WINDOWS ON 1ST FLOOR OF 3-STORY BUILDING. REMOVE EXISTING STORM WINDOWS AND (1) ORIGINAL WOOD WINDOW AND (2) NON-ORIGINAL WINDOWS IN ORIGINAL DOOR OPENINGS, INCLUDING FULL FRAME AND WEIGHT POCKETS. RE-BUILD WALL FRAMING AND INTERIOR FINISHES AS REQUIRED TO FRAME NEW WINDOW OPENINGS AND PREP TO RECEIVE NEW BRICK INFILL BELOW SILLS. REPLACE WITH CUSTOM ALUMINUM-CLAD WOOD WINDOWS TO MATCH EXISTING/ORIGINAL SIGHTLINES AS CLOSELY AS POSSIBLE, SIMULATED

DIVIDED LIGHTS AND BRICKMOLD. · REPLACE (11) WINDOWS ON 1ST AND 2ND FLOORS OF 2-STORY BUILDING. REMOVE EXISTING 'REPLACEMENT' WINDOWS AND ORIGINAL WOOD WINDOWS INCLUDING FULL FRAME AND WEIGHT POCKETS. REPLACE WITH CUSTOM ALUMINUM-CLAD WOOD WINDOWS TO MATCH ORIGINAL SIGHTLINES AS CLOSELY AS POSSIBLE, SIMULATED DIVIDED LIGHTS AND

· CREATE (4) NEW WINDOW OPENINGS ON NORTH SIDE OF 2-STORY BUILDING, INSTALL (4) NEW WINDOWS TO MATCH REPLACEMENT WINDOWS. REFER TO STRUCTURAL DRAWINGS/SPECIFICATIONS. NEW OPENINGS TO ALIGN WITH BRICK COURSING AND MATCH DIMENSIONS OF EXISTING MASONRY OPENINGS ADJACENT. TOOTH-IN SALVAGED BRICKS AT JAMBS TO AVOID EXPOSURE OF CUT BRICK ENDS. MODIFY INTERIOR FINISHES AS REQUIRED,

PROVIDE NEW PAINTED WOOD TRIM AT INTERIOR. · AT ALL NEW/REPLACEMENT WINDOWS REPAIR INTERIOR FINISHES AS REQUIRED AND REPAINT HEAD, JAMB & SILL RETURNS AND INTERIOR TRIM FOR UNIFORM, FINISHED

· PRIOR TO COMMENCING ANY MASONRY WORK ON BUILDING EXTERIOR CONDUCT ANALYSIS OF ORIGINAL MORTAR TO DETERMINE COMPOSITION AND STRENGTH. NEW MORTAR FOR POINTING AND BEDDING NEW/REPLACEMENT/REPAIRED BRICKWORK TO MATCH EXISTING MORTAR AS CLOSELY AS POSSIBLE IN TERMS OF COLOR, COMPOSITION AND STRENGTH. CONTRACTOR TO BUILD A TEST PANEL FOR HPB APPROVAL OF BRICK AND MORTAR. REPLACE DAMAGED BRICK AND REPOINT AS REQUIRED ON ALL SIDES OF BRICK BUILDINGS - MORTAR TO MATCH ORIGINAL. WHERE POSSIBLE, REPLACEMENT BRICK TO BE SALVAGED

 TOOTH-IN NEW/SALVAGED BRICK AT JAMBS OF DOOR INSTALLED IN ORIGINAL WINDOW OPENING ON SOUTH SIDE OF 2-STORY BUILDING TO AVOID EXPOSURE OF CUT BRICK ENDS. · INFILL WITH BRICK (2) BOARDED UP ORIGINAL DOOR OPENINGS ON SOUTH SIDE OF 3-STORY BUILDING BELOW NEW REPLACEMENT WINDOWS. RECESS BRICKWORK 1/2" BACK FROM FACE OF ORIGINAL BRICK, USE ALL NEW BRICK BEDDED AND POINTED WITH MORTAR

LOOSE/FLAKING PAINT. REPAINT ONLY PREVIOUSLY PAINTED MASONRY WITH LOW-CONTRACT

· SCRAPE/BRUSH PAINTED MASONRY AT FIRST FLOOR STREETFRONT TO REMOVE ALL

COLOR TO BE DETERMINED BY DETERMINED BY ARCHITECT AND AS APPROVED BY

FROM NEW OPENINGS CREATED IN NORTH WALL OF 2-STORY BUILDING.

PORTLAND HISTORIC PRESERVATION BOARD.

WOOD BUILDING: REMOVE EXISTING DOUBLE EXTERIOR DOORS AND (2) WINDOWS ABOVE ON WEST SIDE OF WOOD BUILDING. REMOVE EXISTING EXTERIOR OSB SHEATHING AND INSPECT FRAMING FOR SIGNS OF DAMAGE/DECAY, REPLACE AS REQUIRED. FRAME NEW SINGLE OPENING AND INSTALL NEW DOUBLE EXTERIOR DOOR WITH TRANSOM LIGHT. INSTALL NEW EXTERIOR SHEATHING AND WRB, FINISH WITH NEW WOOD CLAPBOARD SIDING TO MATCH EXISTING.

· SCRAPE, PRIME, AND REPAINT ALL SIDING AND TRIM ON ALL (4) SIDES OF WOOD BUILDING SCRAPE, PRIME, AND REPAINT ALL EXISTING WOOD WINDOWS OF WOOD BUILDING. REPLACE EXISTING 6/6 WOOD WINDOWS ON SOUTH ELEVATION WITH NEW 2/2 ALUMINUM

PRIME/PAINT WALLS, CEILINGS, DOORS, WINDOWS AND TRIM AS APPLICABLE THROUGHOUT

3RD FLOOR

INSTALL NEW SINK AND TOILET VERIFY INTEGRITY OF ALL INTERIOR FINISHES, REPAIR AS NEEDED ANY CEILINGS IN BAD SHAPE TO BE REPLACED WITH ACT BELOW NEW WINDOWS, PAINTING PER OTHER SCOPES

*PHASING SUBJECT TO CONTRACTOR PRICING AND OWNER FUNDING

PHASES 3A, 3B MAY OCCUR INDEPENDENTLY AND NON-SEQUENTIALLY WITH EACH OTHER

PHASE 3B – INTERIOR RENOVATIONS 3RD FLOOR · SCOPE OF INTERIOR WORK DEPENDENT ON OUTCOME OF DISCUSSIONS WITH CODE

ENFORCEMENT OFFICIALS

DEMO ALL EXISTING BATHROOM FIXTURES

UPGRADE ELECTRICAL AS REQUIRED UPGRADE FIRE ALARM SYSTEM AS REQUIRED INSULATE EXTERIOR WALLS AND ROOF

- DETAIL NUMBER CALL OUT A101 DRAWING NUMBER CENTERLINE (101) DOOR TAG **ELEVATION INDICATOR** >♥ | ELEVATION TAG View Name **ELEVATION TAG** NORTH ARROW REVISION

ROOM TAG WITH NUMBER

STRUCTURAL GRID BUBBLE

WALL TAG

WINDOW TAG

Room name

101

(1i)

SYMBOL LEGEND

DETAIL NUMBER

BUILDING SECTION

- DRAWING NUMBER

	-ESER	VATION
ISTORIC DO NOT FOR	PRESERVI RD REVI CONST	RUCTION
NOT FOR	Con	


	DRAWING LIST	
NUMBER	SHEET TITLE	
A001	COVER SHEET	
A101	FIRST FLOOR PLAN	
A102	SECOND FLOOR PLAN	
A103	THIRD FLOOR PLAN	
A201	ELEVATIONS	
A202	ELEVATIONS & WINDOW SCHEDULE	
A401	STOREFRONT DETAILS	
A402	ARCH WINDOW DETAILS	
A403	3RD FLOOR WINDOW DETAILS	
A501	DOOR SCHEDULE	
A601	EXISTING CONDITIONS PHOTOGRAPHS	


	DRAWING LIST
NUMBER	SHEET TITLE
\ 001	COVER SHEET
\101	FIRST FLOOR PLAN
102	SECOND FLOOR PLAN
103	THIRD FLOOR PLAN
\201	ELEVATIONS
\202	ELEVATIONS & WINDOW SCHEDULE
\401	STOREFRONT DETAILS
\402	ARCH WINDOW DETAILS
\403	3RD FLOOR WINDOW DETAILS
\501	DOOR SCHEDULE


04/01/15
1503
RIP
HWH
HEET

CONSULTANTS:


REVISIONS:

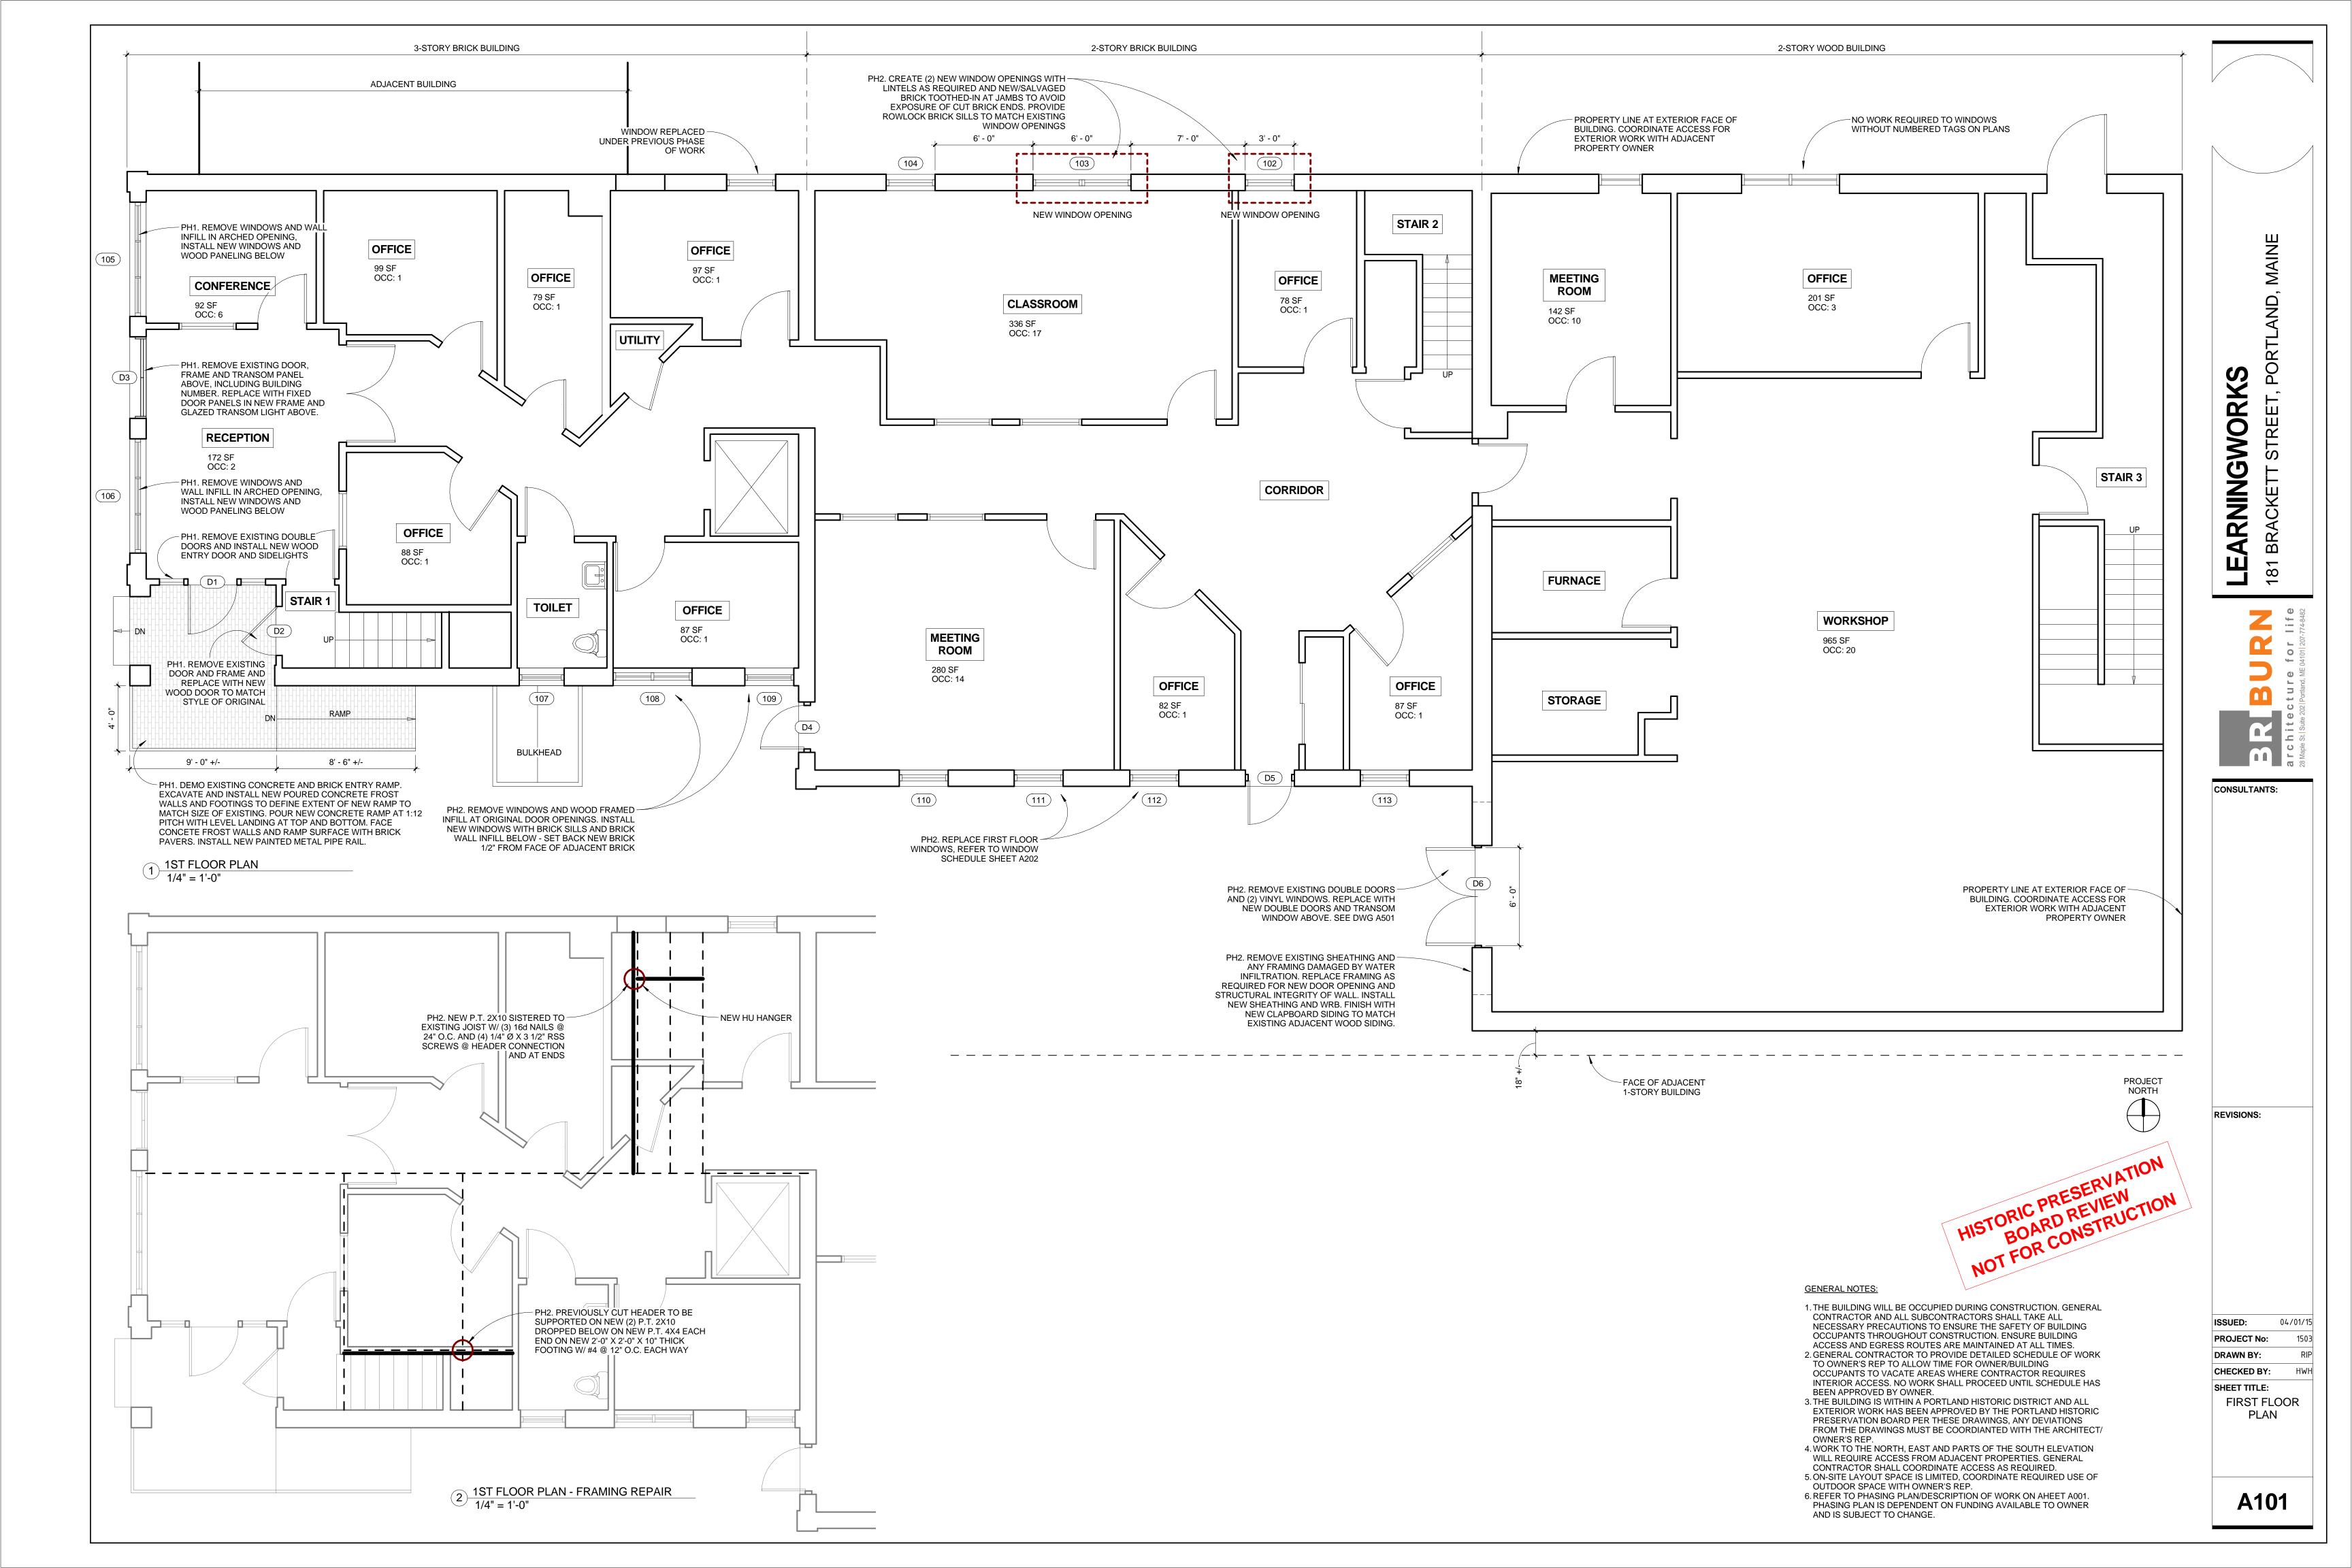


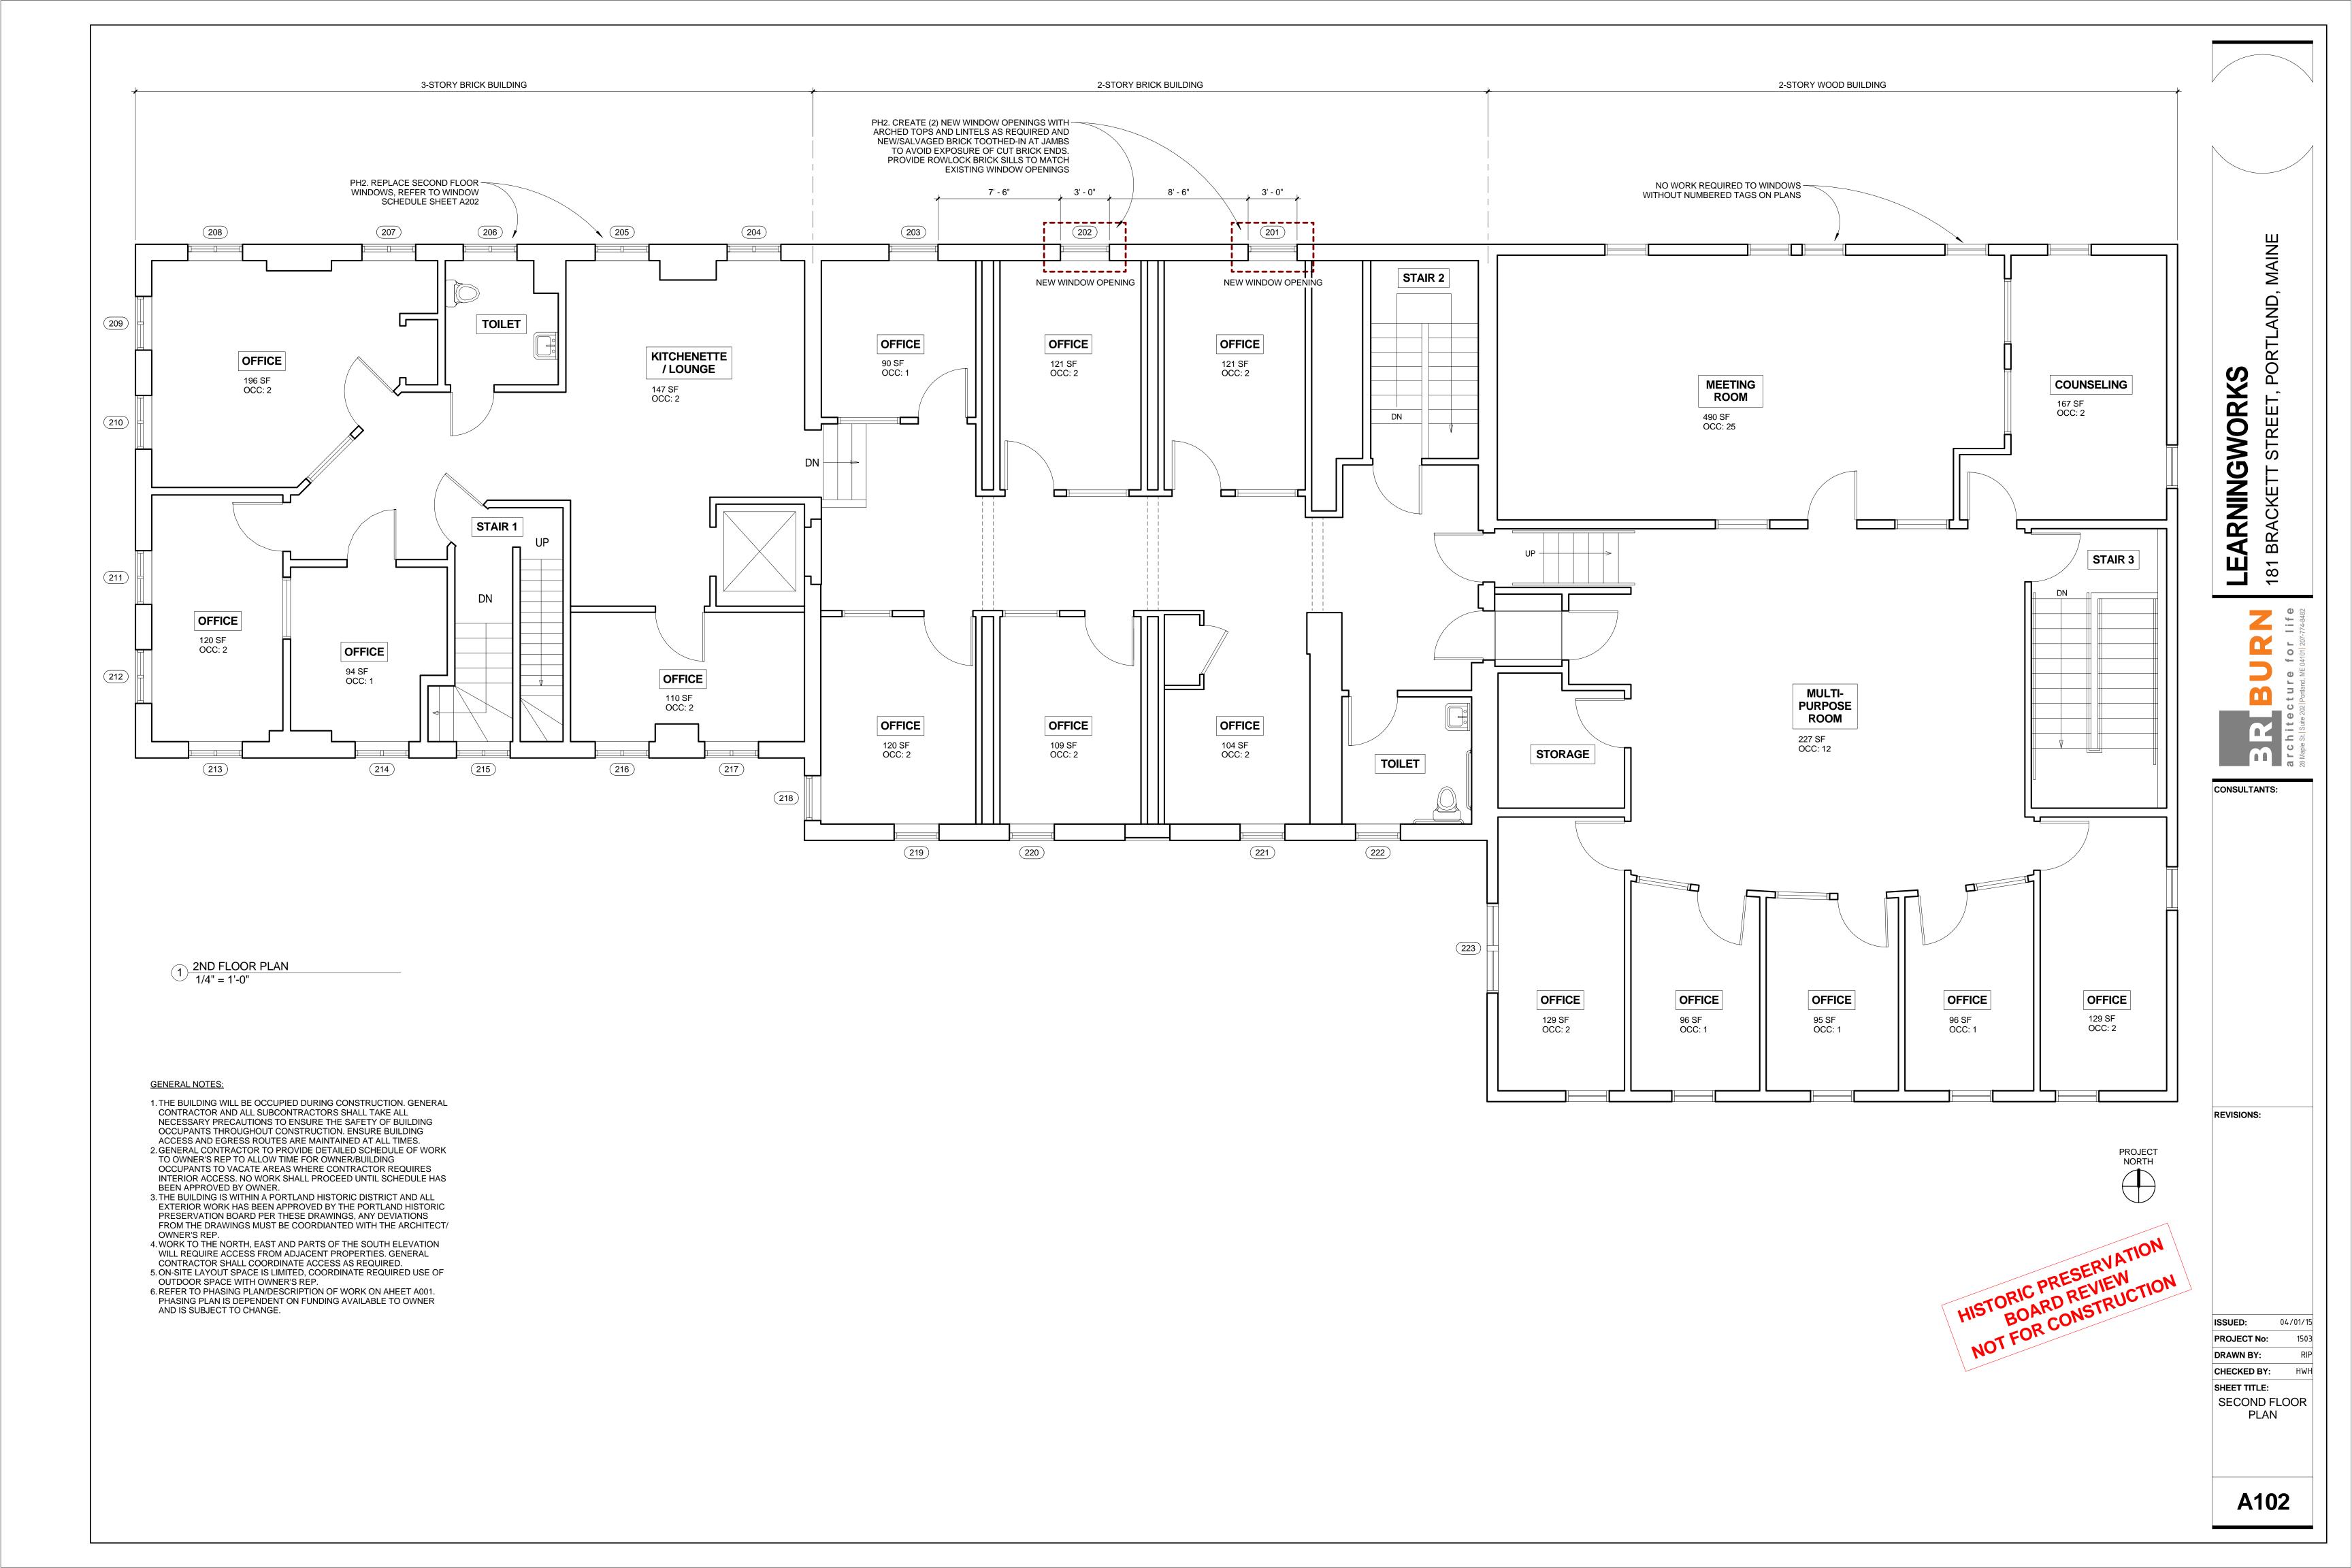

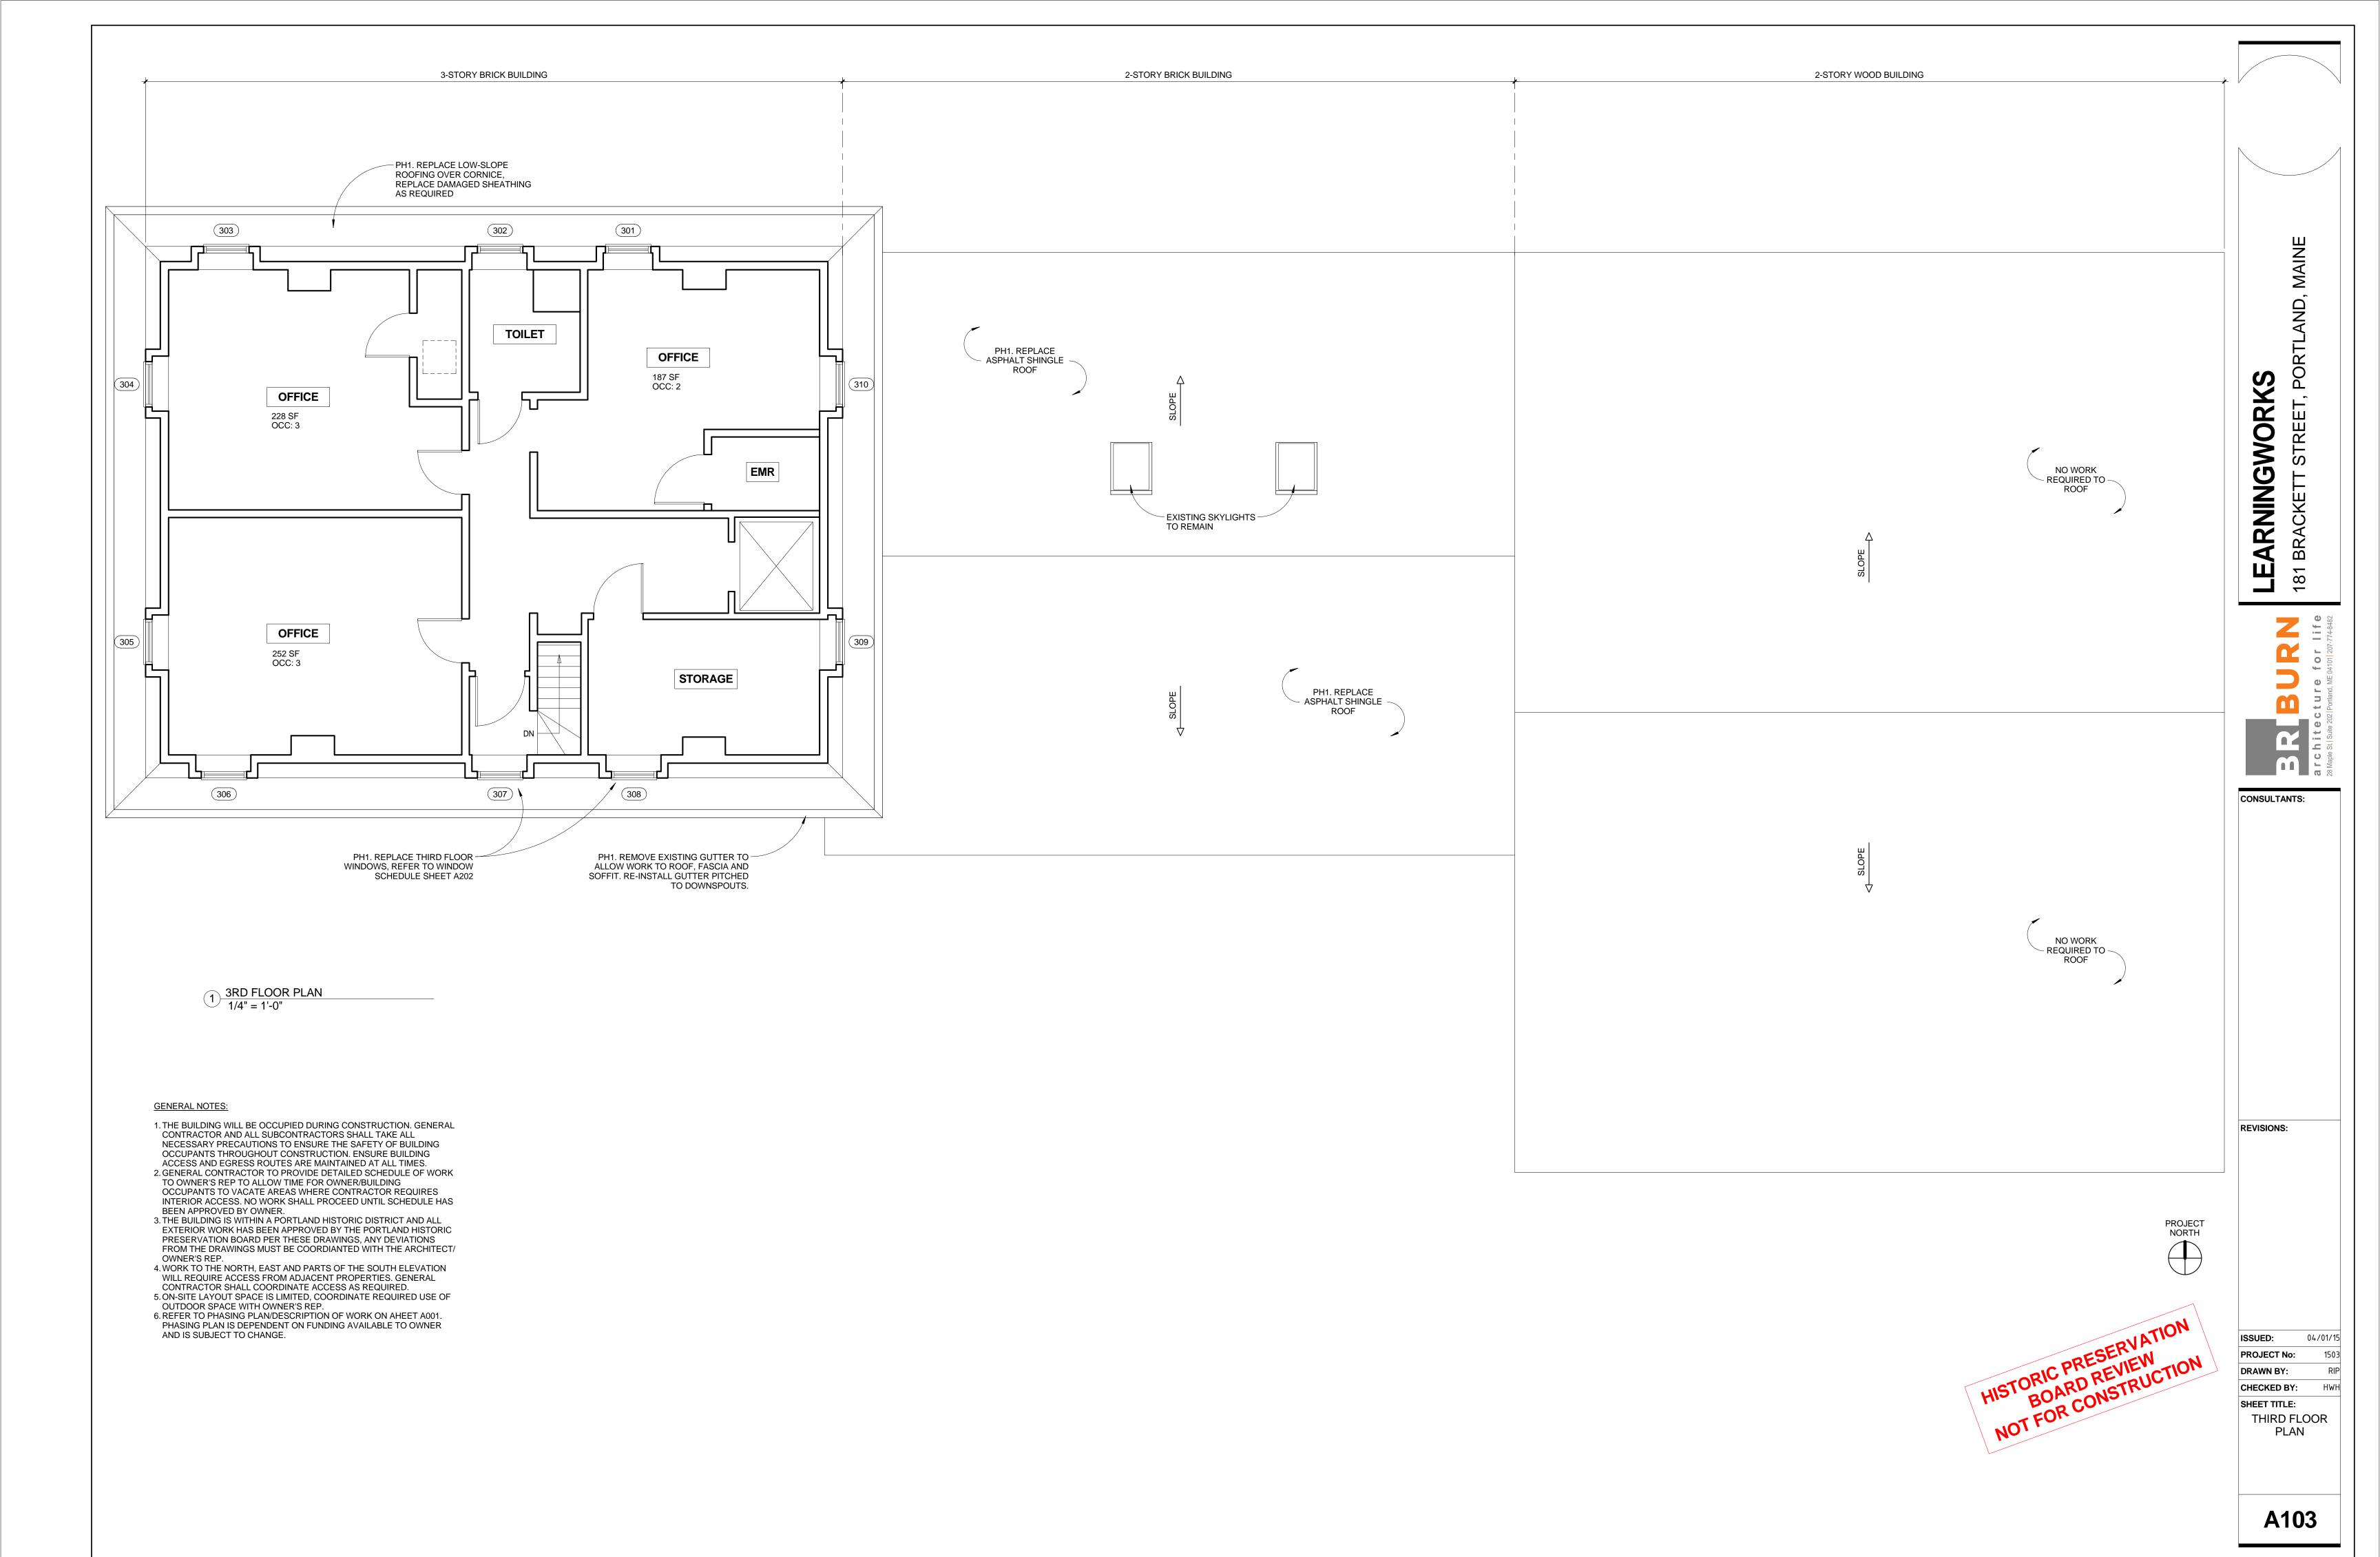



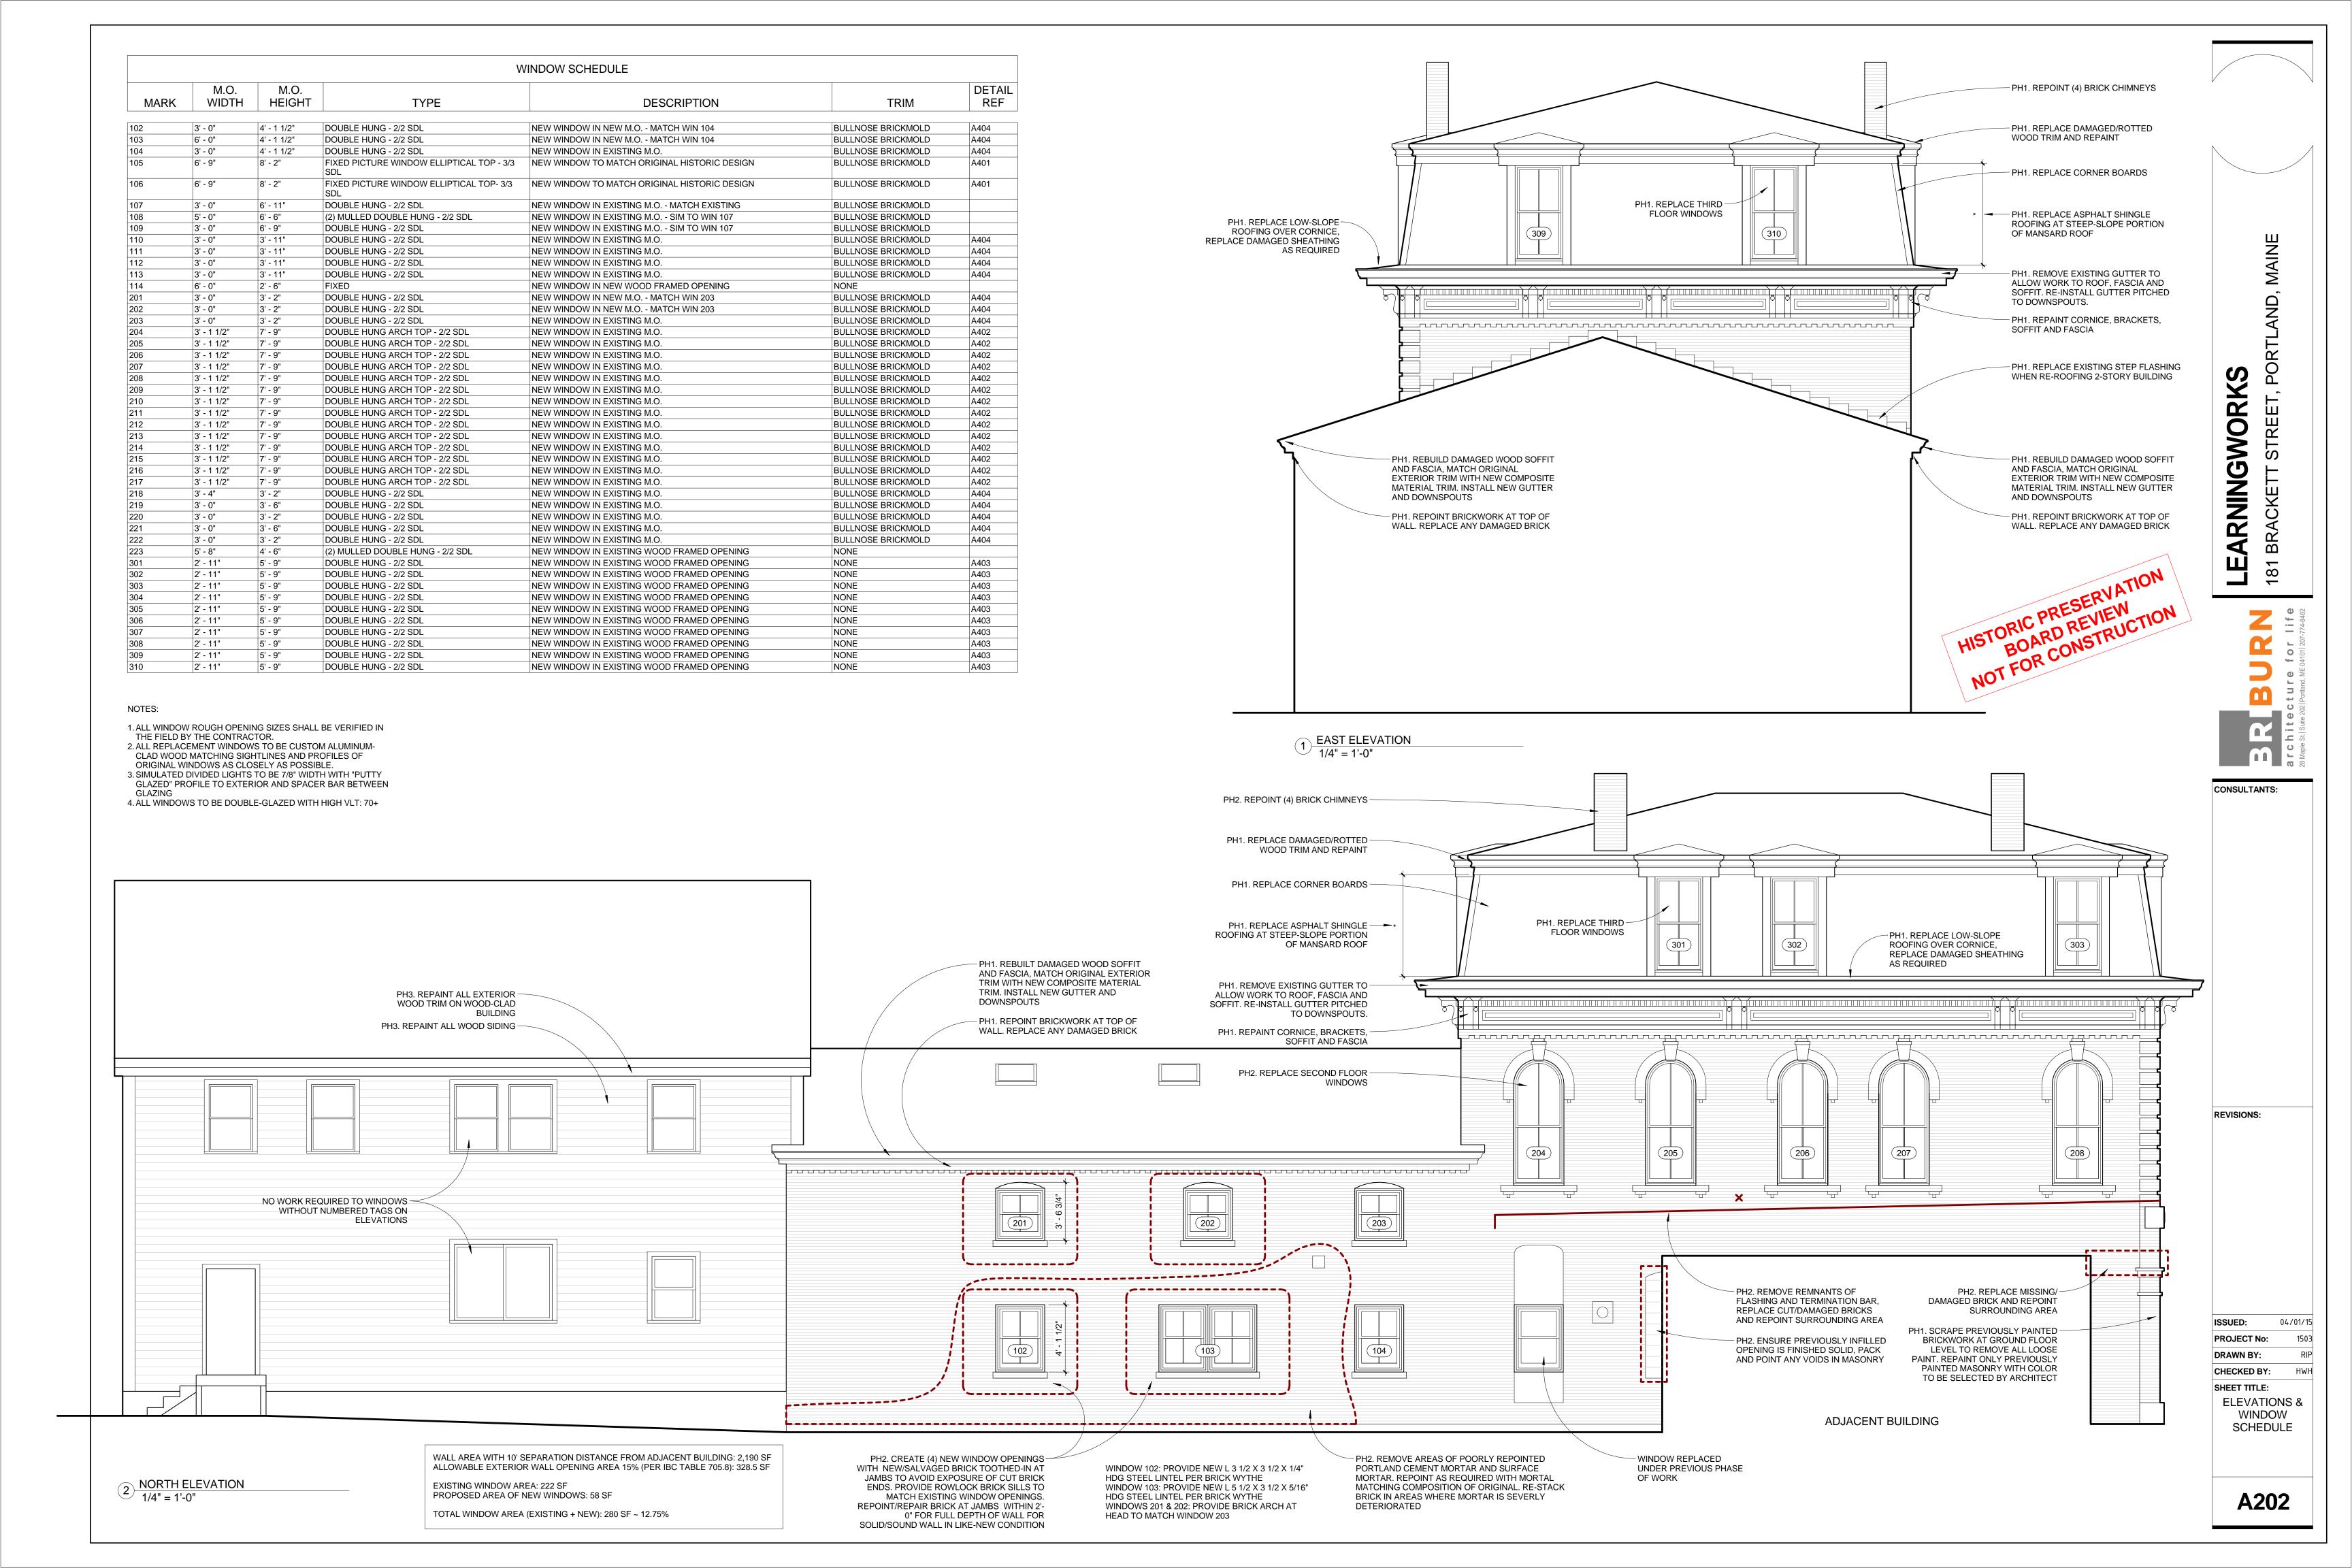


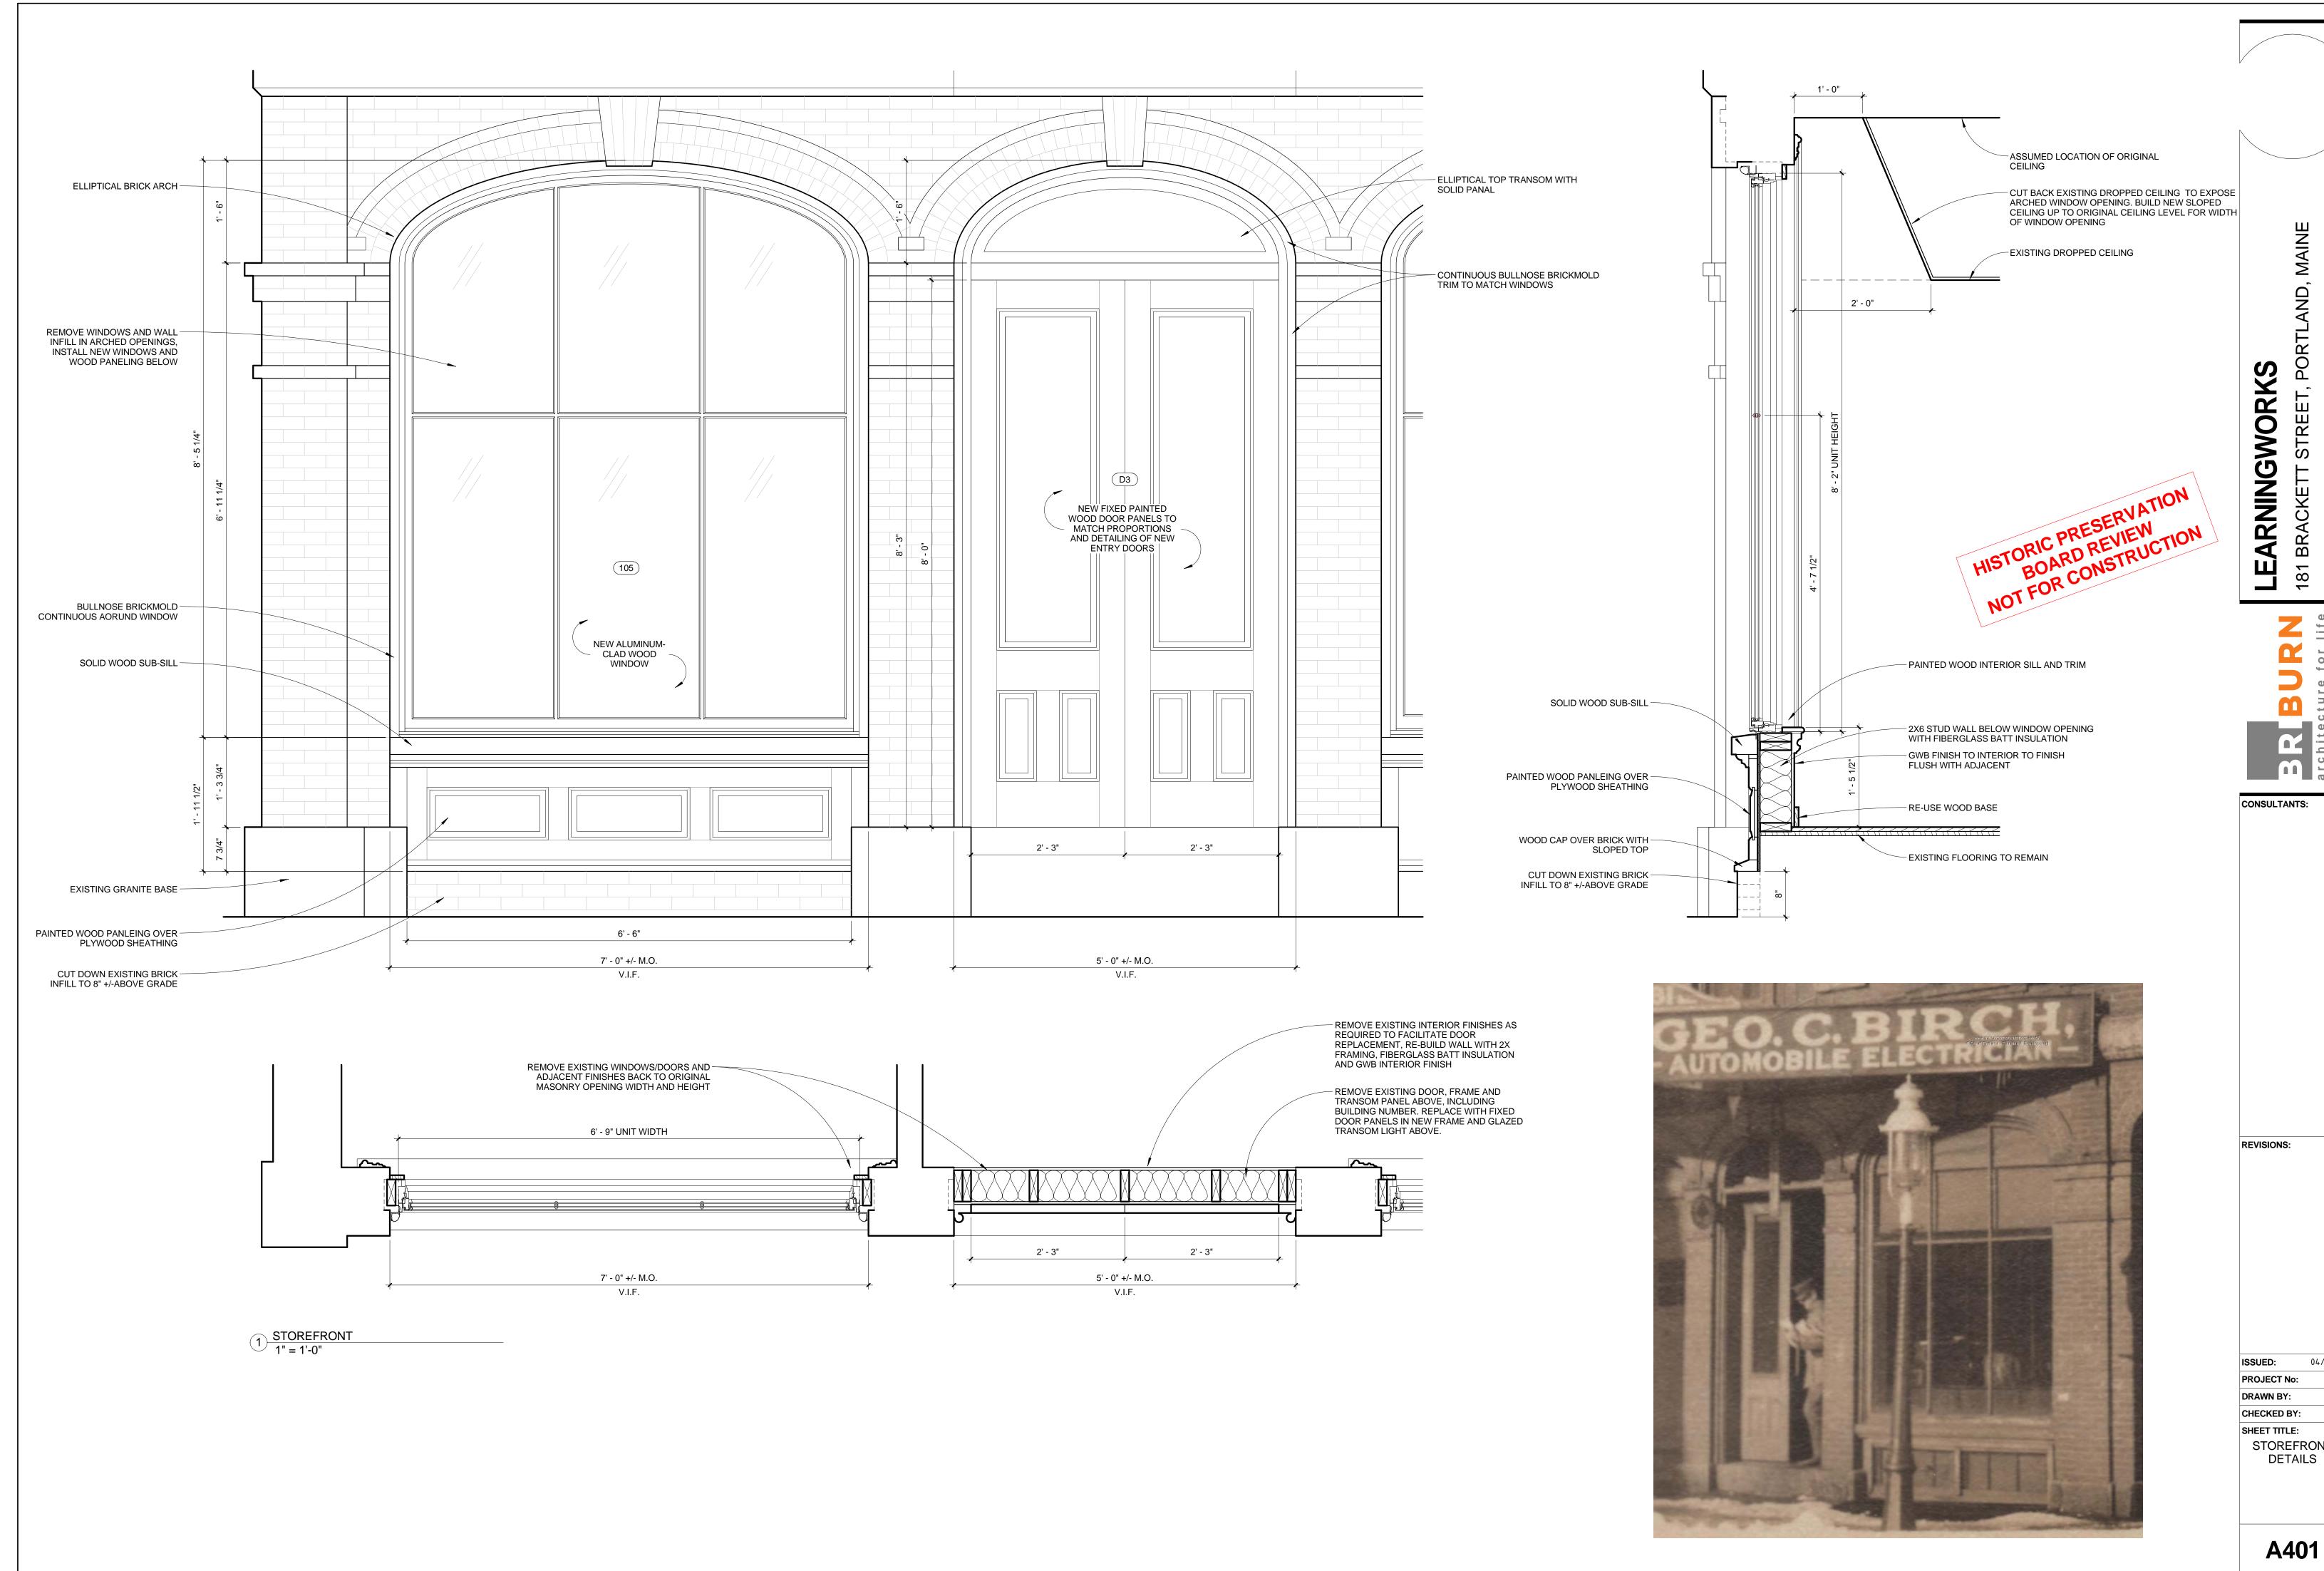

BRACKET

04/01/15

1503 STOREFRONT

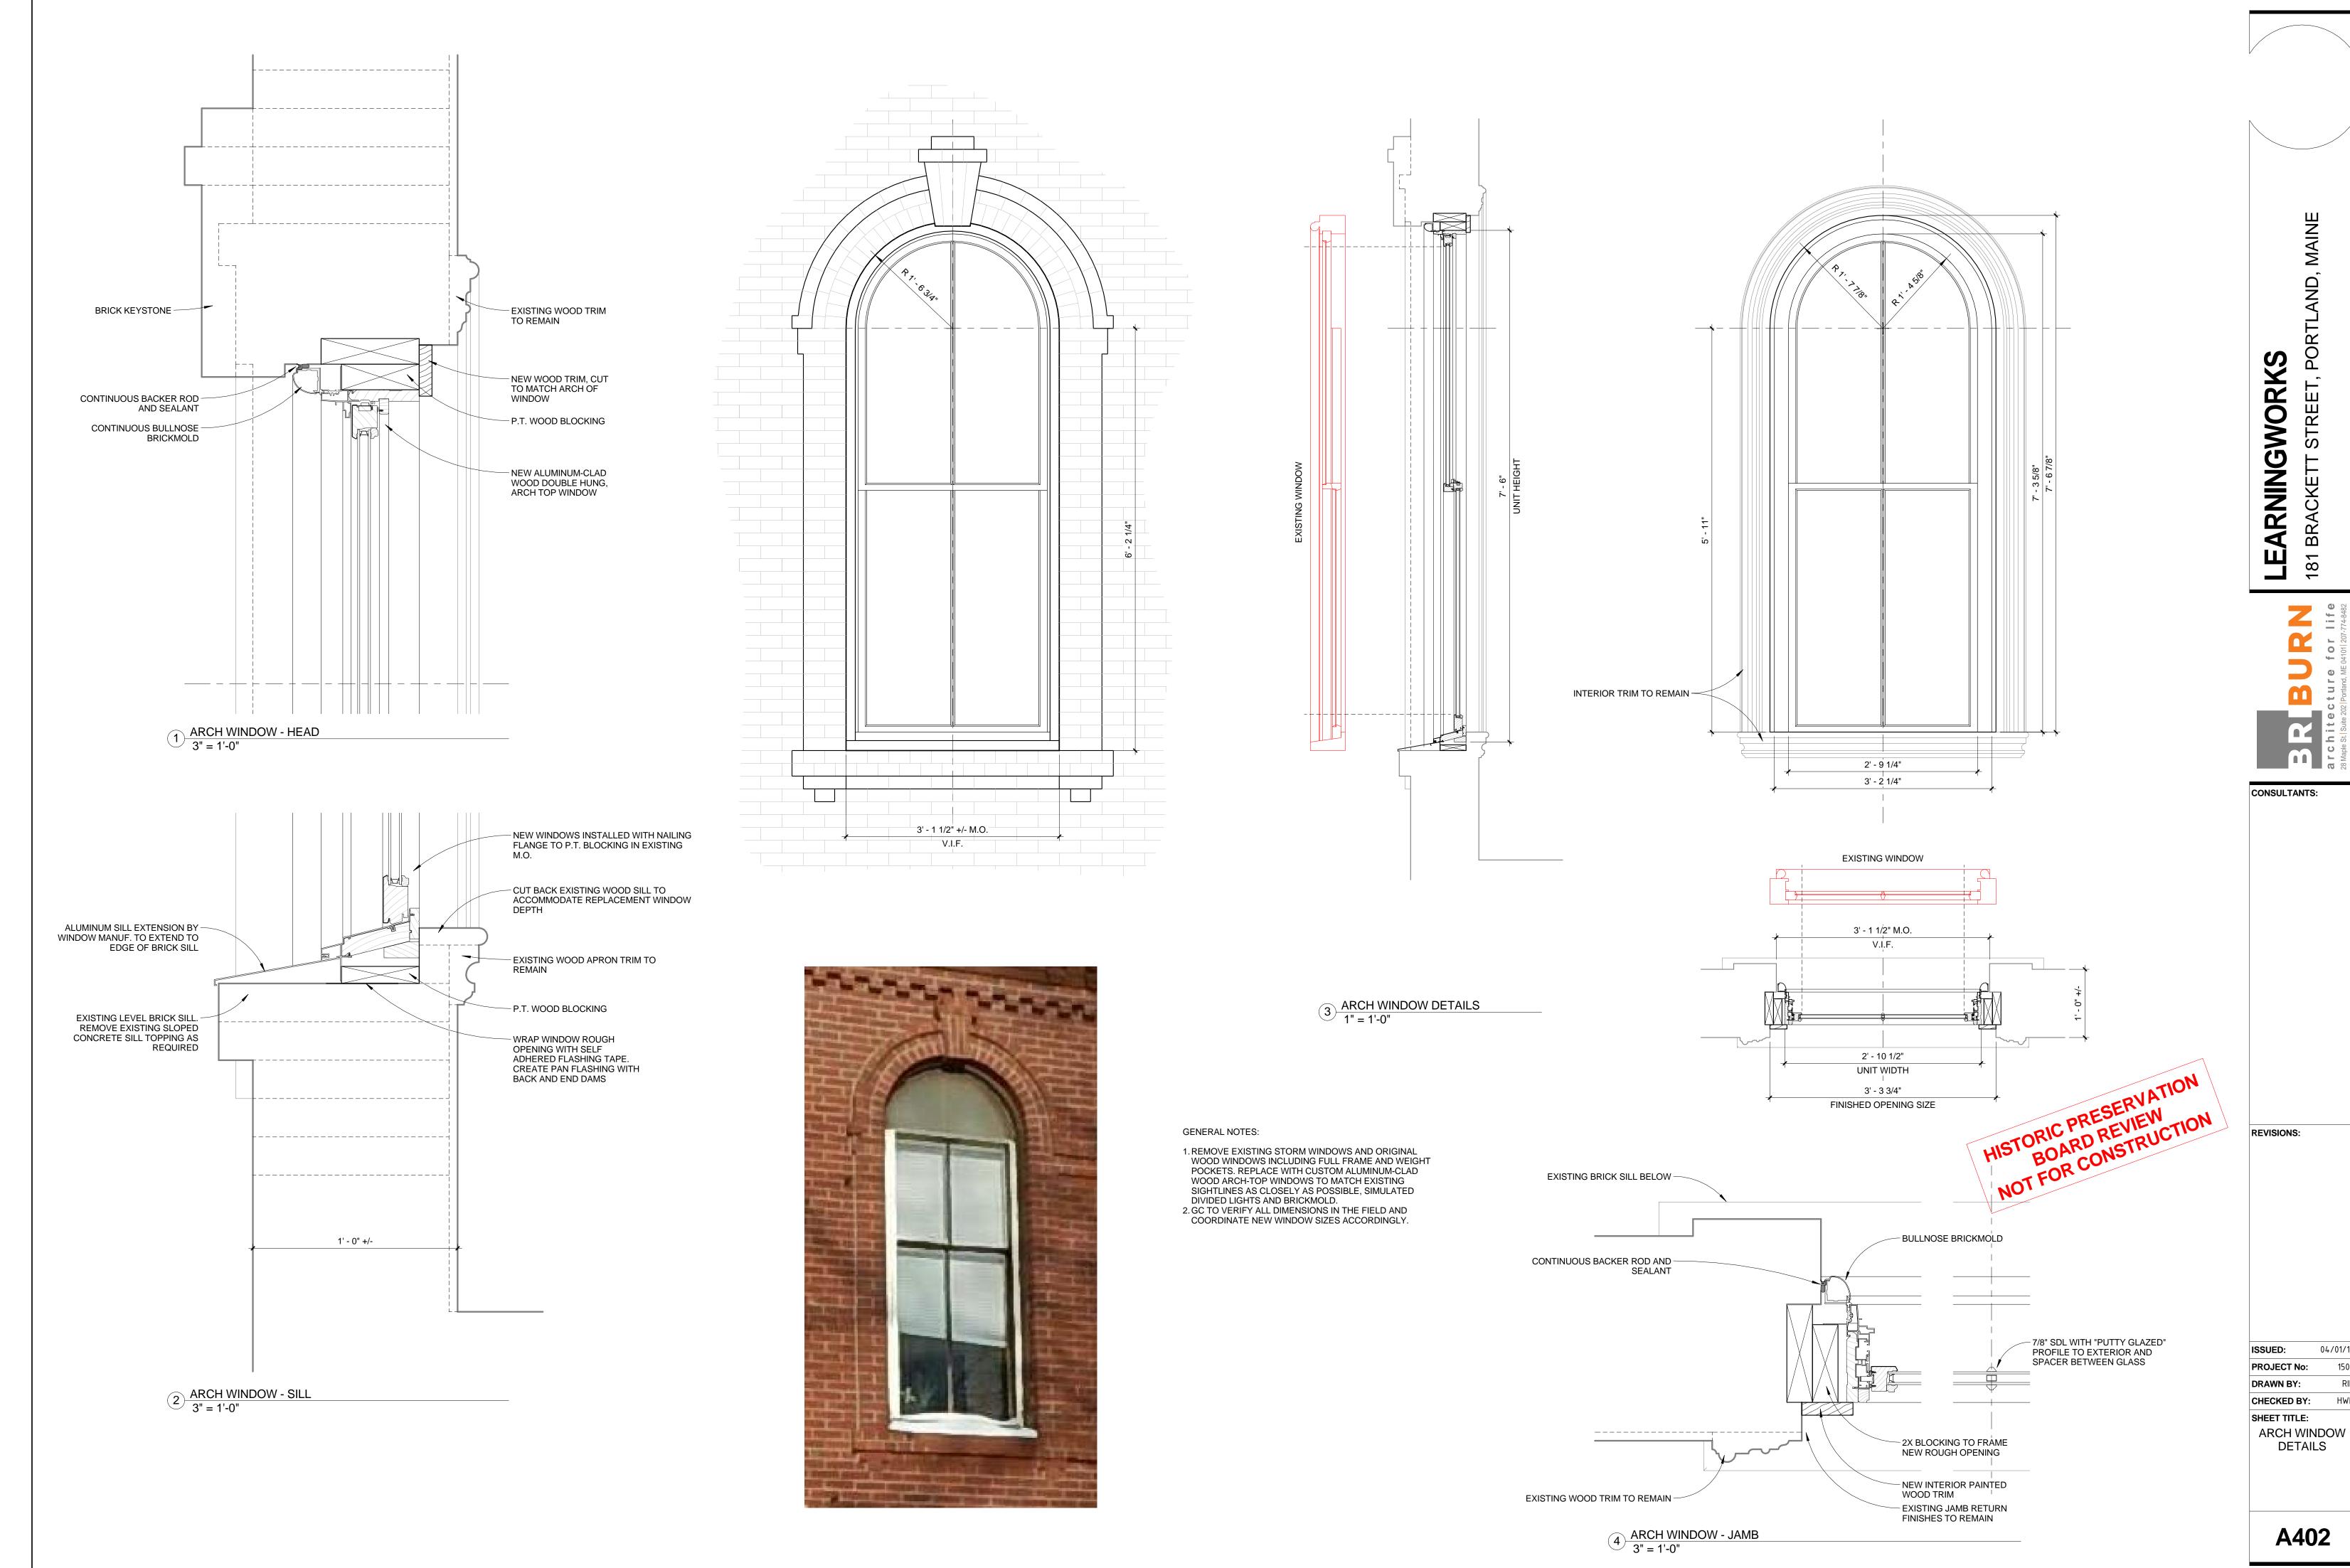

04/01/15 1503



ARNINGWORKS


CONSULTANTS:


REVISIONS:


04/01/15 ISSUED: 1503 PROJECT No: DRAWN BY:

CHECKED BY: SHEET TITLE: 3RD FLOOR WINDOW DETAILS

A403

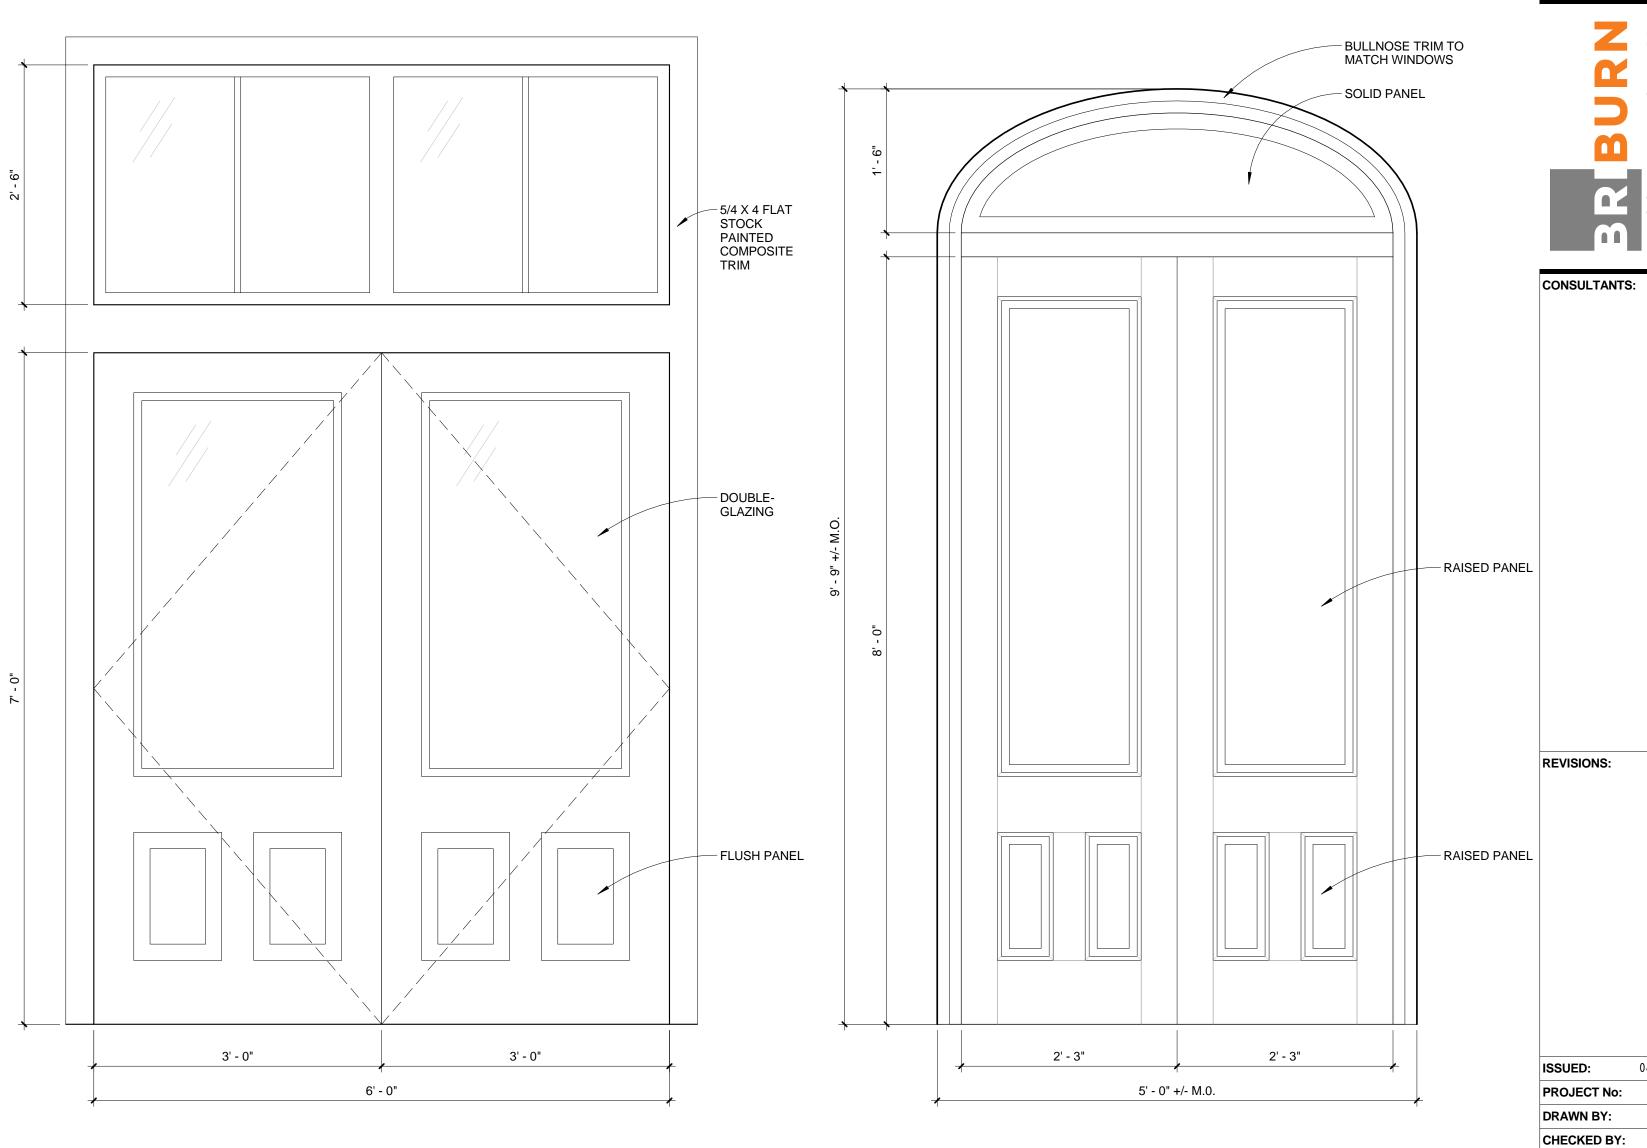

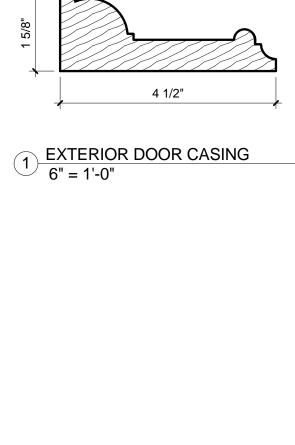

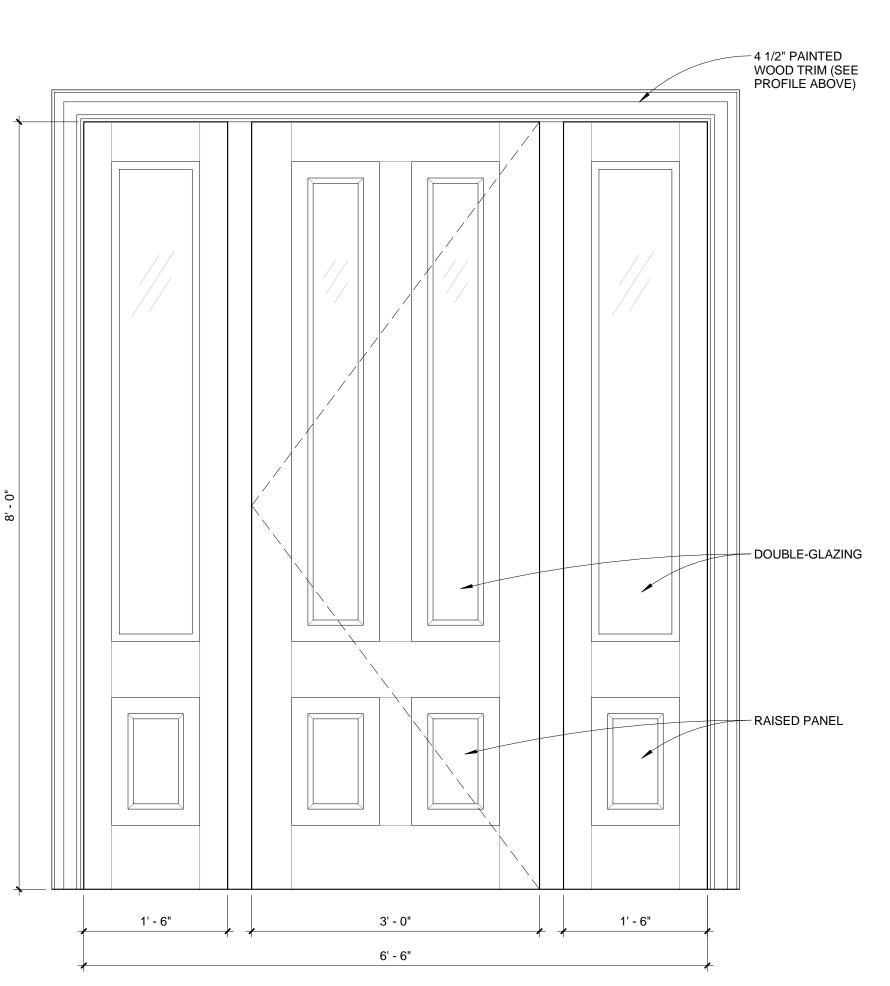

JELD-WEN - CUSTOM CLAD-WOOD GLASS PANEL EXTERIOR DOOR MODEL A110 CUSTOM COLOR PAINT FACTORY FINISH

3' - 0"

— 4 1/2" PAINTED WOOD TRIM (SEE PROFILE ABOVE)

— DOUBLE-GLAZING

RAISED PANEL

JELD-WEN - CUSTOM CLAD-WOOD GLASS PANEL EXTERIOR DOOR CUSTOM COLOR PAINT FACTORY FINISH

JELD-WEN - CUSTOM CLAD-WOOD EXTERIOR DOOR INOPERABLE DOOR PANELS (NO HARDWARE) ELLIPTICAL TOP TRANSOM WITH SOLID PANEL (NO GLAZING) CUSTOM COLOR PAINT FACTORY FINISH

DOOR LEGEND
1" = 1'-0"


JELD-WEN - CUSTOM CLAD-WOOD GLASS PANEL EXTERIOR DOOR WITH SIDELIGHTS MODEL A110 CUSTOM COLOR PAINT FACTORY FINISH

SHEET TITLE:

DOOR SCHEDULE

04/01/15



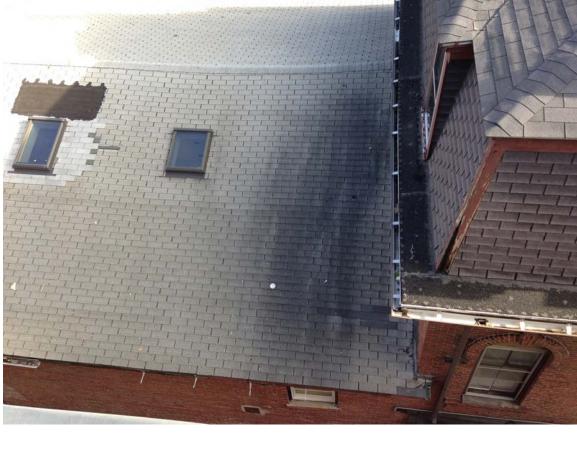

























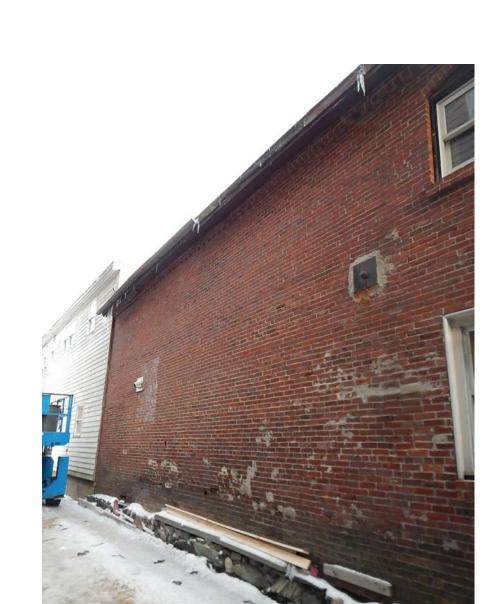



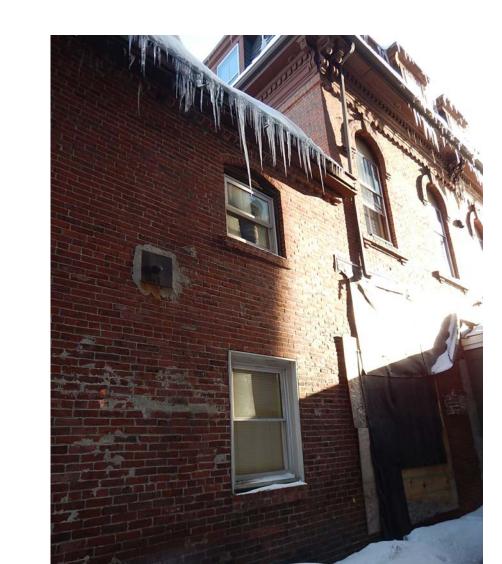

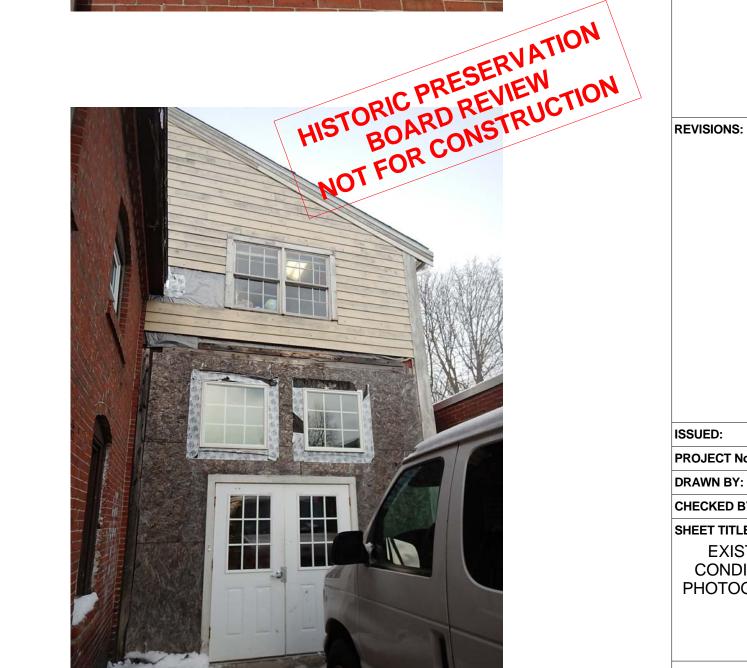

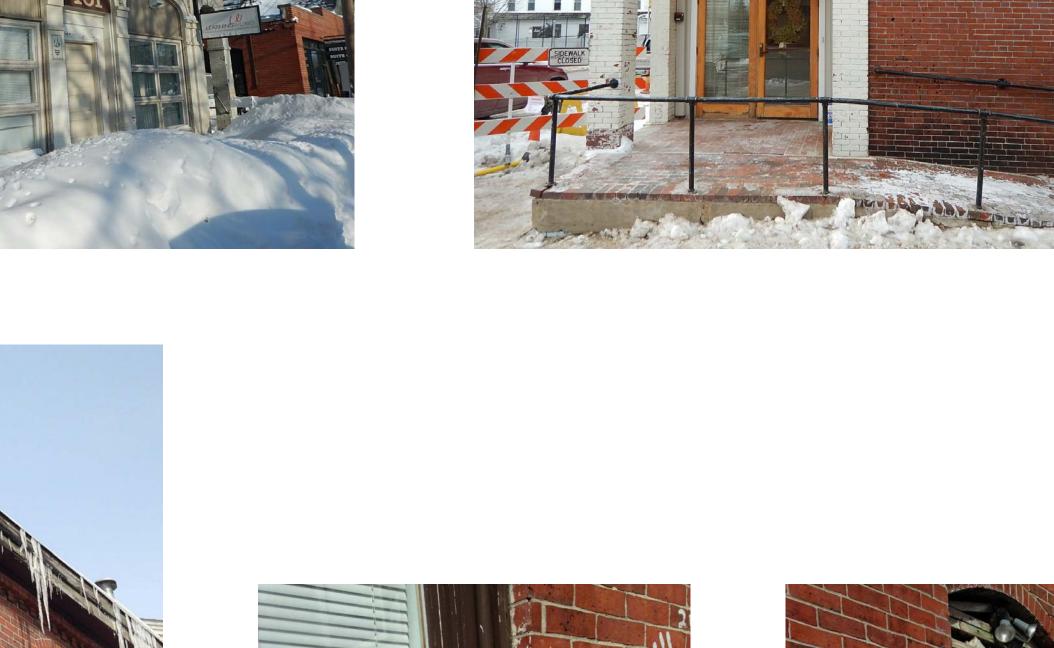





CONSULTANTS:

04/01/15 ISSUED: PROJECT No: DRAWN BY: CHECKED BY: SHEET TITLE: EXISTING CONDITIONS PHOTOGRAPHS

A601