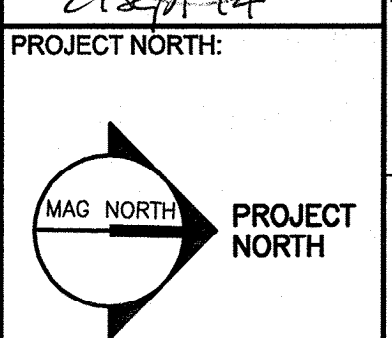
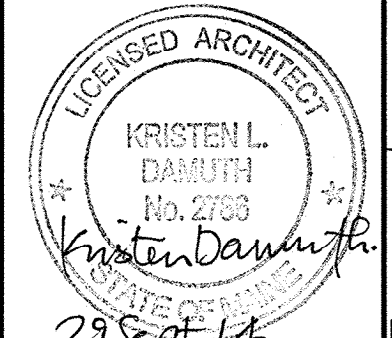


MERCY HOSPITAL STATE ST. - 3S PULMONARY RENOVATIONS PORTLAND, MAINE

144 Fore Street P.O. Box 618
Portland, Maine 04104
tel. (207) 772-3966
fax. (207) 772-1070
www.smrtinc.com

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**MERCY HOSPITAL
3S PULMONARY RENOVATIONS**
STATE STREET - PORTLAND, MAINE

**ISSUED FOR CONSTRUCTION
9-29-14**

CURRENT ISSUE STATUS:

REV	DATE	DESCRIPTION
0	9-29-14	ISSUED FOR CONSTRUCTION

GRAPHIC SCALE:
0" 1"


SCALE: 1/4"=1'-0"
PROJECT MANAGER: KD
JC/DRAWN BY: MDR /MDR
A/E OF RECORD: KD
PROJECT NO: 14087
SMRT FILE: G1001-14087
DATE: 9-29-14
SHEET TITLE:
COVER SHEET

SHEET No.
G1001

A/C	AIR CONDITIONING	N	NOSING
ACPLAS	ACOUSTICAL PLASTER	NIC	NOT IN CONTRACT
ACT	ACOUSTIC CEILING TILE	NS	NEAR SIDE
AFF	ABOVE FINISHED FLOOR	NTS	NOT TO SCALE
AP	ACCESS PANEL	OC	ON CENTER
BCE	BOTTOM CHORD EXTENSION	OF	OUTSIDE FACE
BD	BOARD	OH	OVERHEAD
BLP	BORROWED LIGHT PANEL	PA	PUBLIC ADDRESS
BO	BOTTOM OF	PAF	POWDER-ACTUATED FASTENER
BOF	BOTTOM OF FOOTING	PL	PLATE
BOS	BOTTOM OF STEEL	PLAM	PLASTIC LAMINATE
BS	BOTH SIDES	PLF	POUNDS PER LINEAR FOOT
BSE	BSBRICK SHELF ELEVATION	PP	POWER PANEL
C	CHANNEL	PSF	POUNDS PER SQUARE FOOT
CB	CATCH BASIN; CHALKBOARD	PSI	POUNDS PER SQUARE INCH
CFM	CUBIC FEET PER MINUTE	PT	PRESSURE-TREATED
CJ	CONTROL JOINT; CONSTRUCTION JOINT	PVC	POLYVINYL CHLORIDE
CLG	CEILING	PWP	PLASCORE WALL PANEL
CMU	CONCRETE MASONRY UNIT	R	RISER; RADIUS
CT	CERAMIC TILE	RB	RESILIENT BASE
CUH	CABINET UNIT HEATER	RD	ROOF DRAIN
DF	DRINKING FOUNTAIN	RO	ROUGH OPENING
DR	DISPLAY RAIL	RUB	RUB-RAIL
DW	DISHWASHER	ACT	SUSPENDED ACOUSTIC
EF	EXHAUST FAN; EACH FACE	TILE	TILE CEILING
EJ	EXPANSION JOINT	SBO	SUPPLIED BY OWNER
EPDM	ETHYLENE PROPYLENE DIENE MONOMER	IBC	INSTALLED BY CONTRACTOR
EW	ELECTRIC WATER COOLER	SC	SOLID CORE
EWC	ELECTRIC WATER COOLER	SCHD	SCHEDULE
FB	FLAT BAR	SF	SQUARE FOOT; SUPPLY FAN
FBD	FURNISHED BY OTHERS	SK	SHEAR KEY
FCO	FLOOR CLEAN-OUT	SN	SANITARY NAPKIN (DISPENSER)
FD	FLOOR DRAIN	SP	SPACES
FE	FIRE EXTINGUISHER	SS	STAINLESS STEEL
FF	FINISHED FLOOR; FAR FACE	T	TREAD
FO	FRAMED OPENING	TB	TACKBOARD
FS	FAR SIDE	T&B	TOP AND BOTTOM
GB	GRAB BAR	TBM	TEMPORARY BENCHMARK
GC	GENERAL CONTRACTOR	TCE	TOP CHORD EXTENSION
GDT	GYPSON DROP-IN TILE	TJ	TIE JOIST
GWB	GYPSON WALL BOARD	TO	TOP OF
H	HORIZONTAL	TOC	TOP OF CONCRETE
HC	HANDICAPPED; HOLLOW CORE	TOF	TOP OF FOOTING
HM	HOLLOW METAL	TOM	TOP OF MASONRY
HRU	HEAT RECOVERY UNIT	TOP	TOP OF PIER
HT	HEIGHT	TOS	TOP OF STEEL; TOP OF SLAB
H&V	HEATING AND VENTILATING	TOW	TOP OF WALL
HVAC	HEATING, VENTILATING AND AIR CONDITIONING	TP	TOILET PAPER (DISPENSER)
IF	INSIDE FACE	TS	UNIT HEATER
IJ	ISOLATION JOINT	UNO	UNLESS NOTED OTHERWISE
INV	INVERT	V	VENT PIPE; VERTICAL
JS	JOIST SUBSTITUTE	VB	VAPOR BARRIER
L	ANGLE	VCT	VINYL COMPOSITION TILE
LLH	LONG LEG HORIZONTAL	VP	VISION PANEL
LLV	LONG LEG VERTICAL	VTR	VENT THROUGH THE ROOF
LP	LIGHTING PANEL; LIQUIFIED PROPANE	W/	WITH
MB	MARKER BOARD	WC	WATER CLOSET
MDO	MEDIUM DENSITY OVERLAY	WF	WIDE FLANGE
MO	MASONRY OPENING	WH	WATER HEATER
MR	MOISTURE-RESISTANT	W/O	WITHOUT
MUA	MAKE-UP AIR	WP	WALL PROTECTION
		WS	WEB STIFFENER
		WSF	WELDED WIRE FABRIC

GRID LOCATION	TITLE
A1	BUILDING SECTION
A1	WALL SECTION
A1	DETAIL
◆	LEVEL LINE
△	REVISION
△	WINDOW TYPE
A50A0	DOOR NUMBER
LOBBY	ROOM NAME
A153	ROOM NUMBER
G14	INTERIOR ELEVATION
A200	INTERIOR ELEVATION
◆15	WALL TYPE
○S	BACKER ROD AND SEALANT
A1	EXTERIOR ELEVATION
A101	EXTERIOR ELEVATION


PROJECT LOCATION - 3RD FLOOR

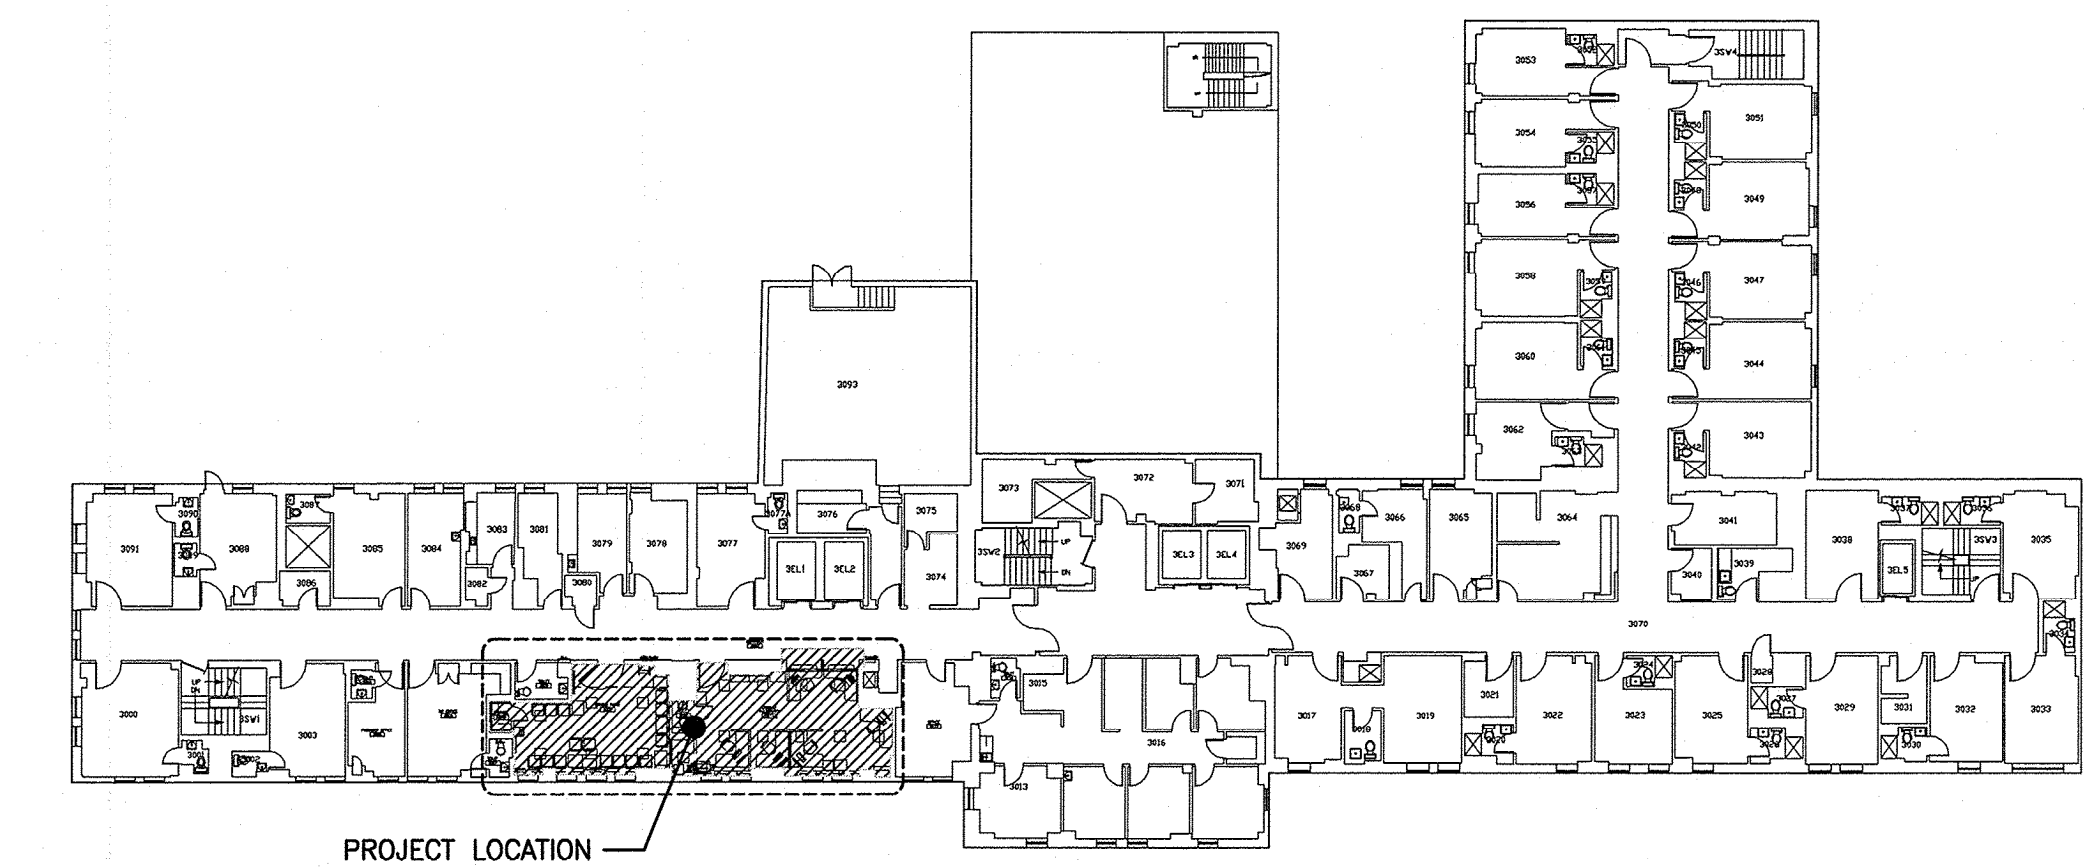

DRAWING LIST

- GENERAL**
- G1001 COVER SHEET
- ARCHITECTURAL**
- A-101 DEMOLITION PLAN AND FLOOR PLAN
 - A-102 RCP, INTERIOR ELEVATION AND DETAILS
- ELECTRICAL**
- E-001 LEGEND AND GENERAL NOTES
 - E-101 DEMOLITION AND LIGHTING PLANS
 - E-102 POWER AND SYSTEMS PLANS

PARTITION TYPES

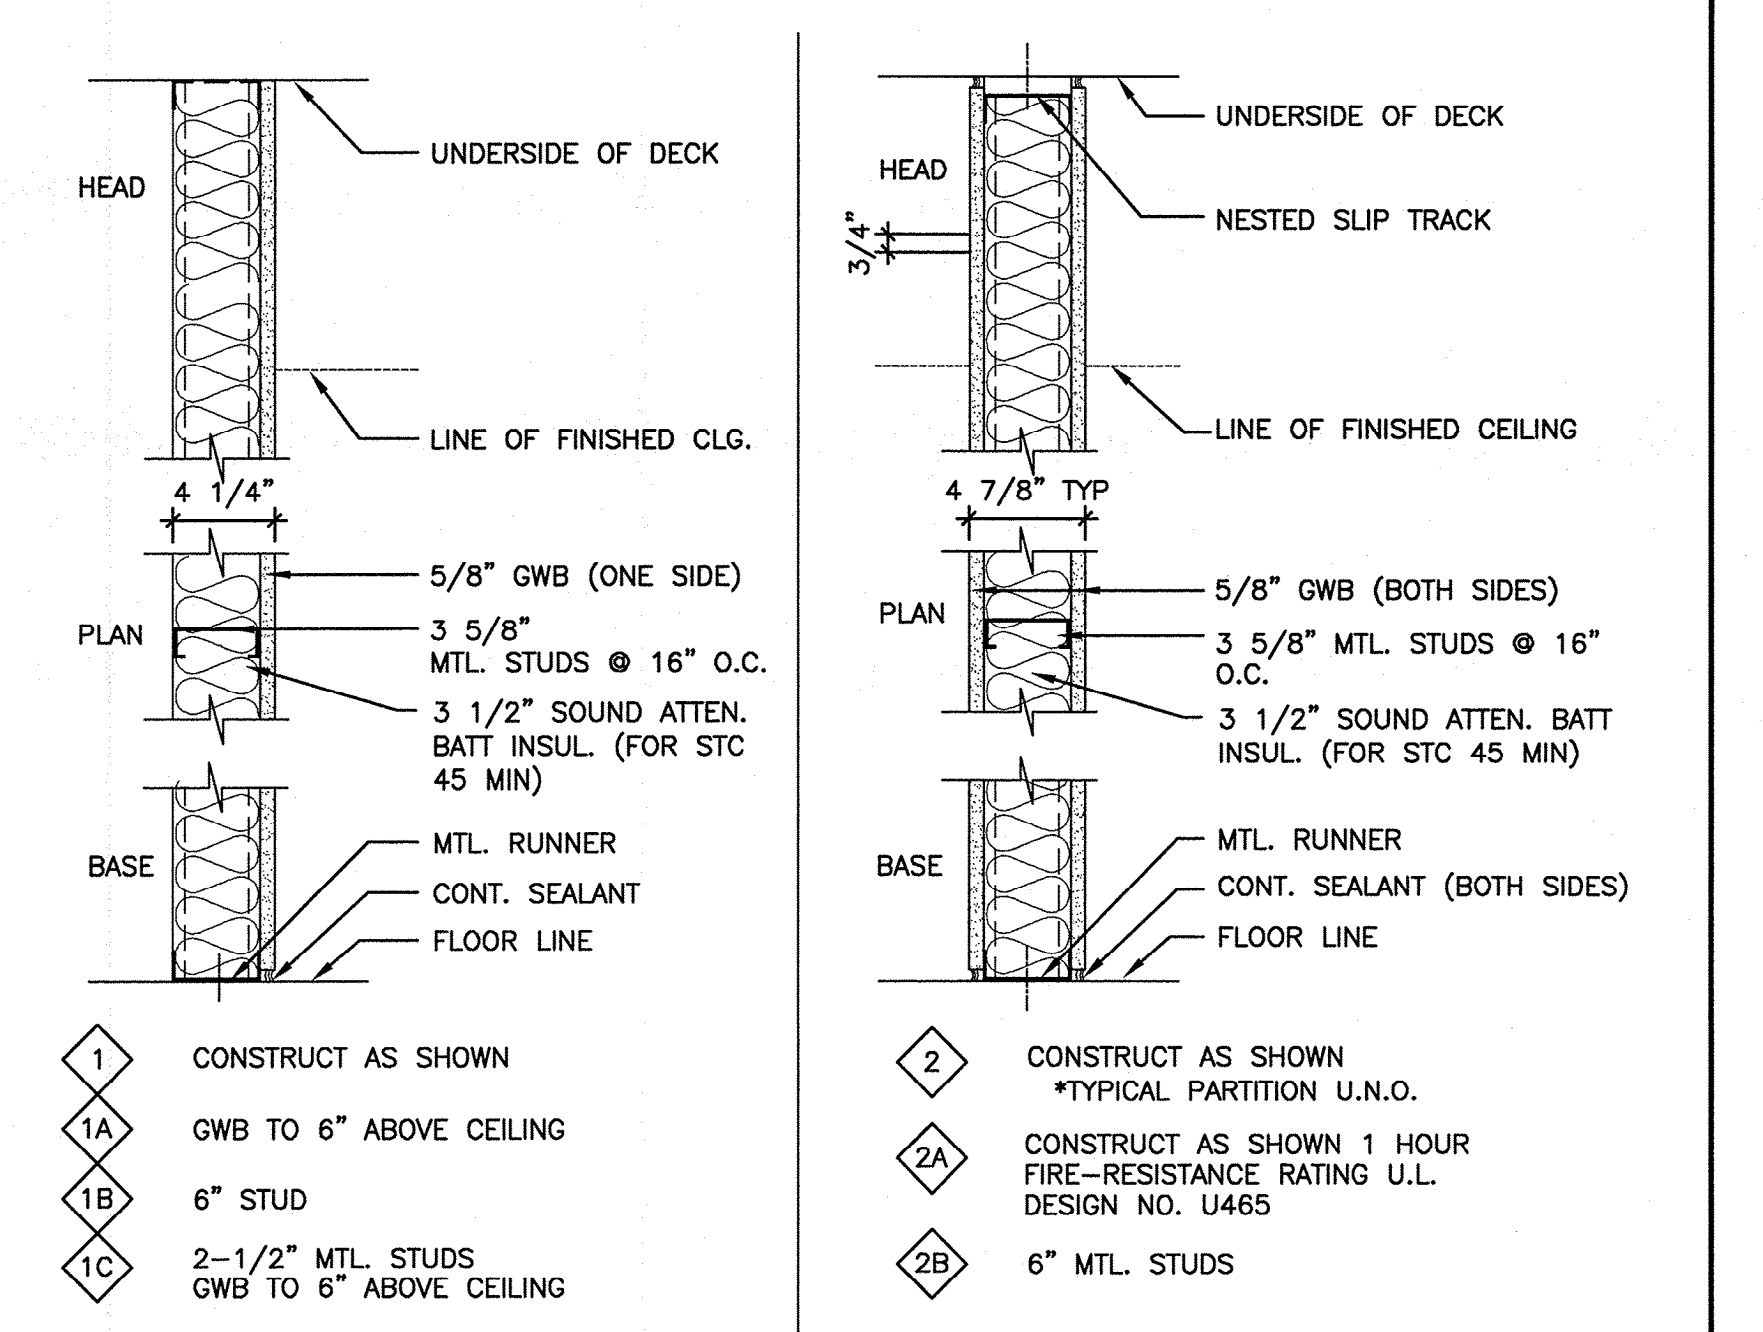

- ◆1 CONSTRUCT AS SHOWN
- ◆1A GWB TO 6" ABOVE CEILING
- ◆1B 6" STUD
- ◆1C 2-1/2" MTL STUDS GWB TO 6" ABOVE CEILING
- ◆2 CONSTRUCT AS SHOWN *TYPICAL PARTITION U.N.O.
- ◆2A CONSTRUCT AS SHOWN 1 HOUR FIRE-RESISTANCE RATING U.L. DESIGN NO. U465
- ◆2B 6" MTL STUDS
- ◆E EXISTING STUD WALL, PATCH AND REPAIR HOLES, CRACKS AND/OR ANY OTHER BLEMISH. PREPARE SUBSTRATE FOR SCHEDULED FINISH PER MANUFACTURERS WRITTEN RECOMMENDATIONS.