


1 DOOR TYPES
1/4" = 1'-0"

DOOR SCHEDULE																	
DOOR NO.	DOOR						FRAME				GENERAL						
	TYPE	SIZE			MATERIAL	FINISH	INSULATED	TYPE	MATERIAL	THRESHOLD	DETAILS			FIRE RATING (MINUTES)	REMARKS		
		WIDTH	HEIGHT	THICKNESS							HEAD	JAMB	SILL				
001.1	A	3'-0"	7'-0"	1-3/4"	STL	PTY	Y	2	STL	AL	-	-	-	Y	60	-	FIRE RATED STEEL DOOR, VERIFY DOOR HEIGHT IN FIELD WITH EXISTING CONDITIONS
003.1	A	3'-0"	7'-0"	1-3/4"	STL	PTD	Y	2	STL	AL	-	-	-	Y	60	-	FIRE RATED STEEL DOOR
100.1	B	VIF	8'-0"	1-3/4"	AL	PTD	Y	2	AL	AL	-	-	-	Y	-	-	3'-0" WIDE DOOR WITH EQUAL WIDTH SIDELIGHTS AND PANIC HARDWARE - EXACT DIMENSION OF SIDELIGHT TO BE DETERMINED IN FIELD
100.2	C	3'-0"	3'-7"	-	WD	PTD	-	-	WD	-	-	-	-	-	-	-	GATE TO BASEMENT STAIRS, CUSTOM GATE
102.1	E	3'-0"	7'-0"	1-3/4"	WD	PTD	-	1	WD	-	-	-	-	-	-	-	-
104.1	D	3'-0"	7'-0"	1-3/4"	WD	PTD	Y	1	WD	-	-	-	-	Y	-	-	-
110.1	A	3'-0"	7'-0"	1-3/4"	STL	PTD	Y	2	STL	AL	-	-	-	Y	60	-	FIRE RATED STEEL DOOR WITH PANIC HARDWARE
110.2	F	3'-0"	7'-0"	1-3/4"	STL	PTD	Y	1	STL	AL	-	-	-	Y	60	-	FIRE RATED DOOR INTO LOBBY WITH PANIC HARDWARE

- DOOR NOTES:
- 1.) ALL EXTERIOR GLAZING TO BE LOW-E ARGON FILLED INSULATED GLAZING UNITS
 - 2.) FRAME ALL OPENINGS WITH ELEVATIONS
 - 3.) SEAL EXTERIOR DOORS TO ROUGH OPENING WITH LOW EXPANDING FOAM INSULATION - SEE DETAILS
 - 4.) ALL DOOR HARDWARE TO BE 'LEVER' TYPE
 - 5.) ALL EXTERIOR DOORS TO BE WEATHERSTRIPPED

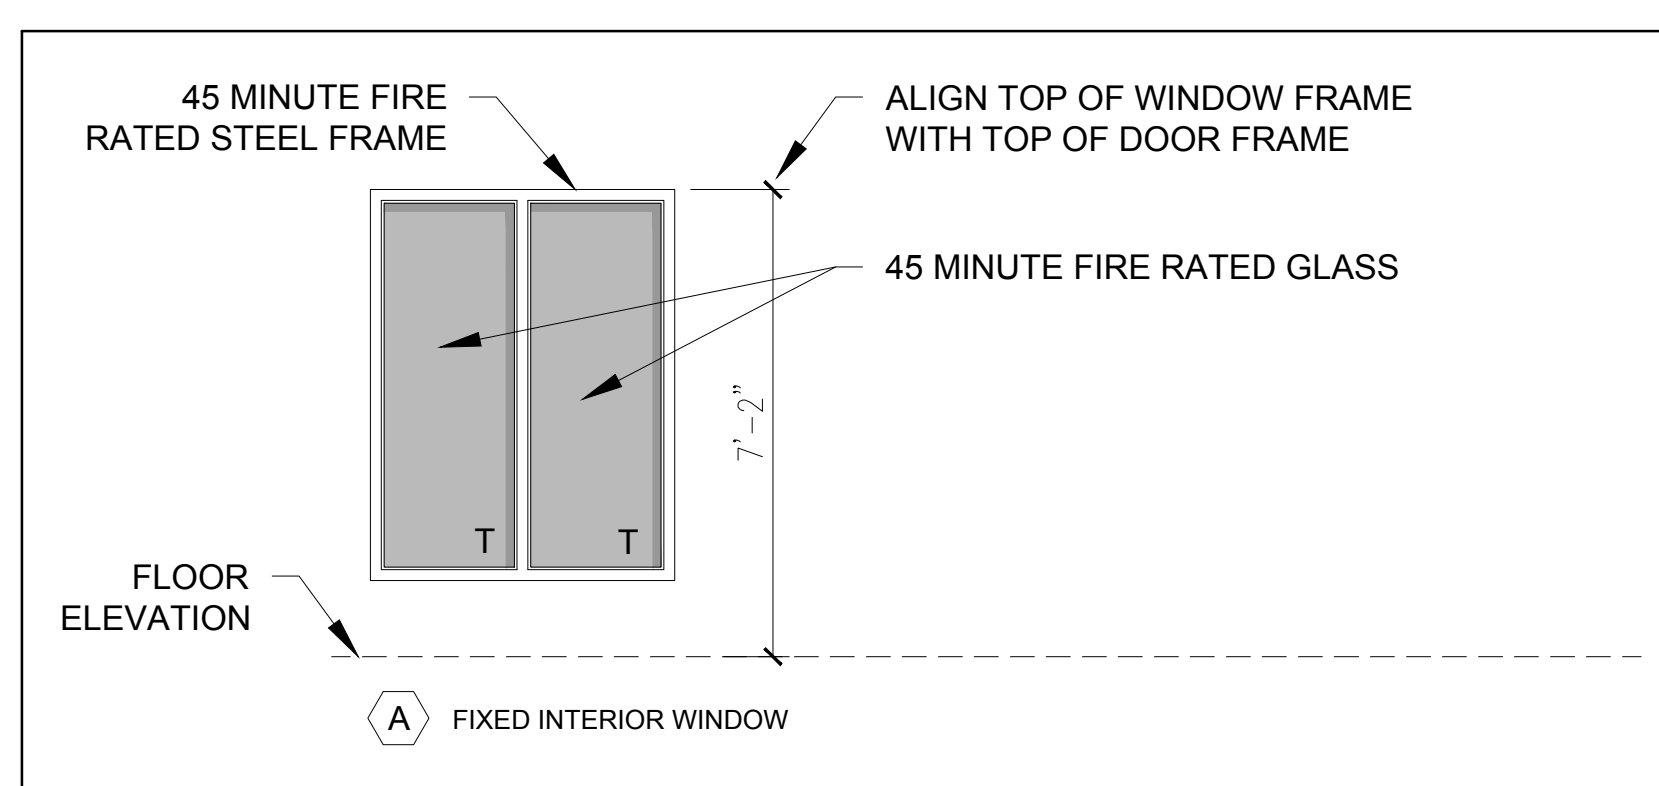


1 WINDOW TYPES
1/4" = 1'-0"

WINDOW SCHEDULE LEGEND	
T	= TEMPERED GLASS
FG	= FIBERGLASS
AL	= ALUMINUM
DH	= DOUBLE HUNG
AW	= AWNING
LV	= LOUVER
F	= FIXED
GL	= GLIDER
OC	= OPERABLE CASEMENT
O/F S	= OPERABLE / FIXED STOREFRONT

WINDOW SCHEDULE									
KEY	ACTION	ROUGH * OPENING (WxH) VIF	R.O. HEAD HEIGHT FROM SUB FLOOR	DETAILS			MATERIAL	FINISH	REMARKS
				HEAD	JAMB	SILL			
F	GL	4'-8" X 6'-0"	-	-	-	-	-	-	FOR TEMPERED GLASS LOCATIONS SEE WINDOW ELEVATION TYPES FOR MASONRY OPENING DIMENSIONS COORDINATE COURSING WITH EXTERIOR ELEVATION SHEETS AND PLAN AND SECTION DETAIL SHEETS
									INTERIOR TEMPERED WINDOW WITH 45 MINUTE FIRE RATED FRAME AND GLASS

- WINDOW NOTES:
- 1.) ALL GLAZING LOCATED WITHIN 18" OF FINISHED FLOOR TO BE TEMPERED GLASS

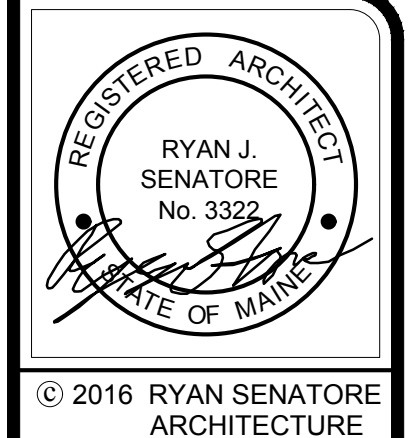

LAYFAYETTE BUILDING RENOVATION
 PARK STREET
 PORTLAND, MAINE



CONSULTANTS:

REVISIONS:

DATE: SEPTEMBER 29, 2016
 PROJECT No. 1621
 DRAWN BY: RJS, RRT
 CHECKED BY: RJS
 SCALE: AS NOTED

SHEET TITLE:
 DOOR AND WINDOW SCHEDULE

A7-0