

SITE NAME: LAFAYETTE SITE NO. 853419

SECTOR: 1

<u>SECTOR: 2</u>

LATITUDE: LONGITUDE: 43° 39' 11.32" (N)

70° 15' 56.11" (W)

43° 39' 11.54" (N)

70° 15′ 53.14″ (W)

SECTOR: 3

43° 39' 10.88" (N)

70° 15' 56.04" (W)

SITE NUMBER: 853419 SITE NAME: LAFAYETTE TOWER TYPE: ROOFTOP ANTENNA FRAME 638 CONGRESS STREET SITE ADDRESS: PORTLAND, ME 04101 PROPERTY OWNER: LAFAYETTE SQUARE LIMITED PART 707 SABLE OAKS DRIVE SOUTH PORTLAND, ME 04106 MAP/BLOCK/LOT: 45/A/03 APPLICANT: U.S. CELLULAR c/o KJK WIRELESS 127 RIDGE ROAD NASHUA, NH 03062

PROJECT SUMMARY

VICINITY MAP	SCALE: NTS
West End West St The Pine St To St	Ta, Co. River
SITE	Sy Contant Plan
Sherman Ave Of Crescent St Cumberland Ave Of Congress St	Salina St. Care St. Charles
Bod Avo Blue Star Memorial Hwy	And Charles Ch
Deering	NORTH

SHEET NO.	DESCRIPTION	DATE	REV. NO.
T-1	TITLE SHEET	2/3/06	0
C-1	PLOT PLAN	2/3/06	0
C-2	SITE PLAN	2/3/06	0
A-1	FLOOR PLAN	2/3/06	0
E-1	ELEVATIONS PLAN	2/3/06	0
S-1	SECTIONS, DETAILS AND GENERAL NOTES	2/3/06	0
SHEET	INDEX		

BUILDING REQUIREMENTS:
BUILDING IS UNMANNED AND NOT FOR HUMAN
HABITATION. HANDICAPPED ACCESS REQUIREMENTS
NOT REQUIRED.

PLUMBING REQUIREMENTS:
FACILITY HAS NO PLUMBING.



THIS DRAWING WAS CREATED FOR A FULL SIZE OF 22"x34". IT HAS BEEN REDUCED 50% FOR SUBMISSION PURPOSES.

The way people talk around here. 288 Route 101, 2nd Floor, Bedford, NH 03110

OEST Associates, Inc.	343 Gorham Road - South Portland, ME 04106 engineers - architects - surveyors - construction managers	TEL: (207) 761–1770 FAX: (207) 774–1246	OEST PROJ. NO: 413.49.01
LAFAYETTE	SITE NUMBER: 853419	ADDRESS: 638 CONGRESS STREET PORTLAND, ME 04101	Drawing Title: TITLE SHEET
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0 F	OR CONS	STRUCTIO	N 2/3/06

2/3/06

SCALE: AS NOTEI


413.49.01

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AWING NO.



LIST OF	ABUTTERS				
CITY OF PORTLAND					
MAP/BLOCK/LOT	RECORD OWNER	ADDRESS			
39/A/1	PARK WONBAE & IP BOON JTS	626 CONGRESS STREET PORTLAND, ME 04101			
39/A/6 45/A/2 46/D/18 46/D/21	GEOFFREY RICE TRUSTEE	658 CONGRESS STREET 1ST FLOOR PORTLAND, ME 04101			
39/A/11	STONE COAST PROPERTIES, LLC	P.O. BOX 4152 PORTLAND, ME 04101			
45/A/1	THOMAS J. BURNS	60 WHITEHEAD AVE HULL, MA 02045			
45/A/6	CITY OF PORTLAND	389 CONGRESS STREET PORTLAND, ME 04101			
45/A/23	ST LUKES PARISH-RECTOR-WARDENS & VESTRYMEN	149 STATE STREET PORTLAND, 04101			
45/A/25	ST LUKES PARISH-RECTOR-WARDENS & VESTRYMEN	P.O. BOX 4141 PORTLAND, ME 04101			
45/A/26	STATE STREET CONGREGATIONAL CHURCH C/O JR MC FARLANE	159 STATE STREET PORTLAND ME 04101			
45/D/22	UNIVERSITY OF MAINE SYSTEM	107 MAINE AVE BANGOR, ME 04401			
46/D/26	PAGE H. & PATRICIA G. BURNHAM	P.O. BOX 2282 SCARBOROUGH, ME 04070			

DESCRIPTION OF LEASE AREA

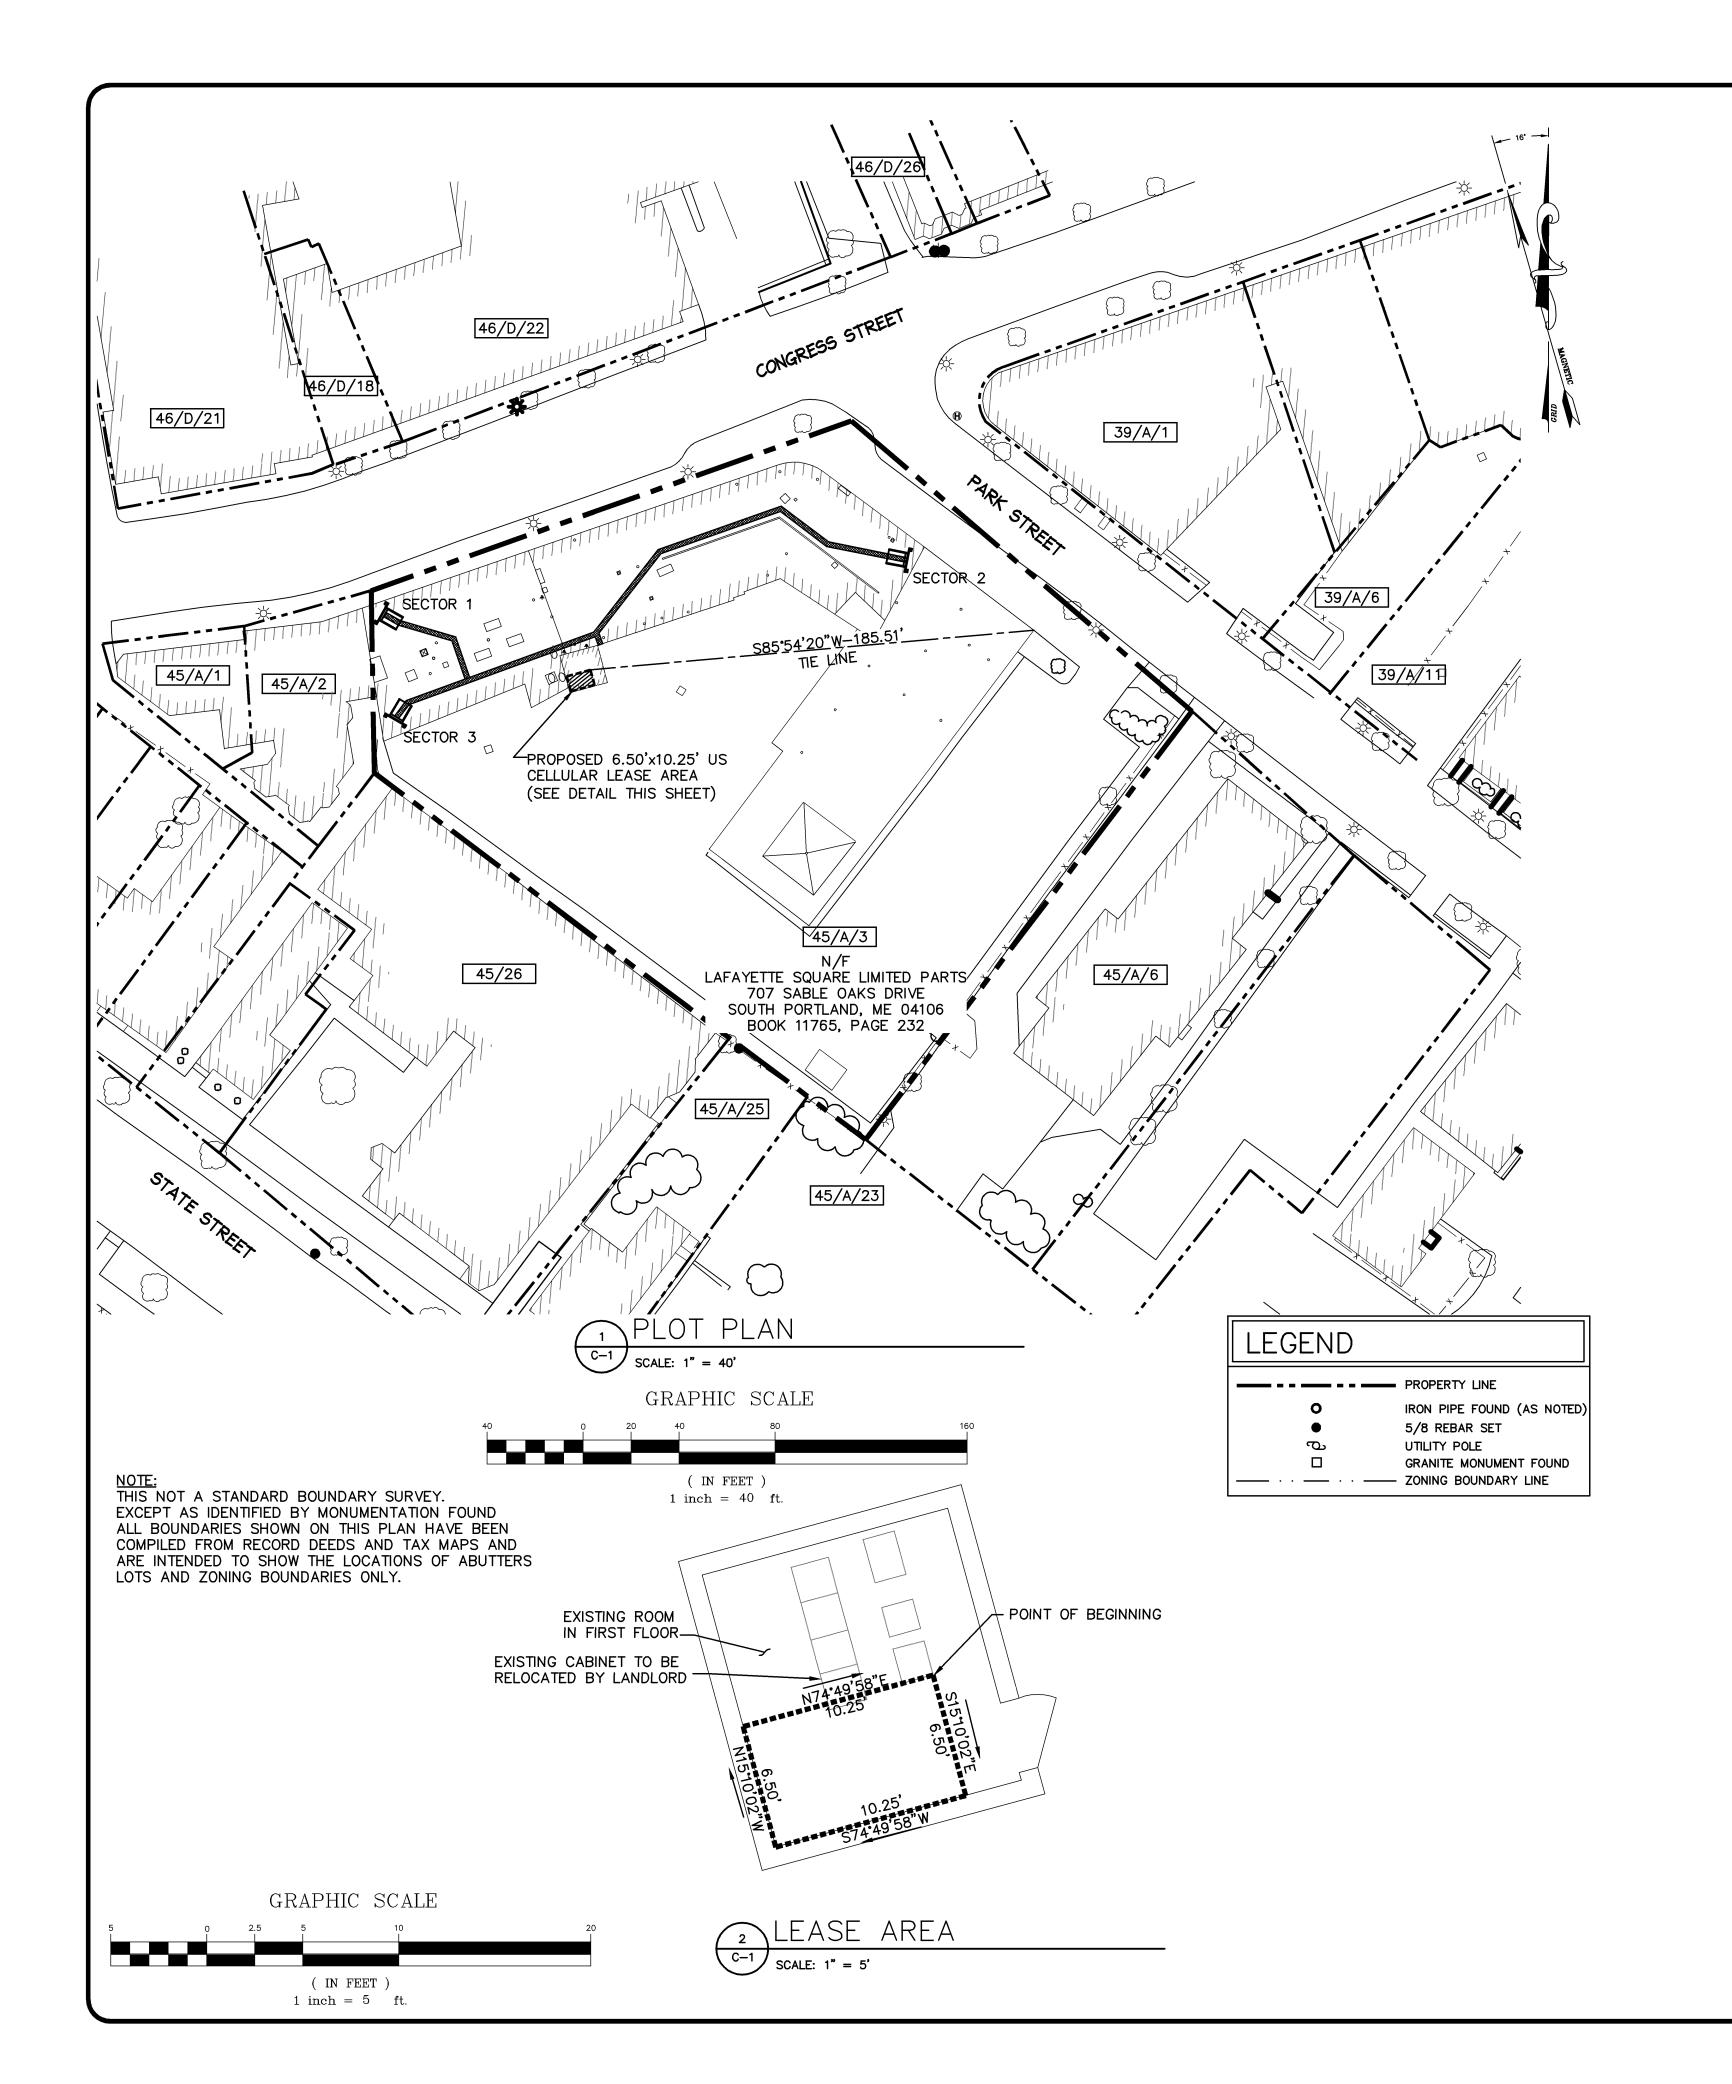LEGAL DESCRIPTION - LEASE PARCEL

A CERTAIN PARCEL OF LAND LOCATED SOUTHERLY OF CONGRESS STREET ALSO BEING SOUTHWESTERLY OF PARK STREET, IN THE CITY OF PORTLAND, CUMBERLAND COUNTY, MAINE, AND LYING WITHIN LAND OF THE GRANTOR(S), AS DESCRIBED IN BOOK 11765, PAGE 232, BOUNDED AND DESCRIBED AS FOLLOWS:

BEGINNING AT A POINT MARKING THE MOST NORTHERLY CORNER OF THE FOLLOWING DESCRIBED LEASE, LOCATED S84°01'30"W, 184.27 FEET FROM THE MOST EASTERLY CORNER THE EXISTING LAFAYETTE APARTMENTS;

THENCE, S15"10'02"E, 6.50 FEET TO A CORNER OF A CONCRETE PAD;

THENCE, S74'49'58"W, 10.25 FEET TO A CORNER OF A CONCRETE PAD;

THENCE, N1510'02"W, 6.50 FEET TO A CORNER OF A CONCRETE PAD;

THENCE, N74°49'58"E, 10.25 FEET TO THE POINT OF BEGINNING.


THE ABOVE DESCRIBED PARCEL CONTAINS 66.63± SQUARE FEET.

BEARINGS ARE BASED ON MAINE STATE GRID COORDINATE SYSTEM,

ZONING INFORMATION

WEST ZONE, (NAD 83).

ZONING DISTRICT:	DOWNTOWN BUSINESS (B3)	
MINIMUM STREET FRONTAGE:	15 FEET	
FRONT YARD SETBACK:	NONE	
SIDE YARD SETBACK:	NONE	
REAR YARD SETBACK:	NONE	
MINIMUM LOT SIZE:	NONE	

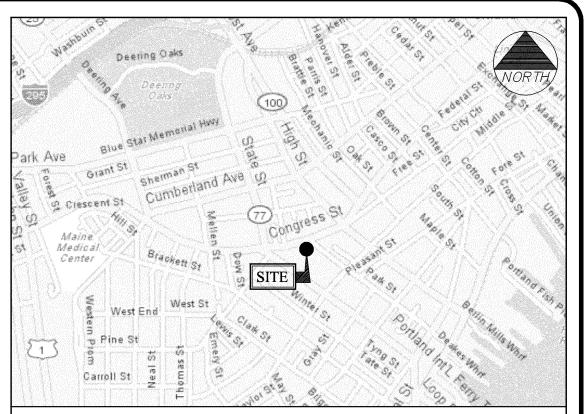

VICINITY MAP

SCALE: NTS

GENERAL NOTES

1. DATES OF FIELD SURVEY: JANUARY 2006

2. SITE NAME:

4. SITE ADDRESS:

3. SITE NUMBER: 853419

638 CONGRESS STREET PORTLAND, ME 04101

CUMBERLAND COUNTY

5. OWNER: LAFAYETTE SQUARE LIMITED PART 707 SABLE OAKS DRIVE

LAFAYETTE

SOUTH PORTLAND, ME 04106 CUMBDERLAND COUNTY

6. APPLICANT: U.S. CELLULAR c/o KJK WIRELESS 127 RIDGE ROAD

NASHUA, NH 03062

7. JURISDICTION: PORTLAND, MAINE

8. ZONING DISTRICT: DOWNTOWN BUSINESS (B3)

9. TAX IDENTIFICATION: MAP 45 BLOCK A LOT 03 DEED BOOK/PAGE: 11765/232

10. VERTICAL DATUM: NATIONAL GEODETIC VERTICAL DATUM

(NAD83)

OF 1929, (MEAN SEA LEVEL).

11. HORIZONTAL DATUM: NORTH AMERICAN DATUM OF 1983

12. <u>SECTOR: 1 (ALPHA)</u> LATITUDE: 43° 39[°] 11.32[°] N (NAD 83)

LATITUDE: 43° 39 11.32 N (NAD 83) LONGITUDE: 70° 15' 56.11" W (NAD 83)

<u>SECTOR: 2 (BETA)</u> LATITUDE: 43° 39' 11.54" N LONGITUDE: 70° 15' 53.14" W

<u>SECTOR: 3 (GAMMA)</u> LATITUDE: 43° 39' 10.88" N LONGITUDE: 70° 15' 56.04" W

GROUND EL. = $117.0^{\circ}\pm$

13. BEARINGS ARE BASED ON MAINE STATE GRID COORDINATE SYSTEM, WEST ZONE, (NAD83).

14. ALL UNDERGROUND UTILITY INFORMATION PRESENTED HEREON WAS DETERMINED FROM SURFACE EVIDENCE AND PLANS OF RECORD. ALL UNDERGROUND UTILITIES SHOULD BE LOCATED IN THE FIELD PRIOR TO COMMENCEMENT OF ALL SITE WORK. CALL DIGSAFE 1(888) 344 -7233 A MINIMUM OF 72 HOURS PRIOR TO PLANNED ACTIVITY.

15. PROPERTY IS LOCATED IN FLOOD ZONE "C" AS SHOWN ON FLOOD INSURANCE RATE MAP IN THE CITY OF PORTLAND MAINE, CUMBERLAND COUNTY PANEL 13 OF 17, COMMUNITY PANEL NUMBER 230051-0013-B EFFECTIVE DATE JULY 17, 1986. ZONE X IS DEFINED AS AREAS OF MINIMAL FLOODING

FAA CERTIFICATION - 2C

I HEREBY CERTIFY THAT THE LATITUDE, LONGITUDE, AND ELEVATIONS PRESENTED HEREON MEETS THE REQUIREMENTS OF THE FAA WITH THE FOLLOWING ACCURACIES:

+/- TWENTY (20) FEET VERTICALLY +/- FIFTY (50) FEET HORIZONTALLY

JEROME B. WATTS LICENSED LAND SURVEYOR #1245

DATE

THIS DRAWING WAS CREATED FOR A FULL SIZE OF 22"x34". IT HAS BEEN REDUCED 50% FOR SUBMISSION PURPOSES.

EQUIPMENT INSTALLATION SHALL MEET ALL LOCAL, STATE AND FEDERAL REQUIREMENTS FOR EQUIPMENT EMISSIONS.

TEL: (207) 774-1246

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STED TO THE STANDARD STRUCTION PARTS TO THE STANDARD STRUCTION PARTS TO THE STANDARD STRUCTION 2/3/06

DESIGNED BY:
MSD

DRAWN BY:
CBM

CHECKED BY:
MSD

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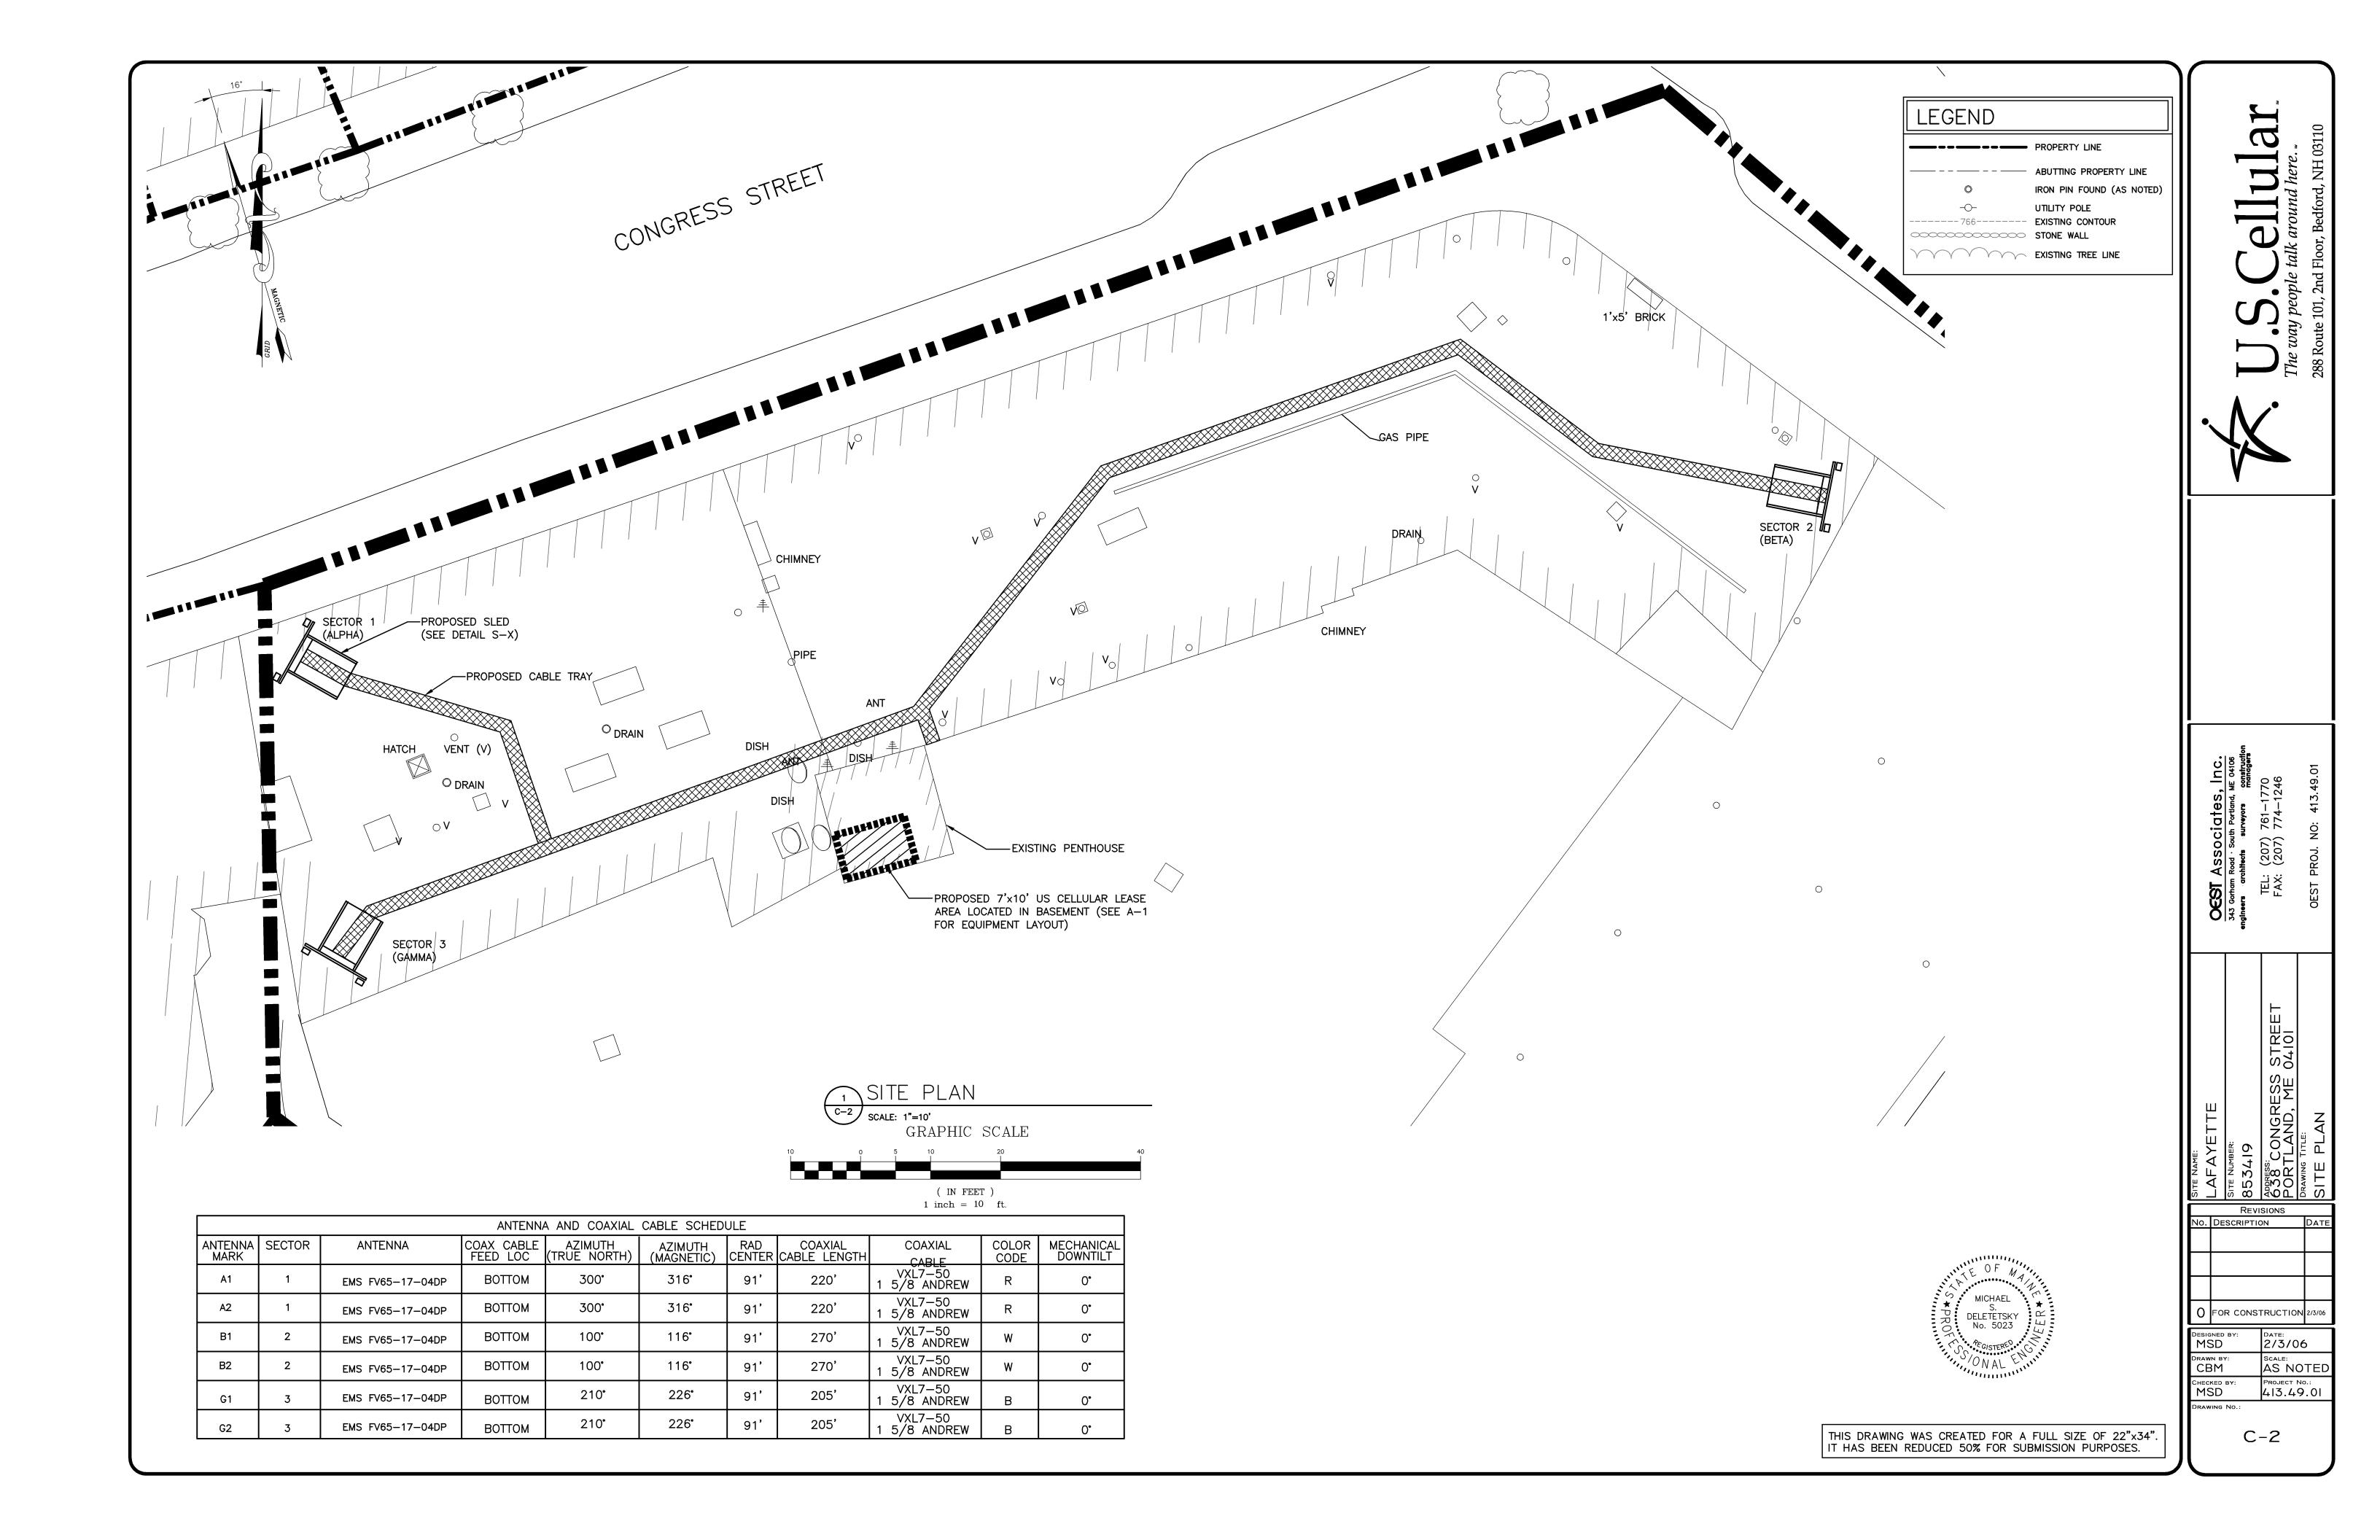
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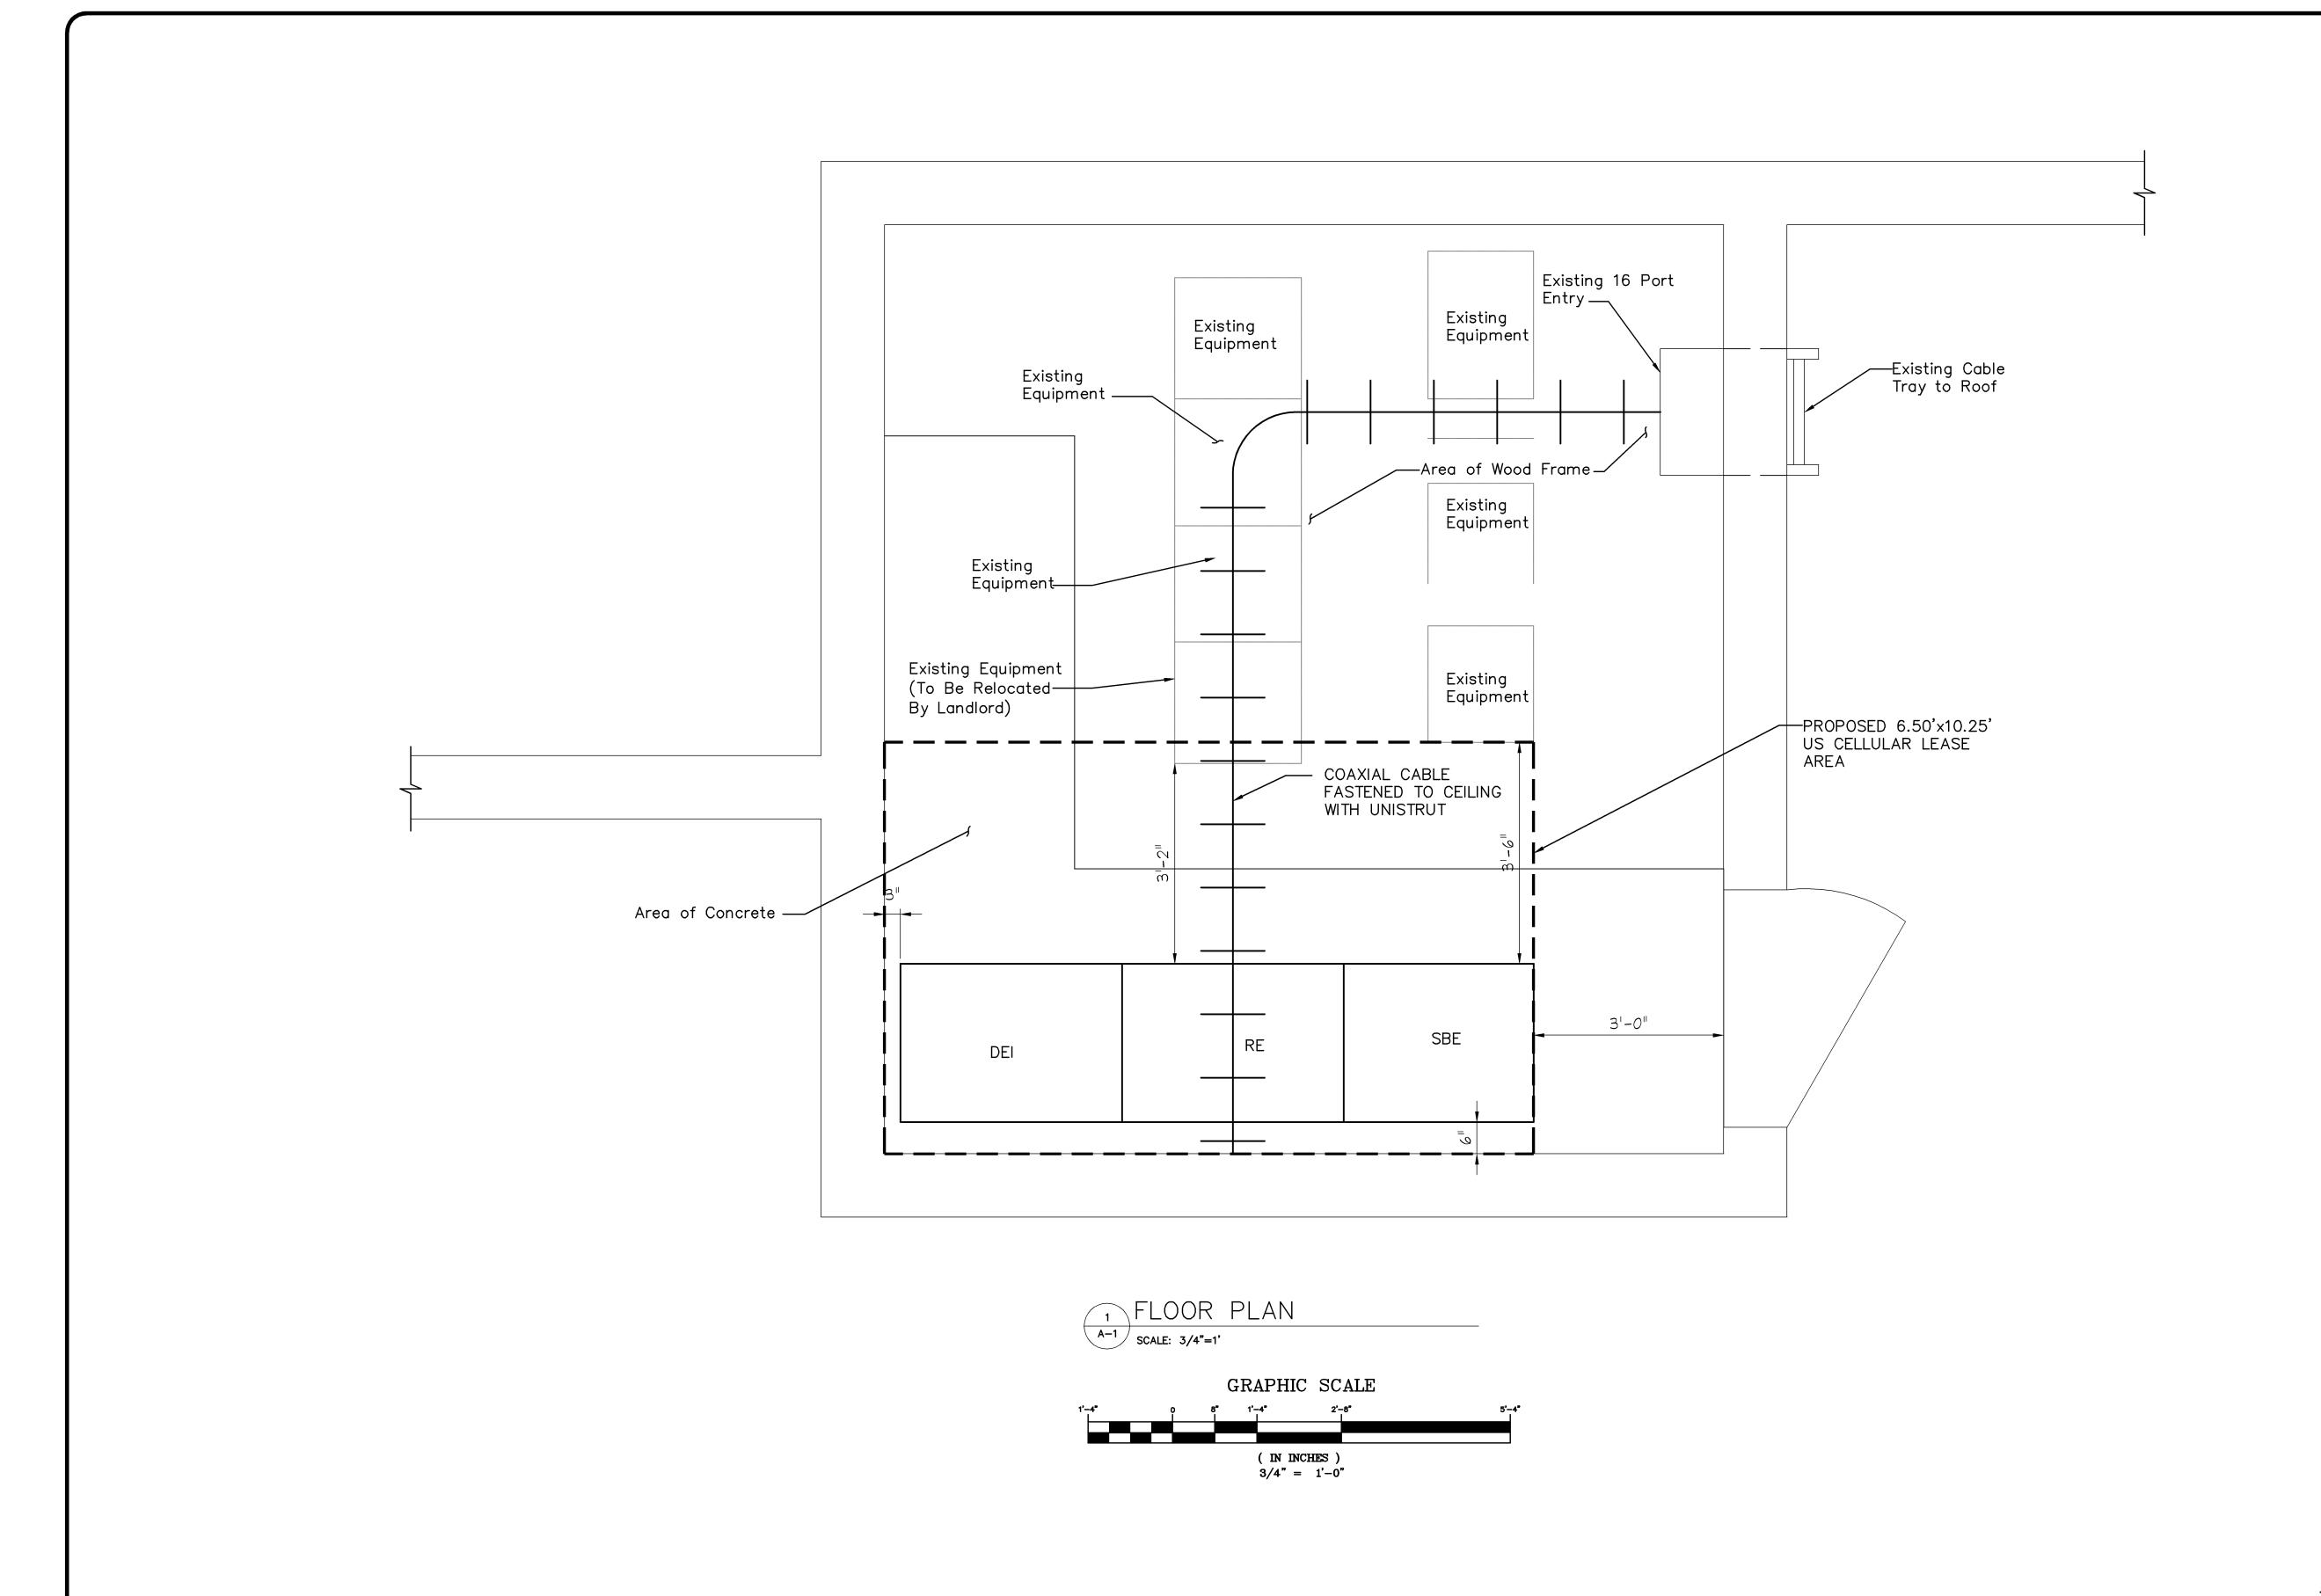
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AS NOTED


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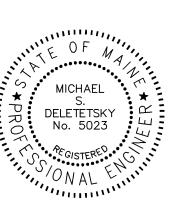
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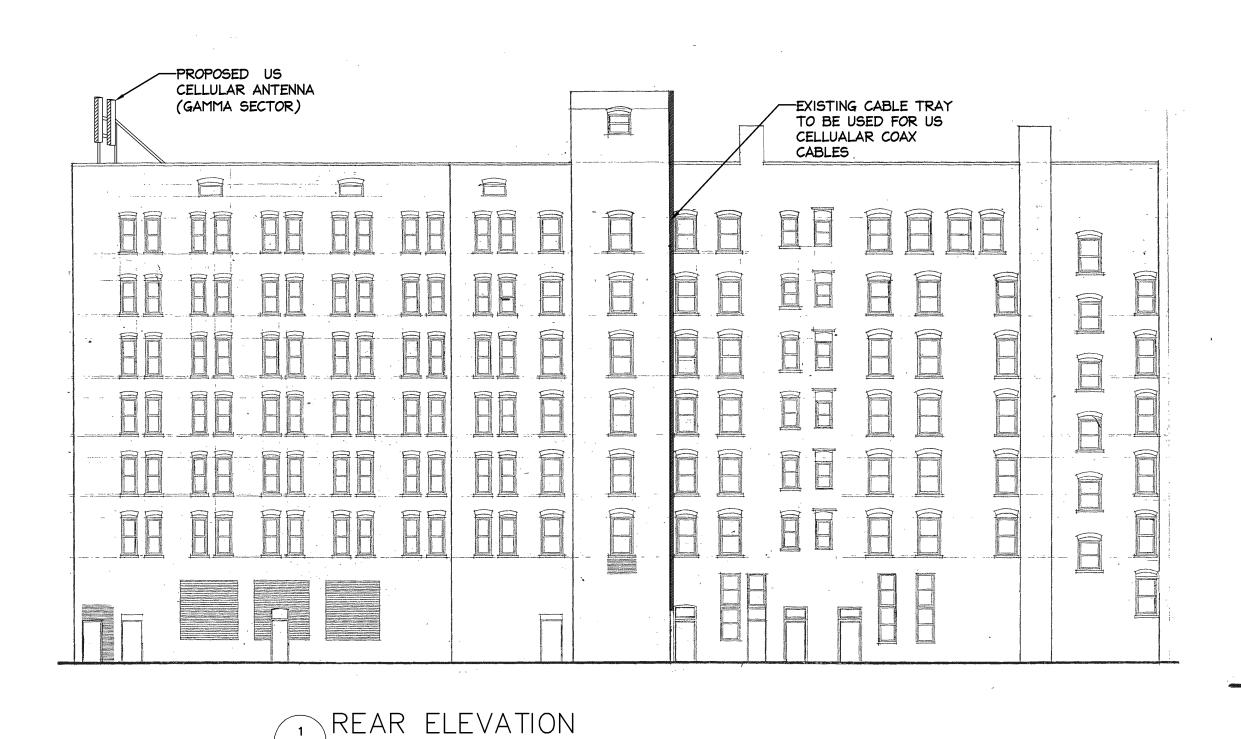
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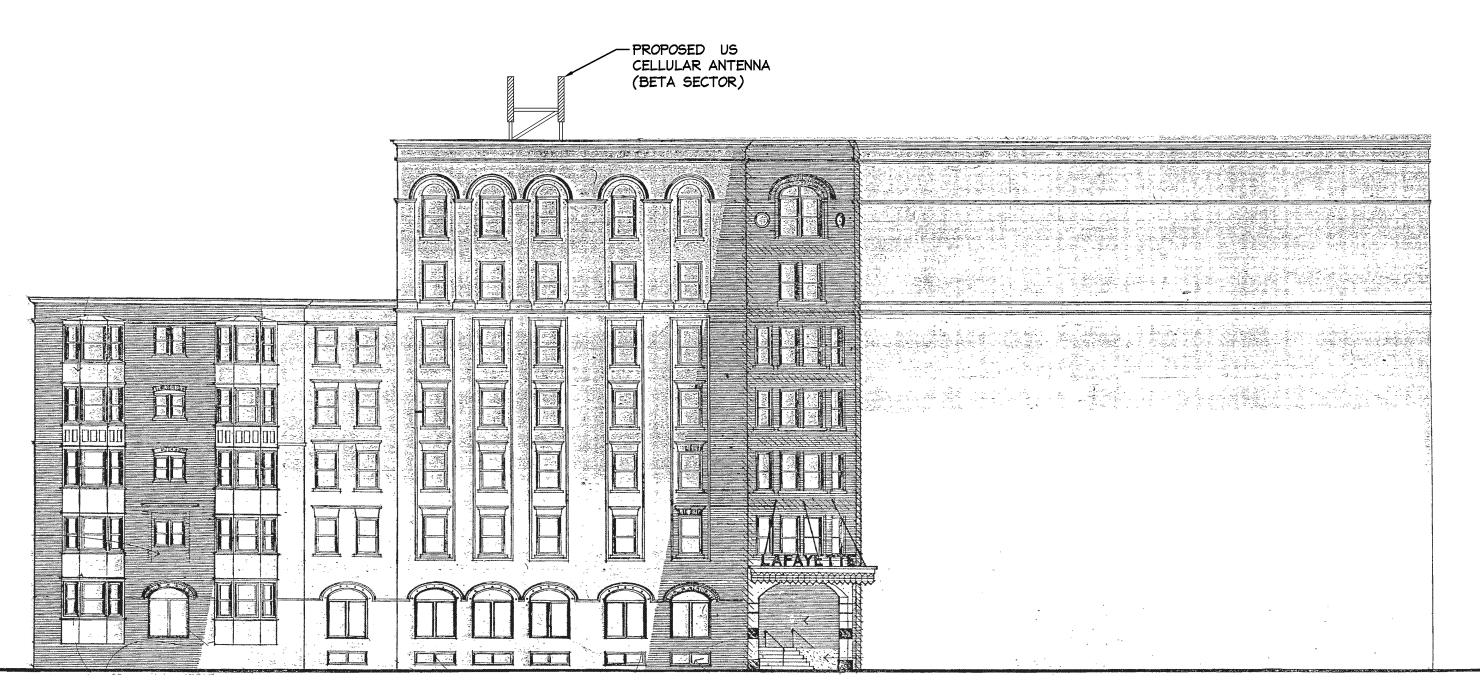









E-1 SCALE: 3/32*=1'

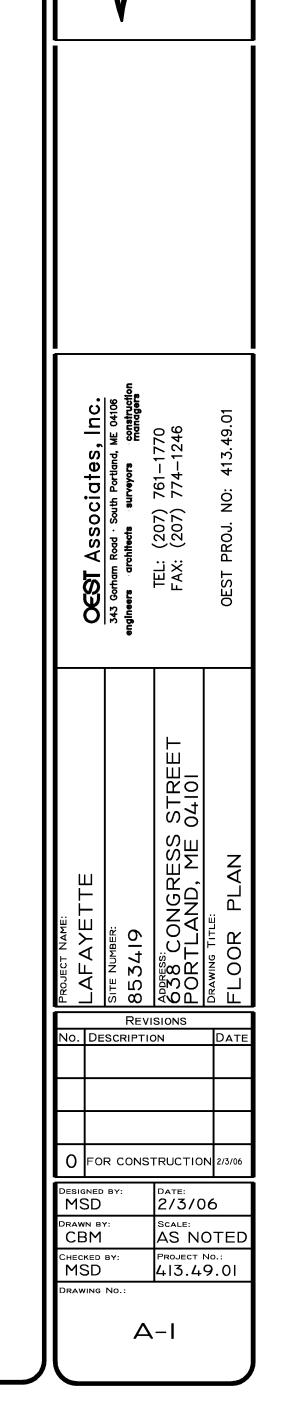

PARK STREET ELEVATION

SCALE: 3/32"=1"

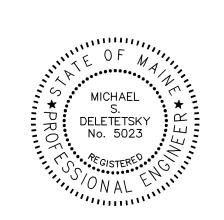

CONGRESS STREET ELEVATION

SCALE: 3/32"=1'

The way people talk ard 288 Route 101, 2nd Floor, Be

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OCST Associates, Inc.

343 Gorham Road · South Portland, ME 04106

engineers architects surveyors construction

TEL: (207) 761-1770

FAX: (207) 774-1246

SITE NUMBER:
853419
ADDRESS:
638 CONGRESS STREET
PORTLAND, ME 04101
DRAWING TITLE:
ELEVATION PLAN

O FOR CONSTRUCTION 2/3/06


DESIGNED BY: DATE: 2/3/06


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No. DESCRIPTION

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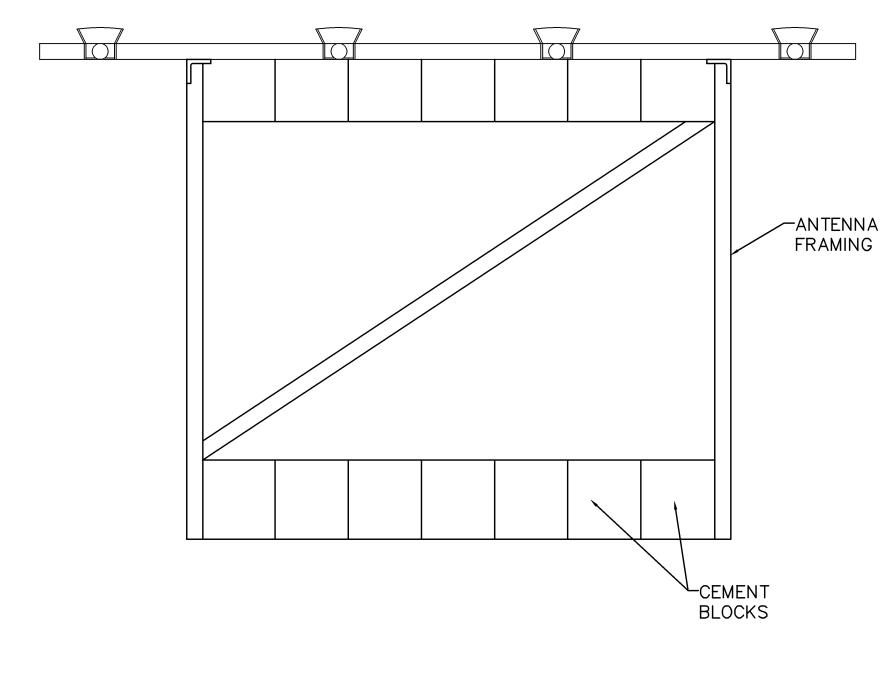
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COAX CABLE TRAY ROOFTOP SLEEPER S-1 SCALE: N.T.S.

ANTENNA MOUNTING RACK ELEVATION S-1 SCALE: N.T.S.

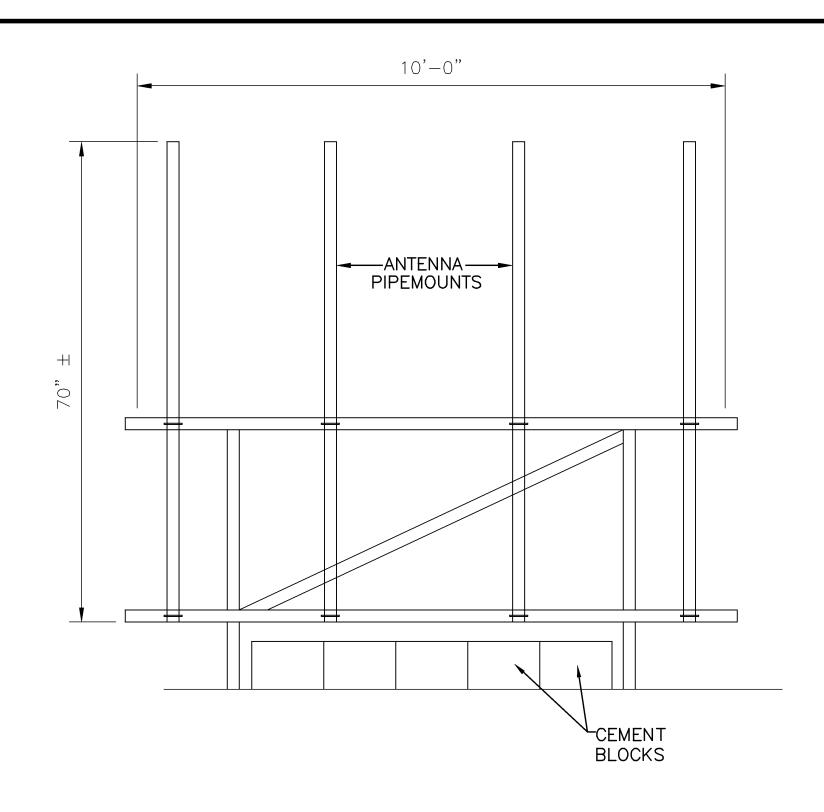

ANTENNA FRAME PLAN S-1 SCALE: N.T.S.

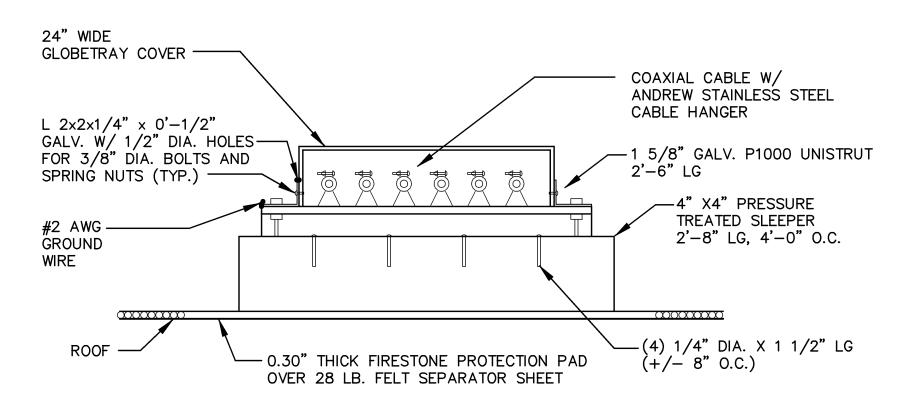GENERAL

- 1 COORDINATE THE STRUCTURAL WORK WITH THE ARCHITECTURAL, CIVIL, MECHANICAL, ELECTRICAL AND PIPING
- 2 VERIFY ALL DIMENSIONS IN THE FIELD. DURING ERECTION AND CONSTRUCTION PHASES, PROVIDE ADEQUATE SHORING AND TEMPORARY BRACING OF ALL STRUCTURAL COMPONENTS AND ASSEMBLAGES. NOTIFY OEST OF ALL FIELD CHANGES OR DIMENSION DISCREPANCIES PRIOR TO FABRICATION OR ERECTION.

CODES

- 1 ALL DESIGN AND CONSTRUCTION SHALL CONFORM TO THE REQUIREMENTS OF THE IBC 2000.
- 2 ADDITIONAL REFERENCED STANDARDS:
- A. AMERICAN INSTITUTE OF STEEL CONSTRUCTION (AISC) MANUAL OF STEEL CONSTRUCTION — ALLOWABLE STRESS DESIGN 1989, 9TH EDITION
- B. METAL BUILDING MANUFACTURES ASSOCIATION (MBMA) 1986 LOW RISE BUILDING SYSTEMS MANUAL
- C. AMERICAN CONCRETE INSTITUTE ACI 318-95 BUILDING CODE REQUIREMENTS FOR REINFORCED CONCRETE
- D. AMERICAN IRON AND STEEL INSTITUTE (AISI) SPECIFICATION FOR THE DESIGN OF COLD-FORMED
- STEEL STRUCTURAL MEMBERS E. AMERICAN SOCIETY OF CIVIL ENGINEERS ASCE 7-98 MINIMUM DESIGN LOADS FOR BUILDINGS AND OTHER STRUCTURES
- 3 ALL APPLICABLE FEDERAL DEPARTMENT OF LABOR OCCUPATIONAL SAFETY AND HEALTH ACT (OSHA) AND THE AMERICANS WITH DISABILITIES ACT (ADA).

COAXIAL-CABLE TRAY NOTES

- 1. ALL BRIDGE KITS SHALL BE INSTALLED AS PER THE MANUFACTURERS RECOMMENDATIONS.
- 2. STRUCTURAL STEEL SHALL BE ASTM A36. PIPE SHALL BE ASTM A53, GRADE B (SEAMLESS)
- 3. EXTERIOR STEEL SHALL BE HOT-DIP GALVANIZED, AFTER FABRICATION AND WELDING, TO ASTM A123. HARDWARE SHALL BE EITHER A325 STEEL, GALVANIZED TO ASTM A153, OR 18-8 STAINLESS.
- 4. SIZE, NUMBER AND POSITION OF COAXIAL CABLES MAY VARY.

STRUCTURAL AND MISCELLANEOUS STEEL

- 1 STRUCTURAL STEEL DESIGN, FABRICATION AND ERECTION SHALL BE IN ACCORDANCE WITH AISC - SPECIFICATION FOR STRUCTURAL STEEL BUILDINGS - ALLOWABLE STRESS DESIGN, JUNE 1, 1989 (9TH EDITION).
- 2 HIGH STRENGTH BOLTS SHALL BE IN ACCORDANCE WITH AISC -SPECIFICATION FOR STRUCTURAL JOINTS USING ASTM A325 OR 490 BOLTS, NOVEMBER 13, 1985.
- 3 WELDING SHALL BE IN ACCORDANCE WITH AWS D1.1 USE AWS PREQUALIFIED JOINT DETAILS.
- 4 STRUCTURAL STEEL MATERIALS SHALL CONFORM TO THE FOLLOWING:
- A. CONNECTION MATERIAL, EMBEDDED ITEMS, HOT ROLLED
- STRUCTURAL SHAPES, BASE PLATES AND MIS. STEEL. ASTM A36 B. STRUCTURAL TUBES ASTM A500 GRADE B
- C. STEEL PIPE ASTM A53, GRADE B
- D. STRUCTURAL BOLTS ASTM A325-W U.N.O. E. ANCHOR BOLTS ASTM A307 OR ASTM A36
- F. THREADED RODS ASTM A36 OR ASTM A307 G. WELDING ELECTRODES E70XX

GROUNDING NOTES:

- 1. ALL DETAILS ARE SHOWN DIAGRAMATICALLY. ACTUAL GROUNDING INSTALLATION AND CONSTRUCTION MAY VARY DUE TO SITE SPECIFIC
- 2. ALL GROUND WIRE SHALL BE BARE TINNED COPPER #2 AWG UNLESS OTHERWISE NOTED.
- 3. ALL GROUND WIRES SHALL PROVIDE A STRAIGHT, DOWNWARD PATH TO GROUND WITH GRADUAL BENDS AS REQUIRED. GROUND WIRES SHALL NOT BE LOOPED OR SHARPLY BENT.
- 4. ELECTRICAL CONTRACTOR SHALL COORDINATE CONNECTIONS TO EXISTING GROUND RINGS WITH SITE CONSTRUCTION MANAGER.
- 5. ANTENNA GROUND KITS SHALL BE FURNISHED BY US CELLULAR AND
- INSTALLED BY CONTRACTOR.
- GROUND SYSTEM SHALL BE TESTED AND SHALL HAVE A RESISTANCE OF 5 OHMS OR LESS.

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O. DESCRIPTION O FOR CONSTRUCTION 2/3 2/3/06 JRW

SCALE: AS NOTEI CBM MSD 413.49.01 RAWING NO.:

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