

COMMERCIAL/ STORAGE

SPACE B05

1¹/₂" MAIN DRAIN—

4-0

MECHANICAL ROOM

HALLWAY B08

COAL STORAGE

LINE @ 4-4 AUX. DRAIN UTILITY CRAWL SPACE BO9

TOTAL PROTECTED AREA 1,650 SQ.FT SCALE 3/16" = 1'-0"

ZONE 2 UP TO— 2ND FLOOR ZONE 1 UP TO— 1ST FLOOR

MERCANTILE TYPE USAGE IN THE BASEMENT AND 1ST FLOOR.

THE FIRST ZONE IS FOR THE BASEMENT AND 1ST FLOOR

AND THIRD FLOOR RESIDENTIAL AREAS.

PREVENT WATER FILLED PIPE FROM FREEZING.

CODE REGARDING AN NFPA 13 2010ed. SYSTEM.

3" RISER TO F.D.C.

UNDERGROUND____K

|--20' 16" CAST--

UNDERGROUND_ GATE VALVE

CONGRESS ST.

TEST HYDRANT #00089
ELEVATION: 6'
STATIC: 66 PSI

RESIDUAL: 64 PSI FLOW: 1164 GPM DATE: 8-8-2014

COAL STORAGE

FED FROM STEEL PIPING.

RESIDENTIAL LIVING TYPE USAGE ON THE SECOND AND THIRD FLOOR.

THERE ARE 2 WET ZONED SPRINKLER SYSTEMS FOR THE BUILDING.

COMMERCIAL AREAS AND THE SECOND ZONE IS FOR THE SECOND


COMMERCIAL AREAS PROTECTED WITH COMMERCIAL STYLE HEADS.

RESIDENTIAL LIVING SPACE PROTECTED WITH RESIDENTIAL PENDENTS

THERE IS TO BE A 2 HOUR SEPARATION BETWEEN THE COMMERCIAL

AND HSW SPRINKLER HEADS FED FROM CPVC PIPING ABOVE. GC TO PROPERLY INSULATE AROUND SPRINKLER PIPING TO

PORTION OF THE BUILDING AND RESIDENTIAL PER NFPA 101. THE SPRINKLER SYSTEM WAS DESIGNED TO MEET APPLICABLE

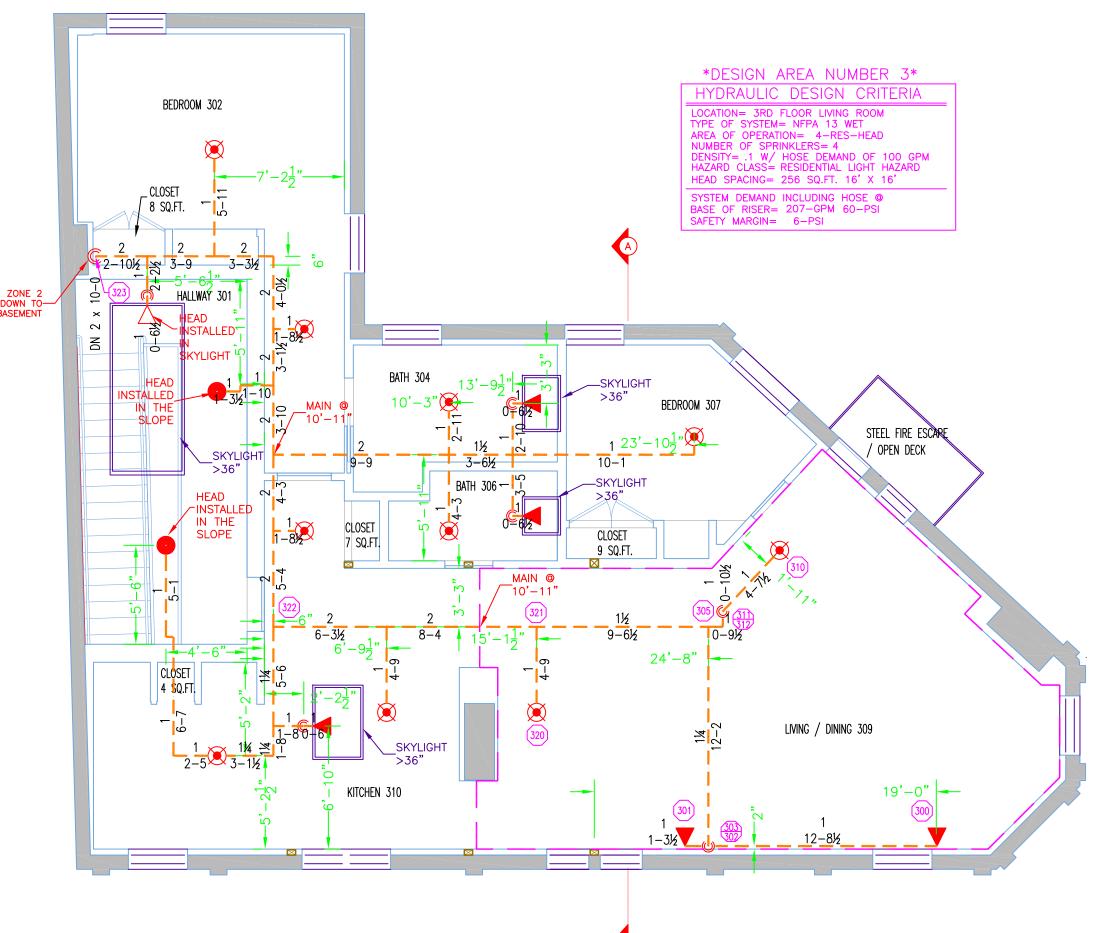




SITE LOCATION—


MAIN EXIST EAST-WEST RIDGE BEAM SUPPORTED BY NEW LVL BEAM, SEE STRUCTURAL - NEW LVL BEAM, SEE STRUCTURAL CEILING COFFER, TYP. -NEW POST, SEE STRUCTURAL -NEW HEADER, SEE STRUCTURAL BEDROOM 307 CONTINUOUS INSULATION AT EXTERIOR — WALLS. SEE WALL TYPES. 6-7½ 9-0 PROBE BAY WINDOW ROOF CONSTRUCTION CONTINUOUS INSULATION LIVING / DINING 209 FINISHED 2ND FLOOR
ELEV + 11'-2" PROBE STOREFRONT ROOF CONSTRUCTION CONTINUOUS INSULATION -NEW CONTINUOUS INSULATION AT — STOREFRONTS, TYP. FINISHED 1ST FLOOR




SPRINKLER SYSTEM COMPONENT DESCRIPTIONS

- 1. 6" DICL UNDERGROUND (BY OTHERS) 1'-6" ABOVE GRADE MINIMUM 2. 6" X 4" FLANGED DUCTILE IRON 90 ELL
- 3. 4" OS&Y GATE VALVE WITH PRESSURE GAUGE & POTTER OSYSU-1 TAMPER SWITCH
- 5. 4" HEADER TO FEED ZONE 1 & 2 WET SYSTEMS
- 11. (2) 2 1/2" SIAMESE F.D.C. FOR SPRINKLER SYSTEM (SEE PLAN FOR LOCATION) 12. 1 1/2" MAIN DRAIN PIPED TO EXTERIOR 18" ABOVE GRADE (SEE PLAN FOR LOCATION) 13. 6" ELECTRIC BELL FOR SPRINKLER SYSTEM ON EXTERIOR OF BUILDING
- 15. 2 1/2" WET FEED TO ZONE 2 (RESIDENTIAL) 16. ADDITIONAL BALL DRIP TO F.D.C.

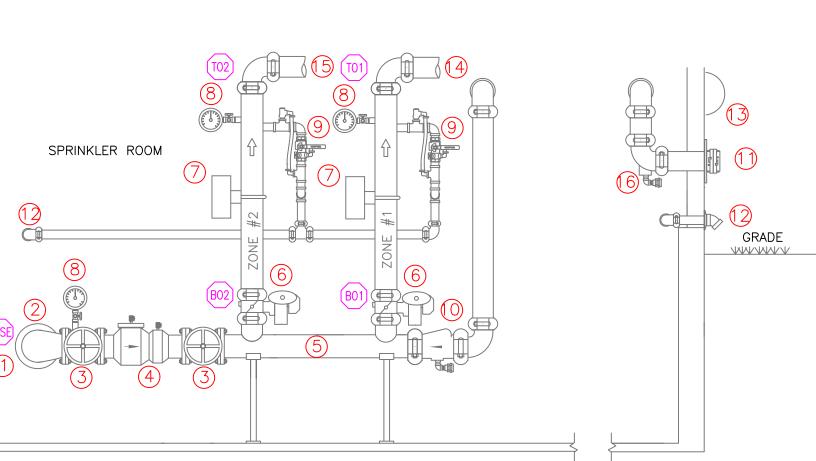

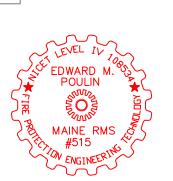

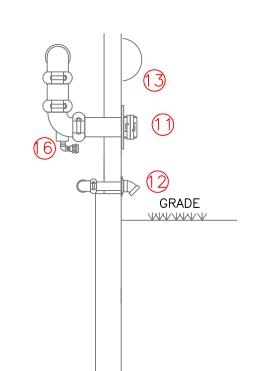

PORTLAND, ME DRAWING TITLE:

FIRE PROTECTION

✓ MAINE LICENSE # 102

GENERAL CONTRACTOR ON RECORD:

SPECIAL APPLICATIONS:

SYSTEM RISER

SWAY BRACING

O RN/DN PIPE RISER UP OR DOWN AUXILIARY DRAIN ----- PROPOSED STEEL PIPE ---- PROPOSED CPVC PIPE

VIKING*

MODEL VK474

16' X 16' SPACING

VIKING*

MODEL VK460

/2" RESIDENTIAL WHITE HORIZONTAL

DEFLECTORS 4" TO 6" BELOW CEILING

16' X 16' SPACING

MODEL GL5615

1/2" BRASS UPRIGHT

ON SPRIGS

DEFLECTORS 1" TO 12" BELOW NON-COMBUSTIBLE CEILINGS

MODEL GL5606

1/2" WHITE CONCEALED PENDENT

MODEL GL5634

1/2" DRY PENDENT

WHITE CONCEALED ESC.

12" MINIMUM

MODEL GL5626

1/2" WHITE HORIZONTAL

SÍDEWALL SEMI REC. ESC.

DEFLECTORS 4" TO 6" BELOW NON-COMBUSTIBLE CEILINGS *OR APPROVED EQUAL*

TAL HEADS ON THIS SHEET: 75

NO. DATE: DESCRIPTION:

DATE: AUGUST 12, 2014

CHECKED BY: J. FOSS

LOCATION:

NICET LEVEL: IV CERT # 108534

REVISIONS:

SCALE 3/16"=1'-0"

DESIGNER: ED POULIN (RMS# 515)

660-662 CONGRESS ST

SIDEWALL SEMI REC. ESC.

P.O. BOX 156 MINOT, ME. 04258-0258 TEL: (207) 998-2551 FAX: (207) 998-4187

COMMERCIAL ZONE RESIDENTIAL ZONE 2 FIRE PROTECTION PLAN (NFPA 13 2010ed.)

DRAWING NO .: FP-01

(101) 30.3.5.3 IN NEW APARTMENT BUILDINGS SPRINKLERS SHALL NOT BE REQUIRED IN CLOTHES CLOSETS LESS THEN 12 SQ.FT. CLOSETS THAT CONTAIN EQUIPMENT SUCH AS WASHER AND DRYERS, FURNACES, OR WATER HEATERS SHALL BE SPRINKLED REGARDLESS OF SIZE. BEDROOM 202 80 SQ.FT. LIVING / DINING 209 KITCHEN 210



TOTAL PROTECTED AREA 1,600 SQ.FT. SCALE 3/16" = 1'-0"

STEEL FIRE ESCAPE / OPEN DECK

A HYDRAULIC CALC. POINT DESIGN & SYSTEM NOTES: WITH GROOVED DUCTILE IRON FITTING OR CPVC. LL PIPING 1 1/4" & SMALLER TO BE SCHEDULE 40 ITH APPROPRIATE FITTING OR CPVC. SITION, LOCATION, SPACING, AND USE OF SPRINKL S SHALL BE IN ACCORDANCE WITH NFPA 13. POSITION, LOCATION, SPACING, AND USE OF HANGERS SHALL BE IN ACCORDANCE WITH NFPA 13. HYDRAULIC CALCULATION PROCEDURES HAVE BEEN DONE IN ACCORDANCE WITH NFPA 13. (SEE PLANS OR LOCATION OF REMOTE AREAS, HYDRAULIC REFERENCE POINTS, AND SYSTEM DEMANDS.) HIGH TECH FIRE PROTECTION IS TO BEGIN WORK AT 6" UNDERGROUND 1' AFF INSIDE OF BUILDING. DIMENSIONS AND LOCATIONS GIVEN FOR SPRINKLER HEADS AND PIPE MAY VARY TO ACCOMMODATE ACTUAL FIELD CONDITIONS. OWNER TO PROVIDE ADEQUATE HEAT THROUGHOUT BUILDING TO PROTECT WATER FILLED PIPING AND EQUIPMENT FROM FREEZING TEMPERATURES. ONLY TRI-SEAL TYPE COUPLINGS TO BE INSTALLED ON DRY AND OR PRE-ACTION SYSTEMS. DWNER IS RESPONSIBLE TO MAINTAIN THE SPRINKLEF SYSTEM IN ACCORDANCE WITH THE LATEST EDITION OF NFPA 25, "INSPECTION, TESTING, & MAINTENANCE OF WATER-BASED FIRE PROTECTION SYSTEMS" AND/ OR ALL APPLICABLE FEDERAL, STATE, AND/OR LOCAL AWS, CODES AND ORDINANCES. LL MECHANICAL, ELECTRICAL AND PLUMBING TRADES TO COORDINATE THEIR WORK WITH RINKLER CONTRACTOR. LL ELECTRIC WORK IS TO BE DONE BY OTHERS. HEAD LEGEND: 1/2" RESIDENTIAL PENDENT WHITE CONCEALED ESC.

- 4. 4" WILKINS 350 BACKFLOW PREVENTER.
- 6. BUTTERFLY VALVE WITH TAMPER SWITCH
- 7. POTTER VSR VANE FLOW SWITCH 8. WATER PRESSURE GAUGE
- 9. INSPECTORS TEST N DRAIN VALVE WITH RELIEF VALVE 10. 3" SWING CHECK VALVE FOR F.D.C. FEED 48" MINIMUM FROM EXTERIOR W BALL DRIP
- 14. 3" WET FEED TO ZONE 1 (COMMERCIAL)