			P	ERMIT ISSU	ED
City of Portland, Maine 389 Congress Street, 04101			Permit No. 02-0.	Issue Date: 554	CBL: 044 G005001
Location of Construction:	Owner Name:	, (207) 07	Owner Address		Phone:
75 State St	Seventy-five S	State St		Y OF PORTI	
Business Name:	Contractor Name	2:	Contractor Ad	lress)	Phone
	WRIGHT RY	AN CONSTRUCTI	O 10 DANFOR	RTH STREET Port	tland 2077733625
Lessee/Buyer's Name	Phone:		Permit Type:		Zone:
			Alterations	- Commercial	Ro
Past Use:	Proposed Use:		Permit Fee:	Cost of Work:	CEO District:
Assisted Living Facility	Assisted Livin Entry Renovat	g Facility with South			
	End y Renoval	.1011	FIRE DEPT:	▼ Apployeu 1	NSPECTION: Use Group:
				☐ Denied	Use Group: P Type:
					^ /
Proposed Project Description:					A(X)/A
Renovation to existing entry/r	eception area.		Signature:	1 milti	Signature Colonia
			PEDESTRIAN	ACTIVITIES DISTR	
			Action:	Approved Appro	ved w/Conditions Denied
			Signature:		Date:
Permit Taken By: jodinea	Date Applied For: 05/21/2002		Zoı	ning Approval	
1. This permit application d	oes not preclude the	Special Zone or R	eviews -	Zoning Appeal	Historic Preservation
Applicant(s) from meetin Federal Rules.		☐ Shoreland	Den V	ariance	Not in District or Landman
2. Building permits do not i septic or electrical work.	nclude plumbing,	Westand C	n hen us	iscellaneous	Does Not Require Review
3. Building permits are void within six (6) months of t		WeHahd Flood Zone	sent c	onditional Use	Requires Review
False information may in permit and stop all work.	validate a building	Subdivision	l	terpretation	Approved
		☐ Site Plan	☐ A _I	pproved	Approved w/Conditions
		Maj Migaor N	on who s	enied	to Denied to D.A 6/31
		Date: 3	73/16/Pate:		Date:
					WH 6000
		CERTIFICA	TION		
I hereby certify that I am the or	wner of record of the na			ork is authorized by	u the owner of record and that
I have been authorized by the c jurisdiction. In addition, if a p shall have the authority to ente such permit.	owner to make this appli ermit for work described	cation as his authori	zed agent and I ag s issued, I certify	gree to conform to that the code office	all applicable laws of this ial's authorized representative
SIGNATURE OF A PRIVATE					
SIGNATURE OF APPLICANT		ADDR	ESS	DATE	PHONE

	2-0554		
Zoning	Strate Approved	PPA-262-03	Marge Schmuckal
75 State Stre	Carried delights of the Carried and the Carried State of the Carried Sta	i de la companya de	05/31/2002
		Streen 2	9.0349
		uckal 05	/31/2002
		i i i i i i i i i i i i i i i i i i i	
This permit is being approbefore starting that work.	oved on the basis of plans subr		Il require a separate approval
		or exterior aumings	
Separate permits shall be	required for any new signage	or exterior awnings.	
ANY exterior work require:	s a separate review and approv	val thru Historic Preservatio	on
A PER DIVINI DE COMPANIA DE CONTRACTO DE LA CONTRACTO DE CONTRACTO DE CONTRACTO DE CONTRACTO DE CONTRACTO DE C			

	Bulldin	2-0554	Approved with Co	nditions	Mike Nuge	ent
					07/10/2002	
	✓	MI	ke Nugent	07/10/20	06/14/2002	
H 0	torizontal Sliding Doc complies with Section	ors cannot be installed un 1017.4.4.	until the designer/buil	der has established tl	hat the intended c	loor
	8 12 57 2 30 2	05/23/2002 jodi		07/10/2	2002 mjn	MINISTER SALES AND

.

Form # P 04

Other

DISPLAY THIS CARD ON PRINCIPAL FRONTAGE OF WORK

CITY OF PORTLAND

Please Read Application And Notes, If Any, Attached

Permit Number: 020554

ences of the City of Portland regulating

tures, and of the application on file in

provided that t	he person or persons,	m or		ion	ep	ting this permit shall comply with all
AT 75 State St						044 G005001
has permission to	Renovation to existing entry/	eption a				
This is to certify that	Seventy-five State St/WRIGI	RYAN	a manabili	CTION		
				1		

of buildings and six

ne and of the

provided that the person or persons, of the provisions of the Statutes of N the construction, maintenance and u this department.

Apply to Public Works for street line and grade if nature of work requires such information.

ication insped must gi n permis and wr n procu e this t ding or t therea losed-in. d or d la Н R NOTICE IS REQUIRED.

A certificate of occupancy must be procured by owner before this building or part thereof is occupied.

OTHER REQUIRED APPROVALS	
OTHER REQUIRED APPROVALS Fire Dept.	
Health Dept.	
Appeal Board	

PENALTY FOR REMOVING THIS CARD

WRIGHT-RYAN CONSTRUCTION, INC

10 Danforth Street Portland, Maine 04101

LETTER OF TRANSMITTAL

					DATE: 6/2	24/02	JOB NO. 0214
	Ph	one (207) 7	73-3625		ATTENTION	Permit / Jodean	
	F	Fax (207) 77	3-5173		RE: 75 St	tate-South Entry	
то	City of Por	rtland					
WE ARE	SENDING YOU	ب ا	Attached	Under separa	te cover via	the following it	ems:
	Shop draw	rings	Prints 🔀	Plans		Samples	
	Copy of let	_ =	Spec's	Change order	Ħ		
COPIES	DATE	NO.				ESCRIPTION	
1	5/31/02	140.	A001,D100,A	100,A200,A3		A500,A600 & S1	
1	5/31/02		11x17 of abov		,		
1				ction Informat	ion		
THESE AF	RE TRANSMIT	TED as chec	ked below:				
	For approve	al	Approved as su	bmitted	Resubm	nit copies for ap	proval
\triangleright	For your us	=	Approved as no	<u> </u>	Submit	copies for dis	
lacksquare	As requeste	ed	Returned for co	rrections	Return	corrected pri	
	For review	and comment			_		
	FOR BIDS	DUE	20		PRINTS	RETURNED AFTER L	OAN TO US
REMAR	RKS:				 		
Plagge	process plar	na fan hwild	ina namit			DES	
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:						(D) 10N 2	100
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COPY T	O: file				SIGNED: P	eter Haber	





CITY OF PORTLAND BUILDING CODE CERTIFICATE 389 Congress St., Rm 315 Portland, ME 04101

TO:	Inspector of Buildings City of Portland, Maine Department of Planning & Urban Development Division of Housing & Community Service
FROM:	GAWROND ARCHITECTS
RE:	Certificate of Design
DATE:	2008 30, 2008
These plans a	nd/or specifications covering construction work on:
SEIDE	WILL STATE STREET,
Sou	TH COMMONS LOBBY
architect/engi	Signature / TWYWYWW
	Tick PRIX POL

\$50,000.00 or more in new construction, repair, expansion, addition, or modification for Building or Structures, shall be prepared by a registered design Professional.

PSH 6/20/2k

HACK POINT RO BORONCH, HE . CMOFM



CITY OF PORTLAND MAINE

389 Congress St., Rm 315 Portland, ME 04101 Tel. - 207-874-8704 Fax - 207-874-8716

TO:

Inspector of Buildings City of Portland, Maine Planning & Urban Development


Division of Housing & Community Services
FROM DESIGNER: LAWRON ARCHITECTS
29 PLACE POINT RD, SCARBORCIXH, ME, CHOTY
DATÉ: 1017. 20, 2002
100 Name SELENTY GIVE STATE STREET, S. COMMONS LOBBY
Address of Construction: 15 STRIE STREET, PORTLAND, MAINE
THE BOCA NATIONAL BUILDING CODE/1999 FourteenthEDITION Construction project was designed according to the building code criteria listed below:
Building Code and Vede 19109 Use Group Classification(s) PROJECT RELOCATION PROJECT RECOCATION PROJECT RECOCATION PROJECT RECOCATION PROJECT RECOCATION PROJECT
Type of Construction Section Blog. Heigh
Seismic ZoneGroup Class
Roof Snow Loud Per Sq. Ft. Dead Load Per Sq. Ft. DR
Basic Wind Speed (mpt.) (A Effective Velocity Pressure Per Sq. Ft. 1)
Fluor Live Load Per Sq. Ft. 1918
Structure has full sprinkler system? Yes No Alarm System? Yes No Sprinkler & Alarm systems must be installed according to BOCA and NFPA Standards with approval from the Portland Fire Department.
Is simultime being considered unlimited area building: Yes_No
If mixed use, what subsection of 313 is being considered DA
List Occupant loading for each room or space, designed Into this Project.
(Designers Stamp & Signature)
PSH 6/07/2K STANLEY 1145 TE OF MANUAL MAN



CITY OF PORTLAND ACCESSIBILITY CERTIFICATE

Designer: CALDROLD POCHITECTS				
Address of Project 5 STATE STOFFT				
Nature of Project PENONATION TO				
ALD EXISTING SPACE				
Date 101 x 20, 2002				

The technical submissions covering the proposed construction work as described above have been have been designed in compliance with applicable referenced standards found in the Maine Human Rights Law and Federal Americans with Disability Act.

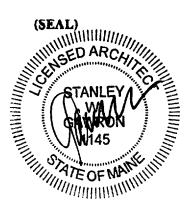

Signature Hayw Mann

Title Penxipal

Firm CAWROWS ARCHITECTS

Address 29 PLACK POINT LD

PFOND 3H, ME CHOTY

Telephone 307.883.1207

02-0554

All Purpose Building Permit Application

If you or the property owner owes real estate or personal property taxes or user charges on any property within the City, payment arrangements must be made before permits of any kind are accepted.

Location/Address of Construction: 75	STATE ST	·Ponnano		
Total Square Footage of Proposed Structu	ıre	Square Footage of Lot		
Tax Assessor's Chart, Block & Lot Chart# Block# Lot# 044 6 005	Owner: Sei	viany five state st.	Telephone: 772-7675	
Lessee/Buyer's Name (If Applicable)	Applicant name, address & Cost Of Work: \$ 164, 500 Whith hyper Construction to annimit ST. Ponname Cost Of Work: \$ 164, 500 Fee: \$ 1171.			
Current use: Assure Living / Sur	H ENTMY	RENUMTION		
If the location is currently vacant, what we	as prior use:			
Approximately how long has it been vacc	ant:			
Proposed use:	THE ENT	MY /RECEPTION AREA		
Contractor's name, address & telephone: Who should we contact when the permit Mailing address: SAME As ALOVE We will contact you by phone when the preview the requirements before starting as and a \$100.00 fee if any work starts before	is ready: <u>Re</u> permit is read ny work, with	dy. You must come in and a Plan Reviewer. A stop	d pick up the permit and	
IF THE REQUIRED INFORMATION IS NOT INCL DENIED AT THE DISCRETION OF THE BUILDING INFORMATION IN ORDER TO APROVE THIS PE I hereby certify that I am the Owner of record of the na have been authorized by the owner to make this appli- jurisdiction. In addition, if a permit for work described in shall have the authority to enter all areas covered by	F/PLANNING RMIT. amed property, lication as his/he on this application	or that the owner of record author authorized agent. I agree to an its issued, I certify that the Code	QUIRE ADDITIONAL horizes the proposed work and that I conform to all applicable laws of this a Official's authorized representative	
to this permit.				
Signature of applicant:	·····	Date: 5	OTION	
This is NOT a permit you may no	ot commo	noo ANV work until th	DEPT. OF BUILDING AND. ME	

If you are in a Historic District you may be subject to additional permitting and fees with Planning Department on the 4th floor of City Halli

COMMERCIAL PROJECTS

Your submissions must include the following to be accepted as a complete application:

- 1 Copy of the deed if you have owned the property less than 365 days
- 1 Copies of floor plan showing dimensions of each area and use to scale
- 1 Copy of the plot plan to scale
- 1 Copies of the construction detail
- 1 Copies of the cover letter explaining the project in detail
- 1 Copy of the floor plan/construction details and plot plan on 11" x 17" paper, we cannot accept
 the application without the reduced set. Electronic plans may be submitted in place of the 11" x
 17" copies

PLOT PLAN INCLUDES THE FOLLOWING:

- The shape and dimension of the lot, footprint of the proposed structure and the distance from the
 actual property lines. Structures include decks porches; a bow windows cantilever sections and
 roof overhangs, sheds, pools, garages and any other accessory structures must be shown and to
 scale. A photocopy of the plat with hand drawn footprints of buildings if it is not to scale, it will not
 be accepted
- Boundary survey to scale showing North arrow; zoning district & setbacks
- First floor sill elevation (based on mean sea level datum);
- Location and dimensions of parking areas and driveways;
- Location and size of both existing utilities in the street and the proposed utilities serving the building;
- Location of areas on the site that will be used to dispose of surface water.
- Existing and proposed grade contours
- Silt fence locations
- THE SURVEYORS MONUMENTS MUST BE IN PLACE AND THE LOT STAKED FOR A SETBACK INSPECTION PRIOR TO ISSUANCE OF A BUILDING PERMIT

A COMPLETE SET OF CONSTRUCTION DRAWINGS INCLUDES THE FOLLOWING:

- Cross sections w/framing details
- Detail of any new walls or permanent partitions
- Floor Plans & Elevations
- Window and door schedules
- Foundation plans with required drainage and damp proofing (if applicable)
- Electrical and plumbing layout. Mechanical drawings for any specialized equipment such as furnaces, chimneys, gas equipment, HVAC equipment (air handling) or other types of work that may require special review must be included.
- Scaled plot plan showing parking, either private or on street

SEPARATE PERMITS ARE REQUIRED FOR INTERNAL & EXTERNAL PLUMBING, HVAC AND ELECTRICAL INSTALLATIONS

- All construction must be conducted in compliance with the 1999 B.O.C.A. Building Code as amended by Section 6-Art II.
- All plumbing must be conducted in compliance with the State of Maine Plumbing Code.
- All Electrical Installation must comply with the 1999 National Electrical Code as amended by Section 6-Art III.
- HVAC (Heating, Ventilation and Air Conditioning) installation must comply with the 1993 BOCA Mechanical Code.

AT THE DISCRETION OF THE BUILDING/PLANNING DEPARTMENT, WE MAY REQUIRE ADDITIONAL INFORMATION IN ORDER TO APPROVE THE PERMIT. IF THE REQUIRED INFORMATION AS STATED ABOVE IS NOT SUBMITTED WITH THE APPLICATION, THE APPLICATION WILL BE AUTOMATICALLY DENIED

The cost of the permit is as follows:


- Basic permit fee: \$30.00
- The first \$1,000.00 worth of construction is covered in the \$30.00 base fee
- Every additional \$1,000.00 of construction will cost \$7.00

Submissions for commercial work over \$50,000.00 must be done by a Design Professional

Please note that commercial uses that are proposing over 5,000 square feet of construction (interior or exterior) or change of use must file a complete Site Plan Application.

If a Certificate of Occupancy is needed, it must be issued and paid for before the structure may be occupied. The fee is \$75.00


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FOUNDATION PLAN

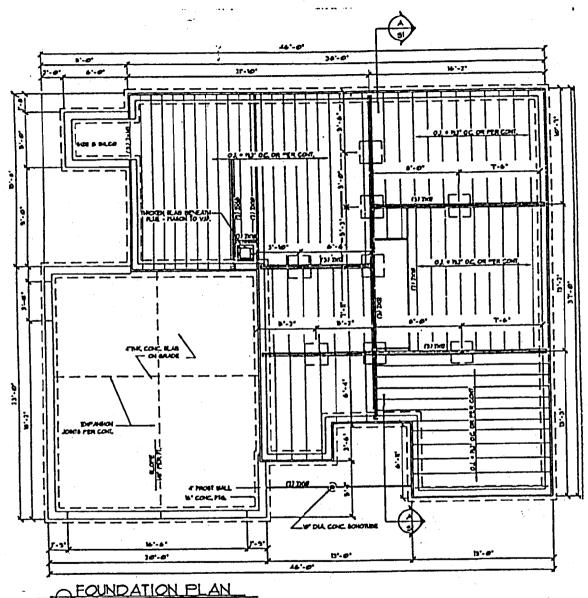:.






Lot Front

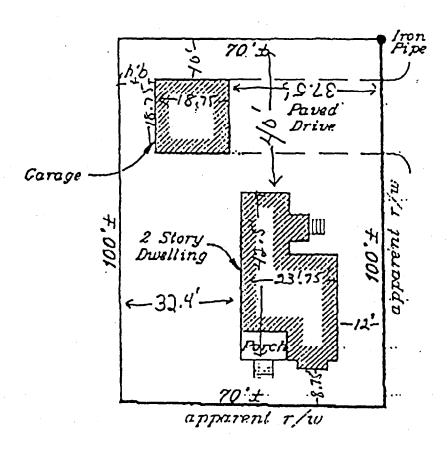



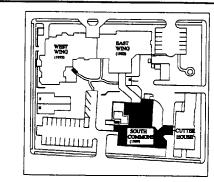

DRAWING INDEX

A001 TITLE SHEET & DRAWING INDEX

A-100 1/8" FLOOR PLAN PLAN & WALL TYPES

A-600 DOOR SCHEDULE / FINISH SCHEDULE

D-100 1/8" DEMOLITION PLAN

A-200 REFLECTED CEILING PLAN

FINISH FLOOR PLAN

A-400 INTERIOR ELEVATIONS

GENERAL SHEETS

INTERIOR ARCHITECTURAL

A-300 POWER PLAN

A-500 DETAILS





www.gawron.com Tel. 207 . 883 . 6307 Fax. 207 . 883 . 0361

> State Street
> Portland, Maine SEVENTY-FIVE

South REVISIONS

05.31.02 PROTECT # 011600.05 DRAWN BY: DLP/LAA CHECKED BY: MBT DRAWING SCALE NTS

> SHEET TITLE COVER SHEET

DRAWING ABBREVIATIONS

AFF ALUM AWP ACT BOT BRG BRK

CL CLG CONC CONT

DNA DTL DW DWG

EXT FD FDN FE FFE

ELEVATION ELECTRICAL

FINISH FLOOR FINISH FLOOR FINISH GRADE FLOOR FIRE RATING FRAMING FEET (FOOT)

ELEVATOR ELECTRO-MAGNETIC HOLD OPEN

ELECTRO-MAGNETIC HOLD
EQUAL
EACH WAY
ELECTRIC WATER COOLER
EXISTING
EXPANSION
EXTERIOR
FLOOR DRAIN
FOUNDATION
PIRE EXTINGUISHER
FINISH FLOOR ELEVATION
FINISH

FIELD VERIFY FABRIC WALL COVERING

ABOVE FINISH FLOOR ALUMINUM ACOUSTICAL WALL PANEL ACOUSTICAL CEILING TILE ACCUSTICAL CEILING
BOTTOM
BEARING
BRICK
CARPET
CABINET
CHALK BOARD
CENTER TO CENTER CENTER LINE CEILING CONCRETE CONTINUOUS CONSTRUCTION CONTRACTOR CERAMIC TILE LINTL LOC M MAS MAX MB MCCH MECH MISC MISC MISC MR MRGB MTL DRINKING FOUNTAIN DOES NOT APPLY DETAIL DISHWASHER DRAWING EAST EACH EACH FACE

OPNG

PTD

GAUGE
GALVANIZED
GRAB BARS
GENERAL CONTRACTOR
GYPSUM WALL BOARD
HANDICAD
HANDED
HANDED JOINT LAVATORY LINTEL LOCATION MARBLE MASONRY MAXIMUM MARKER BOARD MANUFACTURER MINIMUM MISCELLANEOUS MOISTURE RESISTANT GYPSUM BOARD METAL NORTH NOT APPLICABLE NOT IN CONTACT NOT TO SCALE

ON CENTER OUTSIDE DIAMETER

PANEL PRESSURE TREATED

PAPER TOWEL AND WASTE DISPENSER

OPPOSITE OUTSIDE FACE PAINT

OPENING

PAINTED PLATE PLYWOOD

PARTITION REFER REFRIGERATOR REINFORCED REQUIRED ROOM ROOM
ROUGH OPENING
SOUTH
SUSPENDED ACOUSTIC TILE
SHOWER CURTAIN SOAP DISPENSER SCHEDULE SECTION SHEET

SANITARY NAPKIN DISPOSAL SQUARE STANDARD STEEL STRUCTURAL SHEET VINYL TEMPERED (GLASS) TACK BOARD THICKNESS TOP OF TOP OF WALL TOILET PAPER DISPENSER TYPICAL UNLESS NOTED OTHERWISE VCT VINYL COMPOSITION TILE VERTICAL VINYL WALL COVERING


WATER CLOSET

GENERAL NOTES

COORDINATION: IT IS THE RESPONSIBILITY OF THE CONTRACTOR TO COORDINATE ALL DISCIPLINES AND TRADES SO THAT ALL BUILDING SYSTEMS AND COMPONENTS CAN BE ASSEMBLED WITHOUT CONFLICTS. IN THE EVENT THAT THE CONSTRUCTION DOCUMENTS DEFINE CONDITIONS WHICH PRONBET OR MAY PROVINET SUCH ASSEMBLY, THE CONTRACTOR SHALL BRINGS TO THE ARCHITECTS ATTENTION, IN WINTIMG AND IN A THELTY FASHOM, SUCH CONDITION. THE CONTRACTOR SHALL NOT PROCEED WITH RELATED WORK WITHOUT WITHTHE RESOLUTION OR CLARIFICATION FROM THE

DISCREPANCES AND CLARIFICATIONS: IT IS THE RESPONSIBILITY OF THE CONTRACTOR TO GRING TO THE ARCHITECTS ATTENTION, IN WRITING, ANY DISCREPANCES OR AMBIQUITIES IN THE DRAWINGS AND/OR SPECIFICATIONS. THE CONTRACTOR SHALL NOT PROCEED WITH RELATED WORK WITHOUT A WRITTEN RESOLUTION OR CLARIFICATION FROM THE ARCHITECT.

- LAYOUT: UNLESS INDICATED OTHERWISE, CENTER WALL FRAMING AND PARTITION FRAMING ON COLUMN LINES. FLOOR PLAN DIMENSIONS ARE TO CENTERLINE OF FRAMING, FACE OF CONCRETE, FACE OF CAU OR FROM COLUMN CENTER LINES.
- 5. DOOR LOCATIONS: DOOR LOCATIONS NOT DIMENSIONED SHALL BE 6" FROM ADJACENT WALL
- Oraning Scale: Work from the given dimensions only, scale is indicated on the drawings for convolubne only. It is not intended that information be determined by scaling the drawings since some Itials may not be to scale.
- Finishes: Finishes other than the Standard Finishes are all indicated on the drammas, celling finishes are shown on the reflected deling plans and all other finishes are shown on the finish schedule and/or interior elevation. Finishes indicated for a particular room or space are applicable for the entire room or space, unless rookable otherwise.
- ALL EXPOSED SURFACES ARE TO BE PAINTED, WHETHER OR NOT INDICATED ON THE DRAWINGS, EXCEPT AS FOLLOWS: ALL EUROSED SAME ACES AND IN EXPANNED, WHE THEN OR NOT NOT WOCKARD ON THE DRAWWING, EXCEPT AS FOLLOWS; WHORE SPECIAL COATINGS (ARE MODICATED) PREFINISHED (FEBAS, CONCALD) SURFACES, OPERATION PARTS: AND LABELS. EVEN IF PREFINISHED, PAINT THE FOLLOWING: EXPOSED MECHANICAL DUCTHORIC; WILL DIFFUSERS; CARLES AND LOURISER, ROOT TO MECHANICAL DUCTHORIC; WHALL DIFFUSERS AND LAMPS. MOT BULB). PRESIDED METAL SURFACES, EXCEPT AS LISTED ABOVE, ARE NOT TO BE PAINTED. SEE SPECIFICATIONS FOR SCHEDULES SHOWING TYPES OF PAINTS AND SPECIAL COATINGS TO BE USED IN ACCORDANCE WITH MATERIAL BEING PAINTED OR COATED.
- 9. ALL WOOD IN CONTACT WITH CONCRETE FLOOR SHALL BE PRESSURE TREATED.
- 10. SULLING INSULATION: PROVIDE AS NOICATED IN WALL DETAILS AND IN ACCORDANCE WITH PARTITION TYPES, WHETHER OR NOT SHOWN IN SETALS AND OTHER DETAILS AND OTHER DRAWNOS. FOR CLARITY, INSULATION MAY NOT 8E SHOWN IN SOME CISES, EVEN IF IT IS PROVIDED.
- BLOCKING: INSTALL BLOCKING BEHIND ALL SURFACE—APPLIED FOTUNES, THIM, CASEMORK, SHELVES, BRACKETS, TOLET ACCESSORIES, CHAIR RAILS, PICTURE RAILS, GRAB BAIRS, WHITE BOARDS, MIRRORS, PROJECTIOR SCREENS, BASE MOLUBINESS, AND AS OTHERWISE REQUIRED, WHICH SUCH ITEMS ARE APPLIED ON STUD WALLS.
- PENETRATIONS AT STRUCTURAL MEMBERS: BEFORE PENETRATING JOISTS, BEAMS OR OTHER STRUCTURAL MEMBERS, CONSULT WITH THE ARCHITECT.
- 13. DAMAGED WORK: BUILDING OR SITE COMPONENTS WHICH ARE AFFECTED BY NEW WORK, DEMOLITION OR WHICH MAY BE DAMAGED BY THE CENERAL CONTRACTOR OR ANY SUBCONTRACTOR SHALL BE REPLACED OR RESTORED TO ORIGINAL CONDITION AND COLOR TO MEET THE APPROVAL OF THE ARCHITECT.
- RATED CONSTRUCTION: PROVIDE RATED CONSTRUCTION AS REQUIRED BY CODE, AS SPECIFIED, AND AS INDICATED ON DRAWINGS. IT IS THE RESPONSIBILITIES OF THE CONTRACTOR TO PROVIDE AND INSTALL ALL COMPONENTS REQUIRED TO CREATE SUCH RATED CONSTRUCTION, REGARDLESS OF WHETHER OR NOT SUCH COMPONENTS ARE MOLICATED. PROVIDE CONTRINUITY OF SUCH RATED CONSTRUCTION AROUND AND BETWEEN SPACES, INCLIDING AT CHASES AND AT FLOORS, TO MAINTAIN COMPLETE SEPARATIONS, EVEN IF NOT SPECIFICALLY INDICATED.
- CONTRACTOR SHALL SUBMIT SAMPLES OF ALL INTERIOR FINISHES FOR ARCHITECT'S APPROVAL.
- THE DESIGN AND INSTALLATION OF THE HVAC AND PLUMBING SYSTEMS SHALL BE THE RESPONSIBILITY OF THE MECHANICAL CONTRACTOR. DESIGN SHALL BE IN CONFORMANCE WITH NFPA 101, '2000 EDITION, BOCA, '96 EDITION, MAINE STATE PLUMBING CODE.
- THE DESIGN AND INSTALLATION OF THE ELECTRICAL SHALL BE THE RESPONSIBILITY OF THE ELECTRICAL CONTRACTOR. DESIGN SHALL BE IN CONFORMANCE WITH NFPA 101 2000 EDITION, BOCA '98 EDITION, MAINE ELECTRICAL CODE.
- THE SPECIAL PROPERTY OF THE SPECIAL SYSTEM CHAIR DE THE DECINOCICIONES OF THE

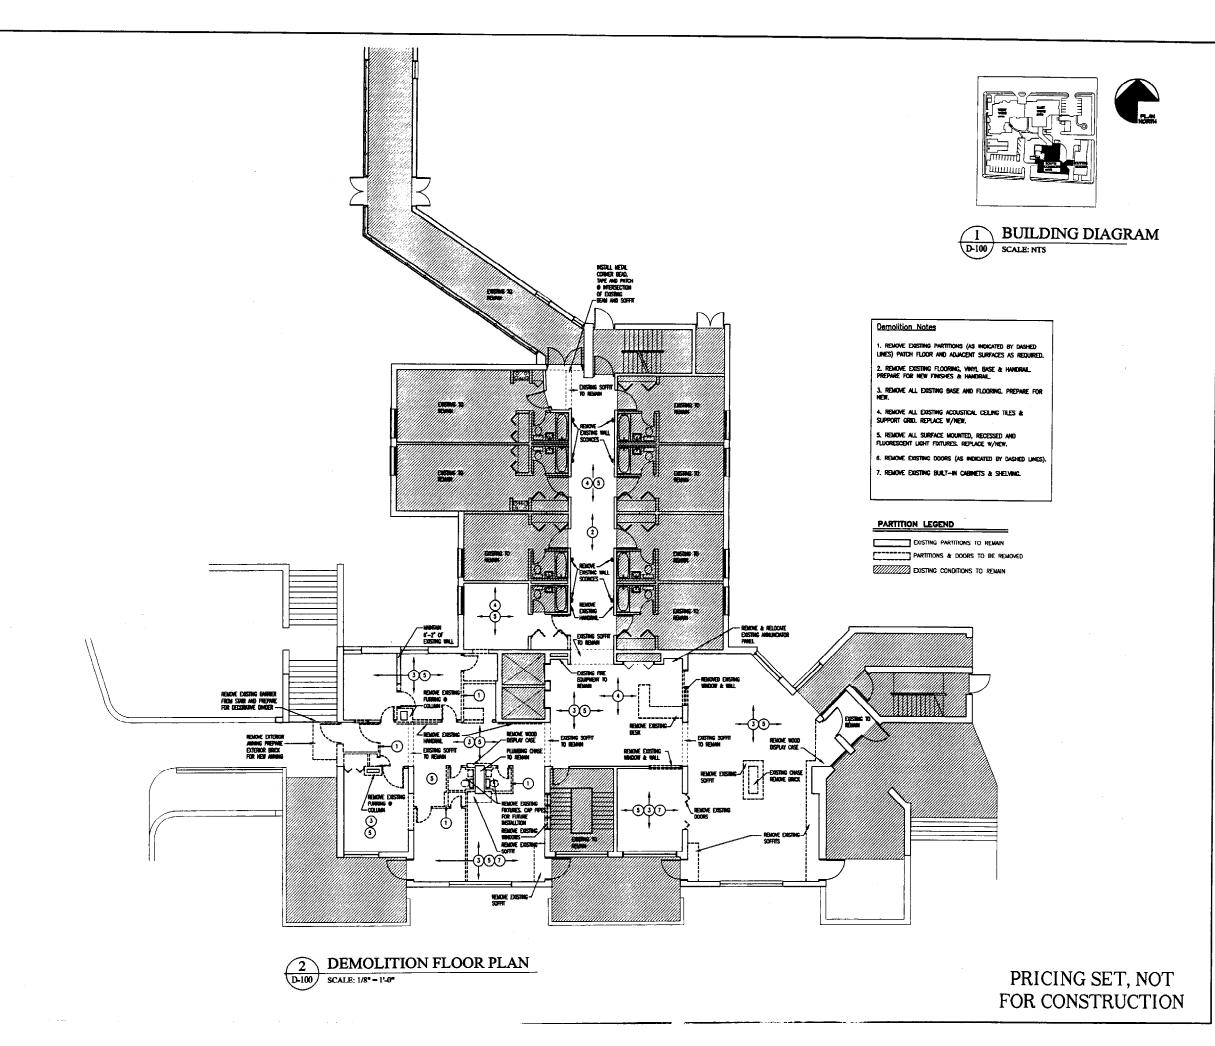





ARCHITECTS
29 Black Point Road
Scarborough, ME 04074
www.gawron.com
Tel. 207 . 883 . 6307
Fax. 207 . 883 . 0361

STATE STREET SEVENTY-FIVE

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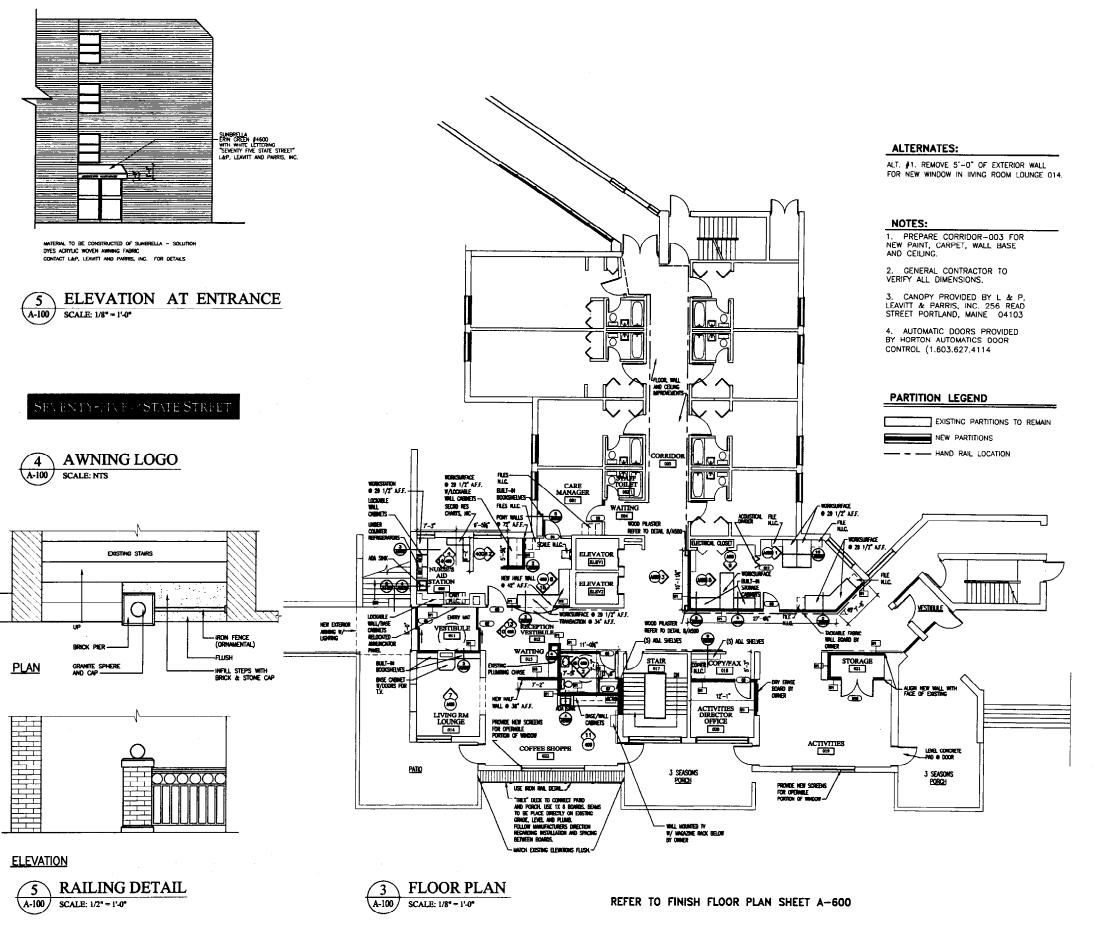
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SHEET TITLE

DEMOLITION FLOOR PLAN


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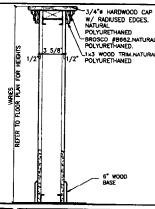








BUILDING DIAGRAM

SCALE: NTS

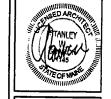

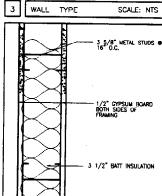

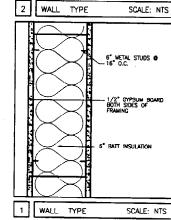



PRICING SET, NOT FOR CONSTRUCTION **GAWRON ARCHITECTS**

29 Black Point Road Scarborough, ME 04074 www.gawron.com Tel. 207 . 883 . 6307 Fax. 207 . 883 . 0361

STREET Maine STATE SEVENTY-FIVE Commons

REVISIONS
DATE DESCRIPTION


South

05.31.02 DEAWN BY DLP/LAA HBCKED BY: DRAWING SCALE 1/8~1'-0"

SHEET TITLE

FLOOR PLAN AND EXT, ELEVATION

A-100

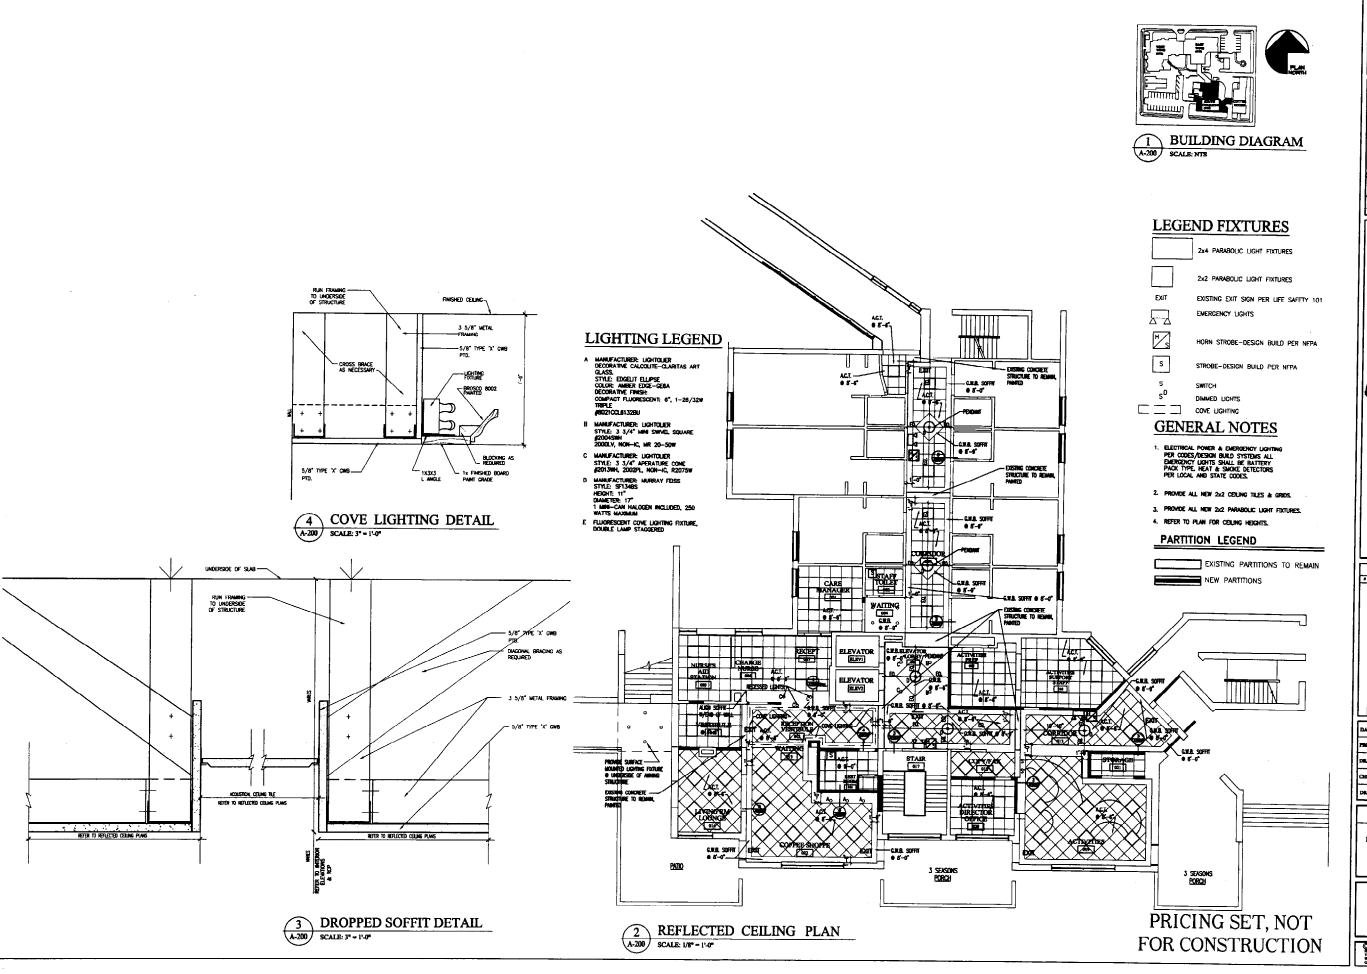





Seventy-Five State Street
South Commons | Portland, Maine

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REVISIONS							
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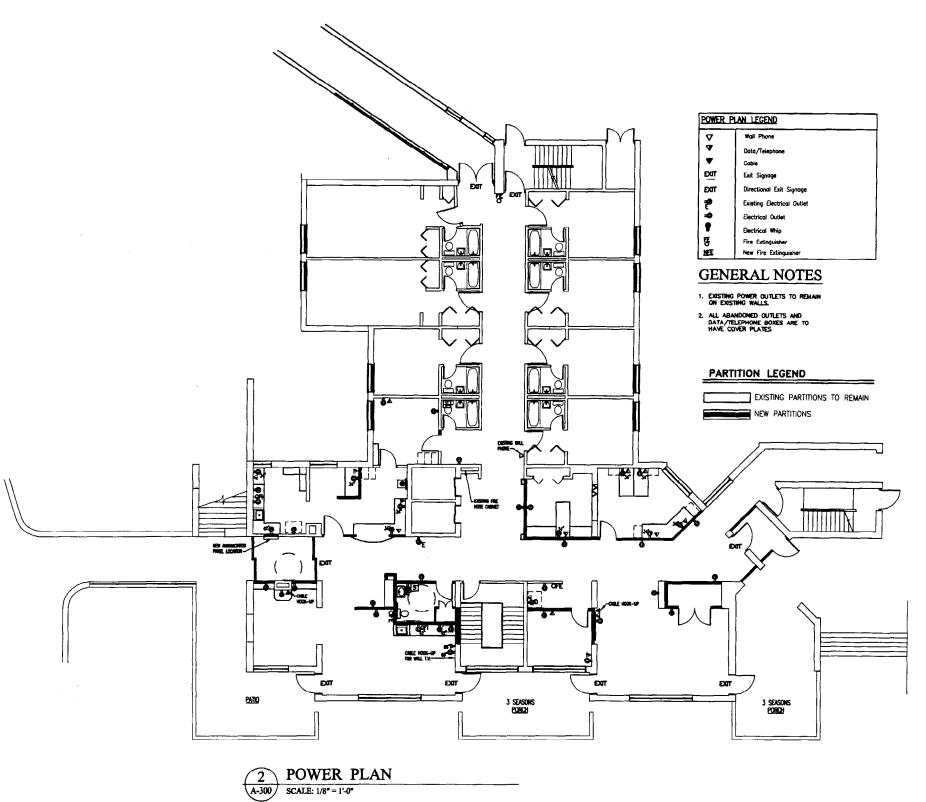
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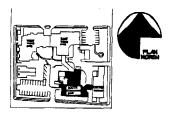
SHEET TITLE

REFLECTED CEILING FLAN

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Tel. 207 . 883 . 6307 Fax. 207 . 883 . 0361

Portland, Maine STATE STREET SEVENTY-FIVE

South Commons

REVISIONS


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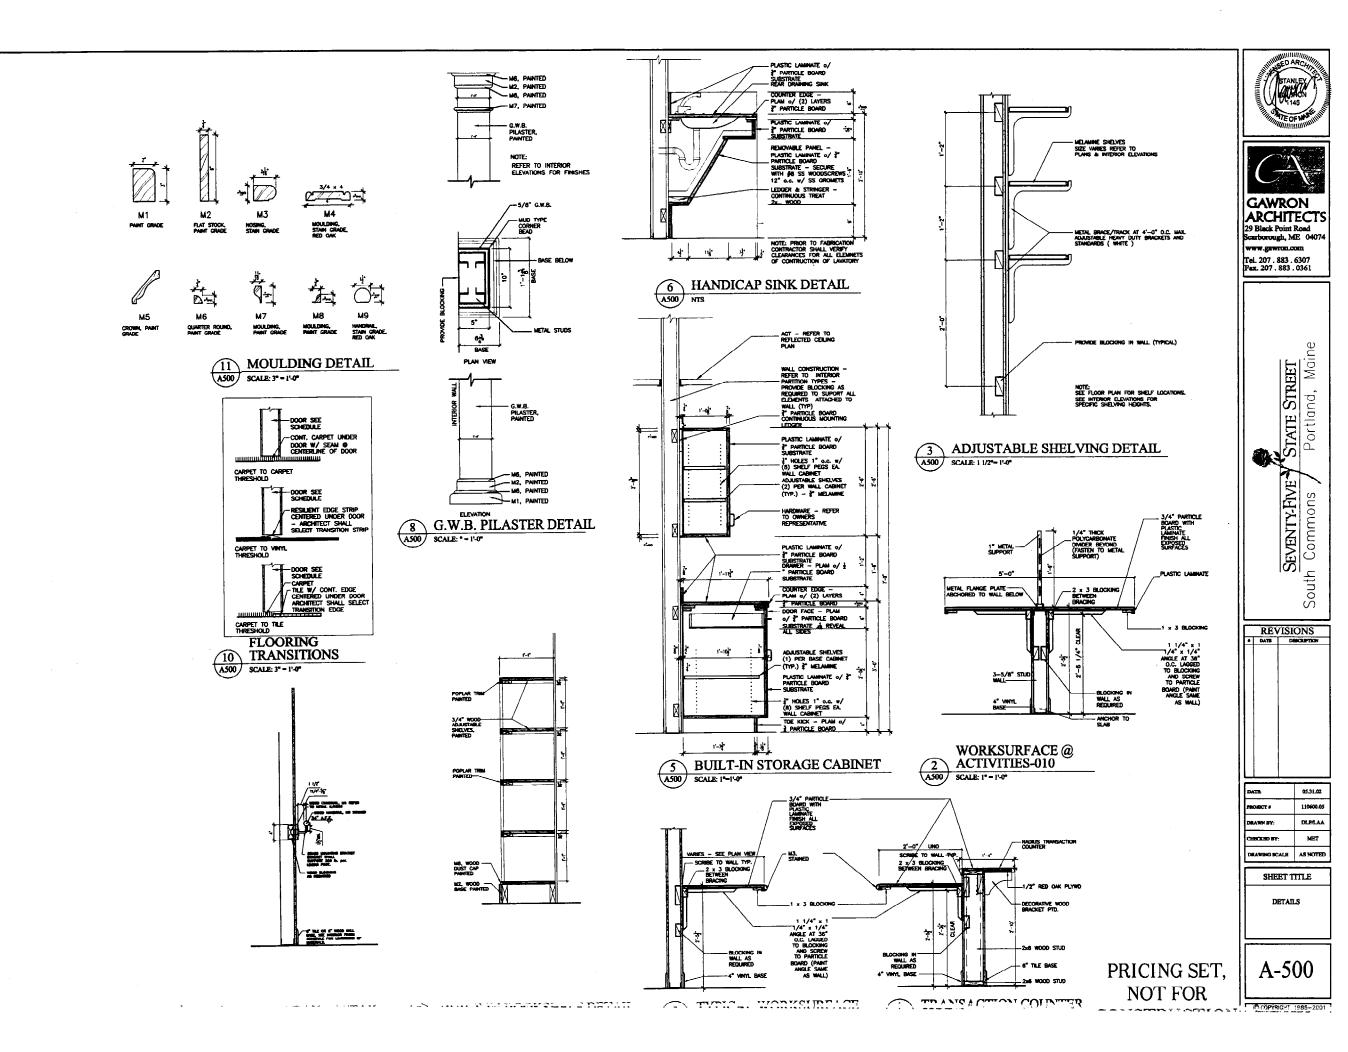
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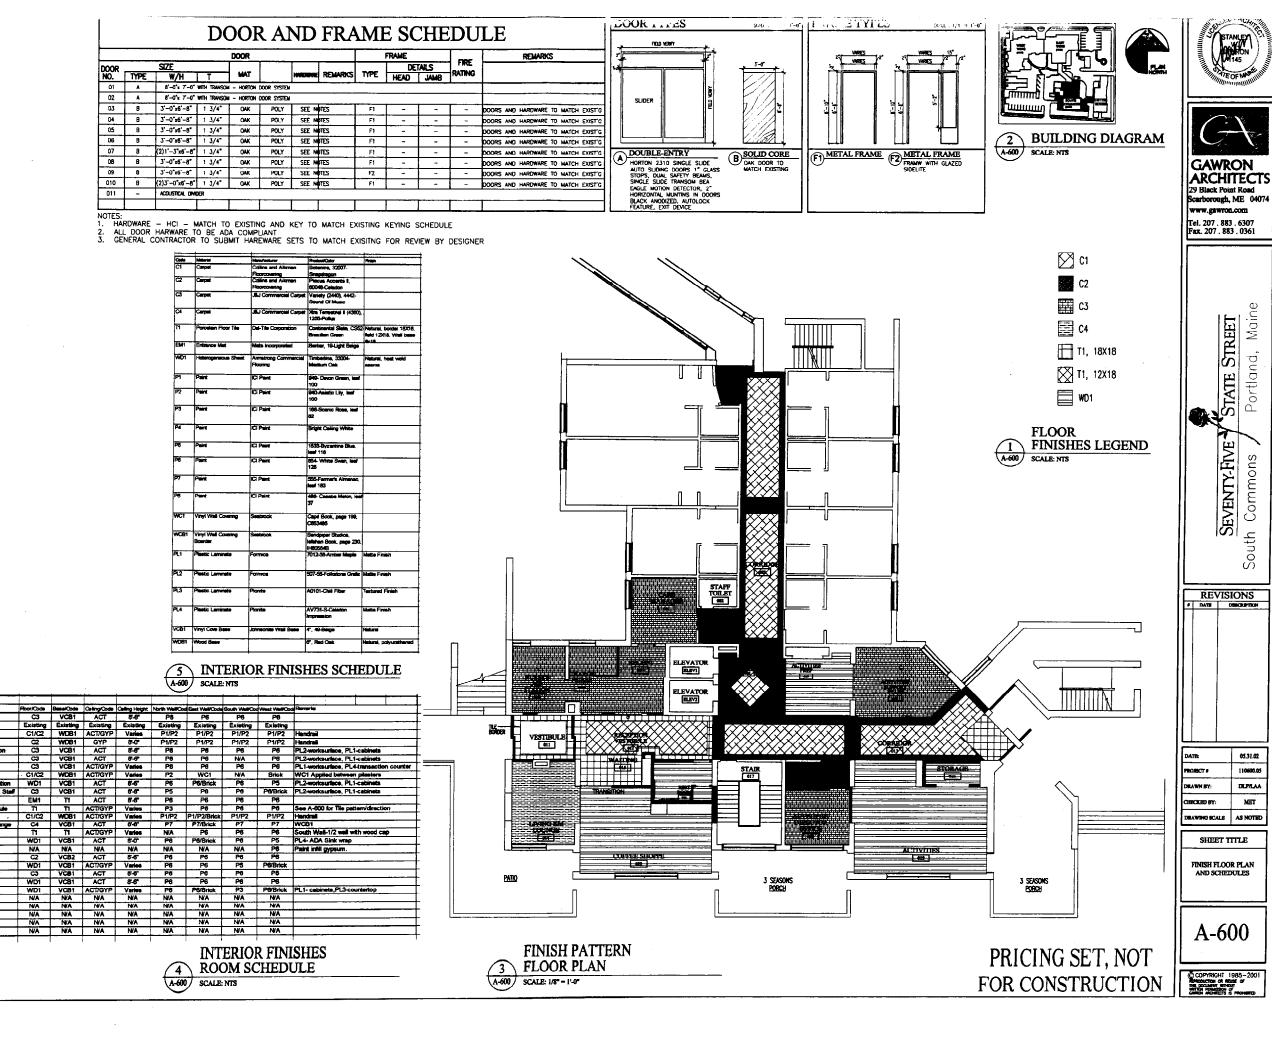
SHEET TITLE POWER PLAN

A-300

PRICING SET, NOT FOR CONSTRUCTION






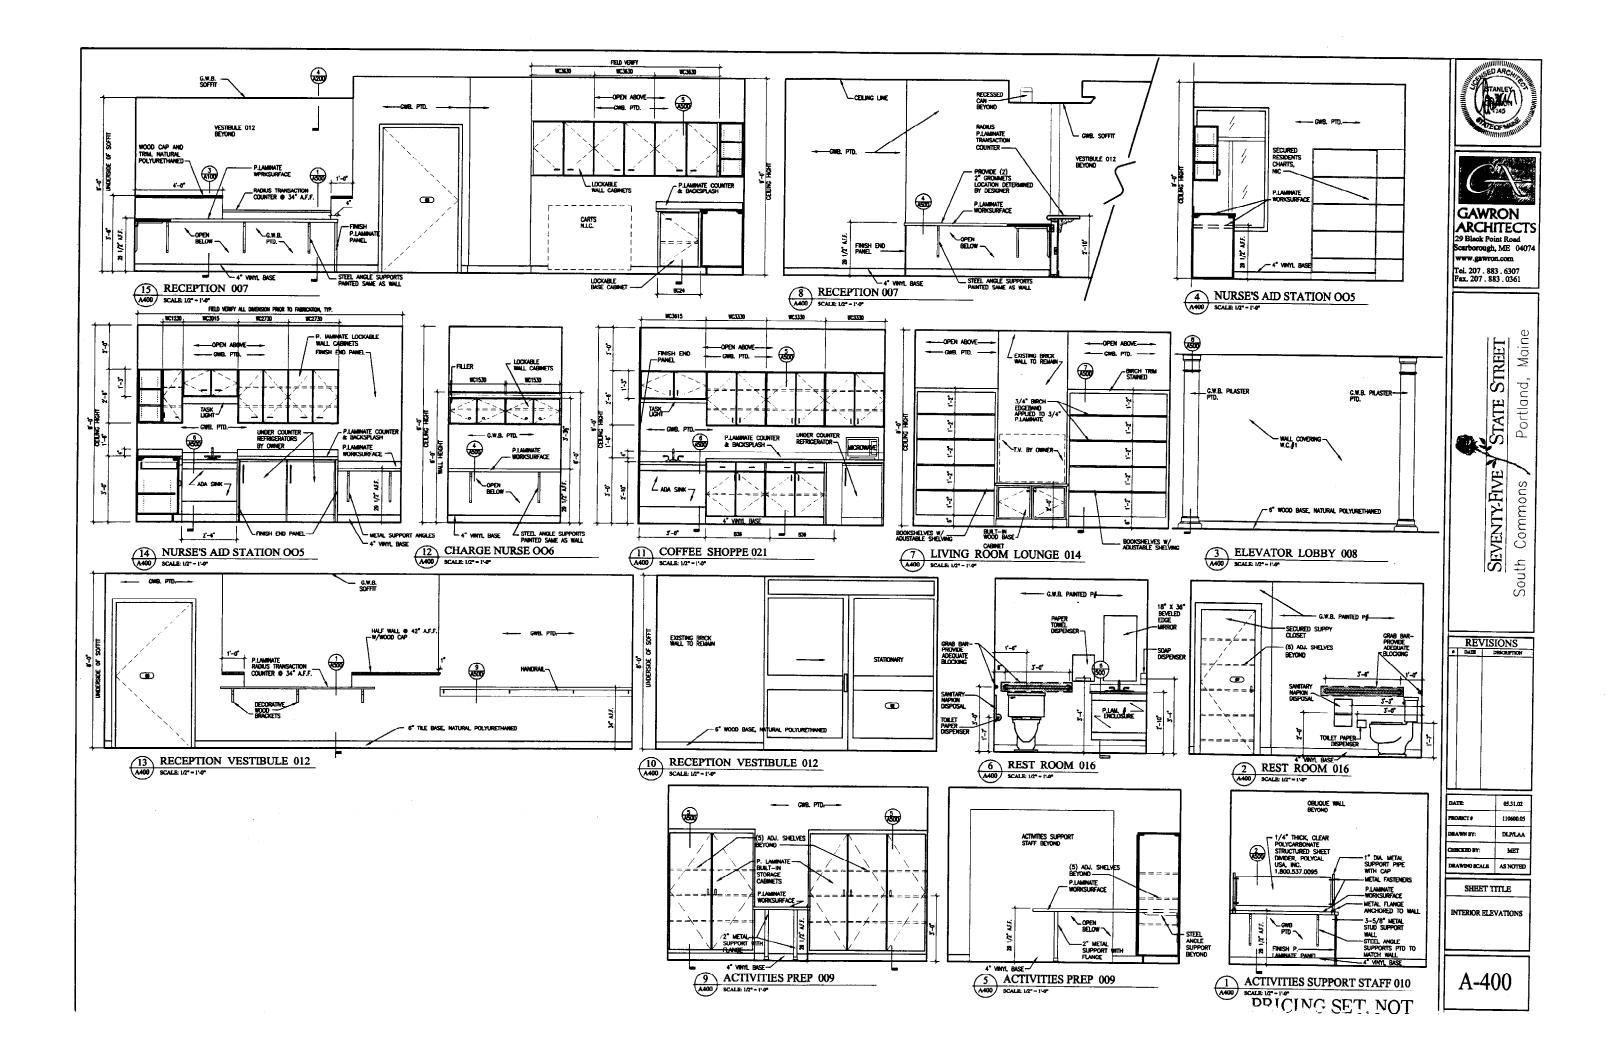

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GENERAL NOTES

- STRUCTURAL DRAWINGS SHALL BE USED IN CONJUNCTION WITH PROJECT SPECIFICATIONS AND ARCHITECTURAL MECHANICAL, ELECTRICAL, PLUMBING, AND SITE DRAWINGS. CONSULT THESE DRAWINGS FOR LOCATIONS AND DIMENSIONS OF OPENINGS, CHASES, INSERTS, REGLETS, SLEVES, DEPRESSIONS, AND OTHER DETAILS NOT SHOWN ON STRUCTURAL DRAWINGS.
- ALL DIMENSIONS AND CONDITIONS MUST BE VERIFIED IN THE FIELD, ANY DISCREPANCIES SHALL BE BROUGHT TO THE ATTENTION OF THE ARCHITECT BEFORE PROCECUING WITH THE AFFECTED PART OF THE WORK.
- 3. THE STRUCTURE IS DESIGNED TO BE SELF SUPPORTING AND STABLE AFTER THE THE STRUCTURE IS DESIGNED TO BE SELF SUPPORTING AND STABLE AFTER THE REPONDING ARE COMPLETE. IT IS THE CONTRACTOR'S SOLE RESPONSIBILITY TO DETERMINE ERECTION PROCEDURES AND SEQUENCE TO INSURE THE SWETT OF THE BULLDING AND ITS COMPONENTS OURING PRECION, THIS INCLUDES THE ADDITION OF NECESSARY SHORMS AND TEMPORARY BRACING, SUCH MATERIAL SHALL REMAIN THE PROPERTY OF THE CONTRACTOR AFTER COMPLETION OF THE PROJECT. DESIGN OF SHORMS IS THE RESPONSIBILITY OF THE CONTRACTOR.
- 4. SECTIONS AND DETAILS SHOWN ON ANY STRUCTURAL DRAWINGS SHALL BE CONSIDERED TYPICAL FOR SIMILAR CONDITIONS AS DETERMINED BY THE ARCHITECT.
- 5. THE CONTRACTOR SHALL SUBJUIT COMPLETE SHOP DRAWINGS FOR ALL PARTS OF THE WORK, INCLUDING DESCRIPTION OF SHORMS, AND CONSTRUCTION METHODS AND SECUENCING WHERE APPLICABLE. NO PERFORMANCE OF THE WORK MILLIONS, BUT NOT LIMITED TO, DEMOLITION OF EXISTING STRUCTURE. OR PARKGATION OF PRECITION OF NEW STRUCTURAL ELEMENTS, SHALL COMMENCE WITHOUT REVIEW OF THE SHOP DEMONESS BY THE ARCHITECT AND ENGINEER. SUBJUIT ONE COPY AND ONE SEPIA. COPY WILL BE REVIEWED AND SEPIA WILL BE RETURNED.
- ALL APPLICABLE FEDERAL, STATE, AND MUNICIPAL RECULATIONS SHALL BE FOLLOWED, INCLUDING THE FEDERAL DEPARTMENT OF LABOR OCCUPATIONAL SAFETY AND HEALTH ACT.

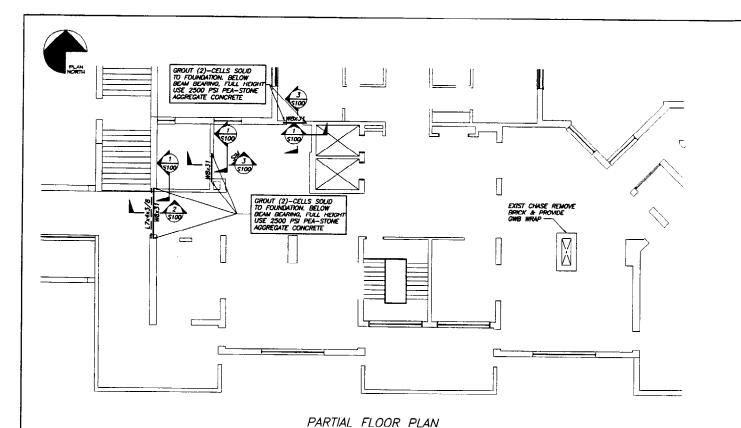DESIGN LOADS

1. BUILDING CODE:

BOCA NATIONAL BUILDING CODE (1999) ASCE 7-95 MINIMUM DESIGN LOADS FOR BUILDINGS AND OTHER STRUCTURES.

2. DESIGN LIVE LOADS:

FLOORS 100 PSF 100 PSF 80 PSF 40 PSF CORRIDORS FLOOR 1

3. DESIGN LIVE LOADS:

CROUND SNOW LOAD (Pg): SNOW EXPOSURE FACTOR (Cx): THERMAL FACTOR (Ct): SNOW LOAD IMPORTANCE FACTOR (I):

- STRUCTURAL STEEL FABRICATION, ERECTION, AND CONNECTION DESIGN SHALL CONFORM TO ASC "SPECIFICATION FOR THE DESIGN FABRICATION, AND ERECTION OF STRUCTURAL STEEL" 9TH EDITION, AND THE "CODE OF STANDARD PRACTICE, LAYEST EDITION.
- STRUCTURAL STEEL: STEEL PLATES, SHAPES, AND BARS, CONFORM TO ASTM A36 UNLESS MOTED OTHERWISE (U.N.O.). STRUCTURAL STEEL SHAPES DESIGNATED ON THE DRAWMOS FOR WIDE-FLANCE SECTIONS: ASTM A992 (ASTM A572 GRADE 50 WITH SPECIAL REQUIREMENTS PER AISC TECHNICAL BULLETIN #3 DATED MARCH, 1997)
- 3. WHERE WELDING IS INDICATED, ALL WELDING SHALL CONFORM TO AWS D1.1— LATEST EDITION. ELECTRODES SHALL BE CONFORM TO AWS A5.1 ETOXX SERIES WITH PROPER ROD TO PRODUCE OPTIMUM WELD (LOW HYDROGEN).
- 4. ALL STEEL SHALL BE FABRICATED AND SHIPPED AS BARE UN-PAINTED STEEL EXCEPT STEEL USED AT EXTERIOR WALLS. ALL STEEL AT EXTERIOR WALLS SHALL BE PAINTED WITH THEMEC 90-97 ZINC RICH PRIMER (2.5-3.5 MLS) AND TOP COATED WITH THEMEC SERVES 73 EMDURA-SHELD (3.0-3.0 MLS). STEEL MAY BE HOT DIPPED GALVANIZED AS INDICATED ON THE DRAWINGS.
- 5. LINTELS FOR EXTERIOR MASONRY AND STRUCTURAL STEEL EXPOSED TO WEATHER SHALL BE HOT-DIP GALVANIZED ACCORDING TO ASTM A123, UNLESS OTHERWISE NOTED TO BE PAINTED. REFER TO LINTEL SCHEDULE FOR LINTEL SIZES.

MASONRY NOTES

- 1. ALL MASONRY CONSTRUCTION SHALL CONFORM TO ACI 530.1-LATEST EDITON.
- 2. ALL CONCRETE MASONRY UNITS SHALL BE ASTM C90 GRADE N. TYPE I STANDARD WEIGHT BLOCKS INCLUDING STRETCHERS AND CORNER BLOCKS. MINIMUM PRISM STRENGTH OF BLOCK SHALL BE F'M = 1500 PSI IN 28 DAYS.
- 3. MORTAR SHALL CONFORM TO ASTM SPECIFICATION C270, TYPE M OR S
- 4. GROUT SHALL CONFORM TO ASTM-C476
- 5. HORIZONTAL JOINT REINFORCING SHALL BE DUR-O-WAL TRUSS DESIGN, STANDARD CLASS MILL GALVANIZED WITH 9 CAGE SIDE ROOS AND 9 GAUGE CROSS TIES U.N.O. REINFORCING SHALL BE PLACED IN MASONRY WALLS AT EVERY SECOND BLOCK COURSE.
- 6. CELLS TO BE CROUTED SHALL BE 2-CELL BLOCK. ALIGN CELLS TO MAINTAIN A CLEAR UNDSETRICTED, CONTINUOUS VERTICAL CHASE CELLS AND MUST BE KEPT CLEAN OF PROTRUSIONS OR FINS OF MORTAIN FILL CELLS OF MASONARY UNITS AND WALL CANTIES INHERE INDICATED WITH 2500 PSI GROUT. MAXIMUM GROUT LEFT WITHOUT CLEAN—OUTS SHALL BE 4"-0". HICH LIFT GROUTING SHALL CONFORM TO CODE REQUIREMENTS WITH A MINIMUM CEMENT CONTENT OF 8 SACKS POR CUBIC VARD. SUPPORT ALL VERTICAL BARS IN CENTER OF GROUTED CELLS WITH VERTICAL BAR POSTTOMER.
- ALL STEEL SUPPORTED BY BLOCK WORK SHALL BE FIELD ANCHORED BY THE USE OF COVERNMENT ANCHORS AND FIELD WELDED TO BEARING PLATES PROPERLY EMBEDDED IN THE BOND BEAM.





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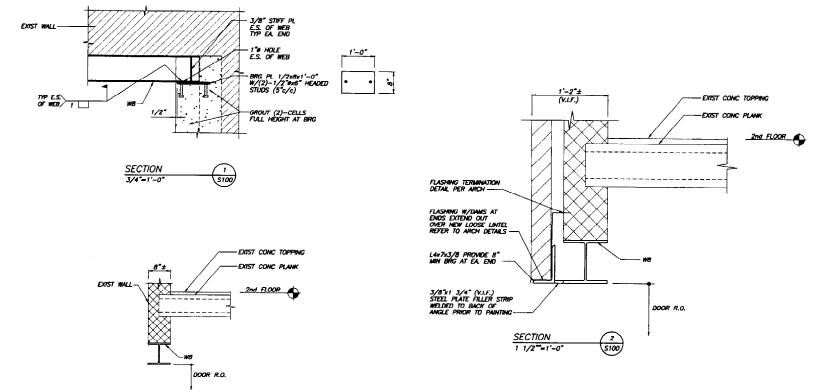
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SHEET TITLE

STRUCTURAL PLAN & DETAILS

S-100

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THIS DRAWING IS AN INSTRUMENT OF SERVICE AND SHALL REMAIN THE PROPERTY OF RECHER STRUCTURAL DEGREEPS INC. IT SHALL NOT BE REPRODUCED, COPED. LIVIT OR DESPOSED OF DAMED'TH OR HOSPICALLY FOR MICE OP ANY PRIMERSE OTHER THAN FOR WINCH IT IS SPECIFICALLY FURNISHED AND MUST BE RETURNED TO SHOWER THAN FOR MICH.

SECTION

3/4"=1"-0"

5100

2

DWGS ISSUED FOR BID

JUNE 03, 2002